CITY OF ALBUQUERQUE

Planning Department Brennon Williams, Director



Mayor Timothy M. Keller

September 29, 2020

David Soule, P.E. Rio Grande Engineering PO Box 93924 Albuquerque, New Mexico 87199

RE: Lot 1 Block 4 Unit 18 SAD 228 6620 Papagayo NW Volcano Cliffs Subdivision Grading and Drainage Plan Engineers Stamp Date 9/26/2020 (D10D003J1)

Dear Mr. Soule,

PO Box 1293 Based upon the information provided in your submittal received 9/24/2020, this plan is approved for Grading Permit.

Albuquerque Prior to Building permit approval a Pad Certification will be required, provided by the Engineer or a registered Land Surveyor.

Advise the owner contractor not to use dirt as a ramp to climb the curb, use lumber or crusher fines for this purpose.

^{www.cabq.gov} Reiterate to the Owner/Contractor that a separate permit for a garden/retaining wall must be obtained with the approved G&D plan and Pad Certification. Also, if a swimming pool is to be placed the grading and drainage plan will change and will need to be resubmitted.


Prior to Certificate of Occupancy release, Engineer Certification per the DPM checklist is required.

If you have any questions, please contact me at 924-3986 or Rudy Rael at 924-3977.

Sincerely,

Ernest Armijo, P.E. Principal Engineer, Planning Dept. Development Review Services

Phone#: 505.321.9099 Fax#: 505.872.0999 E-mail: david@riograndeengineering.com	Address: <u>PO BOX 93924</u> ALB N Phone#: ^{505.321.9099}	IM 87199 Fax#:Fax#:	E-mail: david@riograndeengineering.co	ст
TYPE OF DEVELOPMENT:PLATRESIDENCEDRB SITEADMIN SITE	Check all that Apply: X HYDROLOGY/ DRAINAGE TRAFFIC/ TRANSPORTATION TYPE OF SUBMITTAL: PAD CERTIFICATION CONCEPTUAL G & D PLAN X GRADING PLAN DRAINAGE REPORT DRAINAGE MASTER PLAN FLOODPLAIN DEVELOPMENT PERM ELEVATION CERTIFICATE CLOMR/LOMR TRAFFIC CIRCULATION LAYOUT (I TRAFFIC IMPACT STUDY (TIS) STREET LIGHT LAYOUT OTHER (SPECIFY) PRE-DESIGN MEETING?	X BUI CER ION PRE SITH SITH SITH SIA/ IT APPLIC FOU GRA SO-1 RA VOH CLC FLO	F APPROVAL/ACCEPTANCE SOUGHT: LDING PERMIT APPROVAL TIFICATE OF OCCUPANCY LIMINARY PLAT APPROVAL E PLAN FOR SUB'D APPROVAL E PLAN FOR BLDG. PERMIT APPROVAL E PLAN FOR BLDG. PERMIT APPROVAL AL PLAT APPROVAL AL PLAT APPROVAL ING PERMIT APPROVAL UNG PERMIT APPROVAL ING PERMIT APPROVAL ING PERMIT APPROVAL ING PERMIT APPROVAL ING PERMIT APPROVAL MING/ PAD CERTIFICATION & ORDER APPROVAL MR/LOMR ODPLAIN DEVELOPMENT PERMIT UER (SPECIFY)	
	Address: PO BOX 93924 ALB M	IM 87199		
Address: PO BOX 93924 ALB NM 87199				
Other Contact: RIO GRANDE ENGINEERING DAVID SOULE Address: PO BOX 93924 ALB NM 87199				
Phone#: Fax#: E-mail: Other Contact: RIO GRANDE ENGINEERING Contact: DAVID SOULE Address: PO BOX 93924 ALB NM 87199 Contact: DAVID SOULE	Applicant: SILVERTON CUSTOM H	OMES	Contact:	
Other Contact: RIO GRANDE ENGINEERING DAVID SOULE Address: PO BOX 93924 ALB NM 87199	Legal Description: LOT 1 BLOCK City Address: 6620 PAPAGAYO N	4 VOLCANO CLIFFS U	NIT 18	
City Address:	Project Title: 6620 PAPAGAYO	NW Building Permit #:	Hydrology File #:	
Applicant: SILVERTON CUSTOM HOMES Contact: Address:		Planning Department opment & Building Services ND TRANSPORTATION IN	Division FORMATION SHEET (REV 6/2018)	

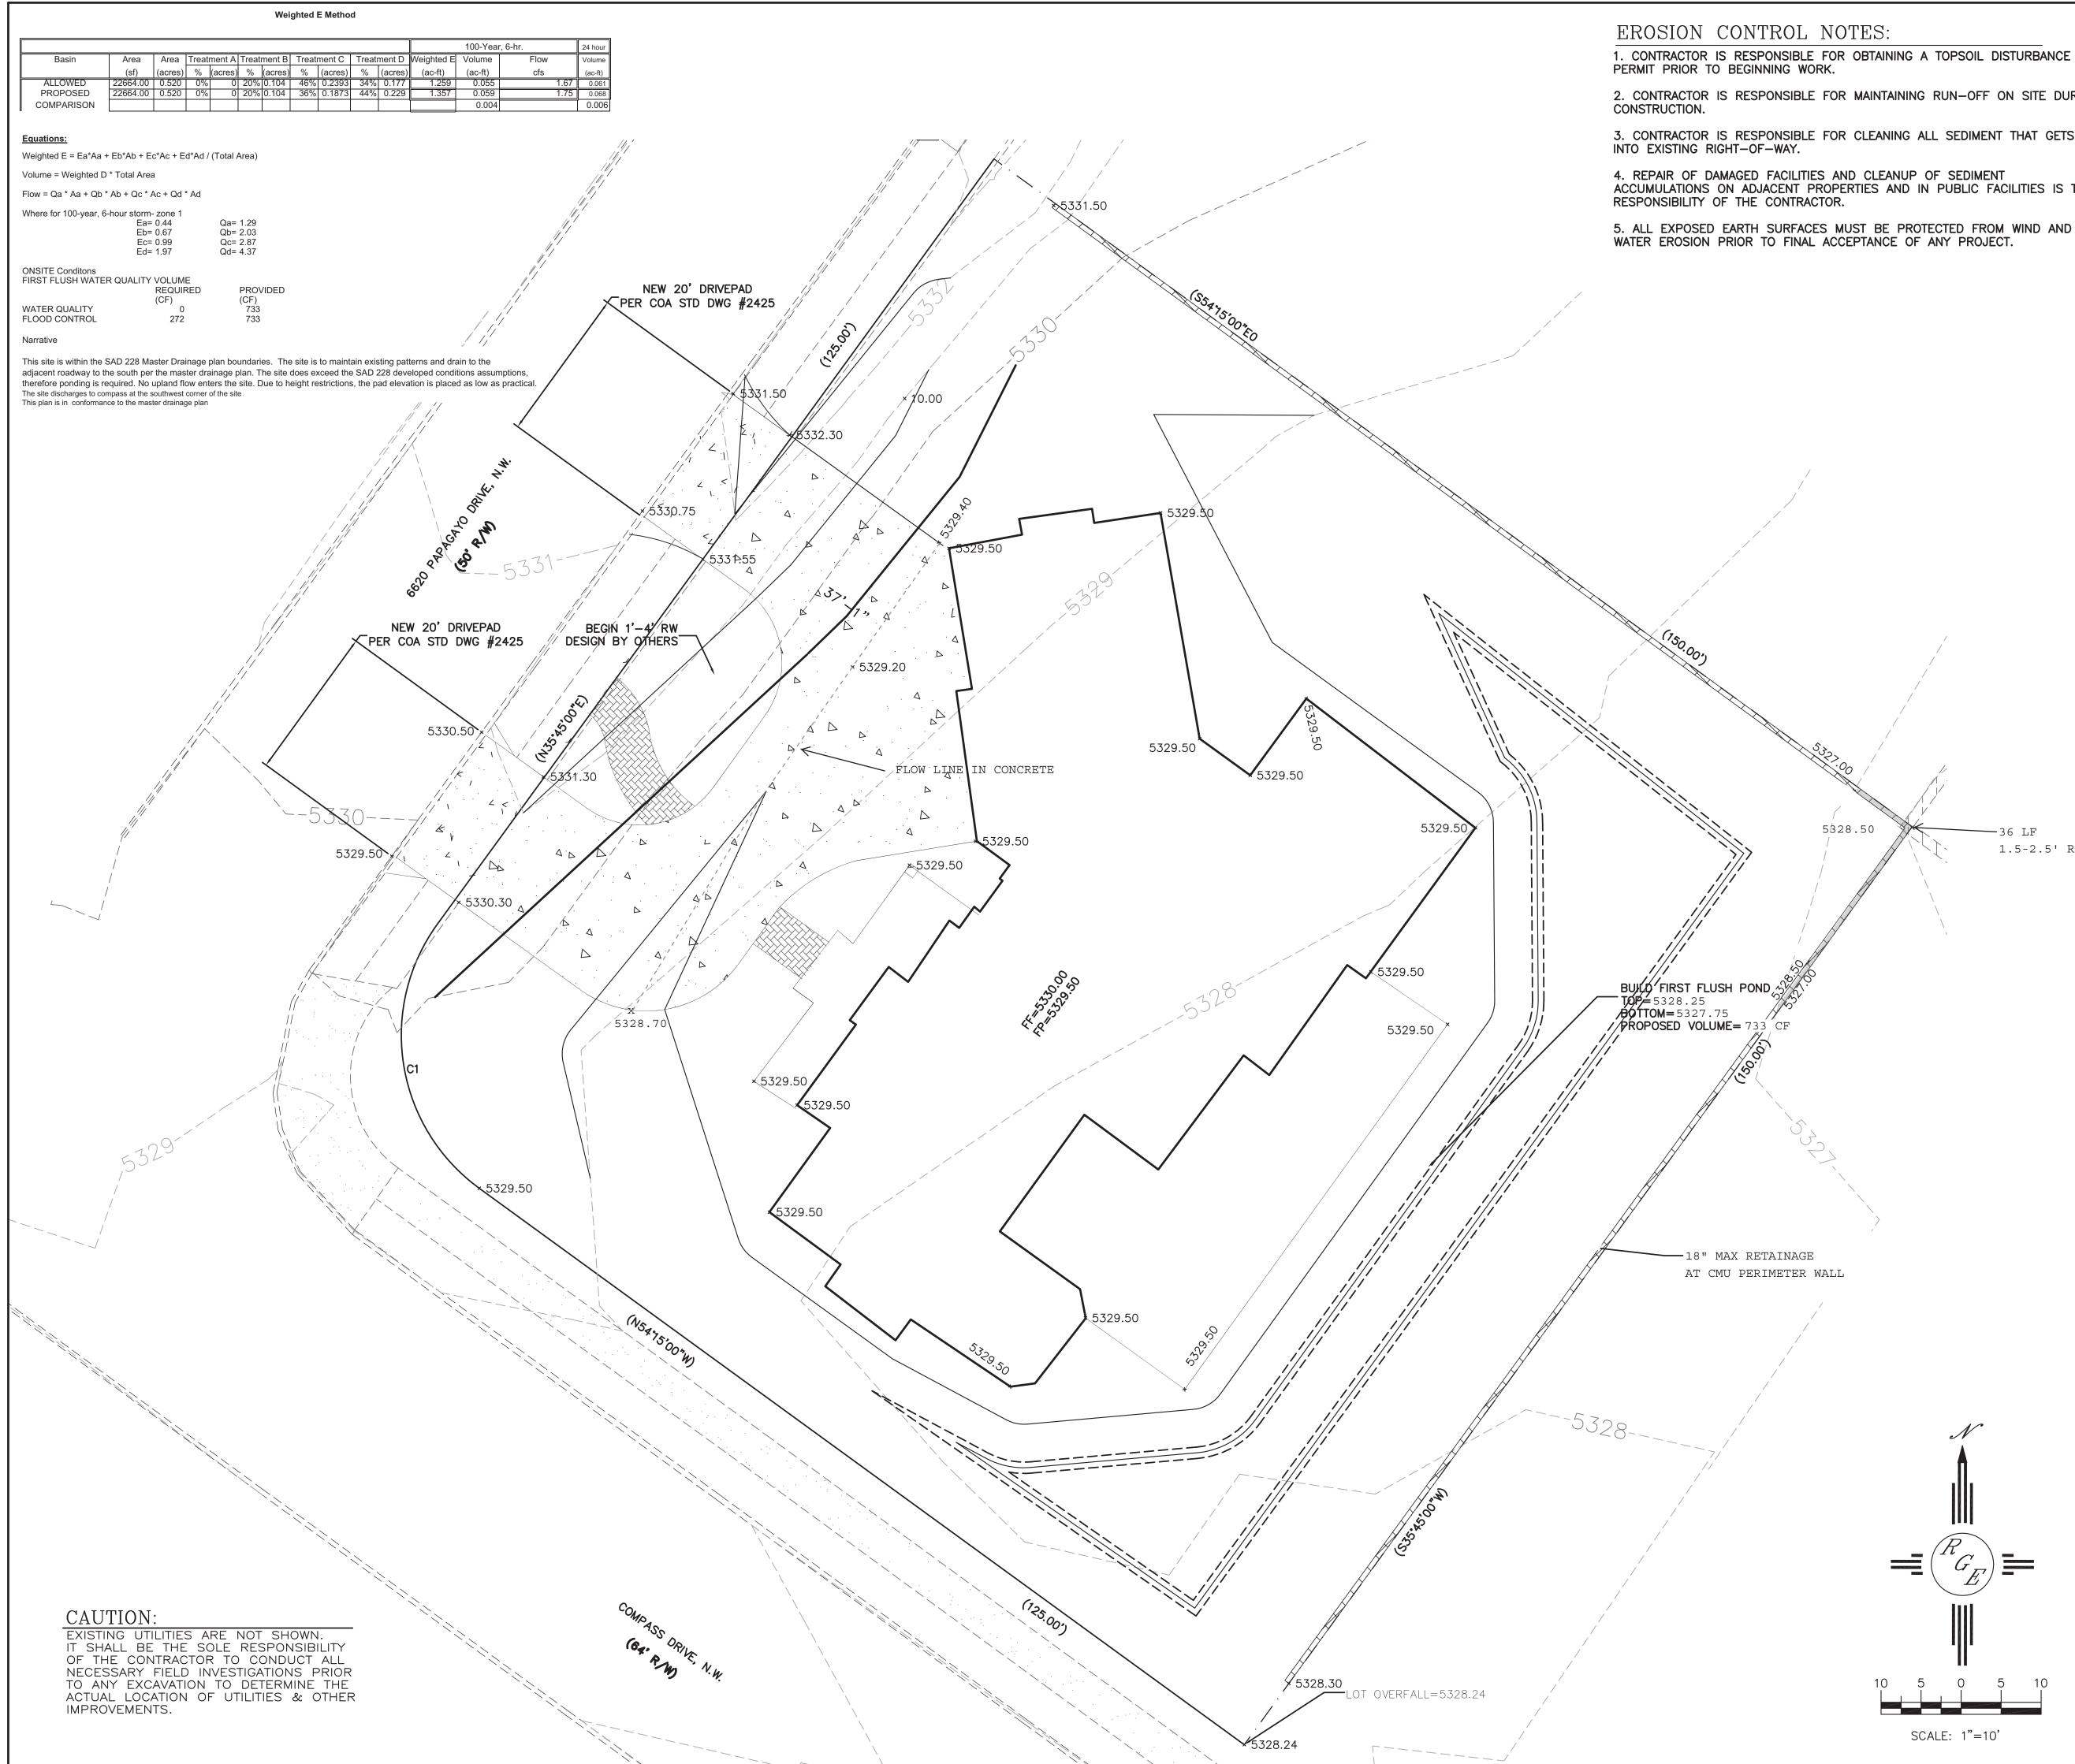




2. CONTRACTOR IS RESPONSIBLE FOR MAINTAINING RUN-OFF ON SITE DURING

3. CONTRACTOR IS RESPONSIBLE FOR CLEANING ALL SEDIMENT THAT GETS

4. REPAIR OF DAMAGED FACILITIES AND CLEANUP OF SEDIMENT ACCUMULATIONS ON ADJACENT PROPERTIES AND IN PUBLIC FACILITIES IS THE

5. ALL EXPOSED EARTH SURFACES MUST BE PROTECTED FROM WIND AND WATER EROSION PRIOR TO FINAL ACCEPTANCE OF ANY PROJECT.

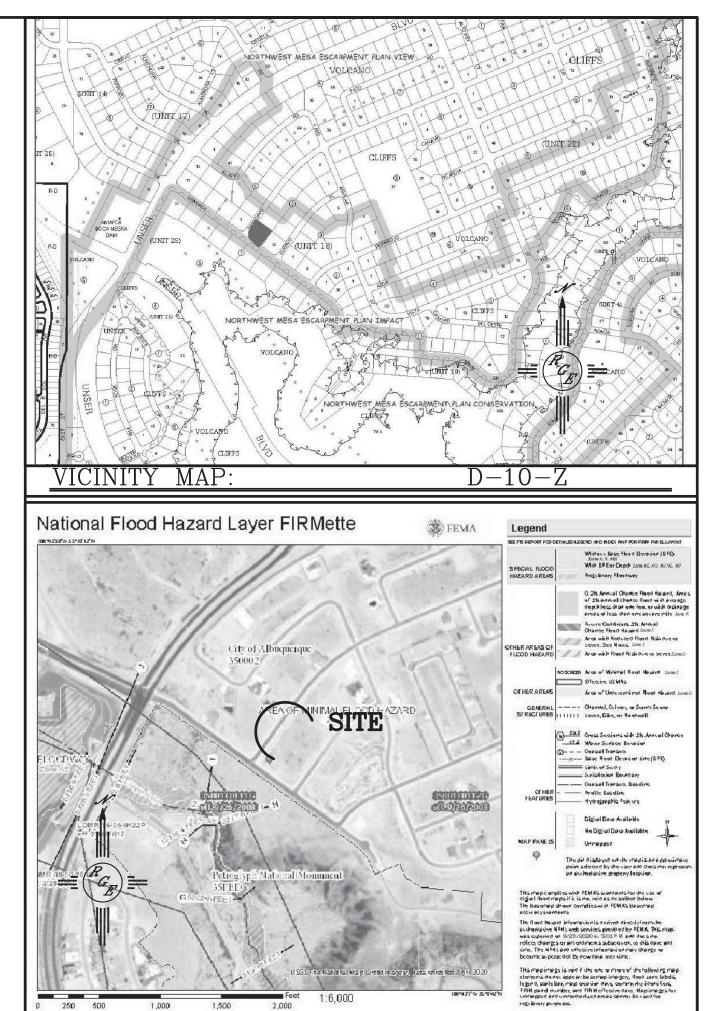

FIRM MAP:

—36 LF 1.5-2.5' RETAINAGE


LEGAL DESCRIPTION: LOT 1, BLOCK 4, VOLCANO CLIFFS UNIT 18

NOTES:

1. ALL SPOT ELEVATIONS REPRESENT FLOWLINE ELEVATION UNLESS OTHERWISE NOTED. 2. ALL SLOPES SHALL BE 3:1 MAX. AND GRAVEL OR NATIVE SEEDING PRIOR TO CO.

LEGEND

	EXISTING CONTOUR	
	EXISTING INDEX CONTOUR	
XXXX	PROPOSED CONTOUR	
►	SLOPE TIE	
x XXXX	EXISTING SPOT ELEVATION	
× XXXX	PROPOSED SPOT ELEVATION	
	BOUNDARY	
	CENTERLINE	
	RIGHT-OF-WAY	
	PROPOSED 4" PVC SD	
	POOL DECK TRENCH DRAIN	
=============	\equiv EXISTING CURB AND GUTTER	
	$\equiv \equiv$ EXISTING CURB AND GUTTER	RETAINAGE
		RETAINAGE DRAWN BY WCWJ
ENGINEER'S	PROPOSED CMU SCREEN WALL-18" MAX. F	DRAWN BY _{WCWJ} DATE
ENGINEER'S SEAL	PROPOSED CMU SCREEN WALL-18" MAX. F	DRAWN BY _{WCWJ} DATE 9–25–20
ENGINEER'S SEAL	 PROPOSED CMU SCREEN WALL-18" MAX. F 6620 PAPAGOYO GRADING AND DRAINAGE PLAN <i>Rio Grande</i> 	DRAWN BY _{WCWJ} DATE
ENGINEER'S SEAL	 PROPOSED CMU SCREEN WALL-18" MAX. F 6620 PAPAGOYO GRADING AND DRAINAGE PLAN <i>Rio Grande</i> <i>Engineering</i> 	DRAWN BY _{WCWJ} DATE 9–25–20 2102075–LAYOUT–9–25–20

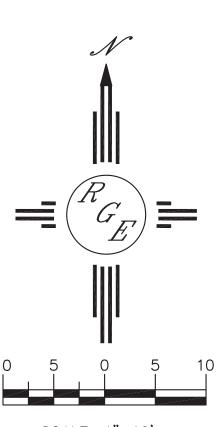

SCALE: 1"=10'