
CITY OF ALBUQUERQUE

Planning Department Alan Varela, Director

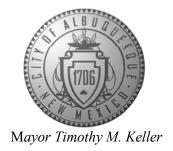

October 16, 2025

Jesse Luehring, P.E. Critical View Engineering, LLC 11501 Modesto Ave NE Albuquerque, New Mexico 87122

RE: Lot 1 Block 5 Unit 18
6601 Papagayo NW
Volcano Cliffs Subdivision
Grading and Drainage Plan

Engineers Stamp Date 10/7/2025 (D10D003K1)

Mr. Luehring,

Based upon the information provided in your submittal received 10/7/2025, this plan is approved for Grading Permit.

PO Box 1293

Advise the owner contractor not to use dirt as a ramp to climb the curb, use lumber or crusher fines for this purpose. Place this note on the plan.

Albuquerque

Reiterate to the Owner/Contractor that a separate permit for a garden/retaining wall must be obtained with the approved G&D plan and Pad Certification. Also, if a swimming pool is to be placed after this approval a new grading and drainage plan will need to be resubmitted showing the changes for the land treatments.

NM 87103

Prior to Certificate of Occupancy release, Engineer Certification per the DPM checklist is required.

www.cabq.gov

If you have any questions, please contact me at 924-3695 or Rudy Rael at 924-3977.

Sincerely,

Tiequan Chen, P.E.

Principal Engineer, Hydrology

Planning Department, Development Review Services

RR/TC

C: File D10D003J6



City of Albuquerque


Planning Department


Development & Building Services Division


DRAINAGE AND TRANSPORTATION INFORMATION SHEET (REV 6/2018)

Project Title: G & D for 6601 Papagayo Rd	Building Perr	mit #: Hydrology File #:
DRB#:	EPC#:	Work Order#:
Legal Description: Lot 1, Block 5, Volcar	o Cliffs, Unit 18	
City Address: 6601 Papagayo Rd NW, Albud	querque NM, 87120	
Applicant: Critical View Engineering		Contact: Jesse Luehring
Address:10900 Florence Ave NE, Albuquerque		
Phone#: 505-321-5917	Fax#:	E-mail:criticalviewabq@gmail.con
Other Contact: Owner		Contact: Louis Casias
Address:		
		E-mail: louiecasisa@yahoo.com
		RESIDENCE DRB SITE ADMIN SITE
THE OF DEVELOTMENTFLA	.1 (# 01 lots)	RESIDENCEDRD SITEADMIN SITE
IS THIS A RESUBMITTAL? Yes	x No	
DEPARTMENT TRANSPORTATION	X HVDI	ROLOGY/DRAINAGE
	111D1	ROEGG I/BR/III//IGE
Check all that Apply:		TYPE OF APPROVAL/ACCEPTANCE SOUGHT:
TYPE OF SUBMITTAL:		BUILDING PERMIT APPROVAL
ENGINEER/ARCHITECT CERTIFICAT	ION	CERTIFICATE OF OCCUPANCY
PAD CERTIFICATION		DDELIMINADA DI AT ADDDOMAI
CONCEPTUAL G & D PLAN		PRELIMINARY PLAT APPROVAL
X GRADING PLAN		SITE PLAN FOR SUB'D APPROVAL
DRAINAGE REPORT		SITE PLAN FOR BLDG. PERMIT APPROVAL
DRAINAGE MASTER PLAN		FINAL PLAT APPROVAL
FLOODPLAIN DEVELOPMENT PERMI	T APPLIC	
ELEVATION CERTIFICATE	THILL	SIA/ RELEASE OF FINANCIAL GUARANTEE
CLOMR/LOMR		FOUNDATION PERMIT APPROVAL
TRAFFIC CIRCULATION LAYOUT (TO	T)	X GRADING PERMIT APPROVAL
TRAFFIC IMPACT STUDY (TIS)	CL)	SO-19 APPROVAL
STREET LIGHT LAYOUT		PAVING PERMIT APPROVAL
OTHER (SPECIFY)		GRADING/ PAD CERTIFICATION
PRE-DESIGN MEETING?		WORK ORDER APPROVAL
TRE DESIGN WEETING.		CLOMR/LOMR
		FLOODPLAIN DEVELOPMENT PERMITOTHER (SPECIFY)
DATE SUBMITTED:	Bv: J	esse Luehring, PE`
	·	
COA STAFF:	ELECTRONIC S	SUBMITTAL RECEIVED:


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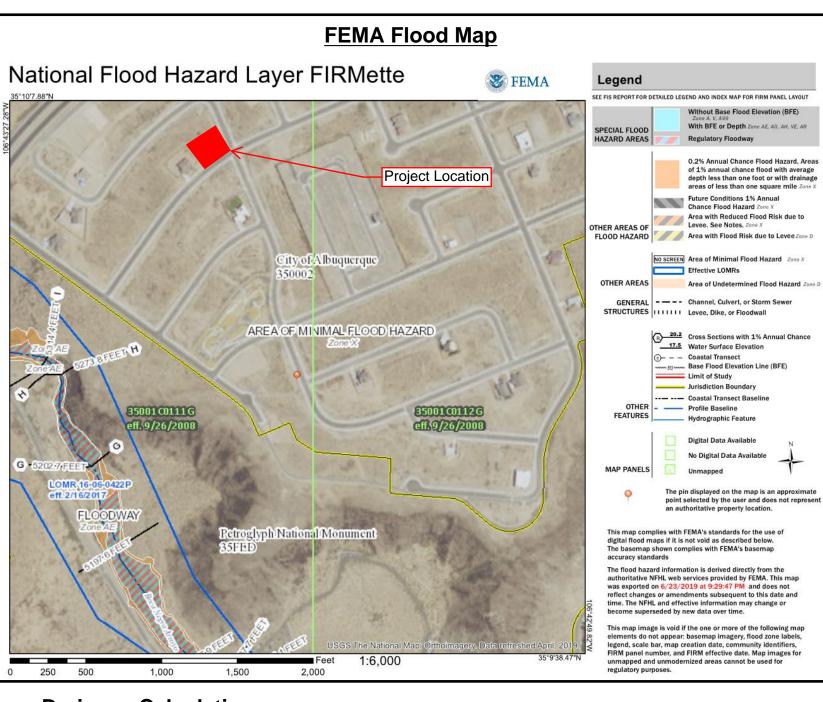


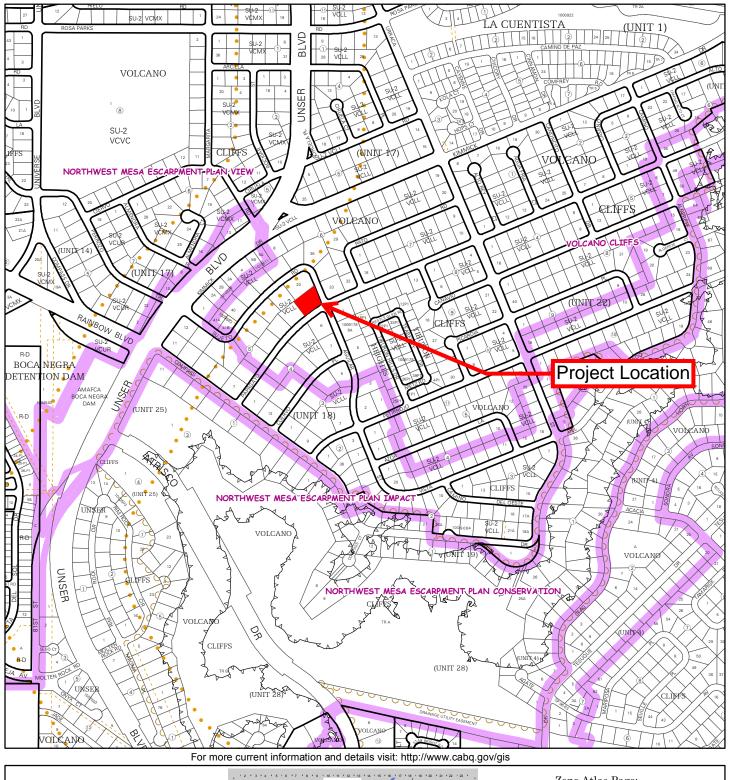

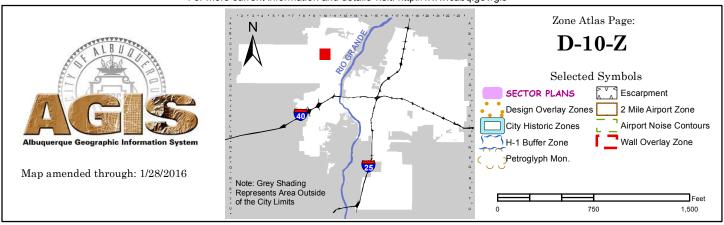

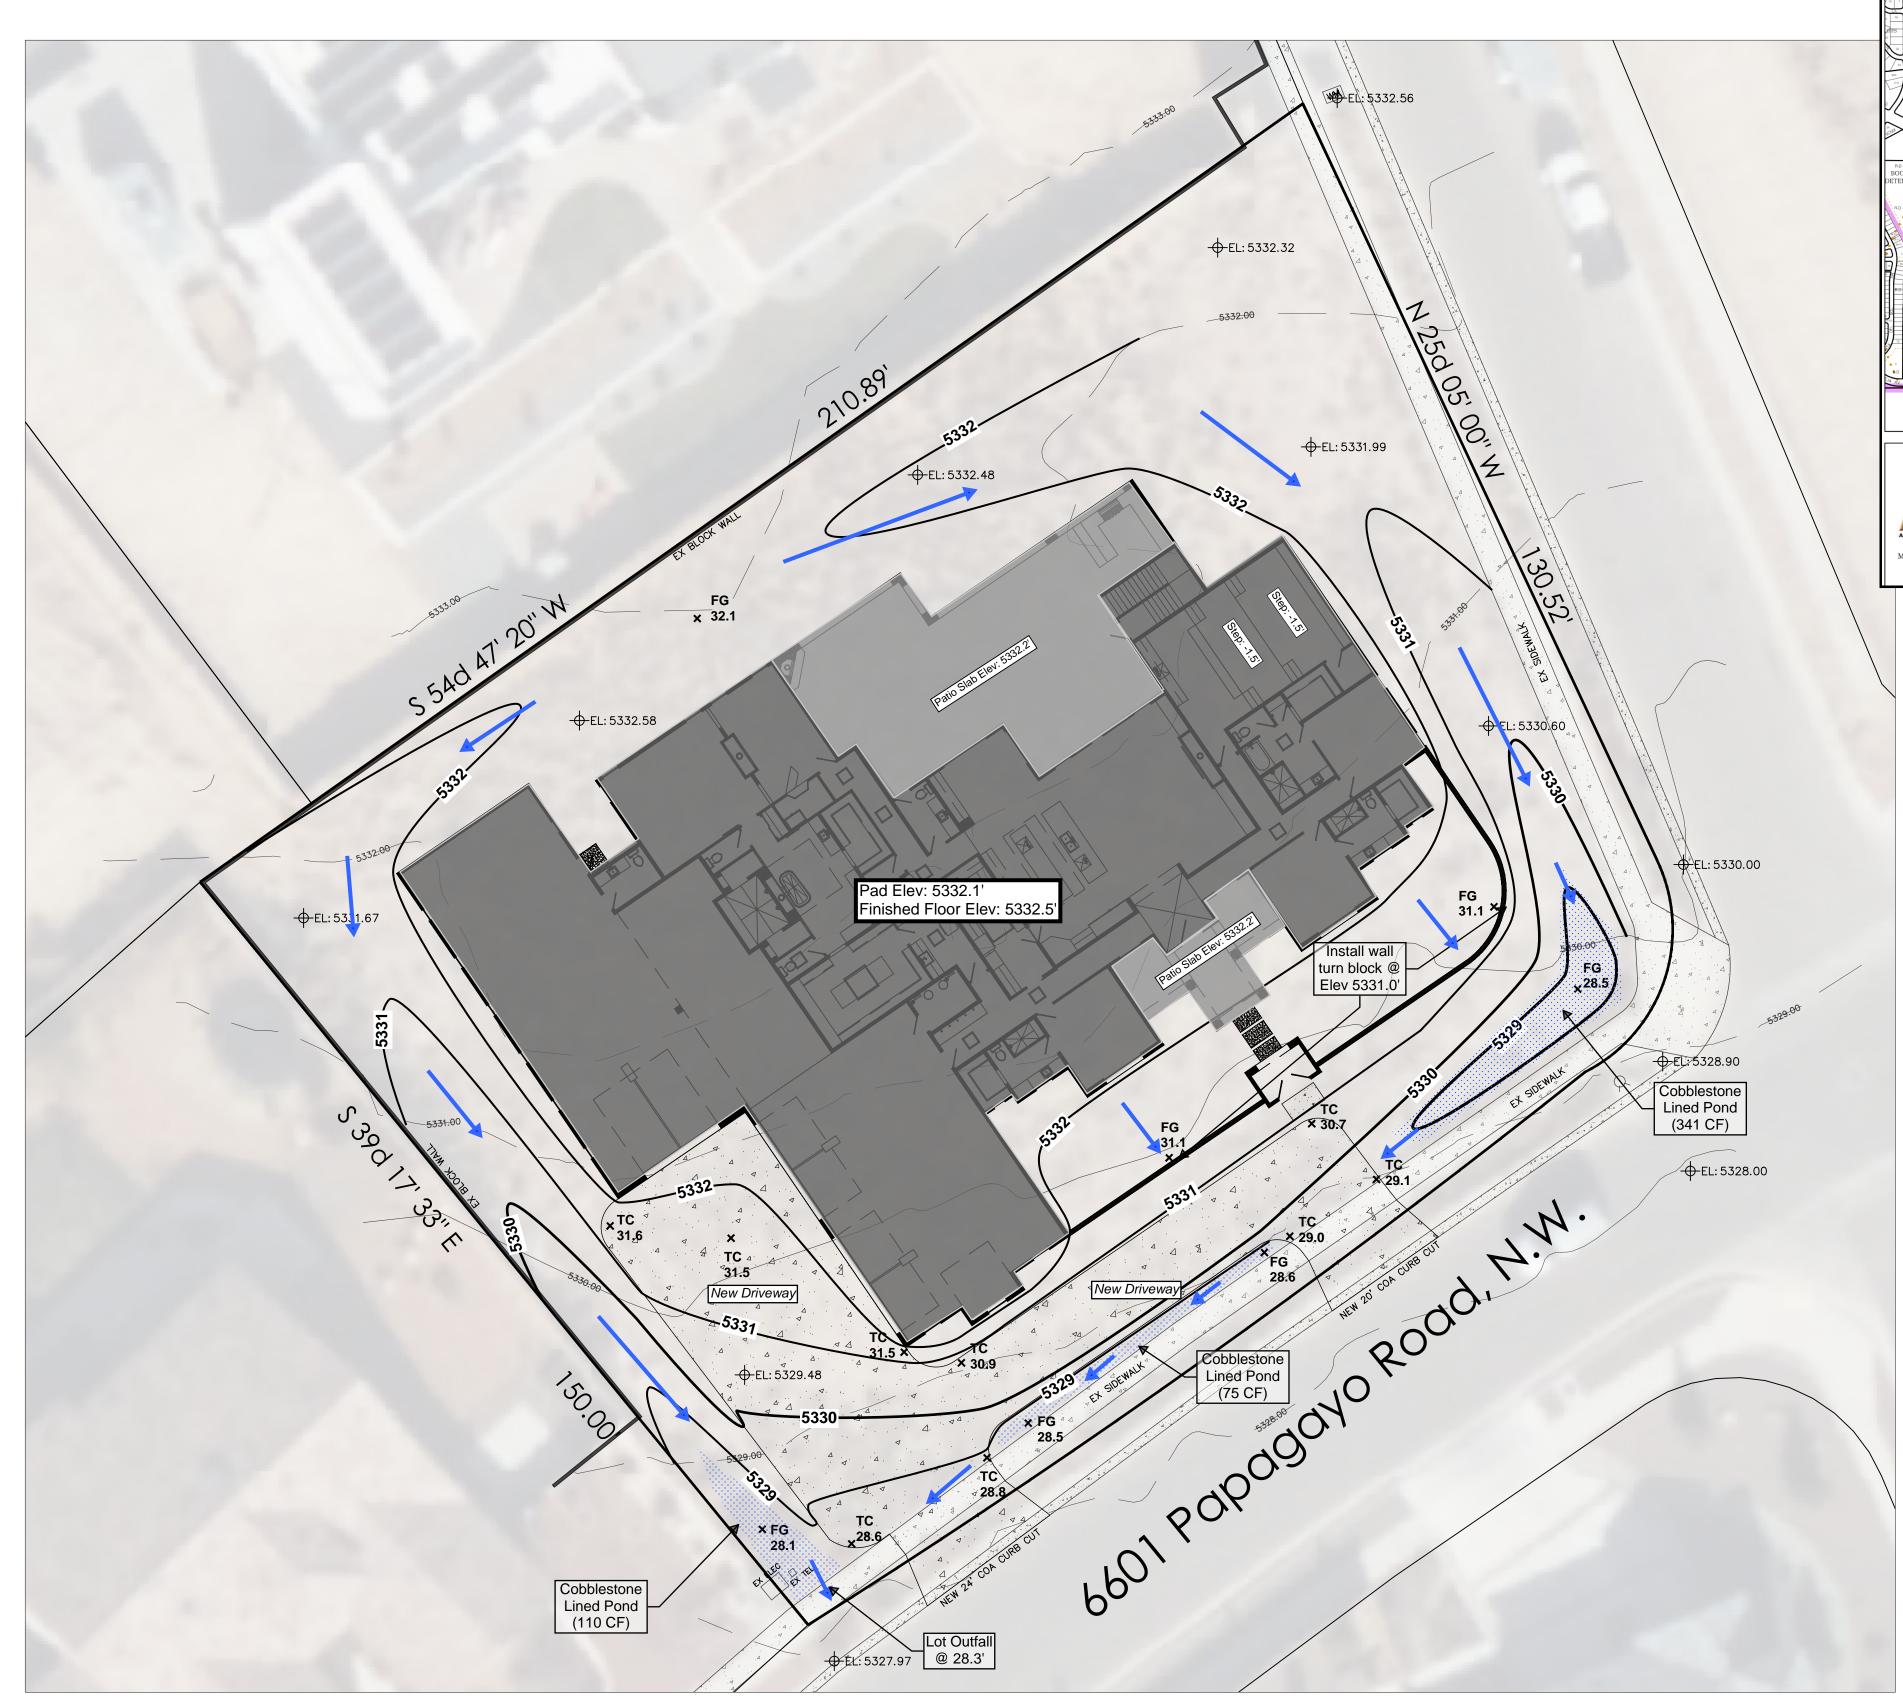Grading Plan Scale: 1" = 15'



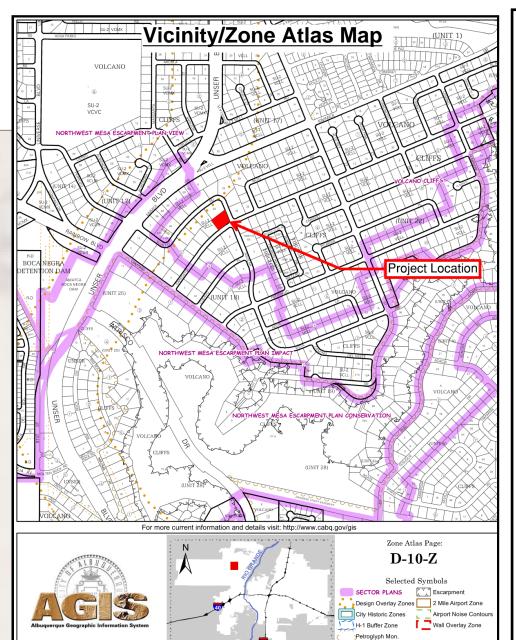

Drainage Calculations

	Lot 1, Block 5, Volcano Cliffs, Unit 18									
Developed Land Treatment Allowed Condit		ions Zone 1 DMP Coefficients (Table 6.2.13)			Developed Calcs					
Land	Proposed	Proposed	Volcano Heights DMP	Allowed	100-Yr Storm	100-Yr Excess	Peak Discharge	Peak Rate of	100-Yr Storm	Req. SWQV
Type	Area Lot (SF)	Area %	Allowed Conditions	Volumes	Inch Depth (6 hr)	Precip (In)	CFS/AC	Discharge (CFS)	Volume (Ac-Ft)	Volume (Ac-Ft)
Type D	13766	55%	50%	0.053	2.17	2.24	4.12	1.30	0.059	0.011061
Type C	8972	36%	40%	0.018	2.17	0.95	2.87	0.59	0.016	-
Type B	2200	9%	10%	0.003	2.17	0.73	2.16	0.11	0.003	-
	24938	100%	100%	0.075				2.00	0.078	0.011061
							Peak Discharge:	2.002 CFS		
							Stormwater Quality Volume:	481.8	Cubic Ft	*governs
							100-Yr Storm Volume (Proposed)	3413.8	Cubic Ft	
Total Drainage Basin Area: 24938 SF		SF				100-Yr Storm Volume (Allowed)	3269.0	Cubic Ft		
Total Drain	age Basin Area:	0.572	AC				100-Yr Storm Retention Volume	144.8 Cubic Ft		

Narrative:

This is a grading and drainage plan for the construction of the building pad for the Lot at address 6601 Papagayo Rd NW (UPC 101006320830420107)

The purpose of this plan is to establish the finished floor elevation, house layout, site concrete layout, wall locations, and general lot drainage of the site. This drainage plan has been prepared in accordance with the 2020 revision to the City of Albuquerque Development Process Manual, and in accordance with the Special Assessment District 228 Master Drainage Plan.

Drainage Intent:

Existing Conditions: This lot is an 0.57 acre vacant land property within the volcano cliffs development. The lot slopes approximately 4% to the Southeast. There are negligible offsite flows entering the property. All onsite flows exit the site to the South and drain to Papagayo Road as intended in the SAD228 Master Drainage Plan.

Proposed Conditions: Improvements to the lot include a new residence and concrete driveway that will add approximately 13766SF of impervious area, or 55% of the property area (Developed conditions of the subdivision allows up to 50%). The lot is designed to drain to Papagayo to the South in accordance with the master drainage plan for the site. Due to the increased amount of impervious area, additional detention ponding is required, however stormwater quality pond volume requirements govern.

This ponds are located at the Southern boundary of the proposed development to ensure contaminant capture. The series of ponds are designed to capture and infiltrate the DPM required stormwater quality volume of approximately 481 CF. Storm event flows in excess of this volume will discharge from the water quality detention ponds by overflowing the sidewalk and draining to the inlets in the street.

Additional improvements may include the construction of garden walls and gates. Drainage paths shall not be impacted by these improvements.


Stormwater Quality Volumes (DPM 6-12):

The required Stormwater Quality Volume to be managed on this lot is for a 0.62" storm (new development). After accounting for initial abstraction, this results in a net of 0.42" rainfall on impervious (Type D) soils, or 481 cubic feet of detention storage for this property. The initial storage on site will be collected and held in the series of shallow landscape ponds near Papagayo Rd as shown on the Plan.

General Notes

- 1. All perimeter walls shall be permitted separately
- No grading shall be allowed on adjacent properties
- A pad certification is required before the building permit is issued
 An as-built certification is required before certificate of occupancy is issued.
- 5. All disturbed areas shall be stabilized with concrete, gravel, asphalt, or native seed mix
- 6. It is recommended to contract with a licensed geotechnical engineer for all aspects of earthwork and engineered fill material
- 7. Driveway cutout shown in concept form only, and shall comply with NM Standard Specs for Public Works Construction, specifically Std Detail 2425
- 8. Any sideyard gates shall allow drainage conveyance to the front of the property as shownAll disturbed areas shall be stabilized with concrete, gravel, asphalt, or native seed mix
- 9. All ponding areas, including at lot outflow to have 2"-4" cobblestone

LEGEND

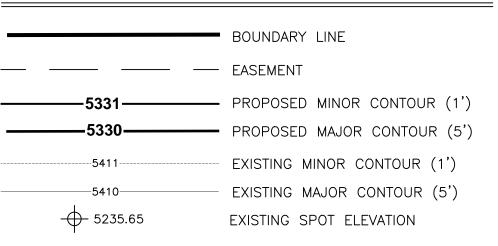

ENGINEER'S SEAL	6601 Papagayo Rd NW	DRAWN BY _{JJL}
SSE J. LUEHRING		DATE/REV 10/5/2025
21684) ROSESSIONAL ENGINEER	Grading & Drainage Plan	
	Critical View Engineering, LLC	SHEET#
10/07/2025	PO Box 90074 ALBUQUERUQUE, NM 87199	
Jesse Luehring P.E. #21684	(505) 321-5917	JOB#