## CITY OF ALBUQUERQUE

Planning Department Brennon Williams, Interim Director



August 14, 2019

David Soule, P.E. Rio Grande Engineering PO Box 93924 Albuquerque, New Mexico 87199

#### RE: Lot 26 Block 1, Volcano Cliffs, Unit 22, SAD 228 8005 Canoncito NW Grading and Drainage Plan Engineers Stamp Date 8/14/19 (D10D003N26)

Dear Mr. Soule,

Based upon the information provided in your submittal received 8/14/19, this plan is approved for Grading Permit.

PO Box 1293 Prior to Building permit approval a Pad Certification will be required, provided by the Engineer or a registered Land Surveyor.

Albuquerque Please inform the builder/owner to attach a copy of this approved plan and letter to the construction sets in the permitting process prior to sign-off by Hydrology.

Reiterate to the Owner/Contractor that a separate permit for a garden/retaining wall must be<br/>obtained with the approved G&D plan and Pad Certification.

Prior to Certificate of Occupancy release, Engineer Certification per the DPM checklist is required.

www.cabq.gov

If you have any questions, please contact me at 924-3999 or Rudy Rael at 924-3977.

Sincerely,

Shahab Biazar, P.E. City Engineer, Planning Division Manager

RR/SB C: File D10D003N26

Creek	LBU	
	(1706)	
AN AN		

# City of Albuquerque

Planning Department Development & Building Services Division

DRAINAGE AND TRANSPORTATION INFORMATION SHEET (REV 6/2018)

Project Title: 8005 CANONCITO	Building Permi	t #:	Hydrole	ogy File #:
DRB#:	EPC#:		Work O	Order#:
Project Title:	1 volcano	cliffs u	nit 22	
City Address: 8005 CANONCITO		<u> </u>		
Address:				
Phone#:				
Other Contact: RIO GRANDE ENGIN	EERING		Contact:	DAVID SOULE
Address: PO BOX 93924 ALB NM	87199			
Phone#:	_ <b>Fax#:</b>	2.0999	E-mail: <sup>da</sup>	avid@riograndeengineering.com
TYPE OF DEVELOPMENT: PLAT	<u> </u>	ENCE	_ DRB SITE	ADMIN SITE
Check all that Apply:				
DEPARTMENT: X HYDROLOGY/ DRAINAGE TRAFFIC/ TRANSPORTATION TYPE OF SUBMITTAL: PAD CERTIFICATION CONCEPTUAL G & D PLAN X GRADING PLAN DRAINAGE REPORT DRAINAGE MASTER PLAN FLOODPLAIN DEVELOPMENT PERMIT ELEVATION CERTIFICATE CLOMR/LOMR TRAFFIC CIRCULATION LAYOUT (TCL TRAFFIC IMPACT STUDY (TIS) STREET LIGHT LAYOUT OTHER (SPECIFY) PRE-DESIGN MEETING?	APPLIC	X BUILDI     CERTIF     PRELIM     SITE PI     SITE PI     FINAL     SIA/ RE     FOUND     GRADII     GRADII	NG PERMIT APPR TCATE OF OCCUP AINARY PLAT AP AN FOR SUB'D A AN FOR BLDG. P PLAT APPROVAL ELEASE OF FINAN ATION PERMIT APPR APPROVAL G PERMIT APPRO NG/ PAD CERTIFI DRDER APPROVAL	PANCY PROVAL APPROVAL PERMIT APPROVAL VICIAL GUARANTEE APPROVAL VAL VAL VAL VAL VAL MENT PERMIT
IS THIS A RESUBMITTAL?: YesXN	lo		. ,	
DATE SUBMITTED:				
COA STAFF:	ELECTRONIC SU		/ED:	

Weighted E Method														
												100-Year	<sup>-</sup> , 6-hr.	24-HOUR
Basin	Area	Area	Treat	ment A	Treat	ment B	Treatr	ment C	Treatr	nent D	Weighted E	Volume	Flow	Volume
	(sf)	(acres)	%	(acres)	%	(acres)	%	(acres)	%	(acres)	(ac-ft)	(ac-ft)	cfs	(ac-ft)
ALLOWED	14002.00	0.321	0%	0	20%	0.064	46%	0.1479	34%	0.109	1.259	0.034	1.03	0.041
PROPOSED	14002.00	0.321	0%	0	22%	0.071	34%	0.1093	44%	0.141	1.351	0.036	1.08	0.045
COMPARISON												0.002		0.00

### Equations:

Weighted E = Ea\*Aa + Eb\*Ab + Ec\*Ac + Ed\*Ad / (Total Area)

Volume = Weighted D \* Total Area

Flow = Qa \* Aa + Qb \* Ab + Qc \* Ac + Qd \* Ad

Where for 100-year, 6-hou	r storm- zone 1	
<b>,</b>	Ea= 0.44	Qa= 1.29
	Eb= 0.67	Qb= 2.03
	Ec= 0.99	Qc= 2.87
	Ed= 1.97	Qd= 4.37
ONSITE Conditons FIRST FLUSH WATER QU		
	REQUIRED	PROVIDED

(CF) 175 199 (CF) 205 205 WATER QUALITY FLOOD CONTROL

Narrative

This site is within the SAD 228 Master Drainage plan boundaries. The site is to maintain existing patterns and drain to the the adjacent roadway to the south per the master drainage plan. We are ponding 205 CF of the water harvest volume generated by the site. there is not measurable upland flow. This plan does exceed the allowed impervious area therefore we are required to retain 199CF. This plan is in conformance to the master drainage plan

> 5332.32 5336.27

CAUTION: EXISTING UTILITIES ARE NOT SHOWN. IT SHALL BE THE SOLE RESPONSIBILITY OF THE CONTRACTOR TO CONDUCT ALL NECESSARY FIELD INVESTIGATIONS PRIOR TO ANY EXCAVATION TO DETERMINE THE ACTUAL LOCATION OF UTILITIES & OTHER IMPROVEMENTS.

### EROSION CONTROL NOTES:


1. CONTRACTOR IS RESPONSIBLE FOR OBTAINING A TOPSOIL DISTURBANCE PERMIT PRIOR TO BEGINNING WORK.


2. CONTRACTOR IS RESPONSIBLE FOR MAINTAINING RUN-OFF ON SITE DURING CONSTRUCTION.

3. CONTRACTOR IS RESPONSIBLE FOR CLEANING ALL SEDIMENT THAT GETS INTO EXISTING RIGHT-OF-WAY.

4. REPAIR OF DAMAGED FACILITIES AND CLEANUP OF SEDIMENT ACCUMULATIONS ON ADJACENT PROPERTIES AND IN PUBLIC FACILITIES IS THE RESPONSIBILITY OF THE CONTRACTOR.

5. ALL EXPOSED EARTH SURFACES MUST BE PROTECTED FROM WIND AND WATER EROSION PRIOR TO FINAL ACCEPTANCE OF ANY PROJECT.

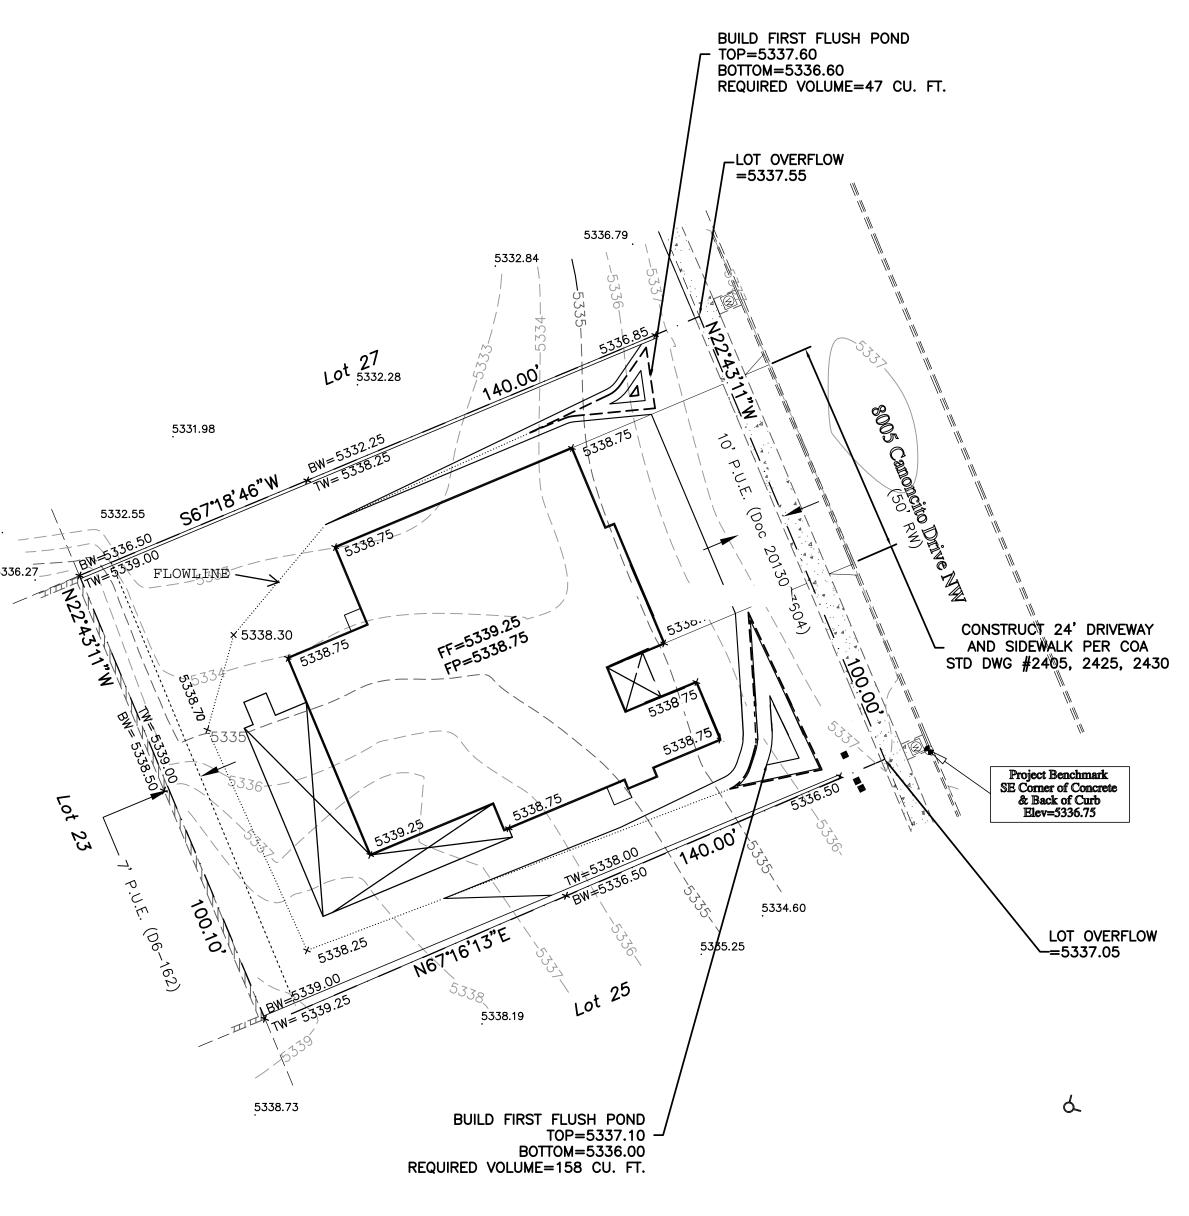

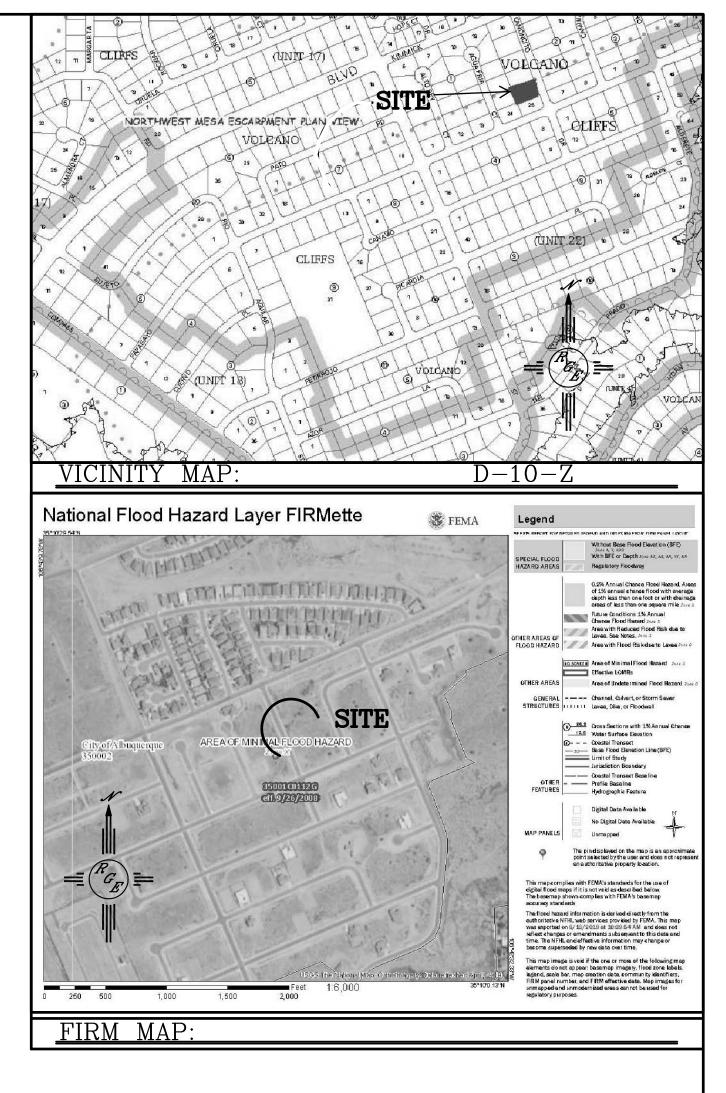

LEGAL DESCRIPTION: Lot 26, Block 1, Volcano Cliffs Unit 22

### NOTES:

1. ALL SPOT ELEVATIONS REPRESENT FLOWLINE ELEVATION UNLESS OTHERWISE NOTED.

2. ALL SLOPES SHALL BE 3:1 MAX. AND GRAVEL OR NATIVE SEEDING PRIOR TO CO.

### LEGEND

	EXISTING CONTOUR						
	Existing index contour	EXISTING INDEX CONTOUR					
xxxx	PROPOSED CONTOUR	PROPOSED CONTOUR					
XXXX	PROPOSED INDEX CONTOUR	PROPOSED INDEX CONTOUR					
►	SLOPE TIE						
× XXXX	EXISTING SPOT ELEVATION	EXISTING SPOT ELEVATION					
× XXXX	PROPOSED SPOT ELEVATION						
	BOUNDARY						
	CENTERLINE						
	RIGHT-OF-WAY						
===========	$\Xi \equiv \pm$ existing curb and gutter						
* * * * * * * * * * * * * * * * * * * *	PROPOSED CMU SCREEN WALL						
ENGINEER'S SEAL	8005 CANONCITO	DRAWN BY <sub>WCWJ</sub>					
SIND SOL		DATE					
OP CH MEXIC IM	CRADINC AND	8–13–19					

 $G_{\Gamma}$ 20 SCALE: 1"=20'

