CITY OF ALBUQUERQUE

Planning Department
Brennon Williams, Director



Mayor Timothy M. Keller

February 27, 2020

David Soule, PE Rio Grande Engineering 1606 Central SE Suite 201 Albuquerque, NM 87106

Re: Lot 2 Block 3 Unit 22 Volcano Cliffs SAD 228

6332 Camino Alto NW

Request Permanent C.O. - Accepted

Engineer's Stamp dated: 3-27-19 (D10D003R2)

Pad Certification dated: 3/27/19 Certificate of C.O. dated: 2/24/20

Dear Mr. Soule,

PO Box 1293

Based on the Certification received on 2/25/2020, the site is acceptable for release of Certificate of Occupancy by Hydrology.

Albuquerque

If you have any questions, please contact me at 924-3986 or Rudy Rael at 924-3977.

NM 87103

Sincerely,

www.cabq.gov

Ernest Armijo, P.E.

Principal Engineer, Hydrology

Planning

RR/SB

C: File D10D003R2



City of Albuquerque

Planning Department

Development & Building Services Division

DRAINAGE AND TRANSPORTATION INFORMATION SHEET (REV 6/2018)

Project Title: 6332 CAMINO ALTO	Building Permit #:	Hydrology File #:	
DRB#:	EPC#:	Work Order#:	
DRB#: Logal Description: Lot 2 , BLOCK	3 VOLCANO CLIFFS	UNIT 22	
City Address: 6332 CAMINO ALTO	···		
Applicant: Phil Herrera		Contact:	
Address:			
Phone#:			
Other Contact: RIO GRANDE ENGIN			
Address: PO BOX 93924 ALB NM	87199		
Phone#: 505.321.9099	Fax#: 505.872.0999	E-mail: david@riograndee	ngineering.com
TYPE OF DEVELOPMENT:PLAT			
Check all that Apply:			
DEPARTMENT: X HYDROLOGY/ DRAINAGE TRAFFIC/ TRANSPORTATION TYPE OF SUBMITTAL: X ENGINEER/ARCHITECT CERTIFICATION PAD CERTIFICATION CONCEPTUAL G & D PLAN GRADING PLAN DRAINAGE REPORT DRAINAGE MASTER PLAN FLOODPLAIN DEVELOPMENT PERMIT ELEVATION CERTIFICATE CLOMR/LOMR TRAFFIC CIRCULATION LAYOUT (TCL TRAFFIC IMPACT STUDY (TIS) STREET LIGHT LAYOUT OTHER (SPECIFY) PRE-DESIGN MEETING? IS THIS A RESUBMITTAL?: X Yes N DATE SUBMITTED:	BUBU	F APPROVAL/ACCEPTANCE SOUGHT ILDING PERMIT APPROVAL RTIFICATE OF OCCUPANCY ELIMINARY PLAT APPROVAL E PLAN FOR SUB'D APPROVAL E PLAN FOR BLDG. PERMIT APPROVAL AL PLAT APPROVAL VRELEASE OF FINANCIAL GUARANTE UNDATION PERMIT APPROVAL ADING PERMIT APPROVAL -19 APPROVAL VING PERMIT APPROVAL ADING/PAD CERTIFICATION ORK ORDER APPROVAL OMR/LOMR OODPLAIN DEVELOPMENT PERMIT HER (SPECIFY)	L
DATE SUBMITTED:	•		_
COA STAFF:	ELECTRONIC SUBMITTAL RE	ECEIVED:	

FEE PAID:_____

Weighted E Method

								100-Year, 6-hr.					
Basin	Area	Area	Treati	ment A	Treat	ment B	Treatr	ment C	Treatr	ment D	Weighted E	Volume	Flow
	(sf)	(acres)	%	(acres)	%	(acres)	%	(acres)	%	(acres)	(ac-ft)	(ac-ft)	cfs
ALLOWED	13446.00	0.309	0%	0	20%	0.062	46%	0.142	34%	0.105	1.259	0.032	0.99
PROPOSED	13446.00	0.309	0%	0	30%	0.093	43%	0.1327	27%	0.083	1.159	0.030	0.93
COMPARISON												-0.003	

Weighted E = Ea*Aa + Eb*Ab + Ec*Ac + Ed*Ad / (Total Area)

Volume = Weighted D * Total Area

Flow = Qa * Aa + Qb * Ab + Qc * Ac + Qd * Ad

Where for 100-year, 6-hour storm-zone

Eb= 0.67 Qb= 2.03 Qc= 2.87 Ec= 0.99 Qd= 4.37

ONSITE Conditions

FIRST FLUSH WATER QUALITY VOLUME REQUIRED

PROVIDED (CF) 745 745 WATER QUALITY FLOOD CONTROL

This site is within the SAD 226 Master Drainage plan boundaries. The site is to maintain existing patterns and drain as much as possible to the adjacent roadway to the south per the master drainage plan. We are ponding the water harvest volume generated by the site

there is not measurable upland flow. This plan does not exceed the allowed impervious area therefore we are notrrequired to retain. This plan is in conformance to the master drainage plan

I, DAVID SOULE HAVE PERSONALLY INPECTED THE SITE. I HEREBY CERTIFY THE PAD HAS BEEN CONSTRUCTED SUCH THAT IT IS IN SUBSTANTIAL CONFORMANCE TO THE APPROVED GRADING PLAN DATED 3/27/19





EROSION CONTROL NOTES:

- 1. CONTRACTOR IS RESPONSIBLE FOR OBTAINING A TOPSOIL DISTURBANCE PERMIT PRIOR TO BEGINNING WORK.
- 2. CONTRACTOR IS RESPONSIBLE FOR MAINTAINING RUN-OFF ON SITE DURING CONSTRUCTION.
- 3. CONTRACTOR IS RESPONSIBLE FOR CLEANING ALL SEDIMENT THAT GETS INTO EXISTING RIGHT-OF-WAY.
- 4. REPAIR OF DAMAGED FACILITIES AND CLEANUP OF SEDIMENT ACCUMULATIONS ON ADJACENT PROPERTIES AND IN PUBLIC FACILITIES IS THE RESPONSIBILITY OF THE CONTRACTOR.

5. ALL EXPOSED EARTH SURFACES MUST BE PROTECTED FROM WIND AND WATER EROSION PRIOR TO FINAL ACCEPTANCE OF ANY PROJECT.

I <u>David Soule</u>, NMPE 14522, of the firm <u>Rio Grande Engineering</u>, hereby certify that this project has been graded and will drain in substantial compliance with and in accordance with the design intend of the approved plan dated 3/27/19. The record information edited on the original design document has performed by me or under my direct supervision and is true and correct to the best of my knowledge and belief. The asbuilt survey was provided by THOMAS PATRICK NMPS 12651. The certification is submitted in support of a request for PERMANENT CERTIFICATE OF OCCUPANCY. The record information presented heron is not necessarily complete and intended only to verify substantial compliance of the grading and drainage aspects of this project. Those relying on this record document are advised to obtain independent verification of its accuracy before using it for any other purpose

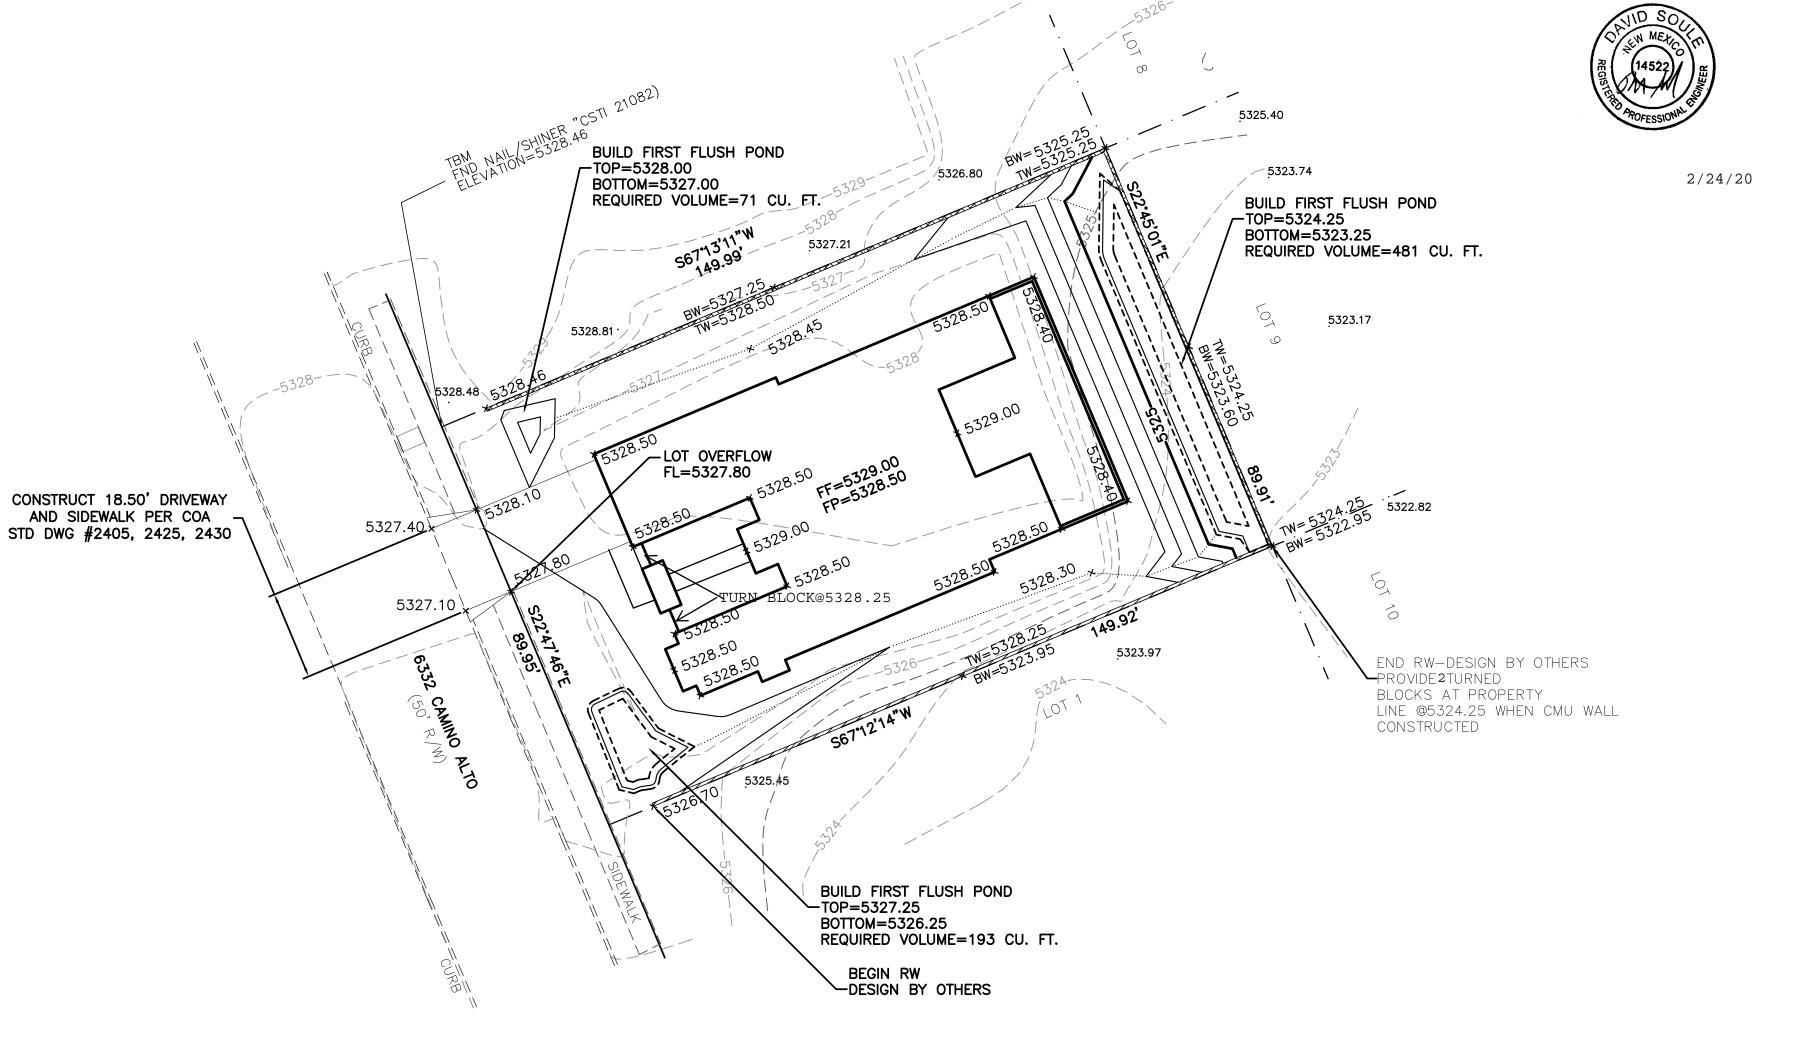


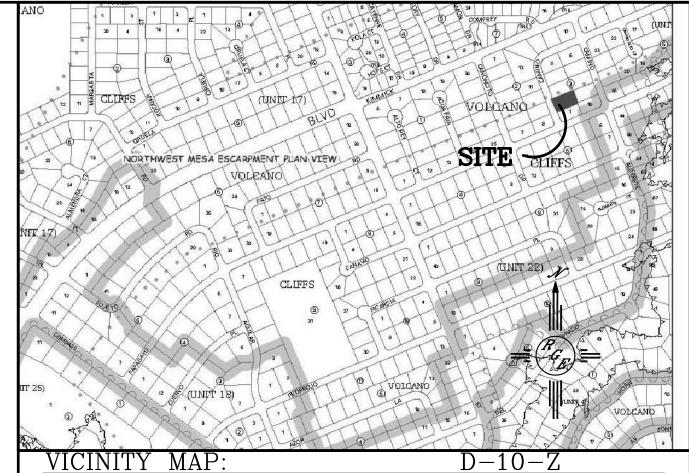

Without Base Flood Elevation (BFE)
Zone A. V. A99
With BFE or Depth Zone AE, AO, AH, VE, AR
Regulatory Floodway

No Digital Data Available

The pin displayed on the map is an appropoint selected by the user and does not r

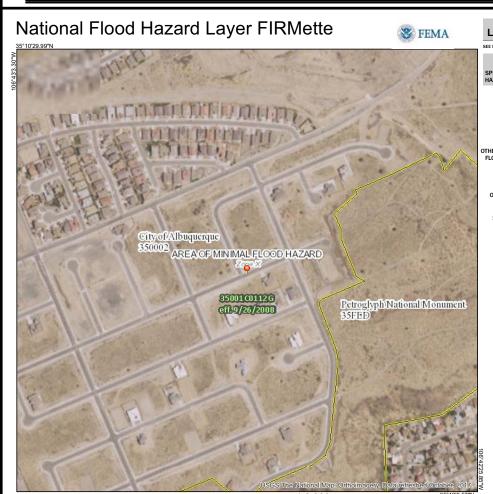

FIRM MAP:

LEGAL DESCRIPTION: LOT 2, BLOCK 3, VOLCANO CLIFFS UNIT 22

NOTES:

1. ALL SPOT ELEVATIONS REPRESENT FLOWLINE ELEVATION UNLESS OTHERWISE


2. ALL SLOPES SHALL BE 3:1 MAX. AND GRAVEL OR NATIVE SEEDING PRIOR TO CO.

PROPOSED CMU SCREEN WALL (12" MAX. RETAINAGE)

PROPOSED RETAINING WALL-DESIGN BY OTHERS

LEGEND

----EXISTING CONTOUR ---- EXISTING INDEX CONTOUR — PROPOSED CONTOUR PROPOSED INDEX CONTOUR SLOPE TIE EXISTING SPOT ELEVATION × XXXX * XXXX PROPOSED SPOT ELEVATION ---- BOUNDARY CENTERLINE RIGHT—OF—WAY

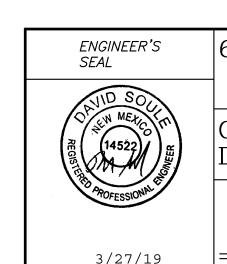

SCALE: 1"=20'

6332 CAMINO ALTO DRAWN BY WCWJ 3-26-19 GRADING AND DRAINAGE PLAN SHEET #

2109026-LAYOUT-3-26-Rio Grande ___ Lingineering 3/27/19 1606 CENTRAL AVENUE SE JOB # ALBUQUERQUE, NM 87106 (505) 872-0999 DAVID SOULE P.E. #14522 2109026

CAUTION:

EXISTING UTILITIES ARE NOT SHOWN. IT SHALL BE THE SOLE RESPONSIBILITY OF THE CONTRACTOR TO CONDUCT ALL NECESSARY FIELD INVESTIGATIONS PRIOR TO ANY EXCAVATION TO DETERMINE THE ACTUAL LOCATION OF UTILITIES & OTHER IMPROVEMENTS.