
TOP POND=23.75 BOTTOM POND=23.00 VOLUME= 275 CF LOT 6, BLOCK 5 **VOLCANO CLIFFS UNIT 22** NOTE: WATER QUALITY REQUIREMENT= .34" X SITE AREA=453.33 CF TOP POND=23.00 BOTTOM=22.25 VO/LUME=310.00 CF LOT 4, BLOCK 5 **VOLCANO CLIFFS UNIT 22** LOT 7, BLOCK 5 VOLCANO CLIFFS UNIT 22 LOT 8, BLOCK 5 REBAR-CAP RL=5325.56 **VOLCANO CLIFFS UNIT 22**


COORDINATES SYSTEM IS NEW MEXICO STATE PLANE CENTRAL ZONE NAD1983/NAVD 1988 AND ARE REFERENCED TO THE ALBUQUERQUE GEODETIC REFERENCE SYSTEM AS DETERMINED BY GPS OBSERVATIONS OBTAINED USING THE ALBUQUERQUE REAL TIME GNSS NETWORK (ARTGN). DISTANCES ARE GROUND. THESE VALUES WERE PROVIDED BY CONSTRUCTION SURVEY TECHNOLOGIES NMPLS 21082

LOT 9, BLOCK 5 **VOLCANO CLIFFS UNIT 22**

EROSION CONTROL NOTES:

- 1. CONTRACTOR IS RESPONSIBLE FOR OBTAINING A TOPSOIL DISTURBANCE PERMIT PRIOR TO BEGINNING WORK.
- 2. CONTRACTOR IS RESPONSIBLE FOR MAINTAINING RUN-OFF ON SITE DURING CONSTRUCTION.
- 3. CONTRACTOR IS RESPONSIBLE FOR CLEANING ALL SEDIMENT THAT GETS INTO EXISTING RIGHT-OF-WAY.
- 4. REPAIR OF DAMAGED FACILITIES AND CLEANUP OF SEDIMENT ACCUMULATIONS ON ADJACENT PROPERTIES AND IN PUBLIC FACILITIES IS THE RESPONSIBILITY OF THE CONTRACTOR.
- 5. ALL EXPOSED EARTH SURFACES MUST BE PROTECTED FROM WIND AND WATER EROSION PRIOR TO FINAL (CITY) ACCEPTANCE OF ANY PROJECT.

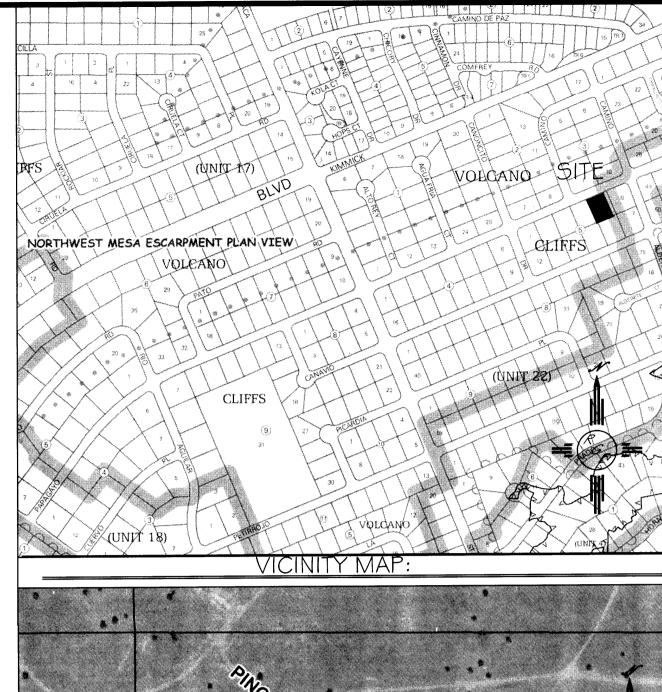


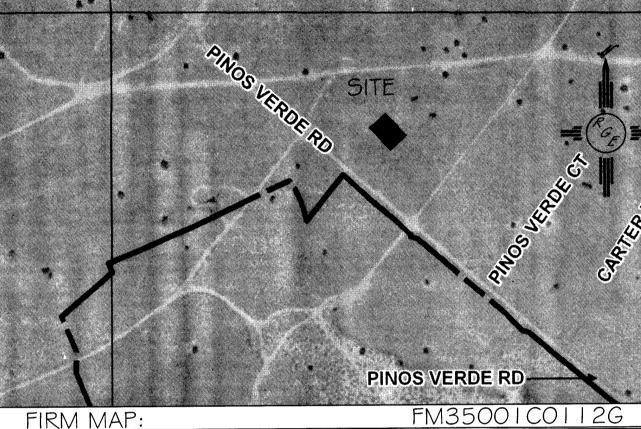

LEGAL DESCRIPTION: LOT 5, BLOCK 5, UNIT 22, VOLCANO CLIFFS

- 1. ALL SPOT ELEVATIONS REPRESENT FLOWLINE ELEVATION UNLESS OTHERWISE NOTED. 2. TOPOGRAPHIC SURVEY INFORMATION SHOWN ON THIS PLAN WAS OBTAINED BY CONSTRUCTION SURVEY TECHNOLOGIES, DAVID ACOSTA PLS 2081, DATED MAY 2015
- 3. All PERIMETER FENCING SHALL HAVE TURNED BLOCKS EVERY 16' TO ALLOW FOR CROSS LOT DRAINAGE. ALL WALLS SHALL HAVE 18" MAXIMUM RETAINAGE

LEGEND

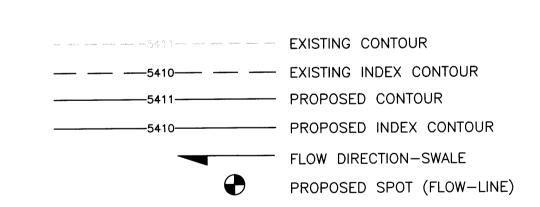





ENGINEER'S SEAL
REGISTORESSIONALE
5/11/15


DAVID SOULE P.E. #14522


'S	LOT 5, BLOCK 5, UNIT 22 VOLCANO CLIFFS SUBDIVISION	DRAWN BY _{JDG}
\sim	AUDRY EAGLE RESIDENCE	DATE 05-12-15
SAGMEER 3	GRADING AND DRAINAGE PLAN	
	Rio Grande	SHEET #
	Engineering 1606 CENTRAL AVENUE SE	1 OF 1
	SUITE 201 ALBUQUERQUE, NM 87106 (505) 872-0999	JOB #

I, DAVID SOULE HAVE PERSONALLY VISITED THE SITE AND VERIFY THE SITE HAS BEEN GRADED IN SUBSTANTIAL CONFORMANCE TO THE APPROVED



11/24/15

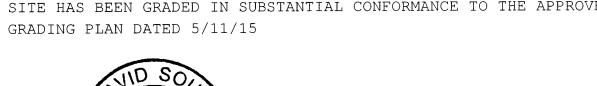

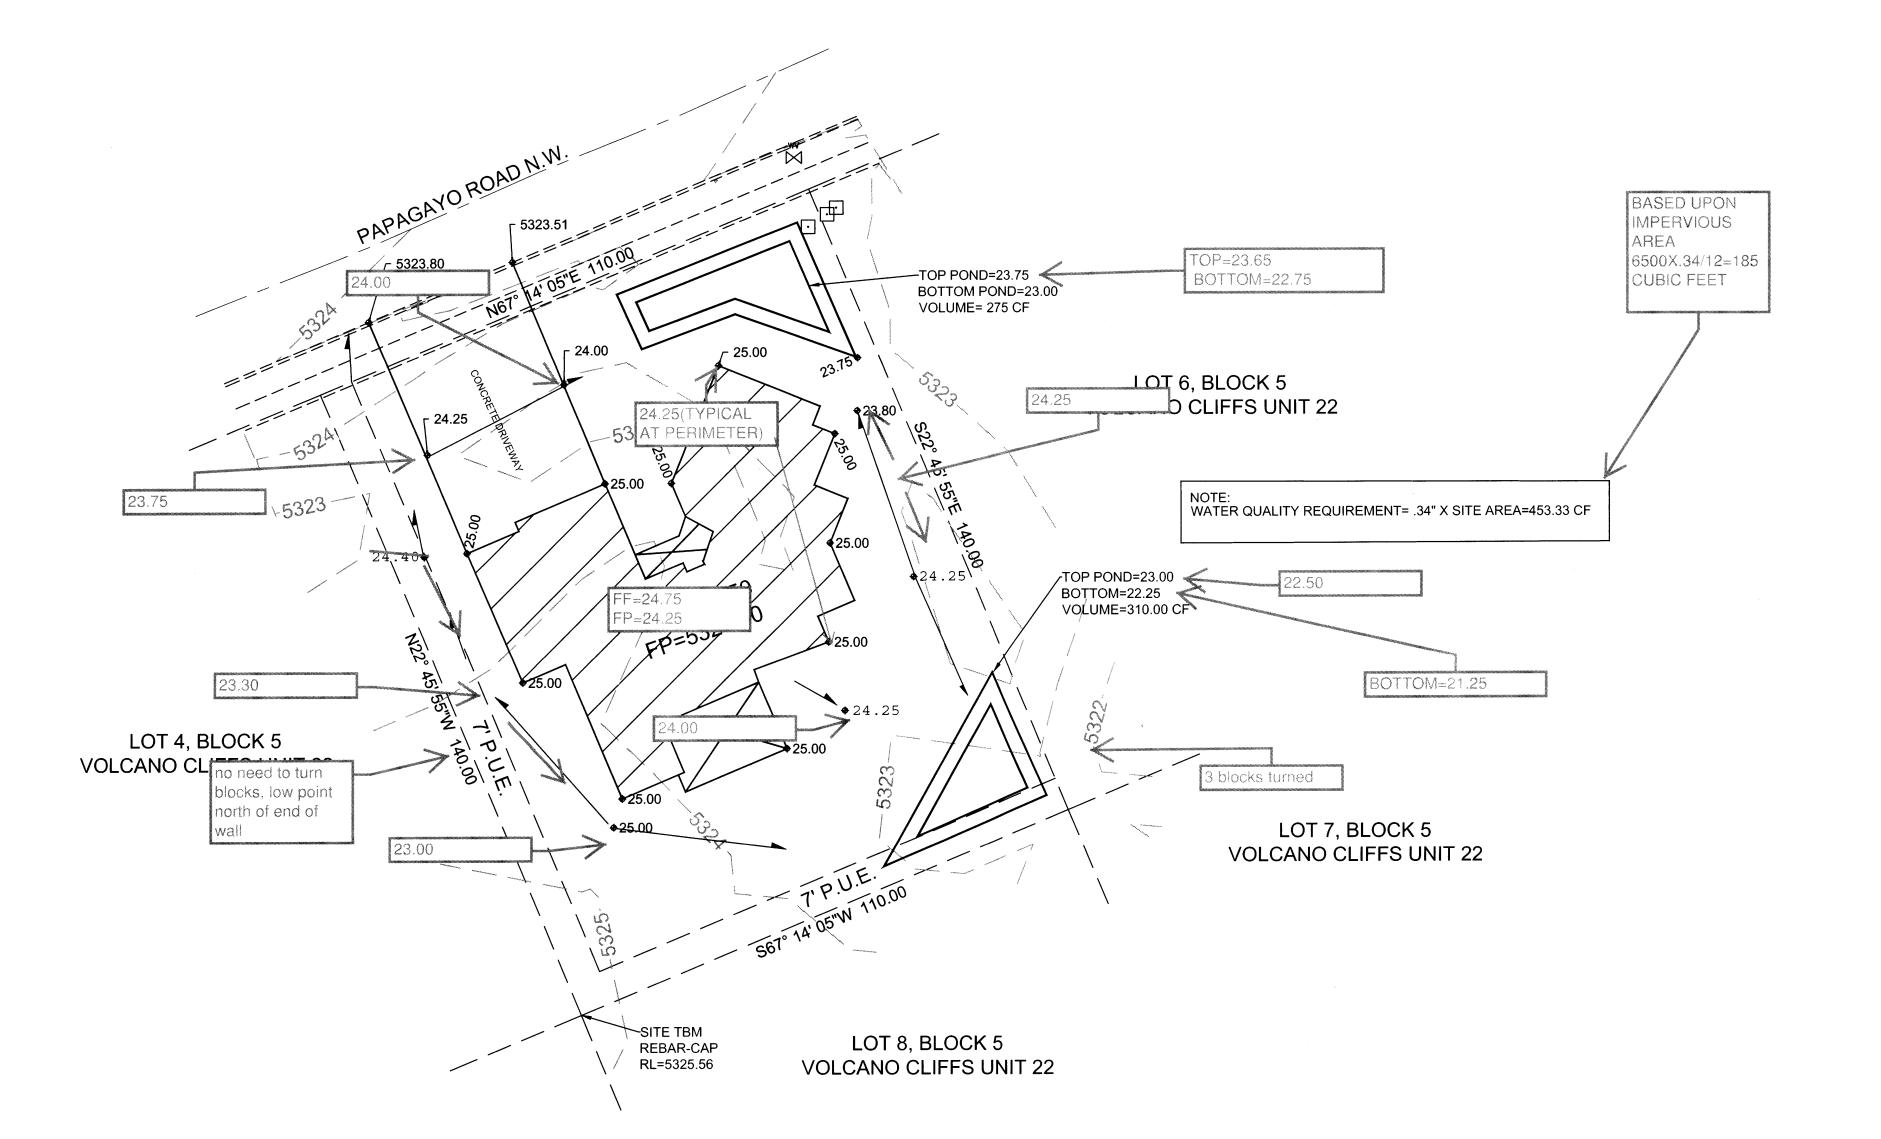


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LOT 9, BLOCK 5 **VOLCANO CLIFFS UNIT 22**

EROSION CONTROL NOTES:

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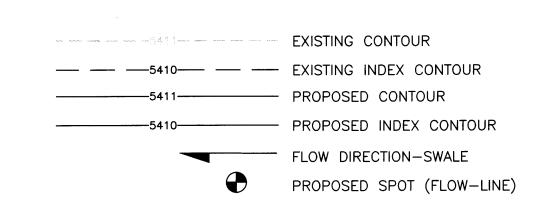
LEGAL DESCRIPTION: LOT 5, BLOCK 5, UNIT 22, VOLCANO CLIFFS

NOTES:

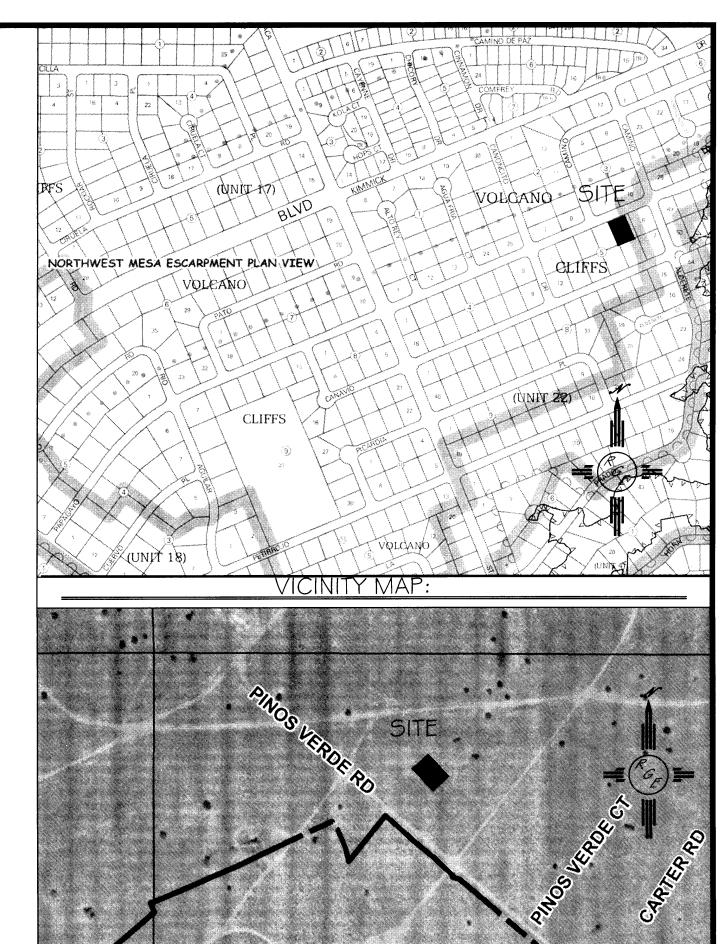FIRM MAP:

- I. ALL SPOT ELEVATIONS REPRESENT FLOWLINE ELEVATION UNLESS OTHERWISE NOTED. 2. TOPOGRAPHIC SURVEY INFORMATION SHOWN ON THIS PLAN WAS OBTAINED BY CONSTRUCTION SURVEY TECHNOLOGIES, DAVID ACOSTA PLS 2081, DATED MAY 2015
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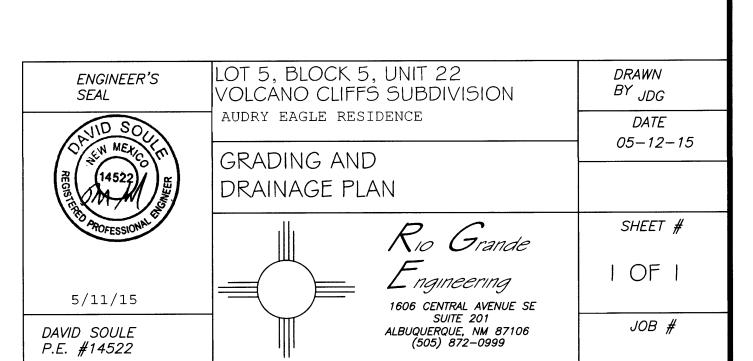
LEGEND



PINOS VERDE RD

FM35001C0112G









SCALE: 1"=20'