CITY OF ALBUQUERQUE

Planning Department
Suzanne Lubar, Director



July 20, 2017

David Soule, P.E. Rio Grande Engineering PO Box 93924 Albuquerque, New Mexico 87199

RE: Lot 15 Block 2 Unit 5 Unser Cliffs SAD 227 6912 Rimrock NW

Grading and Drainage Plan

Engineers Stamp Date 7/18/17 (D10D009)

Dear Mr. Soule,

PO Box 1293

Albuquerque

New Mexico 87103

www.cabq.gov

Based upon the information provided in your submittal received 7/18/17, this plan is approved for Grading Permit.

Please inform the builder/owner to attach a copy of this approved plan to the construction sets in the permitting process prior to sign-off by Hydrology.

Reiterate to the Owner/Contractor that a separate permit for a garden/retaining wall must be obtained, with the approved G&D plan dated 7/18/17.

Prior to Building permit approval a Pad Certification will be required, provided by the Engineer or a registered Land Surveyor.

Prior to Certificate of Occupancy release, Engineer Certification per the DPM checklist of this plan will be required.

If you have any questions, please contact me at 924-3695 or Rudy Rael at 924-3977.

Sincerely,

James D. Hughes, P.E.

Principal Engineer, Hydrology

Planning Department

RR/JH C: File



City of Albuquerque

Planning Department

Development & Building Services Division

DRAINAGE AND TRANSPORTATION INFORMATION SHEET (REV 09/2015)

Project Title:	Building Permit #: City Drainage #: D10D009
DRB#: EPC#:	
Legal Description:	
City Address:	
Engineering Firm:	Contact:
Address:	
Phone#: Fax#:	E-mail:
Owner:	Contact:
Address:	
	E-mail:
Architect:	Contact:
Address:	
DI "	E-mail:
Other Contact:	Contact:
Address:	
	E-mail:
DEPARTMENT: HYDROLOGY/ DRAINAGE TRAFFIC/ TRANSPORTATION MS4/ EROSION & SEDIMENT CONTROL	CHECK TYPE OF APPROVAL/ACCEPTANCE SOUGHT: BUILDING PERMIT APPROVAL CERTIFICATE OF OCCUPANCY
TYPE OF SUBMITTAL:	DDELIMINADY DI AT ADDDONAL
ENGINEER/ ARCHITECT CERTIFICATION	PRELIMINARY PLAT APPROVAL SITE PLAN FOR SUB'D APPROVAL
	SITE PLAN FOR BLDG. PERMIT APPROVAL
CONCEPTUAL G & D PLAN	FINAL PLAT APPROVAL
GRADING PLAN	SIA/ RELEASE OF FINANCIAL GUARANTEE
DRAINAGE MASTER PLAN	FOUNDATION PERMIT APPROVAL
DRAINAGE REPORT	GRADING PERMIT APPROVAL
CLOMR/LOMR	SO-19 APPROVAL
TRAFFIC CIRCULATION LAYOUT (TCL)	PAVING PERMIT APPROVAL
TRAFFIC IMPACT STUDY (TIS)	GRADING/ PAD CERTIFICATION WORK ORDER APPROVAL
EROSION & SEDIMENT CONTROL PLAN (ESC)	CLOMR/LOMR
	
OTHER (SPECIFY)	PRE-DESIGN MEETING
	OTHER (SPECIFY)
IS THIS A RESUBMITTAL?: Yes No	
	;

COA STAFF: ELECTRONIC SUBMITTAL RECEIVED: ____

CITY OF ALBUQUERQUE

Planning Department
Suzanne Lubar, Director



July 18, 2017

David Soule, P.E. Rio Grande Engineering PO Box 93924 Albuquerque, New Mexico 87199

RE: Lot 15 Block 2 Unser Cliffs SAD 227 6912 Rimrock NW Grading and Drainage Plan Engineers Stamp Date 7/16/17 (D10D009)

Dear Mr. Soule,

Based upon the information provided in your submittal received 7/17/17, this plan cannot be approved for Grading Permit until the following comments are addressed.

- Provide a statement on the plan stating that this grading plan must be used for the application of any garden/retaining walls. added language to note #3
- Provide a statement that a Pad Certification is required before building permit can be approved. note#4 shows this

Albuquerque

PO Box 1293

Please inform the builder/owner to attach a copy of this approved plan to the construction sets in the permitting process prior to sign-off by Hydrology for pad certification.

New Mexico 87103

Prior to Certificate of Occupancy release, Engineer Certification per the DPM checklist of this plan will be required.

www.cabq.gov

If you have any questions, please contact me at 924-3986 or Rudy Rael at 924-3977.

Sincerely,

James D. Hughes, P.E.

Principal Engineer, Hydrology

Planning Department

RR/JH C: File

Weighted E Method 100-Year, 6-hr. Area Area Treatment A Treatment B Treatment C Treatment D Weighted Volume (acres) % (acres) % (acres) % (acres) % (acres) % 13328.00 0.306 0% 0 10% 0.031 40% 0.1224 50% 0.153 1.448 0.037 13328.00 0.306 0% 0 25% 0.076 29% 0.0887 46% 0.141 1.361 0.035 PROPOSED **Equations:** Weighted $E = Ea^*Aa + Eb^*Ab + Ec^*Ac + Ed^*Ad / (Total Area)$ Volume = Weighted D * Total Area Flow = Qa * Aa + Qb * Ab + Qc * Ac + Qd * Ad Where for 100-year, 6-hour storm-zone 1 Qb= 2.03 Eb= 0.67 Ec= 0.99 Qc= 2.87 Ed= 1.97 Qd= 4.37 BUILD WATER HARVESTING POND TOP=5324.25 BOTTOM=5323.75 **ONSITE Conditions** FIRST FLUSH WATER QUALITY VOLUME PROPOSED VOLUME=132 CU. FT. REQUIRED PROVIDED (CF) 283 (CF) FND REBAR/CAP WATER QUALITY . 174 LS "14733" ELEVATION=5324.11 Narrative ----This site is within the SAD 226 Master Drainage plan boundaries. The site is to maintain existing patterns and drain to the the adjacent roadway per the master drainage plan. We are ponding the water harvest volume generated by the site there is not measurable upland flow. This plan has a shallow water harvest pond in excess of the drainage regulations. This plan is in conformance to the master drainage plan EXISTING CMU WALL -CONSTRUCT 20' DRIVEWAY AND SIDEWALK PER COA END 2' EARTHEN SWALE -STD DWG #2405, 2425, 2430 FF=5325.50/ FP=5325.00 L=69.00' C=68.98' R=862.00' CB=N24'59'45"W ?=4'35'11") C=69.02'CB=N24*56'50"W ?=4*35'19" BUILD WATER HARVESTING POND TOP=5324.25 END 2' EARTHEN SWALE-BOTTOM=5323.75 PROPOSED VOLUME=151 CU. FT. (C2: R=982.00'

L=78.61'

C=78.58'

?=4'35'11")

CB=N24'59'45"W

C2: R=982.00'

L=78.72'

C=78.70'


CB=N25°08'15"W ?=4'35'36"

CAUTION: EXISTING UTILITIES ARE NOT SHOWN. IT SHALL BE THE SOLE RESPONSIBILITY OF THE CONTRACTOR TO CONDUCT ALL NECESSARY FIELD INVESTIGATIONS PRIOR TO ANY EXCAVATION TO DETERMINE THE ACTUAL LOCATION OF UTILITIES & OTHER IMPROVEMENTS.

EROSION CONTROL NOTES:

1. CONTRACTOR IS RESPONSIBLE FOR OBTAINING A TOPSOIL DISTURBANCE PERMIT PRIOR TO BEGINNING WORK.

- 2. CONTRACTOR IS RESPONSIBLE FOR MAINTAINING RUN-OFF ON SITE DURING CONSTRUCTION.
- 3. CONTRACTOR IS RESPONSIBLE FOR CLEANING ALL SEDIMENT THAT GETS INTO EXISTING RIGHT-OF-WAY.
- 4. REPAIR OF DAMAGED FACILITIES AND CLEANUP OF SEDIMENT ACCUMULATIONS ON ADJACENT PROPERTIES AND IN PUBLIC FACILITIES IS THE RESPONSIBILITY OF THE CONTRACTOR.
- 5. ALL EXPOSED EARTH SURFACES MUST BE PROTECTED FROM WIND AND WATER EROSION PRIOR TO FINAL ACCEPTANCE OF ANY PROJECT.

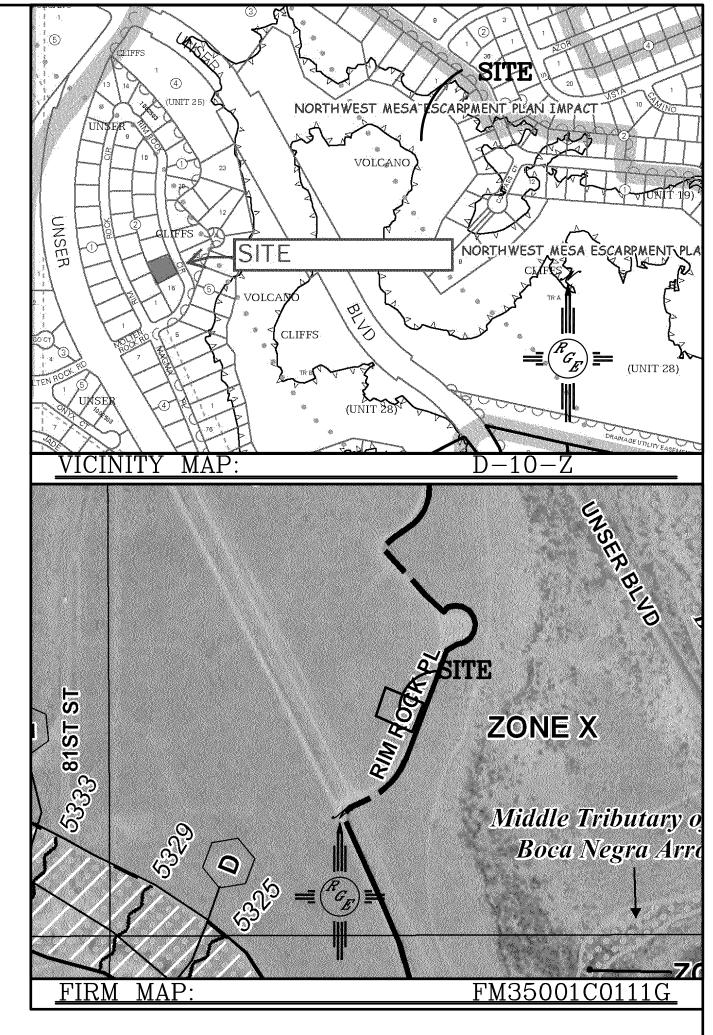

LEGAL DESCRIPTION:
LOT 15, BLOCK 2 UNSER CLIFFS SUBDIVISION

NOTES:

1. ALL SPOT ELEVATIONS REPRESENT FLOWLINE ELEVATION UNLESS OTHERWISE

2. ALL SLOPES SHALL BE 3:1 MAX. AND GRAVEL OR NATIVE SEEDING PRIOR TO CO.


3. ANY PERIMETER WALLS MUST BE PERMITED SEPARATELY. ALL RETAINING WALL DESIGN SHALL BE BY OTHERS.

THIS PLAN MUST BE SUBMITTED WHEN PERMITTING ANY WALLS. 4. A PAD CERTIFICATION IS REQUIRED PRIOR TO RELEASE OF BUILDING PERMIT


LEGEND

---- EXISTING CONTOUR ---- EXISTING INDEX CONTOUR PROPOSED INDEX CONTOUR SLOPE TIE **EXISTING SPOT ELEVATION** * XXXX × XXXX PROPOSED SPOT ELEVATION BOUNDARY CENTERLINE — RIGHT—OF—WAY

PROPOSED CMU SCREEN WALL 0'-3' MAX RETAINAGE (DESIGN BY OTHERS)

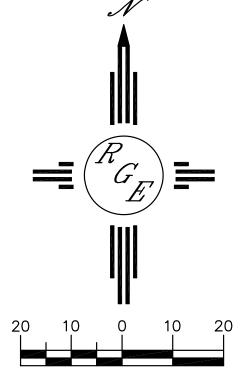

SCALE: 1"=20'

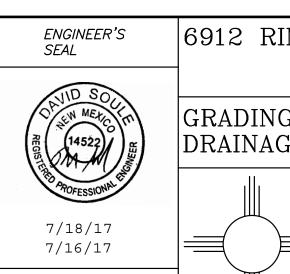

6912 RIM ROCK DRAWN BY WCWJ DATE 7-15-17 GRADING AND DRAINAGE PLAN 21764-LAYOUT-7-14-1 SHEET # Rio Grande

JOB #

21764

Lingineering 1606 CENTRAL AVENUE SE ALBUQUERQUE, NM 87106 (505) 872-0999

DAVID SOULE P.E. #14522