CITY OF ALBUQUERQUE

Planning Department Brennon Williams, Director



Mayor Timothy M. Keller

September 15, 2020

David Soule, P.E. Rio Grande Engineering PO Box 93924 Albuquerque, New Mexico 87199

RE: Lot 9 Block 2 Unit 28 SAD 227 6708 Rimrock NW Grading and Drainage Plan Engineers Stamp Date 2/21/2020 (D10D019) Pad Certification Date 8/14/2020

Dear Mr. Soule,

PO Box 1293 Based upon the information provided in your submittal received 9/15/2020, this plan is approved for Building Permit.

Albuquerque Please inform the builder/owner to attach a copy of this approved plan and this letter to the construction sets in the permitting process prior to sign-off by Hydrology.

NM 87103Reiterate to the Owner/Contractor that a separate permit for a garden/retaining wall must be
obtained, with the approved G&D plan.

Prior to Certificate of Occupancy release, Engineer Certification per the DPM checklist of this plan will be required.

www.cabq.gov

If you have any questions, please contact me at 924-3986 or Rudy Rael at 924-3977.

Sincerely,

Ernest Armijo, P.E. Principal Engineer, Planning Dept. Development Review Services

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EA	(1706)	

City of Albuquerque


Planning Department Development & Building Services Division


DRAINAGE AND TRANSPORTATION INFORMATION SHEET (REV 6/2018)

Project Title: 6708 Rimrock	Building Permit	#:	Hydro	logy File #:
DRB#:	EPC#:		Work	Order#:
Legal Description: LOT 9, Block 2	2 VOLCANO	CLIFFS UNIT	28	
City Address: 6708 RIMROCK				
Applicant:			Contact:	·
Address:				······
Phone#:	_Fax#:		E-mail:	
Other Contact: RIO GRANDE ENGINE	ERING		Contact:	DAVID SOULE
	07100			
Address: <u>PO BOX 93924</u> ALB NM Phone#: <u>505.321.9099</u>	Fax#: 505.872	.0999	E-mail:	lavid@riograndeengineering.com
TYPE OF DEVELOPMENT: PLAT				
Check all that Apply:				
DEPARTMENT: <u> </u>		TYPE OF APPRO	ERMIT APP	
TYPE OF SUBMITTAL: ENGINEER/ARCHITECT CERTIFICATION PAD CERTIFICATION CONCEPTUAL G & D PLAN X GRADING PLAN DRAINAGE REPORT DRAINAGE MASTER PLAN FLOODPLAIN DEVELOPMENT PERMIT A ELEVATION CERTIFICATE CLOMR/LOMR TRAFFIC CIRCULATION LAYOUT (TCL) TRAFFIC IMPACT STUDY (TIS) STREET LIGHT LAYOUT OTHER (SPECIFY)	PPLIC	FINAL PLAT SIA/ RELEA FOUNDATIC GRADING P SO-19 APPR PAVING PEI GRADING/ F WORK ORDE CLOMR/LOM	FOR SUB'D FOR BLDG. 1 C APPROVA SE OF FINAN ON PERMIT A ERMIT APPROVAL RMIT APPROVA AD CERTIF & APPROVA MR N DEVELOP	APPROVAL PERMIT APPROVAL L NCIAL GUARANTEE APPROVAL ROVAL DVAL DVAL L MENT PERMIT
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	Ec= 0.99 Ed= 1.97	Qc= 2.87 Qd= 4.37			 	//			
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OOD CONTROL	142	188		 ;					
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OF THE CONTRACTOR TO CONDUCT ALL NECESSARY FIELD INVESTIGATIONS PRIOR TO ANY EXCAVATION TO DETERMINE THE ACTUAL LOCATION OF UTILITIES & OTHER IMPROVEMENTS.



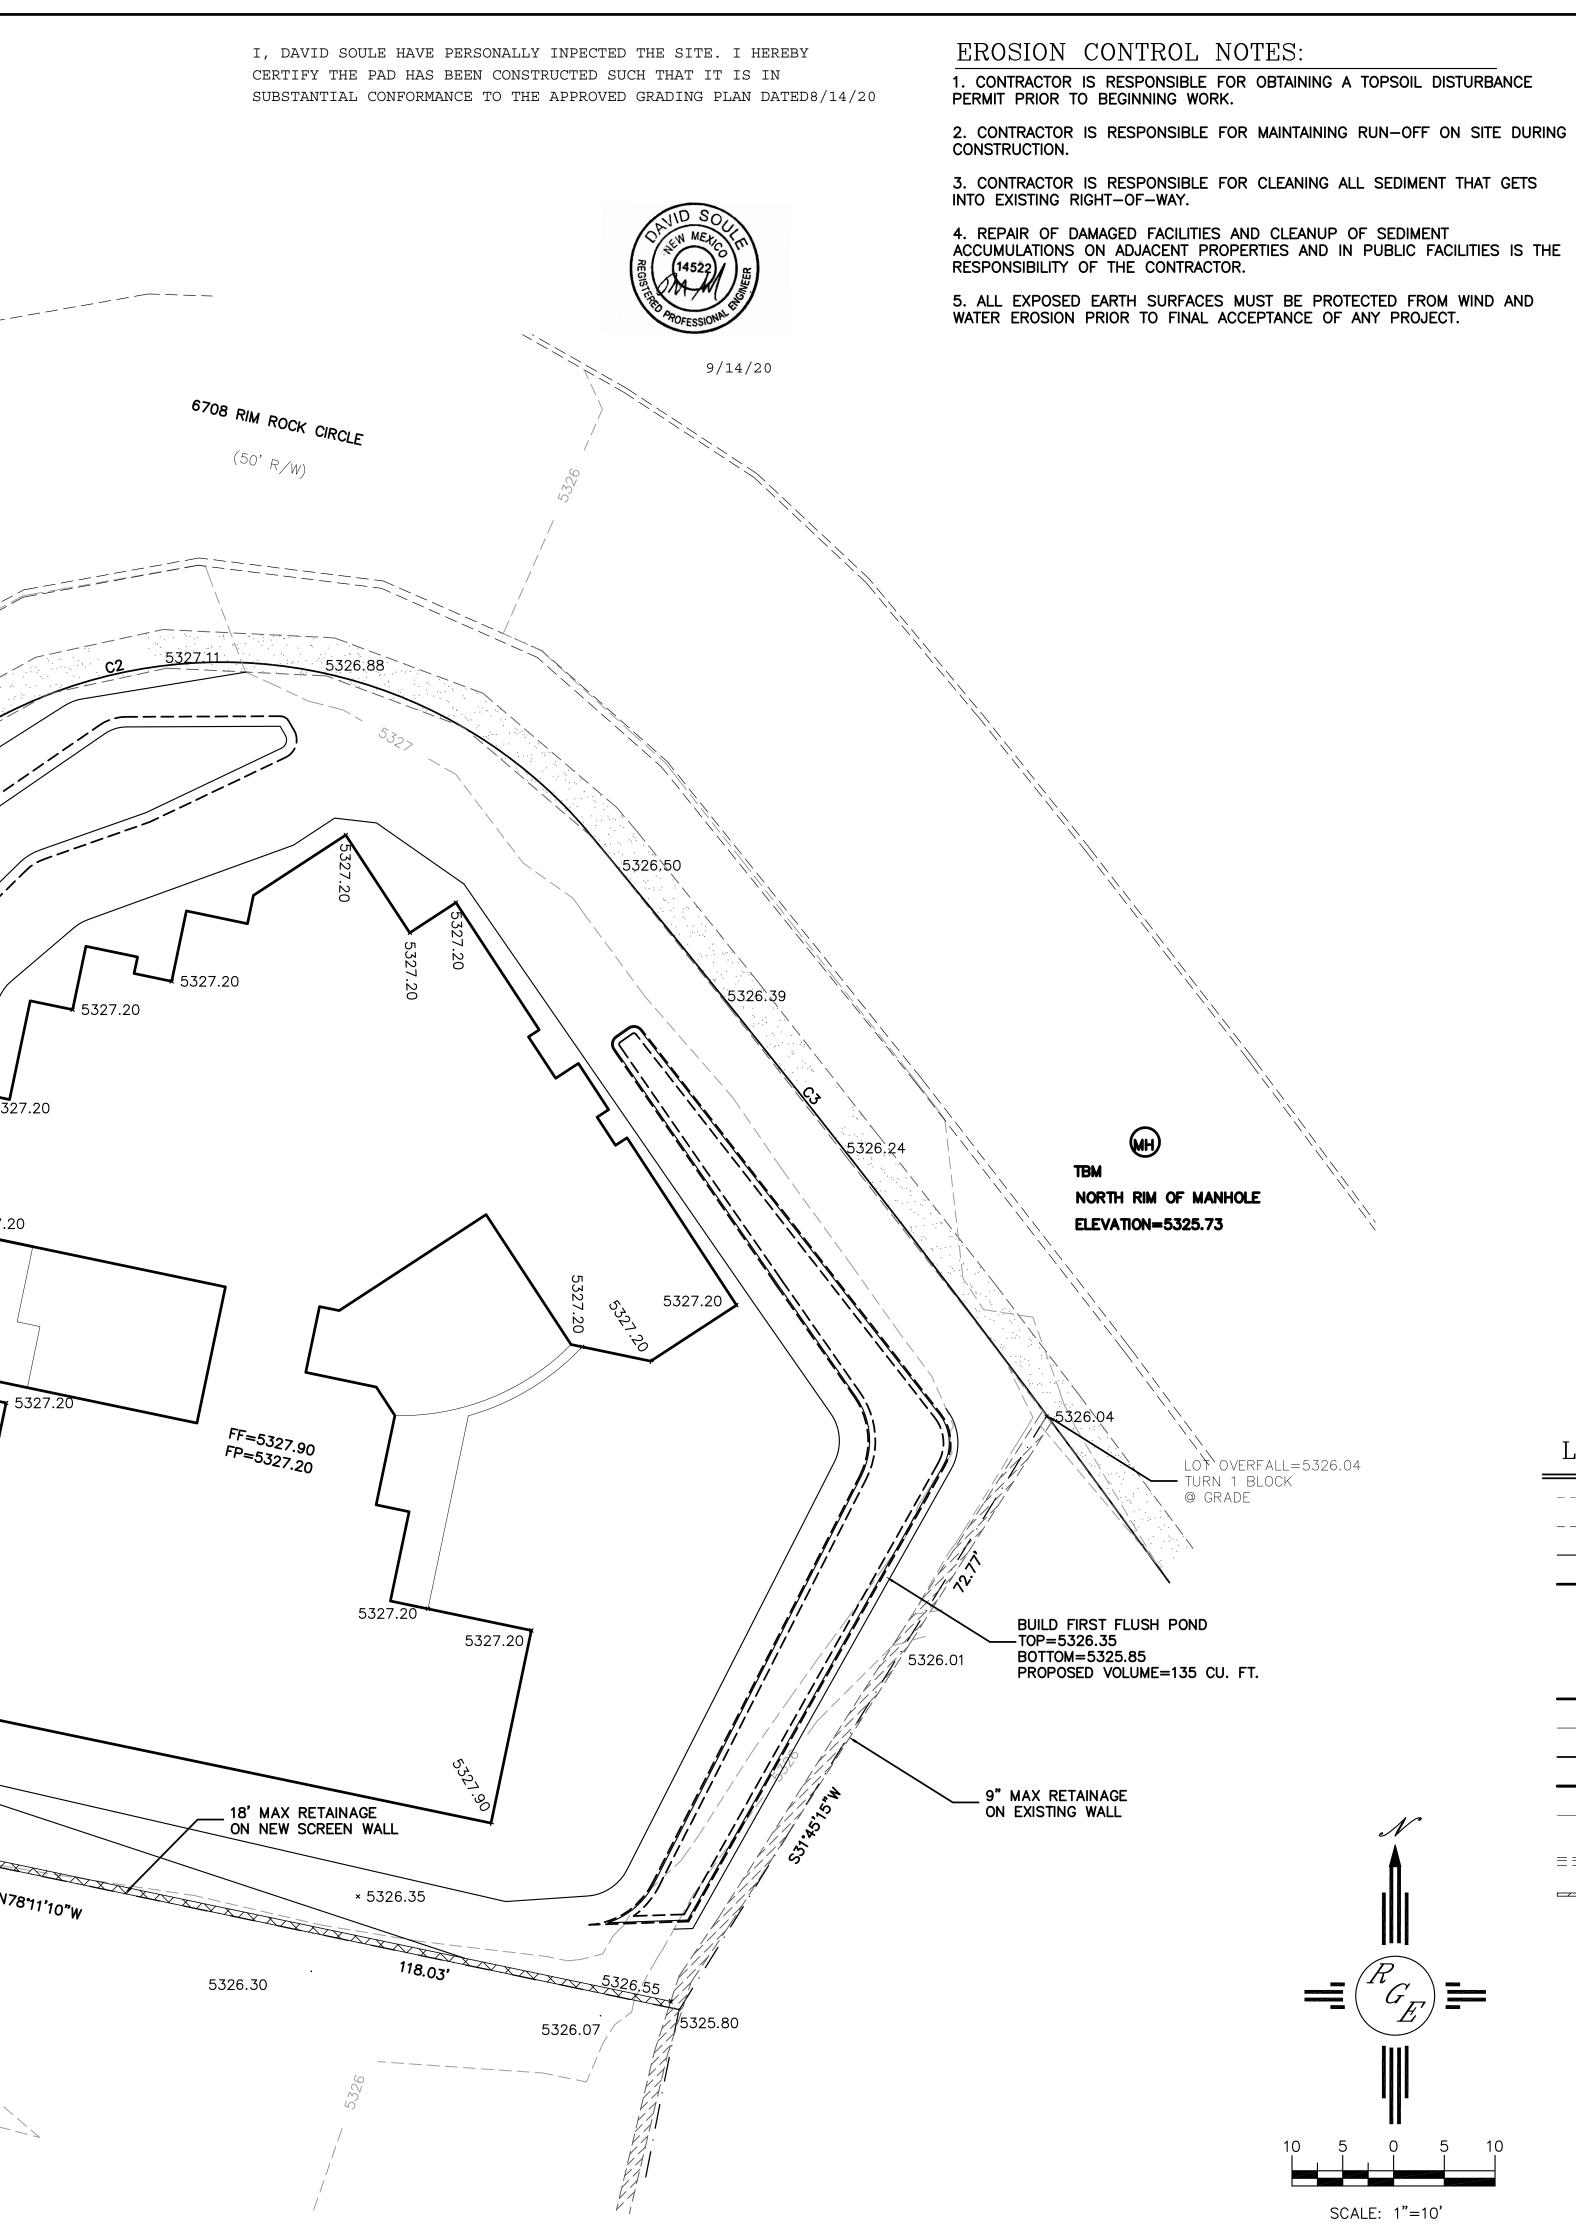

NOTES:

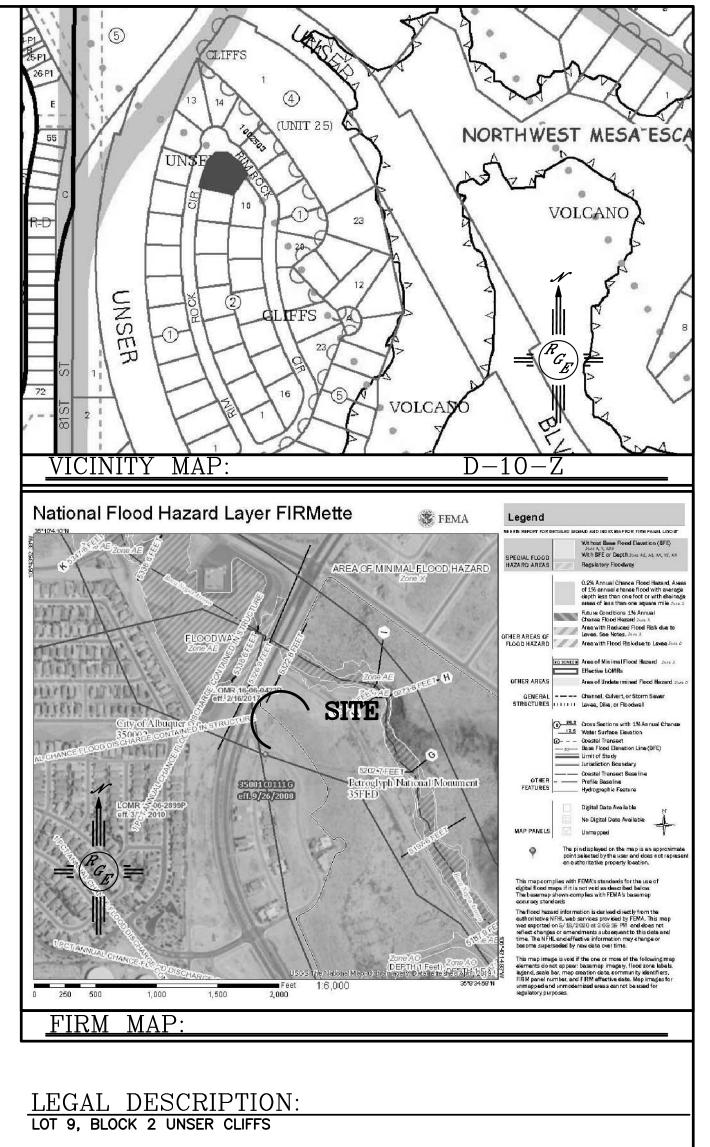1. ALL SPOT ELEVATIONS REPRESENT FLOWLINE ELEVATION UNLESS OTHERWISE NOTED.

2. ALL SLOPES SHALL BE 3:1 MAX. AND GRAVEL OR NATIVE SEEDING PRIOR TO CO.

LEGEND

8/14/20

DAVID SOULE P.E. #14522

	- EXISTING CONTOUR				
	EXISTING INDEX CONTOUR				
XXXX	PROPOSED CONTOUR				
	- PROPOSED INDEX CONTOUR				
►	SLOPE TIE				
× XXXX	EXISTING SPOT ELEVATION				
× XXXX	PROPOSED SPOT ELEVATION				
	BOUNDARY				
	- CENTERLINE				
	RIGHT-OF-WAY				
PROPOSED 4" PVC SD					
$\equiv \equiv \equiv$ EXISTING CURB AND GUTTER					
PROPOSED CMU RETAINING WAL-DESIGN BY OTHERS					
ENGINEER'S SEAL	6708 RIM ROCK	DRAWN BY _{WCWJ}			
VIID SOL		DATE			
MEN MEN	GRADING AND	52020			
2 14522 1	DRAINAGE PLAN	2102039-LAYOUT-5-20-20			
13 APOFESSION NL	Rio Granda	SHEET #			


Rio Grande

Engineering

1606 CENTRAL AVENUE SE SUITE 201 ALBUQUERQUE, NM 87106 (505) 872–0999

JOB #

2102039

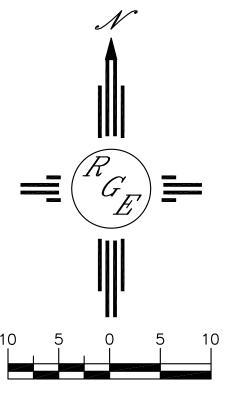

SCALE: 1"=10'