CITY OF ALBUQUERQUE

Planning Department Alan Varela, Director



Mayor Timothy M. Keller

April 26, 2023

Reza Afaghpour, PE SBS Construction and Engineering, LLC 10209 Snowflake Ct NW Albuquerque, NM 87114

RE: Lot 8 Block 2 Unser Cliffs SAD 227 6704 Rim Rock Circ. NW Grading and Drainage Plan Engineers Stamp Date 3/25/2023 (D10D025)

Mr. Afaghpour,

Based upon the information provided in your submittal received 4/7/2023, this plan is approved for grading plan.

Please inform the builder/owner to attach a copy of this approved plan and this letter to the construction sets in the permitting process prior to sign-off by Hydrology.

Reiterate to the Owner/Contractor that a separate permit for a garden/retaining wall must be obtained, with the approved G&D plan and Pad Certification. <u>Advise the owner &</u> <u>Contractor that dirt is not allowed in the public right of way to climb the curb. Crusher</u> <u>fines or lumber is allowed. If dirt is used this will delay going forward with the construction</u> <u>of the home.</u>

Prior to Certificate of Occupancy release, Engineer Certification per the DPM checklist of this plan will be required.

If you have any questions, please contact me at 924-3695 or Rudy Rael at 924-3977.

Sincerely,

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Tiequan Chen, P.E. Principal Engineer, Hydrology Planning Department, Development Review Services

RR/SB File D10D025

	Planning Department	Distriction
	velopment & Building Services	
MELLON DRAINAGE	E AND TRANSPORTATION IN	FORMATION SHEET (REV 6/2018)
Project Title: 6704 Rim Rock Circle, N	W Building Permit #:	Hydrology File #: D10D025
	-	Work Order#:
Legal Description:Lot 8, Block 2, Un		
City Address: 6704 Rim Rock Circle, NW		
Applicant:SBS CONSTRUCTION AN	ND ENGINEEING, LLC	Contact: SHAWN BIAZAR
Address:7632 William Moyers Avenue, I		
Phone#: (505) 804-5013	Fax#: (505) 897-4996	E-mail: AECLLC@AOL.COM
Other Contact:		Contact:
Address:		
		E-mail:
		CE DRB SITE ADMIN SITE
TYPE OF SUBMITTAL: ENGINEER/ARCHITECT CERTIFIC	CATIONCEF	RTIFICATE OF OCCUPANCY
		ELIMINARY PLAT APPROVAL E PLAN FOR SUB'D APPROVAL E PLAN FOR BLDG. PERMIT APPROVAL
CONCEPTUAL G & D PLAN X GRADING PLAN	SITI SITI SITI FIN FIN FOU FOU X GRA CICLO	E PLAN FOR SUB'D APPROVAL

Location

This project is located at 6704 Rim Rock Cir. Albuquerque, NM 87120 and contains 0.3076 acre. See attached portion of Vicinity Map D-10-Z for exact location.

Purpose

The purpose of this drainage report is to present a grading and drainage solution for the new house.

Existing Drainage Conditions

This project falls within SAD 227 master drainage plan and drain to Rim Rock Cir.

Proposed Conditions and On-Site Drainage Management Plan

The drainage patterns will remain the same. The site will drain to ponds A & B and then to Rim Rock Cir. Ponds A & B are designed to hold a total volume of 537.21 cf. The required first flush volume is 248.58 cf

5324.71

5324.95

WM

RUNOFF CALCULATIONS

BASIN AREA (SF) AREA (AC) AREA (MI²) ON-SITE 13,400.47 0.30763 0.000481

E = EA(AA) + EB(AB) + EC(AC) + ED(AD)AA + AB + AC + AD

- EA = 0.55EB = 0.73EC = 0.95ED = 2.24
- P-60 = 1.69P-360 = 2.17P-1440 = 2.49P-10 Day = 3.90

LAND TREATMENT

PROPOSED	EXISTING
AA = 0.00%	AA = 0.00%
AB = 27.00%	AB = 100.00%
AC = 20.00%	AC = 0.00%
AD = 53.00%	AD = 0.00%

E = 1.57 IN (PROPOSED) E = 0.66 IN (EXISTING)

V-360 = 1,758.03 (PROPOSED) V-360 = 815.20 (EXISTING)

A = 1.54 CFS/ACB = 2.16 CFS/ACC = 2.87 CFS/ACD = 4.12 CFS/AC

TOTAL QP = QPA*AA+QPB*AB+QPC*AC+QPD*AD= 1.03 CFS (PROPOSED)TOTAL QP = 0.66 CFS (EXISTING)


FIRST FLIUSH PONDING REQUIREMENT


IMPERVIOUS AREA =7,102.55 SF FIRST FLUSH VOL. REQUIRED. = 0.42" x 7,102.55 / 12 = 248.58 CF

PONDING VOLUME CALCULATION

POND A: AREA @ ELEV. 25.40 = 302.04 SF AREA @ ELEV. 24.40 = 64.25 SF POND VOLUME = (302.04 + 64.25)/2*1.00 = 183.15 CF POND B: AREA @ ELEV. 25.40 = 530.61 SF AREA @ ELEV. 24.40 = 177.51 SF POND VOLUME=(530.61+177.51)/2*1.00=354.06 CF

TOTAL PONDING VOLUME PROVIDED = 183.15 + 354.06 = 537.21 CF

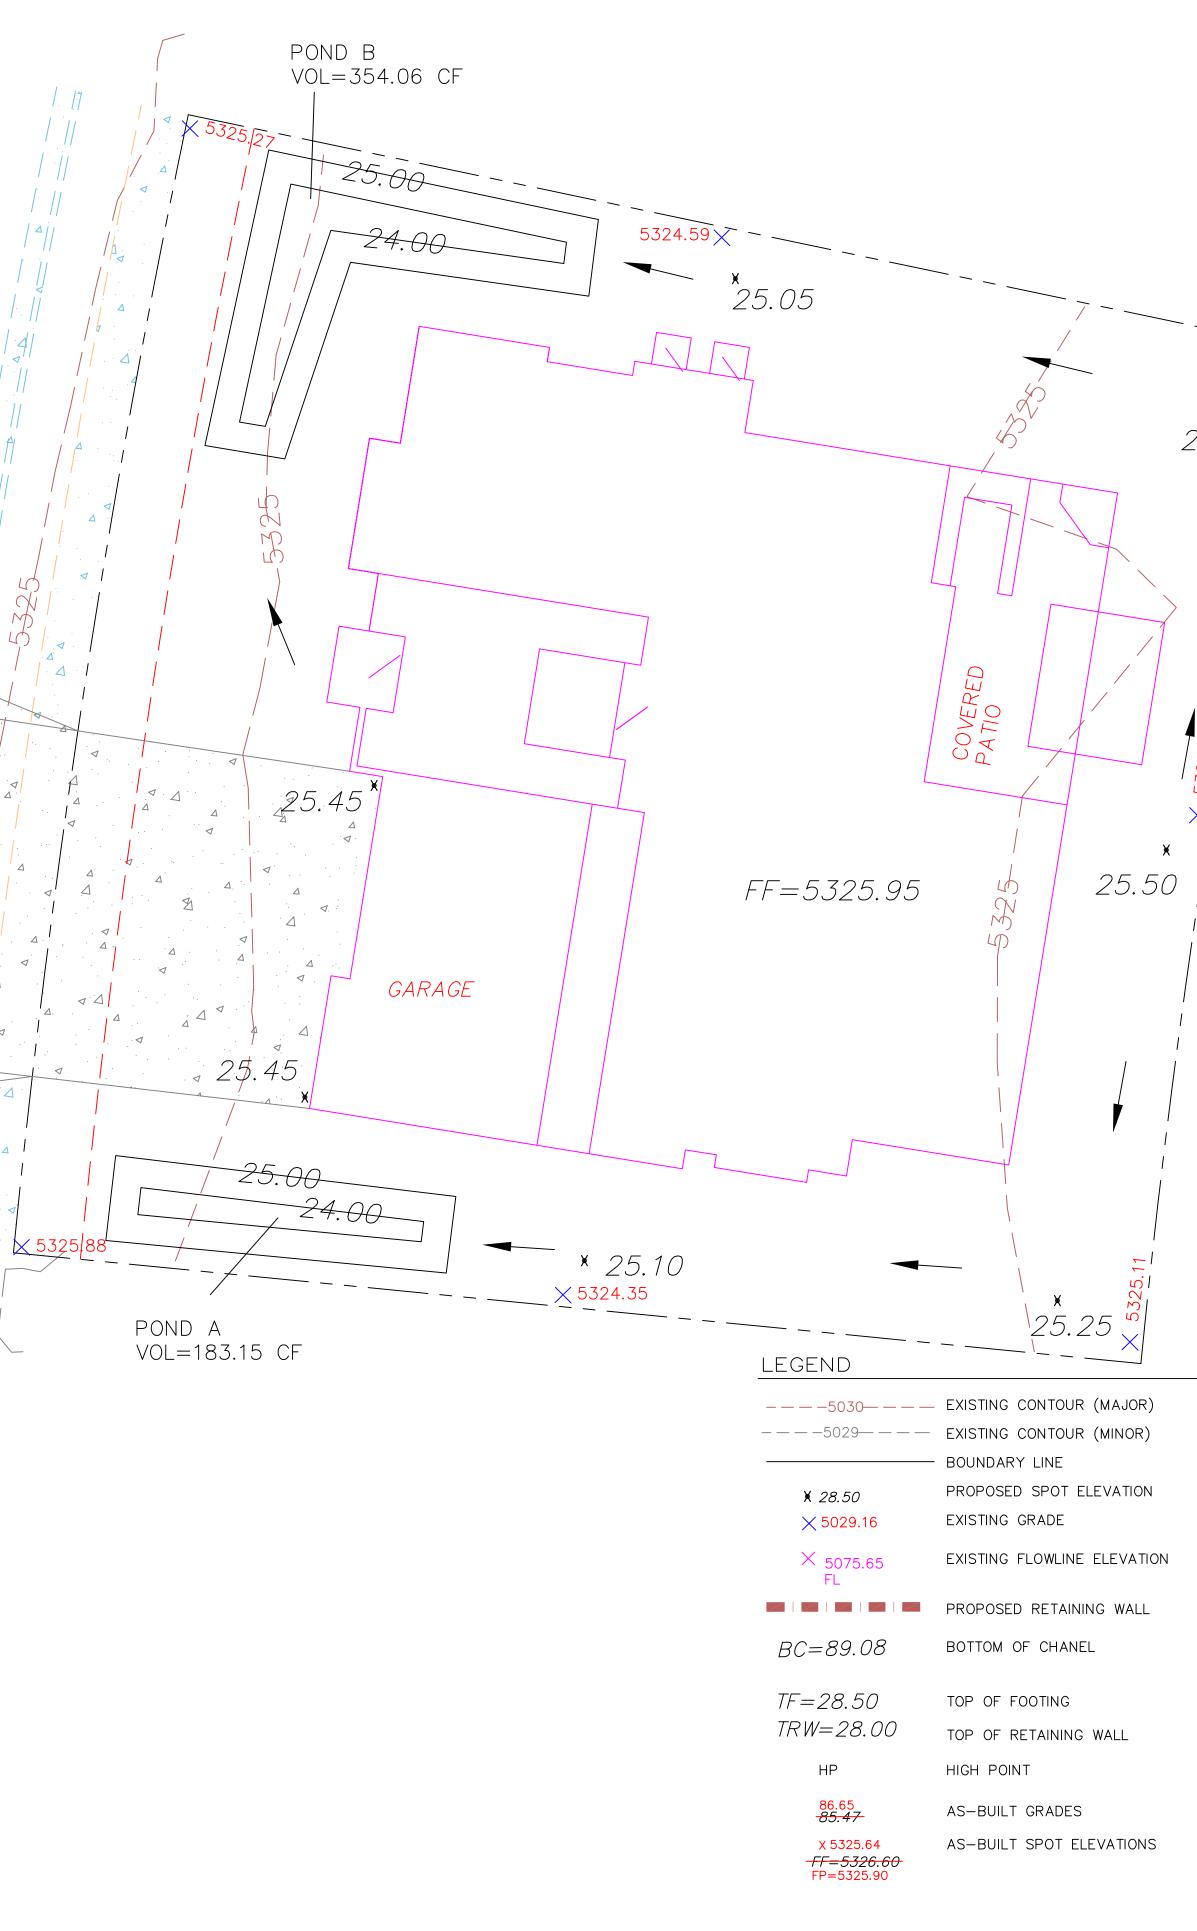

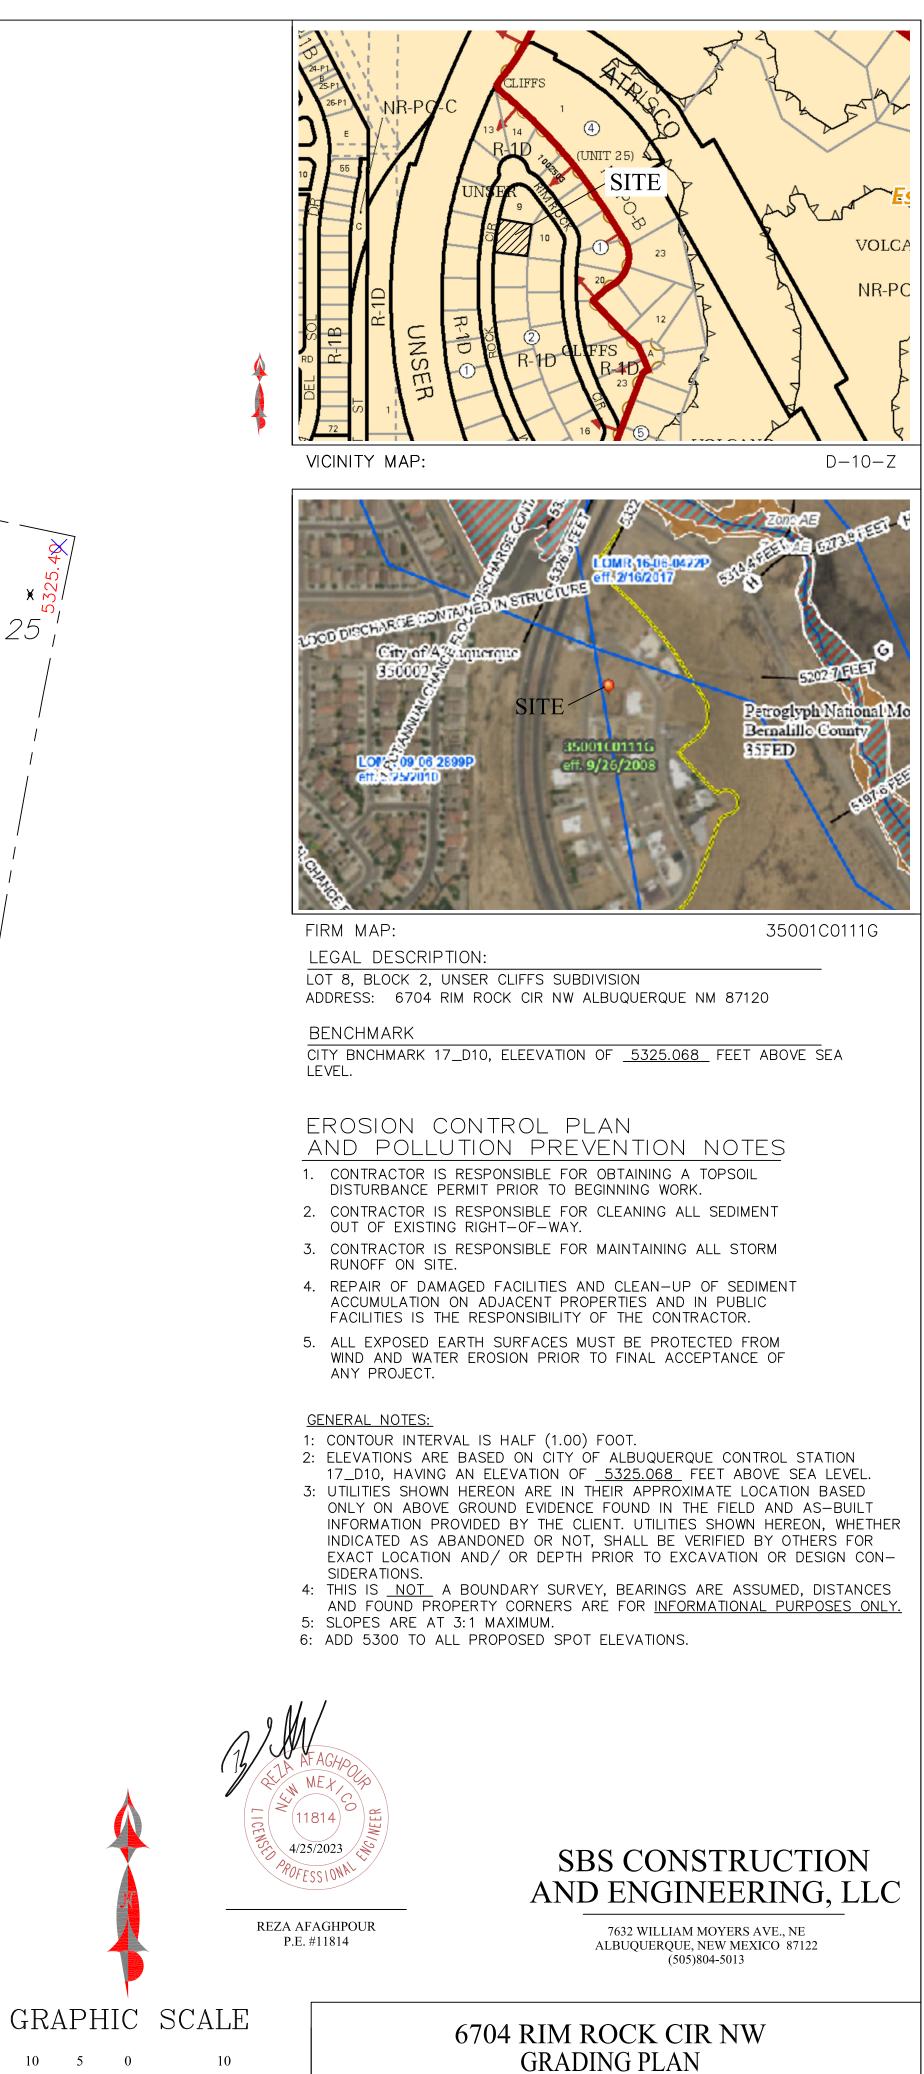

25.25

SCALE: 1"=10'

DRAWING: RIM ROCK GD.dwg DRAWN BY:

DATE: 4/25/2023 SHEET #

SH-B