# CITY OF ALBUQUERQUE

*Planning Department* Alan Varela, Director



Mayor Timothy M. Keller

April 26, 2023

Reza Afaghpour, PE SBS Construction and Engineering, LLC 10209 Snowflake Ct NW Albuquerque, NM 87114

#### RE: Lot 8 Block 2 Unser Cliffs SAD 227 6704 Rim Rock Circ. NW Grading and Drainage Plan Engineers Stamp Date 3/25/2023 (D10D025)

Mr. Afaghpour,

Based upon the information provided in your submittal received 4/7/2023, this plan is approved for grading plan.

Please inform the builder/owner to attach a copy of this approved plan and this letter to the construction sets in the permitting process prior to sign-off by Hydrology.

Reiterate to the Owner/Contractor that a separate permit for a garden/retaining wall must be obtained, with the approved G&D plan and Pad Certification. <u>Advise the owner &</u> <u>Contractor that dirt is not allowed in the public right of way to climb the curb. Crusher</u> <u>fines or lumber is allowed. If dirt is used this will delay going forward with the construction</u> <u>of the home.</u>

Prior to Certificate of Occupancy release, Engineer Certification per the DPM checklist of this plan will be required.

If you have any questions, please contact me at 924-3695 or Rudy Rael at 924-3977.

Sincerely,

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Tiequan Chen, P.E. Principal Engineer, Hydrology Planning Department, Development Review Services

RR/SB File D10D025

	Planning Department	Distriction
	velopment & Building Services	
MELLON DRAINAGE	E AND TRANSPORTATION IN	FORMATION SHEET (REV 6/2018)
Project Title: 6704 Rim Rock Circle, N	W Building Permit #:	Hydrology File #: D10D025
	-	Work Order#:
Legal Description:Lot 8, Block 2, Un		
City Address: 6704 Rim Rock Circle, NW		
Applicant:SBS CONSTRUCTION AN	ND ENGINEEING, LLC	Contact: SHAWN BIAZAR
Address:7632 William Moyers Avenue, I		
Phone#: (505) 804-5013	Fax#: (505) 897-4996	E-mail: AECLLC@AOL.COM
Other Contact:		Contact:
Address:		
		E-mail:
		CE DRB SITE ADMIN SITE
TYPE OF SUBMITTAL: ENGINEER/ARCHITECT CERTIFIC	CATIONCEF	RTIFICATE OF OCCUPANCY
		ELIMINARY PLAT APPROVAL E PLAN FOR SUB'D APPROVAL E PLAN FOR BLDG. PERMIT APPROVAL
CONCEPTUAL G & D PLAN X GRADING PLAN	SITI SITI SITI FIN FIN FOU FOU X GRA CICLO	E PLAN FOR SUB'D APPROVAL

# Location

This project is located at 6704 Rim Rock Cir. Albuquerque, NM 87120 and contains 0.3076 acre. See attached portion of Vicinity Map D-10-Z for exact location.

#### Purpose

The purpose of this drainage report is to present a grading and drainage solution for the new house.

# **Existing Drainage Conditions**

This project falls within SAD 227 master drainage plan and drain to Rim Rock Cir.

## **Proposed Conditions and On-Site Drainage Management Plan**

The drainage patterns will remain the same. The site will drain to ponds A & B and then to Rim Rock Cir. Ponds A & B are designed to hold a total volume of 537.21 cf. The required first flush volume is 248.58 cf

5324.71

5324.95

WM

## **RUNOFF CALCULATIONS**

BASIN AREA (SF) AREA (AC) AREA (MI<sup>2</sup>) ON-SITE 13,400.47 0.30763 0.000481

E = EA(AA) + EB(AB) + EC(AC) + ED(AD)AA + AB + AC + AD

- EA = 0.55EB = 0.73EC = 0.95ED = 2.24
- P-60 = 1.69P-360 = 2.17P-1440 = 2.49P-10 Day = 3.90

LAND TREATMENT

PROPOSED	EXISTING
AA = 0.00%	AA = 0.00%
AB = 27.00%	AB = 100.00%
AC = 20.00%	AC = 0.00%
AD = 53.00%	AD = 0.00%

E = 1.57 IN (PROPOSED) E = 0.66 IN (EXISTING)

V-360 = 1,758.03 (PROPOSED) V-360 = 815.20 (EXISTING)

A = 1.54 CFS/ACB = 2.16 CFS/ACC = 2.87 CFS/ACD = 4.12 CFS/AC

TOTAL QP = QPA\*AA+QPB\*AB+QPC\*AC+QPD\*AD= 1.03 CFS (PROPOSED)TOTAL QP = 0.66 CFS (EXISTING)


FIRST FLIUSH PONDING REQUIREMENT


IMPERVIOUS AREA =7,102.55 SF FIRST FLUSH VOL. REQUIRED. = 0.42" x 7,102.55 / 12 = 248.58 CF

PONDING VOLUME CALCULATION

POND A: AREA @ ELEV. 25.40 = 302.04 SF AREA @ ELEV. 24.40 = 64.25 SF POND VOLUME = (302.04 + 64.25)/2\*1.00 = 183.15 CF POND B: AREA @ ELEV. 25.40 = 530.61 SF AREA @ ELEV. 24.40 = 177.51 SF POND VOLUME=(530.61+177.51)/2\*1.00=354.06 CF

TOTAL PONDING VOLUME PROVIDED = 183.15 + 354.06 = 537.21 CF

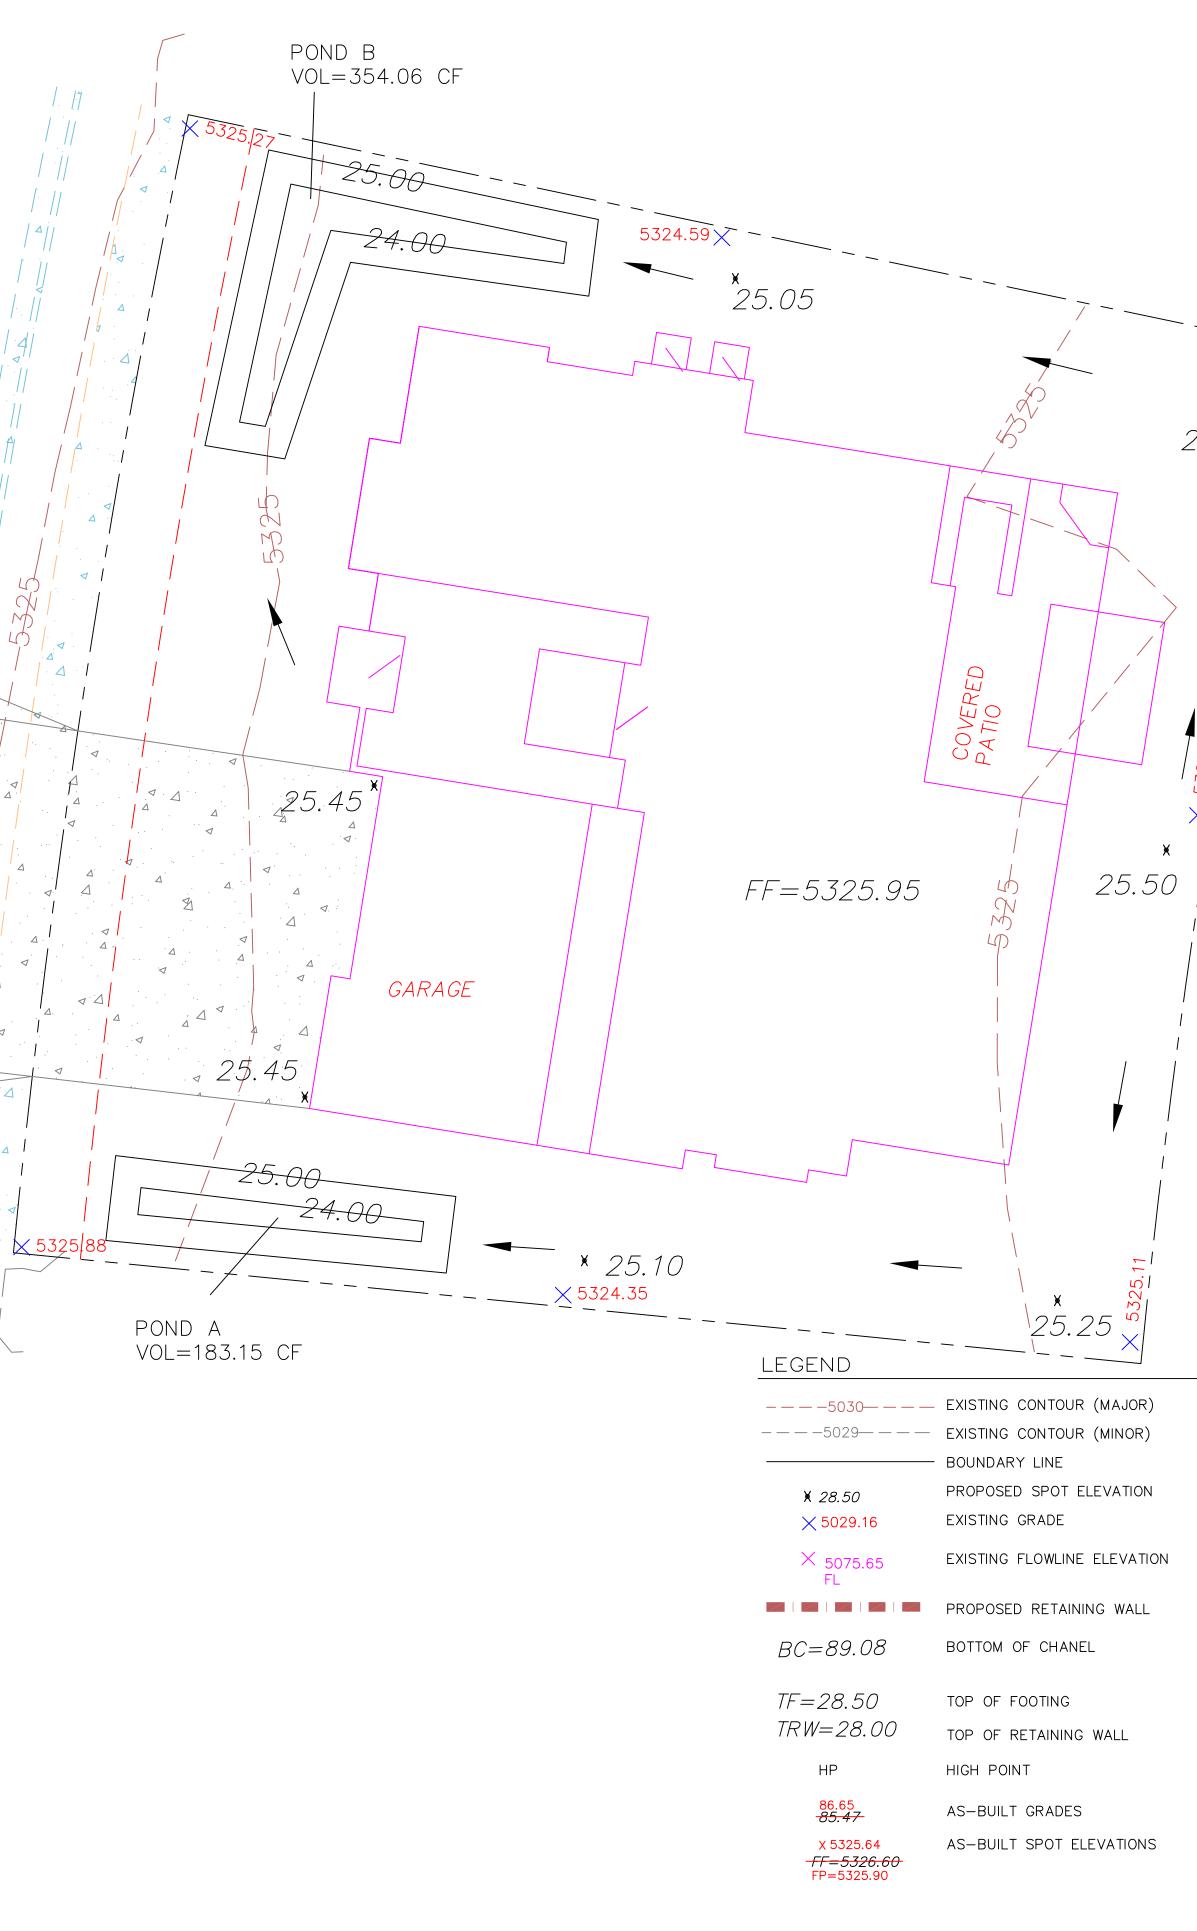

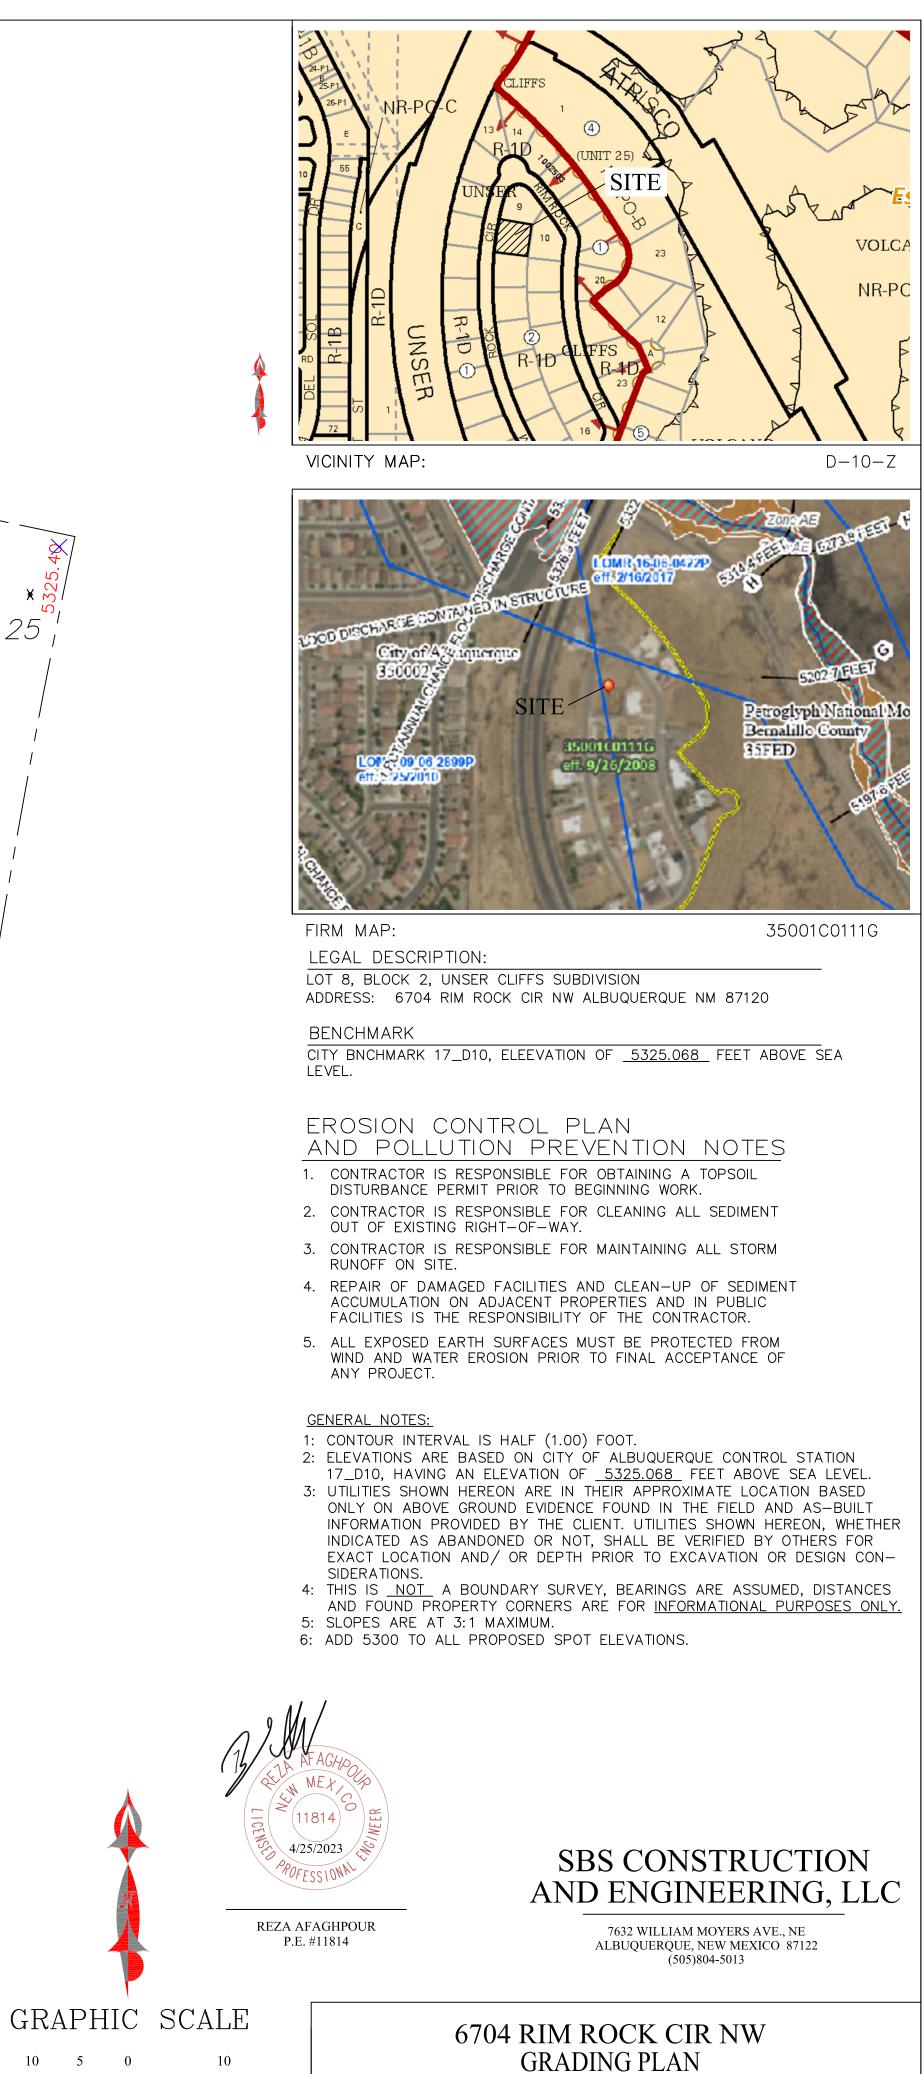

25.25

SCALE: 1"=10'

DRAWING: RIM ROCK GD.dwg DRAWN BY:

DATE: 4/25/2023 SHEET #

# SH-B