# CITY OF ALBUQUERQUE



Richard J. Berry, Mayor

April 13, 2017

Martin Garcia, PE 1035 S. Bosque Loop Bosque Farms, NM, 87123

RE: Pontilux - 1301 Cuesta Abajo Ct NE

Grading and Drainage Plan

Stamp Date: 4/3/17

Hydrology File: D13D002H

Dear Mr. Garcia:

Based upon the information provided in your submittal received 4/7/2017, the Grading and Drainage Plan **is not** approved for Grading Permit. The following comments need to be addressed for approval of the above referenced project:

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PO Box 1293

New Mexico 87103

www.cabq.gov

- 1. This site is part of a Master Drainage Plan by Mark Goodwin and Associates engineer's stamp date of 1/18/05. Please address this in the drainage narrative for the existing conditions.
- 2. As part of this Master Drainage Plan, there is a maximum allowable Q that is allowed for this tract. Please note that the proposed Q is below this. Please add this maximum allowable Q in the drainage narrative.
- 3. Under your drainage calculations, the existing conditions needs show the existing asphalt in the shared access easement. Also, the proposed conditions needs to address this existing asphalt as well.
- 4. Please add the following information to the Grading Plan:
  - a. Shared access agreement along the east property line.
  - b. Existing pavement and grades on this pavement.
  - c. Existing 100 ft easement along the north property line.
  - d. Existing inlets on Cuesta Abajo Ct. There are four of them adjacent to the property. Please include the TC and FL elevations.

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Richard J. Berry, Mayor

- e. Existing TC and FL of the existing driveway curbing.
- f. Please label/hatch the existing curb along Los Lomitas Rd. It disappears in all of the line work.
- g. Please label/hatch the proposed curb along Cuesta Abajo. It disappears in all of the line work.
- h. Please show the existing ramps at the corner of Los Lomitas & Cuesta Abajo and the existing driveway.
- i. Please label/hatch the existing berm along Los Lomitas.
- j. Please label or put in the legend the water block/high point.
- 5. Please add a water block/high point symbol at the NW corner of the propose pavement.

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6. The propose pavement is cutting into the existing berm. This berm was placed per the Master Drainage Plan along Los Lomitas to divert the site drainage towards the inlets on Cuesta Abajo. Please show how you are going to continue this drainage pattern. Such as re-contouring the berm behind the proposed curb so no drainage will spill onto Los Lomitas.

New Mexico 87103

If you have any questions, please contact me at 924-3995 or rbrissette@cabq.gov.


www.cabq.gov

Sincerely,

Reneé C. Brissette, P.E. Senior Engineer, Hydrology Planning Department

Renee C. Brissett

Albuquerque - Making History 1706-2006

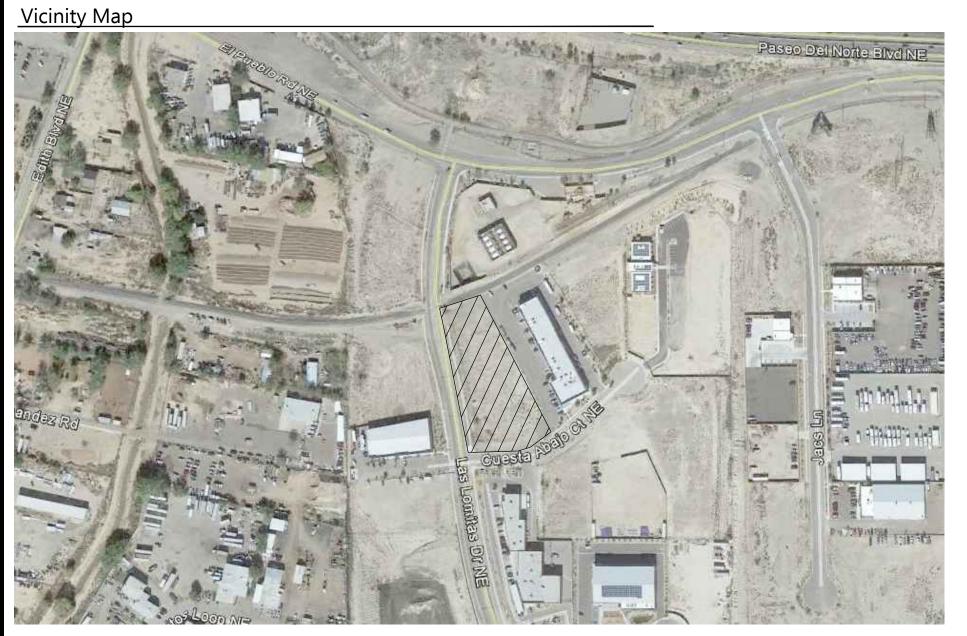

#### **Drainage Narrative**

THE PURPOSE OF THIS GRADING AND DRAINAGE PLAN LOCATED AT 1301 CUESTA ABAJO COURT N.E., ALBUQUERQUE, NM IS TO ACCOMMODATE A NEW WAREHOUSE AT THE SOUTH END OF THE LOT. THE LOT IS CURRENTLY UNIMPROVED AND IS BOUND TO THE NORTH BY AN EXISTING RAILROAD SPUR, TO THE EAST BY AN IMPROVED COMMERCIAL LOT, TO THE SOUTH BY CUESTA ABAJO COURT AND THE WEST BY LOS LOMITAS DRIVE.

THE SITE CURRENTLY FLOWS FROM THE NORTH TO SOUTH WITH A LOW POINT AT THE SOUTHWEST CORNER OF THE LOT WHERE THE MAJORITY OF THE RUN-OFF WILL BE DIRECTED THROUGH A CLEAR WATER POND LOCATED AT THE SOUTHWEST CORNER OF THE LOT, THEN DRAIN ONTO CUESTA ABAJO COURT AND INTO THE EXISTING STORM DRAIN. A SMALL PORTION OF THE DRAINAGE WILL FLOW DIRECTLY TO CUESTA ABAJO COURT AND INTO THE EXISTING STORM DRAIN.

### **Drainage Calculations**

Hydrology Calculations					
Date: November 11, 2003					
DPM - Section 22.2					
Volume 2, January 1993					
Precipitation Zone	2				
100 Year Storm Depth, P (360)	2.35				
100 year Storm Depth, P (10 day)	3.95				
T					
Treatment Area	Α	В	С	D	
Excess Precipitation Factors	0.53	0.78	1.13	2.12	
Peak Discharge Factors	1.56	2.28	3.14	4.70	
Land Treatment Area	Acres	Existing	Allowable	Proposed	
Type "D" (Roof)		0.00	0.31	0.85	
Type "C" (Unpaved Roadway)		0.00	0.36	0.00	
Type "B" (Irrigated Lawns)		0.00	0.36	0.00	
Type "A" (Undeveloped)		0.96	0.77	0.11	
Total (Acres)		1.80	1.80	0.96	
Excess Precipitaion(in)		0.28	0.99	1.94	
Volume (100), cf		1846.94	6438.60	6752.89	
Volume (10),cf		1237.45	4313.86	4524.44	
Volume (100,10 day), cf		1846.94	6438.60	11689.69	
Q (100), cfs		1.50	4.59	4.17	
Q (10), cfs		1.00	3.07	2.79	
Flush Pond D*(0.34/12)	37,026 sf	Х	0.34in/1ft/12in	=	1049 cf

### Pond Volume

AREA TREATMENT "D" = 37026 SF

IMPERVIOUS AREA ——— 0.10 x 37026 = 3702.6 SF PONDING REQUIRED —  $3702.6 \times \frac{.34}{12} = 104.90 \text{ CF}$ 

POND 1: A36.50 = 584.11 SF A36.00 = 234.31 SF

VOL 3 & 4:  $584.11 + 234.31 = \frac{818.42}{2} \times 0.5 = 204.60 \text{ CF}$ 

POND VOLUME PROVIDED: 204.60 CF

DEPTH OF WATER  $\frac{104.90}{204.60} = 0.52 \times 0.5 = 0.26$ 

WATER SURFACE ELEV = 5036.00 + .26 = 5036.26

### Project Benchmark

PROJECT BENCHMARK THE PROJECT BENCHMARK FOR THIS SITE IS AN ACS BRASS MONUMENT STAMPED "13-D16"


N=1518996.001 E=1534181.325 ELEV=5073.471

THE LOCAL BENCHMARK THE LOCAL BENCHMARK IS THE STORM DRAIN MANHOLE ON CUESTA ABAJO ROAD LOCATED AT THE DRIVEPAD

ELEV=5036.53

### Legend

<del>-4805 -</del>	EXISTING CONTOUR
<del></del> 05 <del></del>	NEW CONTOUR
FF	FINISH FLOOR
TC	TOP OF CURB
FL	FLOW LINE
TS	TOP OF SIDEWALK

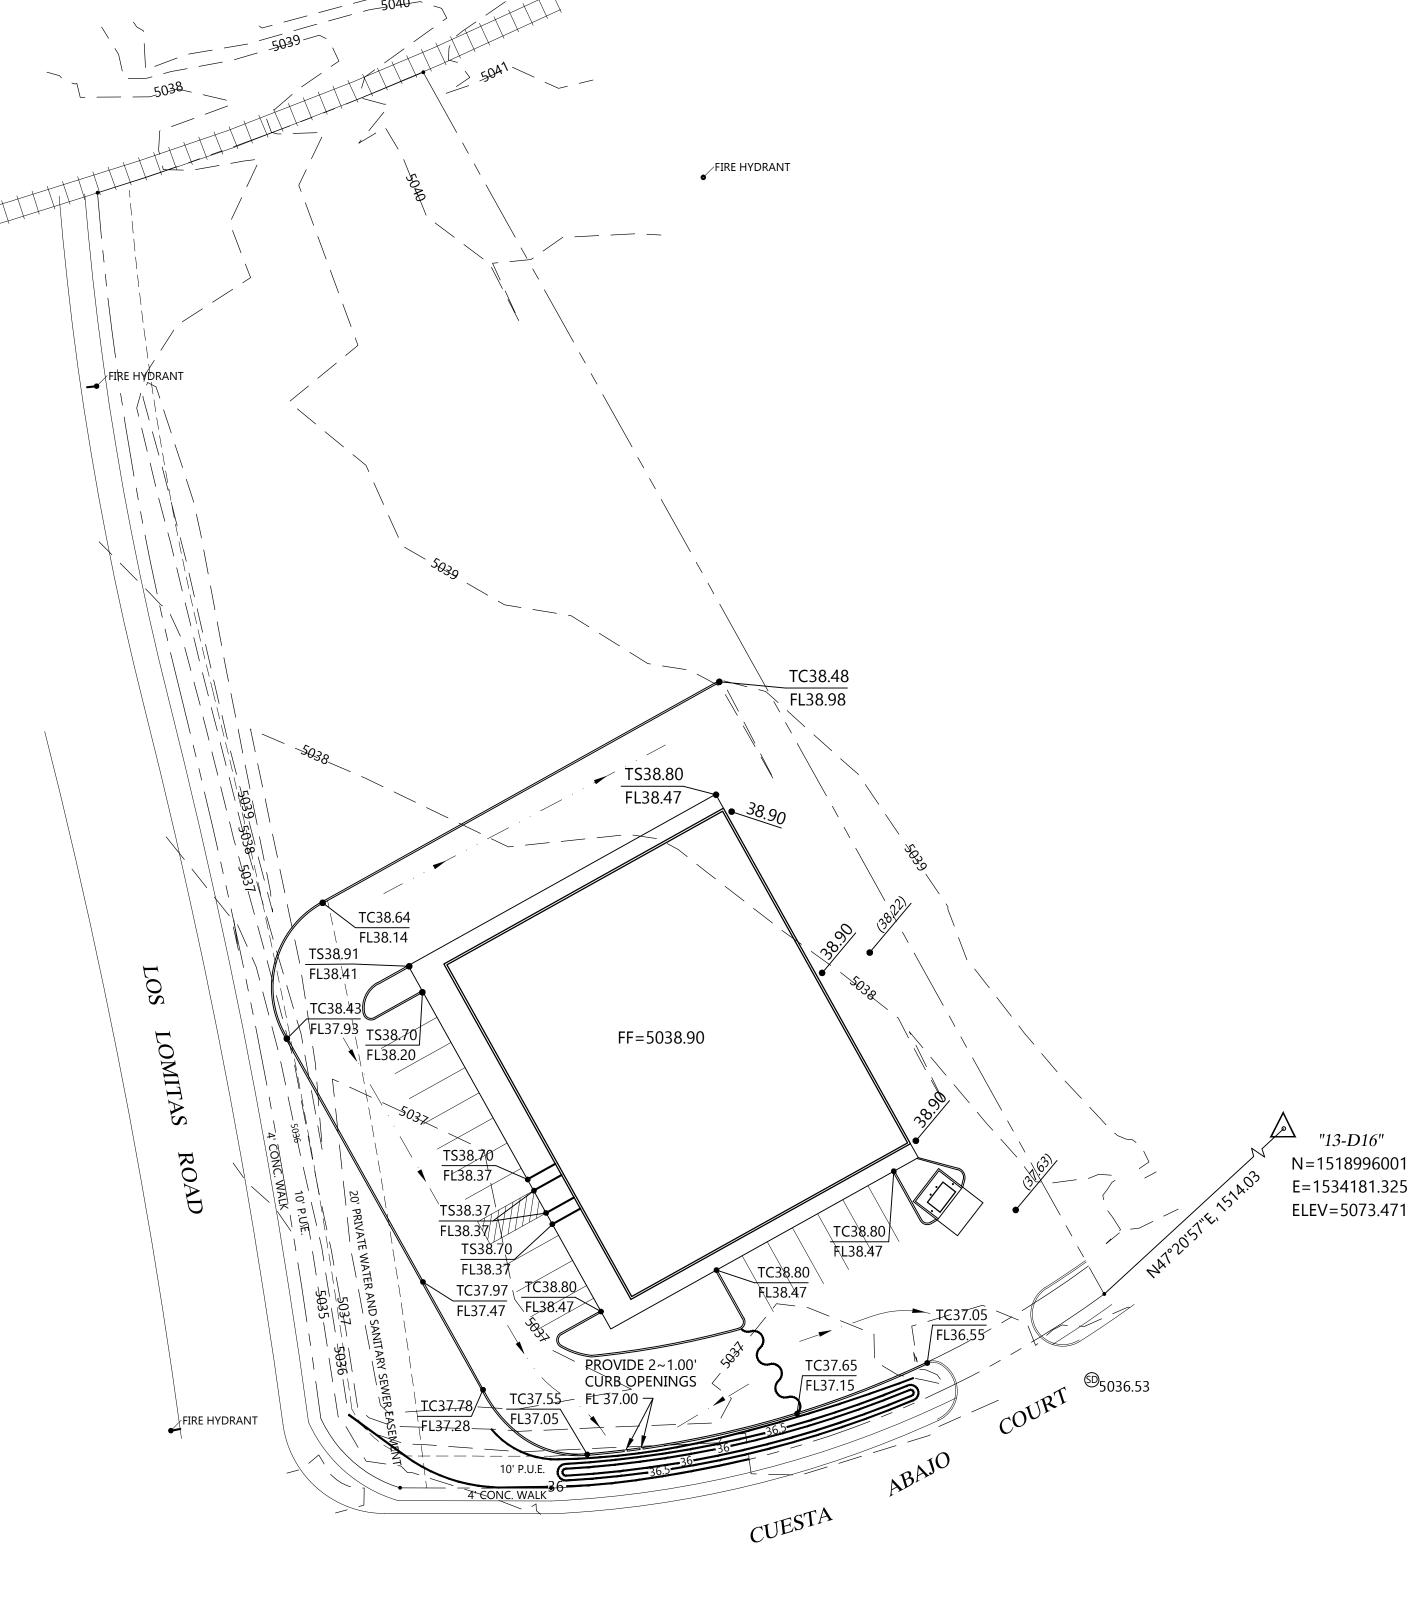

# GRADING AND DRAINAGE PLAN

SCALE: 1" = 30'







	PROJECT NO.	16-054	R	NO.	DATE	COMMENTS	
C	DATE:	4.03.2017	ŋ> □				
0	DRAWN BY:	2011110	<u> </u>				
			2+				
7	CHECKED BY:	M GARCIA	-0;				
	SCALE:	1" = 30'	ZV				1035 S. Bosque L
			_	_			505 362 1530