


RECIPROCAL ACCESS, PARKING & PRAINAGE FASEMENTS RECORDED BK-AGI PG. 358 ON JULY 25, 2003.

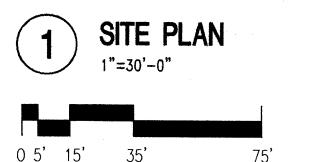

PROJECT INFORMATION

PROJECT:

INDUSTRIAL PARK © JOURNAL CENTER 2 NEW OFFICE/WAREHOUSE DEVELOPMENT

LOCATION: OWNER:

3730, 3800, 3810 & 3900 RUTLEDGE ROAD NE

BRUNACINI DEVELOPMENT

ARCHITECT: LEGAL DESCRIPTION:

TATE FISHBURN ARCHITECT LOTS 16, 17, 18 & 19 JOURNAL CENTER 2

CURRENT ZONING CLASSIFICATION: TYPE CONSTRUCTION: TYPE IIN SPRINKERED OCCUPANCY: B & S1 **ALLOWABLE AREA:** 36,000 SQ. FT.

TYPE IIN CONSTRUCTION & B OCCUPANCY = 12,000 TRIPLE FOR SPRINKLER= 36,000

GROSS BUILDING AREA:

3730-12,800 S.F. 3800 & 3810-27,800 S.F. 3900-15,534 S.F.

OCCUPANT LOAD:

56.134/500 = 113 OCCUPANTS4 ACRES +/-

(4) 1 ACRE LOTS

56,134 S.F.

PARKING ANALYSIS:

TOTAL LOT AREA:


WAREHOUSE AREA = 44,904 OFFICE AREA = 11,230 REQUIRED WAREHOUSE = 44,904/2000 = 23REQUIRED OFFICE = 11,230/200= TOTAL REQUIRED PARKING SPACES= 79 SPACES


> BIKE PARKING REQUIRED= 4 BIKE PARKING PROVIDED= 8


SPACES PROVIDED= 143 SPACES


INCLUDING 8 HANDICAP


SITE LIGHTING NOTE: SITE LIGHTING SHALL BE BUILDING MOUNTED WALL PACKS WITH CUT OFF ANGLE THAT WILL NOT ALLOW ANY LIGHT TO SPILL ONTO ADJACENT PROPERTIES.

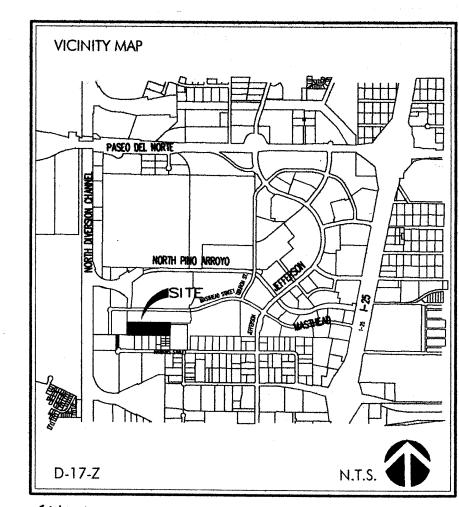

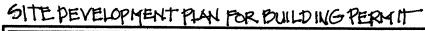

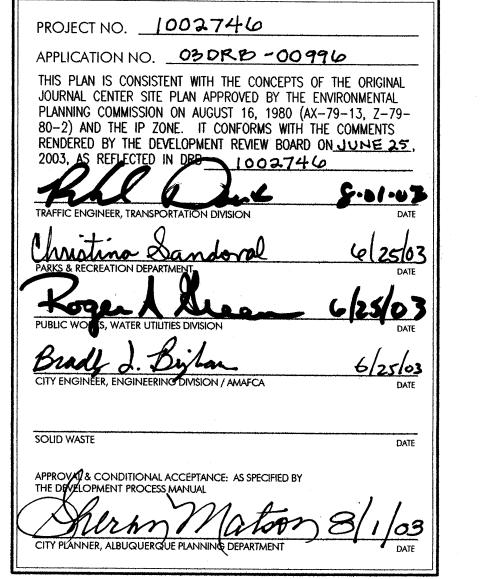

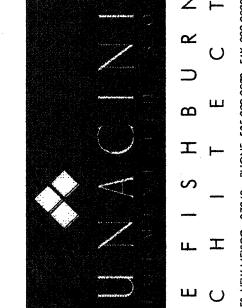

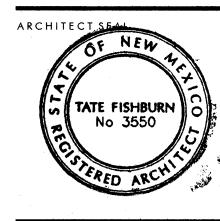

ENGINEER SEAL

PROJECT

7

REVISIONS


HYDROLOGY SECTION JUNE 17, 2003

1'-0"=30'-0"

DRAWING NAME SITE DEVELOPMENT PLAN


SHEET NUMBER

SDP-1

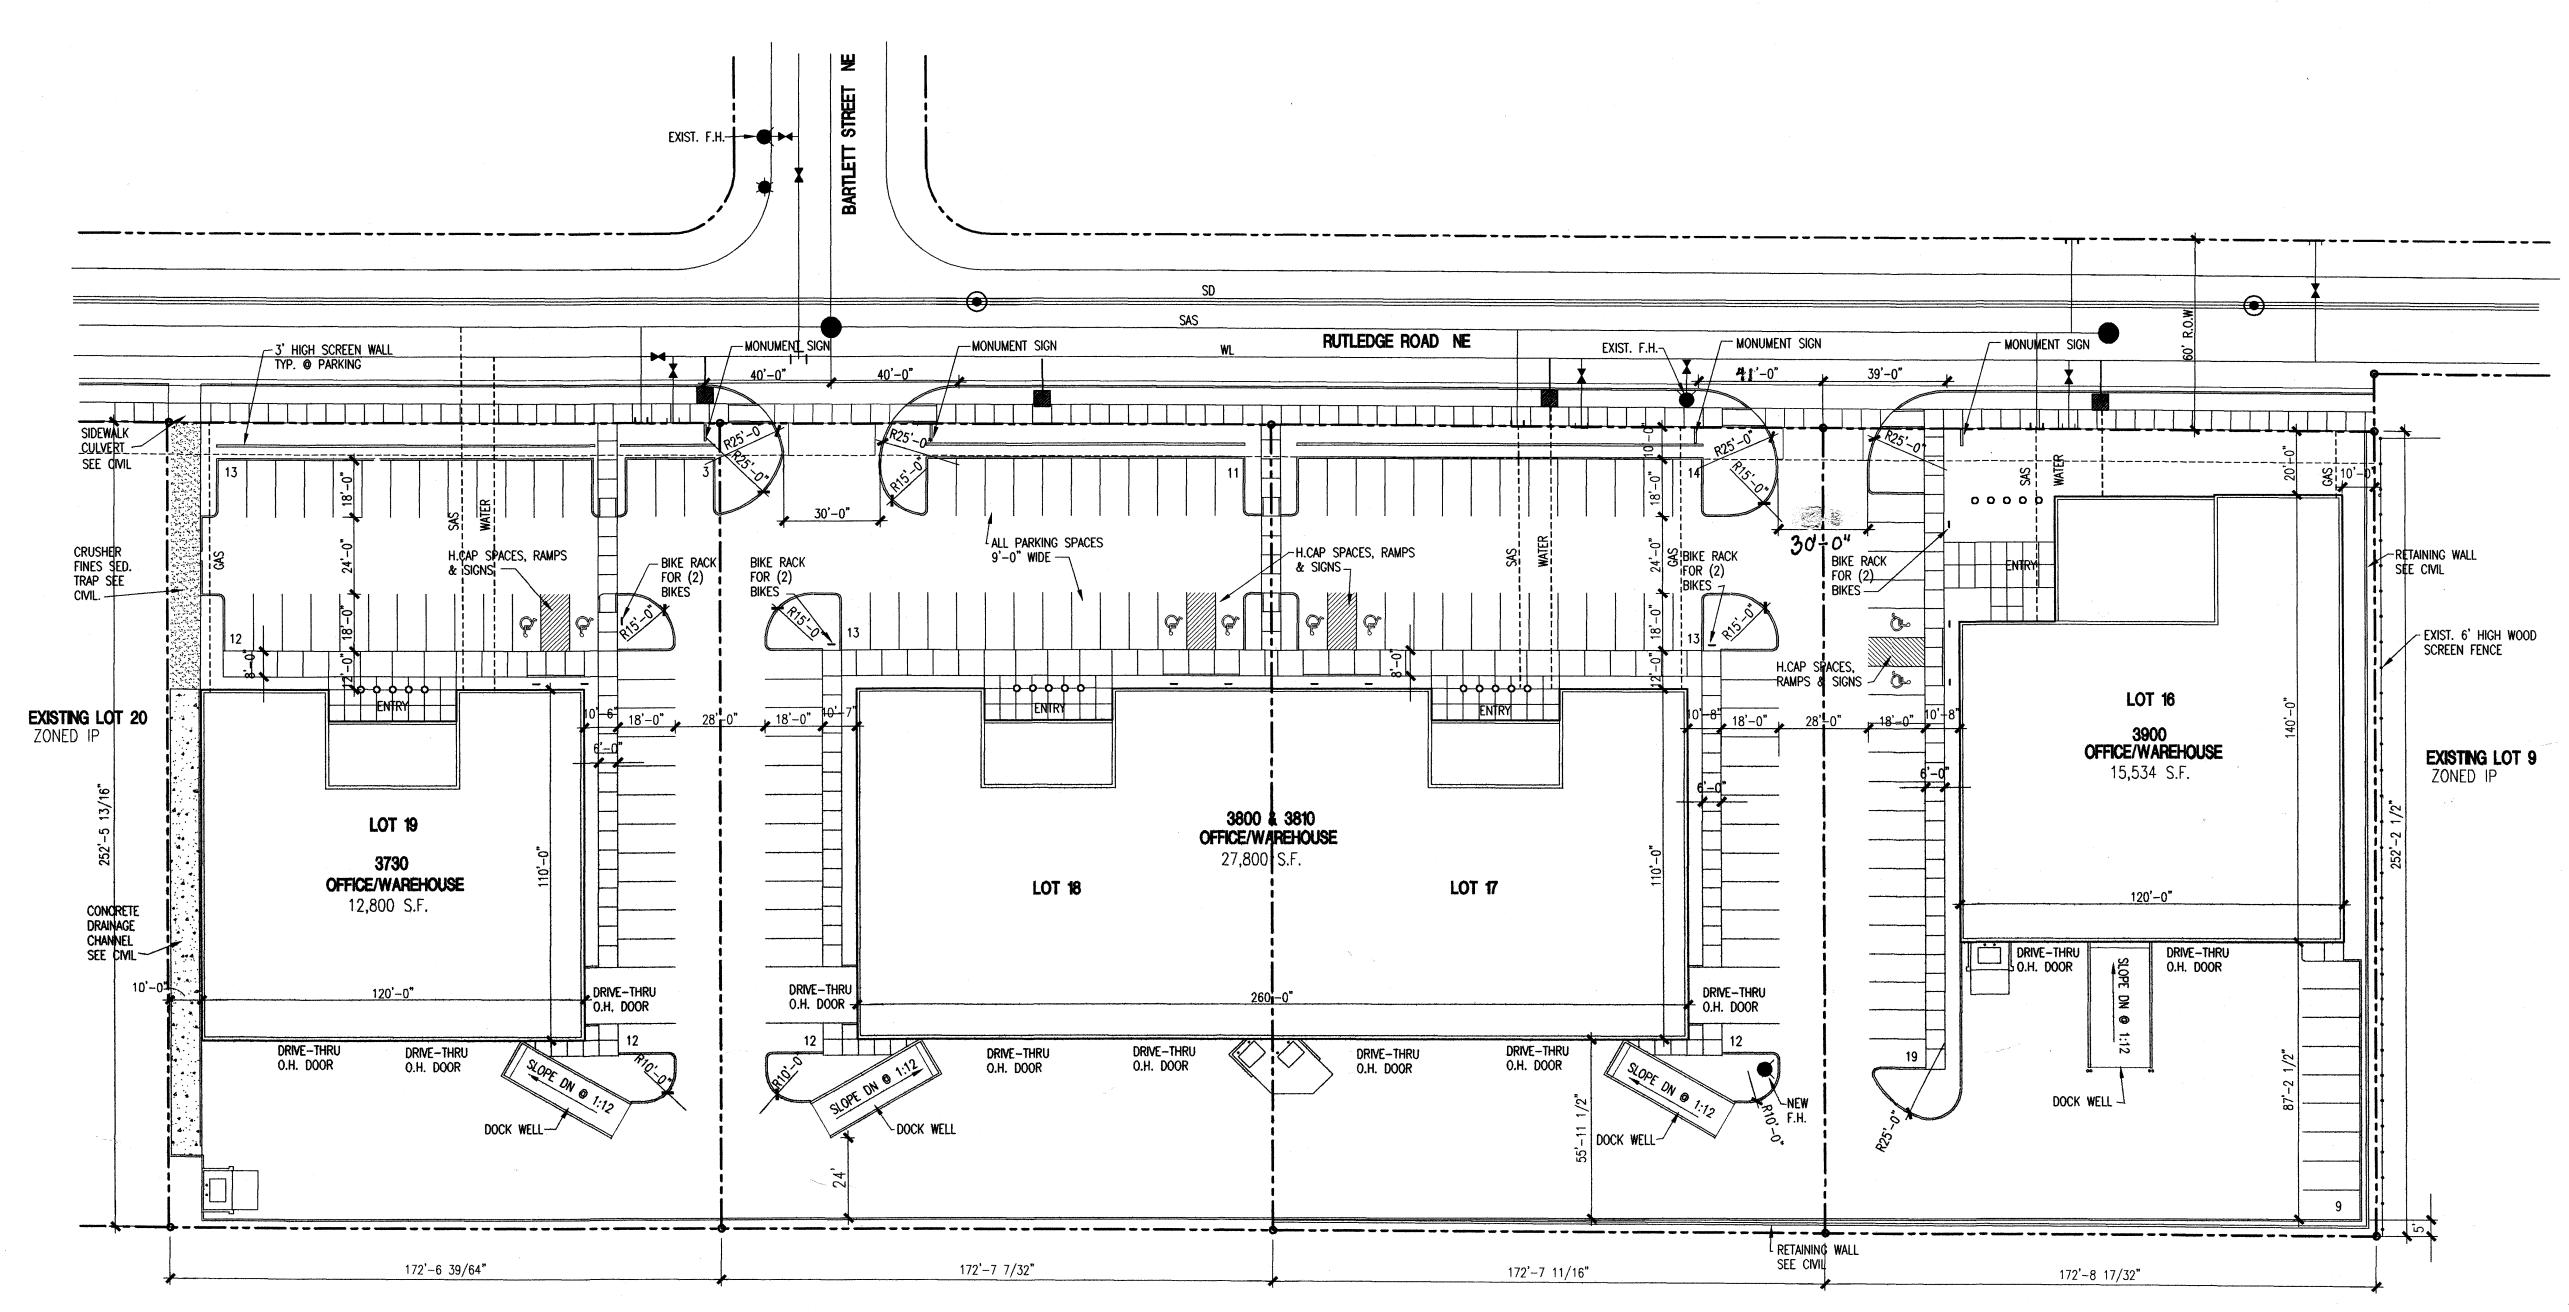

RECIPROCAL ACCESS, PARKING & DRAINAGE FASEMENTS RECORDED BK-AG! PG. 358 ON JULY 25, 2003.



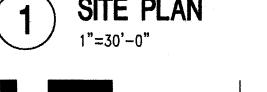



PROJECT:

INDUSTRIAL PARK @ JOURNAL CENTER 2 NEW OFFICE/WAREHOUSE DEVELOPMENT

LOCATION: OWNER:

3730, 3800, 3810 & 3900 RUTLEDGE ROAD NE BRUNACINI DEVELOPMENT TATE FISHBURN ARCHITECT

TRIPLE FOR SPRINKLER= 36,000

56,134 S.F.

27,800 S.F.

12,800 S.F.

15,534 S.F.

ARCHITECT: LEGAL DESCRIPTION:

LOTS 16, 17, 18 & 19 JOURNAL CENTER 2

CURRENT ZONING CLASSIFICATION: TYPE CONSTRUCTION:

TYPE IIN SPRINKERED OCCUPANCY: ALLOWABLE AREA: 36,000 SQ. FT. TYPE IIN CONSTRUCTION & B OCCUPANCY = 12,000

GROSS BUILDING AREA: 3730-3800 & 3810-

OCCUPANT LOAD: 56,134/500 = 113 OCCUPANTS

TOTAL LOT AREA: 4 ACRES +/-(4) 1 ACRE LOTS


PARKING ANALYSIS: WAREHOUSE AREA = 44,904 OFFICE AREA = 11,230 REQUIRED WAREHOUSE = 44,904/2000 = 23REQUIRED OFFICE = 11,230/200=TOTAL REQUIRED PARKING SPACES = 79 SPACES


> BIKE PARKING REQUIRED= 4 BIKE PARKING PROVIDED= 8

SPACES PROVIDED= 143 SPACES


INCLUDING 8 HANDICAP

SITE LIGHTING NOTE: SITE LIGHTING SHALL BE BUILDING MOUNTED WALL PACKS WITH CUT OFF ANGLE THAT WILL NOT ALLOW ANY LIGHT TO SPILL ONTO ADJACENT PROPERTIES.

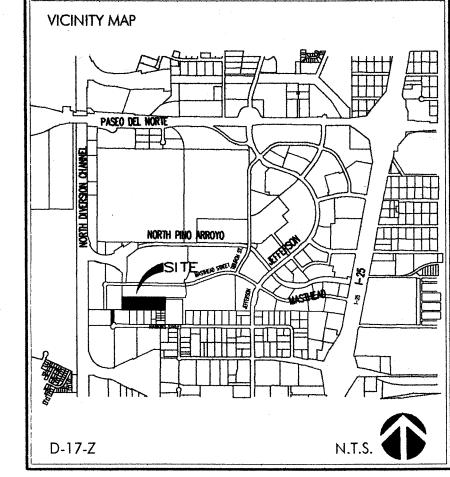

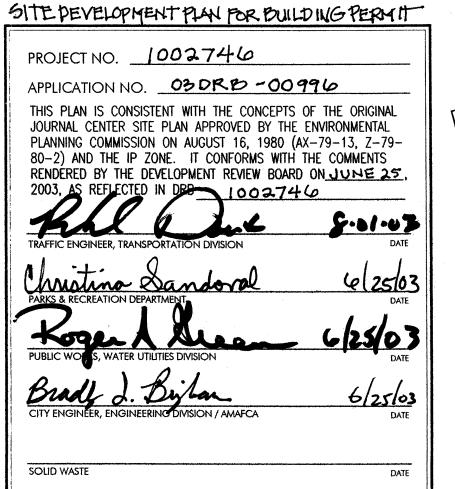

APPROVAL& CONDITIONAL ACCEPTANCE: AS SPECIFIED BY THE DEVELOPMENT PROCESS MANUAL

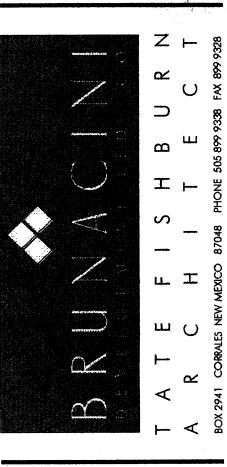

ARCHITECT TATE FISHBURN No 3550

ENGINEER SEAL

PROJECT

JUNE 17, 2003

1'-0"=30'-0"

DRAWING NAME SITE DEVELOPMENT PLAN

SHEET NUMBER

TEMPORARY DRAINAGE CERTITICATION


3)20)200


LEGAL DESCRIPTION
LOTS 16-19, JOURNAL CENTER 2


I, Larry D. Read, NMPE 10998, of the firm Larry Read & Associates, Inc., hereby certify that this project has been graded and will drain in substantial compliance with and in accordance with the design intent of the approved plan Engineer's Stamp dated 10/03/03. The record information edited onto the original design document has been obtained by Jake Arguelles, Jr., NMPS 7472. I further certify that I have personally visited the project site on 1/20/2004 and have determined by visual inspection that the survey data provided is representative of actual site conditions and is true and correct to the best of my knowledge and belief. This certification is submitted in support of a request for a Temporary Certificate of Occupancy.


Exceptions: The channel and associated sidewalk culverts west of Phase III has not been completed at this time. The construction of the drainage related items will not be complete for at least 3—weeks.

The record information presented hereon is not necessarily complete and intended only to verify substantial compliance of the Grading and Drainage aspects of this project. Those relying on this record document are advised to obtain independent verification of its accuracy before using it for any other purpose.

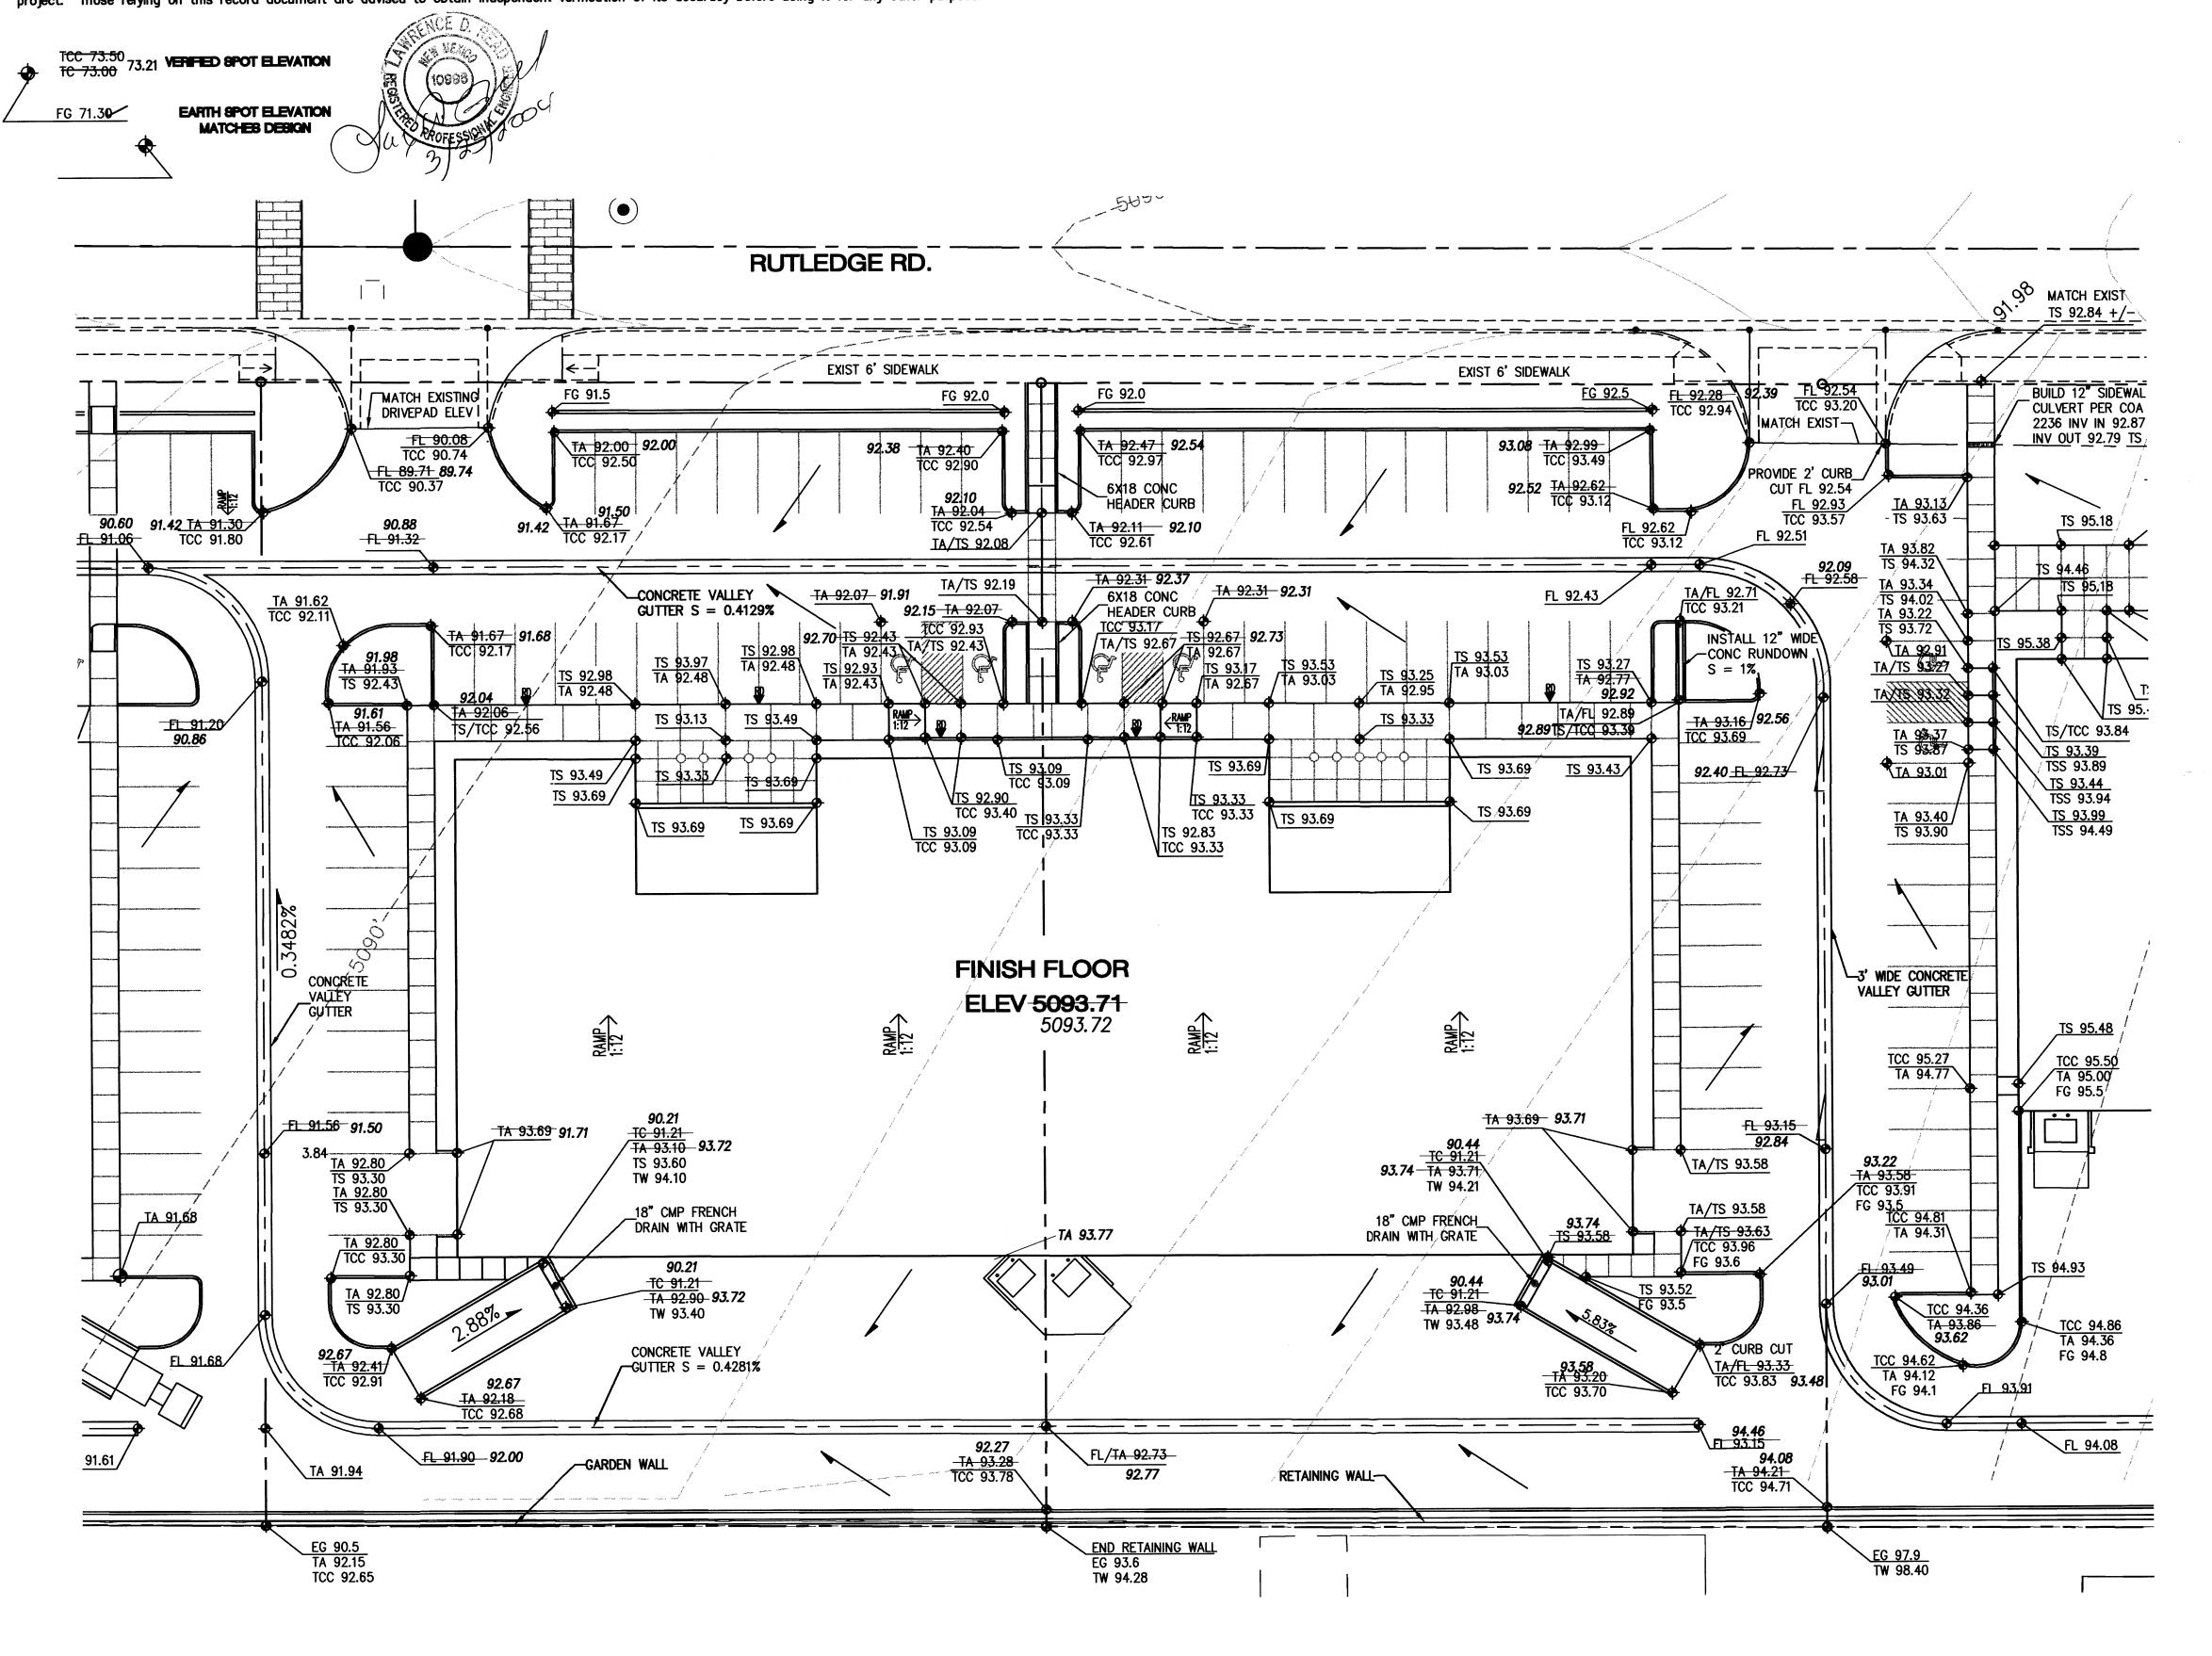


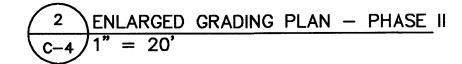

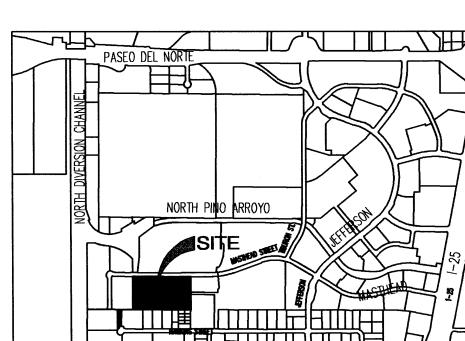

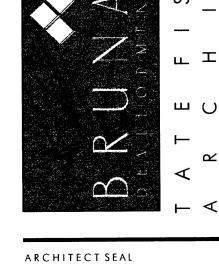

VICINITY MAP D-7-Z

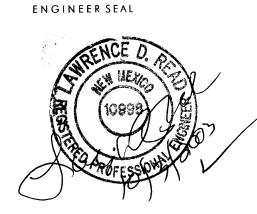

PROJECT

SITE DEVELOPMENT PLAN FOR INDUSTRIAL PARK @ JOURNAL CENTER 2 LOTS 16-19, JOURNAL CENTER 2 ALBUQUERQUE, NEW MEXICO

REVISIONS

June 16, 2003

NORTH SCALE

DRAWING NAME

PHASE II GRADING PLAN

SHEET NUMBER

C-4

LARRY READ & ASSOCIATES

Civil Engineers

4800 Juan Tabo Blvd. NE Suite C
Albuquerque, New Mexico 87111
(505) 237-8421

NOTICE TO CONTRACTOR

- 1. AN EXCAVATION/CONSTRUCTION PERMIT WILL BE REQUIRED BEFORE BEGINNING ANY WORK WITHIN THE CITY RIGHT-OF-WAY. AN APPROVED COPY OF THESE PLANS MUST BE SUBMITTED AT THE TIME OF APPLICATION FOR THIS PERMIT.
- 2. ALL WORK DETAILED ON THESE PLANS TO BE PERFORMED WITHIN THE CITY RIGHT-OF-WAY SHALL, EXCEPT AS OTHERWISE STATED OR PROVIDED FOR HEREON, BE CONSTRUCTED IN ACCORDANCE WITH C.O.A. STANDARD SPECIFICATIONS FOR PUBLIC WORKS CONSTRUCTION 1986.
- 3. TWO (2) WORKING DAYS PRIOR TO ANY EXCAVATION, THE CONTRACTOR MUST CONTACT LINE LOCATING SERVICE 260-1990, FOR LOCATION OF EXISTING UTILITIES.
- 4. PRIOR TO CONSTRUCTION, THE CONTRACTOR SHALL EXCAVATE AND VERIFY THE HORIZONTAL AND VERTICAL LOCATIONS OF ALL OBSTRUCTIONS. SHOULD A CONFLICT EXIST, THE CONTRACTOR SHALL NOTIFY THE ENGINEER OR SURVEYOR SO THAT THE CONFLICT CAN BE RESOLVED WITH MINIMUM AMOUNT OF DELAY.
- 5. BACKFILL COMP ACTION SHALL BE ACCORDING TO ARTERIAL STREET USE.
- 6. MAINTENANCE OF THESE FACILITIES SHALL BE THE RESPONSIBILITY OF THE

THE FOLLOWING NOTES ALSO APPLY WHEN CHECKED Ø ALL UTILITIES AND UTILITY SERVICE LINES SHALL BE INSTALLED PRIOR TO

- CONSTRUCTION OF ANY SIDEWALK OR PAVEMENT.
- Ø BACKFILL COMP ACTION SHALL BE ACCORDING TO ARTERIAL STREET USE. TACK COAT REQUIREMENTS SHALL BE DETERMINED BY THE CITY ENGINEER.
- O SIDEWALKS AND WHEELCHAIR RAMPS WITHIN THE CURB RETURNS SHALL BE CONSTRUCTED WHEREVER A NEW CURB RETURN IS CONSTRUCTED.
- O IF CURB IS DEPRESSED FOR A DRIVEPAD OR A HANDICAP RAMP, THE DRIVEPAD OR RAMP SHALL BE CONSTRUCTED PRIOR TO ACCEPTANCE OF THE CURB AND GUTTER.
- ALL STORM DRAINAGE FACILITIES SHALL BE COMPLETED, INSPECTED AND APPROVED PRIOR TO FINAL ACCEPTANCE.

APPROVALS	ENGINEERS	DATE	
A.C.E./DESIGN			
INSPECTOR			
A.C.E./FIELD			

PHASE

PHASE I OF THE DEVELOPMENT OF THIS PROJECT, ON EXISTING PARCEL 16, WILL INCLUDE THE BUILDING, ASSOCIATED 24-FOOT WIDE PAVED DRIVE WEST OR THE BUILDING, ASSOCIATED PAVED PARKING WEST OF THE BUILDING, PAVED SERVICE YARD SOUTH OF THE BUILDING, RETAINING WALL AT THE EAST PROPERTY LINE, THE CONCRETE/CRUSHER FINE CHANNEL AT THE WEST PROPERTY LINE, AND THE NEW SIDEWALK CULVERTS TO RUTLEDGE ROAD.

IN ORDER TO MAKE THE DRAINAGE FUNCTION, TEMPORARY RIPRAP LINED SWALES FROM THE END OF BOTH THE NORTH AND SOUTH VALLEY GUTTERS MUST BE CONSTRUCTED TO THE NEW CHANNEL AT THE WEST PROPERTY LINE.

PHASE

PHASE II OF THE DEVELOPMENT OF THIS PROJECT, ON EXISTING PARCELS 17 AND 18, WILL INCLUDE THE CENTER BUILDING, ASSOCIATED 24-FOOT WIDE PAVED DRIVES EAST AND WEST OR THE BUILDING, ASSOCIATED PAVED PARKING EAST AND WEST OF THE BUILDING, AND PAVED SERVICE YARD SOUTH OF THE BUILDING.

THE TEMPORARY RIPRAP LINED SWALES FROM THE END OF BOTH THE NORTH AND SOUTH VALLEY GUTTERS CONSTRUCTED IN PHASE I WILL BE SHORTENED IN PHASE II. THEY WILL REMAIN FROM THE WEST SIDE OF PHASE II DEVELOPMENT TO THE CHANNEL AT THE WEST PROPERTY LINE OF LOT 19.

PHASE II

PHASE II INCLUDES THE BUILDING ON PARCEL 19 AS WELL AS ASSOCIATED PAVED PARKING, DRIVES, AND SOUTH SERVICE YARD AND IS THE CONCLUSION TO THIS DEVELOPMENT. THIS PHASE WILL REPLACE THE TEMPORARY DRAINAGE SWALES AND GRADING WITH PERMANENT PAVEMENT AND CONCRETE VALLEY GUTTERS.

ARCHITECT SEAL

ENGINEER SEAL

PROJECT

DEVELOPMENT

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OPMENT PL RK @ JOURN/ JOURNAL (SITE DEVINDUSTRIAL 9


REVISIONS

June 16, 2003 1" = 20'DRAWING NAME

PHASE I GRADING PLAN

SHEET NUMBER

OWNER SERVED. BEING CONSTRUCTED IN PHASE IT OF THIS PROJECT -CUBROUTLY LANDER CORSTRUCTION DRAINAGE CERTITICATION l, Larry D. Read, NMPE 10998, of the firm Larry

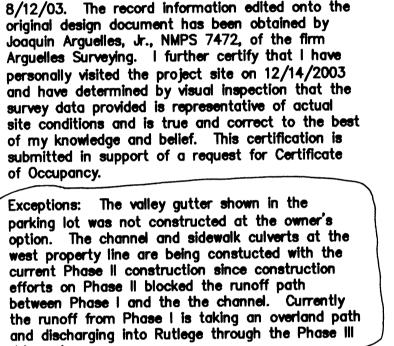

The record information presented hereon is not necessarily complete and intended only to verify substantial compliance of the Grading and Drainage aspects of this project. Those relying on this record document are advised to obtain independent verification of its accuracy before using it for any other purpose.

Read & Associates, Inc., hereby certify that this

the design intent of the approved plan dated

substantial compliance with and in accordance with


project has been graded and will drain in


of Occupancy.









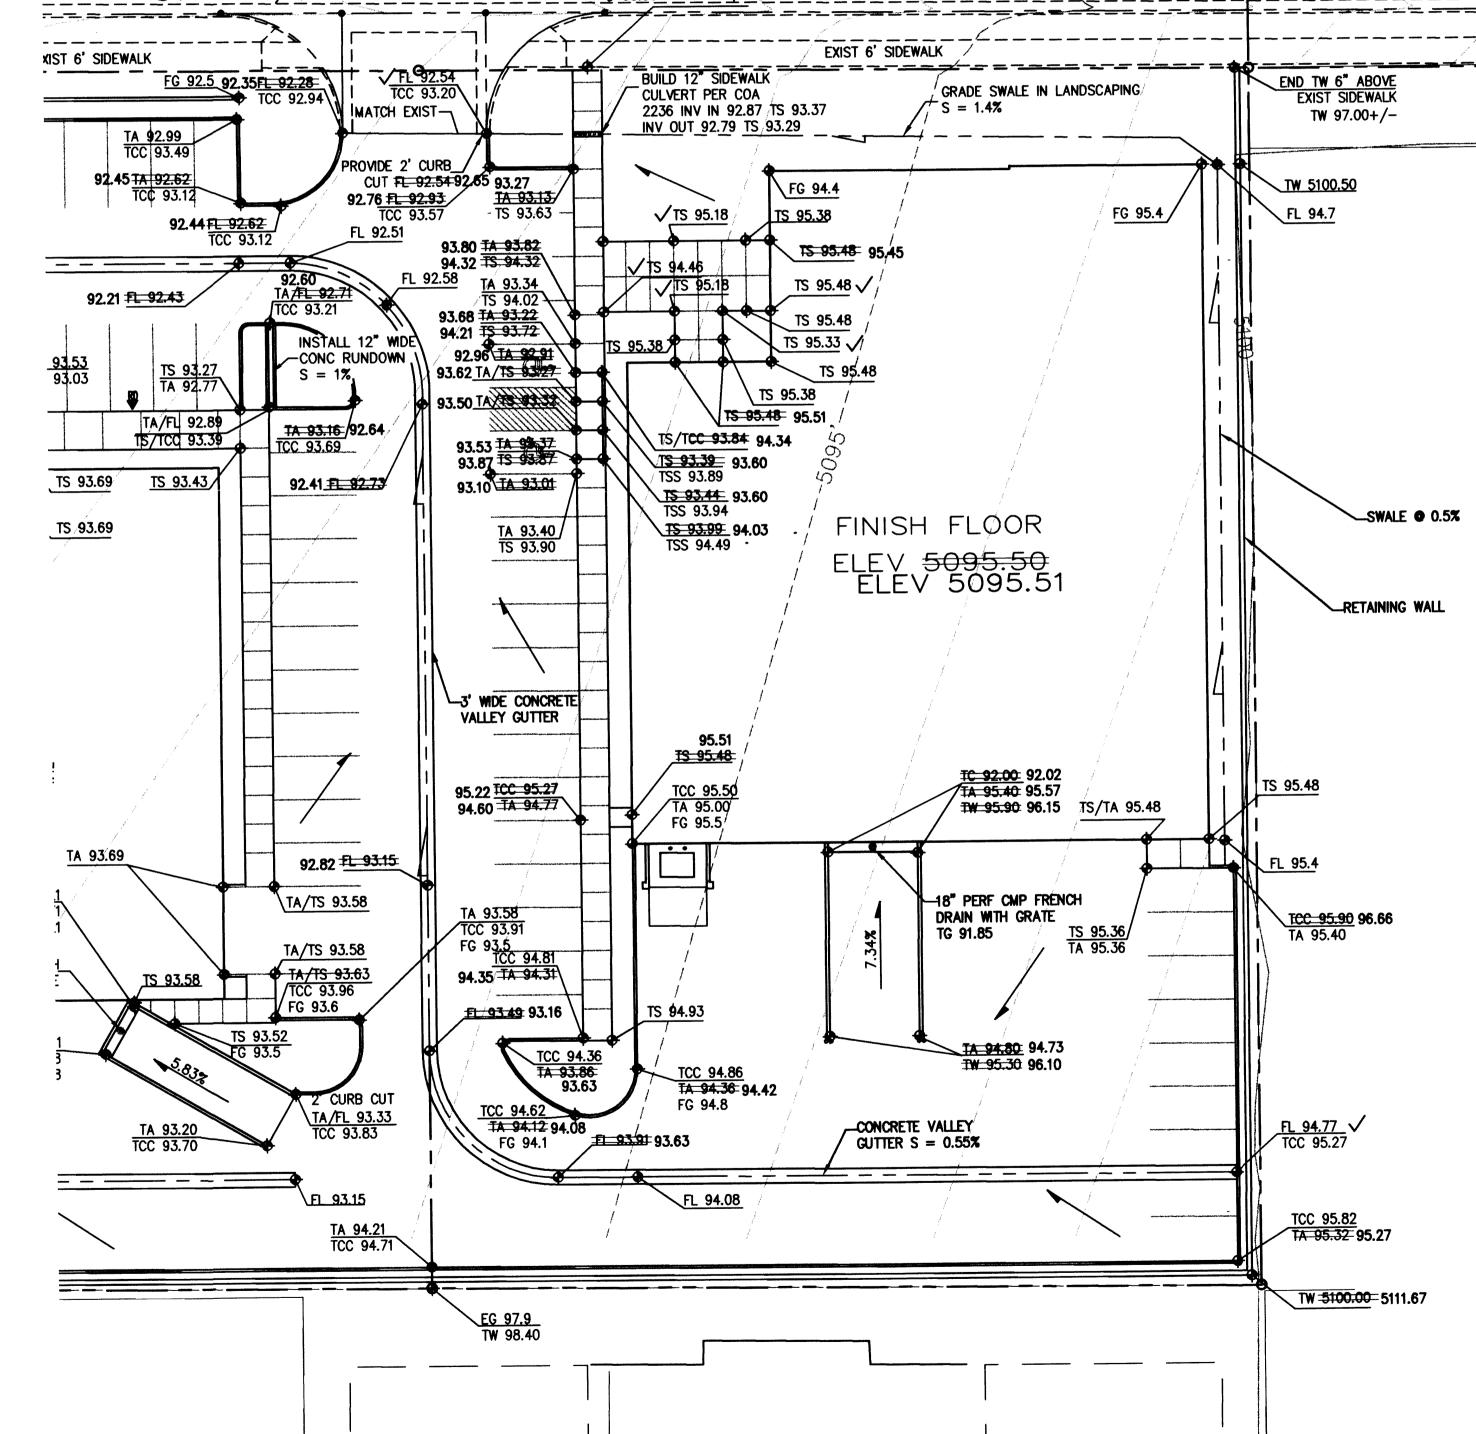

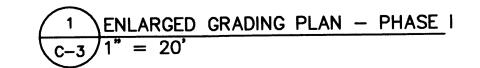




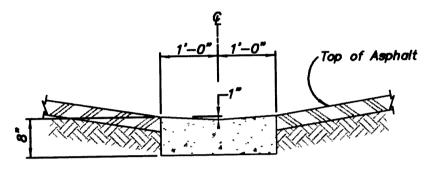


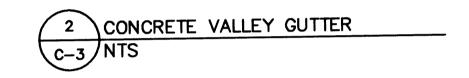


CONSTRUCTION NOTES:

- 1. ALL CONCRETE SHALL BE 3000 PSI (28DAY) CONCRETE.
- 2. PROVIDE A TEXTURED SURFACE ON RAMP IN ACCORDANCE WITH ADA AND ANSI.

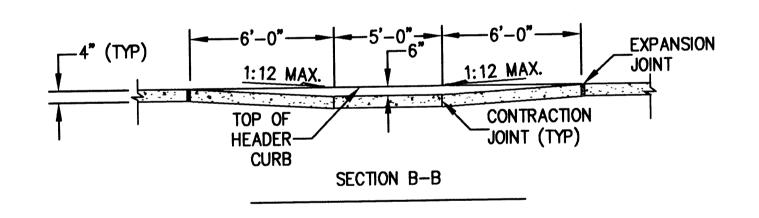

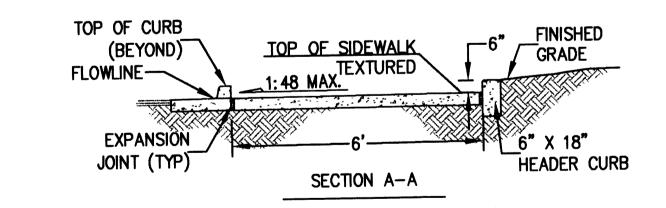

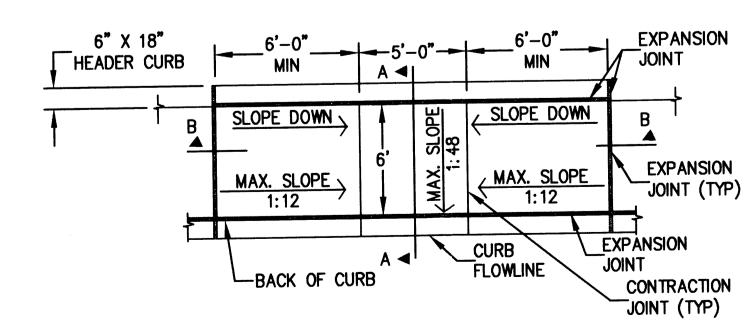

3 CONCRETE HANDICAP RAMP DETAIL C-3 N. T. S.

Ree 12/18/03

SO-19 FORM

NOTICE TO CONTRACTOR

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- 3. TWO (2) WORKING DAYS PRIOR TO ANY EXCAVATION. THE CONTRACTOR MUST CONTACT LINE LOCATING SERVICE 260-1990, FOR LOCATION OF EXISTING UTILITIES.
- 4. PRIOR TO CONSTRUCTION, THE CONTRACTOR SHALL EXCAVATE AND VERIFY THE HORIZONTAL AND VERTICAL LOCATIONS OF ALL OBSTRUCTIONS. SHOULD A CONFLICT EXIST, THE CONTRACTOR SHALL NOTIFY THE ENGINEER OR SURVEYOR SO THAT THE CONFLICT CAN BE RESOLVED WITH MINIMUM AMOUNT OF DELAY.
- 5. BACKFILL COMP ACTION SHALL BE ACCORDING TO ARTERIAL STREET USE.
- 6. MAINTENANCE OF THESE FACILITIES SHALL BE THE RESPONSIBILITY OF THE

OWNER SERVED.

THE FOLLOWING NOTES ALSO APPLY WHEN CHECKED

- Ø ALL UTILITIES AND UTILITY SERVICE LINES SHALL BE INSTALLED PRIOR TO CONSTRUCTION OF ANY SIDEWALK OR PAVEMENT.
- Ø BACKFILL COMP ACTION SHALL BE ACCORDING TO ARTERIAL STREET USE.
- TACK COAT REQUIREMENTS SHALL BE DETERMINED BY THE CITY ENGINEER.
- O SIDEWALKS AND WHEELCHAIR RAMPS WITHIN THE CURB RETURNS SHALL BE CONSTRUCTED WHEREVER A NEW CURB RETURN IS CONSTRUCTED. O IF CURB IS DEPRESSED FOR A DRIVEPAD OR A HANDICAP RAMP, THE

DRIVEPAD OR RAMP SHALL BE CONSTRUCTED PRIOR TO ACCEPTANCE OF

THE CURB AND GUTTER. Ø ALL STORM DRAINAGE FACILITIES SHALL BE COMPLETED, INSPECTED AND APPROVED PRIOR TO FINAL ACCEPTANCE.

DISCUSSION

PHASE I

APPROVALS ENGINEERS DATE

A.C.E. / DESIGN

INSPECTOR

A.C.E./FIELD

PHASE I OF THE DEVELOPMENT OF THIS PROJECT, ON EXISTING PARCEL 16, INCLUDED THE BUILDING, ASSOCIATED 24-FOOT WIDE PAVED DRIVE WEST OR THE BUILDING, ASSOCIATED PAVED PARKING WEST OF THE BUILDING, PAVED SERVICE YARD SOUTH OF THE BUILDING, RETAINING WALL AT THE EAST PROPERTY LINE, THE CONCRETE/CRUSHER FINE CHANNEL AT THE WEST PROPERTY LINE, AND THE NEW SIDEWALK CULVERTS TO RUTLEDGE ROAD.

A CERTIFICATE OF OCCUPANCY FOR PHASE I WAS ISSUED ON DECEMBER 18, 2003

PHASE II

PHASE II OF THE DEVELOPMENT OF THIS PROJECT, ON EXISTING PARCELS 17 AND 18, INCLUDED THE CENTER BUILDING, ASSOCIATED 24-FOOT WIDE PAVED DRIVES EAST AND WEST OR THE BUILDING, ASSOCIATED PAVED PARKING EAST AND WEST OF THE BUILDING, AND PAVED SERVICE YARD SOUTH OF THE BUILDING.

A CERTIFICATE OF OCCUPANCY WAS ISSUED FOR THE PHASE II DEVELOPMENT ON MARCH 26,


TABLE 1

100-YEAR HYDROLOGIC CALCULATIONS

		L	AND TR	EATMEN	IT	WEIGHTED E							
BASIN	AREA	A	В	С	D		V (6-hr)	V (6-hr)	V(10 day)	V(10 day)	Q		
#	(acre)	(%)	(%)	(%)	(%)	(in)	(acre-ft)	(cu-ft)	(acre-ft)	(cu-ft)	(cfs)		
					EXSTIN	IG CONDITIO	ONS						
BASIN A	1.0652	100.00	10.00	0.00	0.00	0.61	0.05	2,351	0.05	2,351	1.90		
BASIN B	1.1489	100.00	0.00	0.00	0.00	0.53	0.05	2,210	0.05	2,210	1.79		
BASIN C	0.8814	100.00	0.00	0.00	0.00	0.53	0.04	1,696	0.04	1,696	1.37		
					DEVOP	ED CONDITI	ONS						
BASIN A	1.0652	0.00	5.70	5.00	89.30	1.99	0.18	7,710	0.30	13,235	4.78		
BASIN B	1.1489	0.00	0.00	0.00	100.00	2.12	0.20	8,841	0.36	15,514	5.40		
BASIN C	0.8814	0.00	6.20	6.10	87.70	1.98	0.15	6,324	0.25	10,813	3.93		
											10.3		
EXCESS PR	ECIP.	0.53	0.78	1.13	2.12	E: (in)					10		
PEAK DISCH	IARGE	1.56	2.28	3.14	4.7	Qei (cfs)					12		
									ZONE =	2			
WEIGHTED I					C) + (E _D)((%D)			P _{6-HR} (in.) =	2.35			
V ₆ HR (acre-ft) = (WEIGHTED E)(AREA)/12								P_{24-HR} (in.) = 2.75					
V10DAY (acre-f									P10DAY (in.) =	3.95			
$Q (cfs) = (Q_{PA}$.)(Aa) + (Qp	в)(Ав) + (С	⊋ Pc)(Ac) -	+ (Q _{PD})(A	w)								

PHASE III


IN THE ORIGINAL SITE DRAINAGE PLAN, PHASE III INCLUDED A BUILDING ON PARCEL 19 AS WELL AS ASSOCIATED PAVED PARKING, DRIVES, AND SOUTH SERVICE YARD AND WAS THE CONCLUSION TO THIS DEVELOPMENT. SINCE THE SITE MASTER DRAINAGE PLAN WAS COMPLETED, THE DEVELOPER HAS PURCHASED LOT 20 AND IS PROPOSING TO CONSTRUCT A 40,000 SQUARE FOOT BUILDING WITH ASSOCIATED PAVED PARKING ON BOTH LOT 19 AND 20 AS SHOWN ON THIS PLAN. THE DRAINAGE CONCEPT SHOWN ON THE ORIGINAL SITE MASTER DRAINAGE PLAN IS STILL FOLLOWED ON THIS PROPOSED PLAN EXCEPT THE CHANNEL ALONG THE WEST SIDE OF LOT 19 IS NO LONGER NEEDED. THE SIDEWALK CULVERTS ORIGINALLY PROPOSED ON RUTLEDGE WILL STILL BE USED TO DRAIN THE NORTHERN PORTION (BASIN A) OF THE PHASE III DEVELOPMENT. THE RUNOFF FROM PHASES I AND I HAVE BEEN DIVERTED THROUGH THE EXISTING DRIVEPAD ON THE WEST EDGE OF PHASE II, INTO RUTLEDGE AND INTO THE EXISTING STORM DRAIN SYSTEM NORTH OF THE CENTER OF THE PHASE III DEVELOPMENT. IN ADDITION TO THE PHASE I AND II RUNOFF DIRECTED TO THE EXISTING STORM DRAIN SYSTEM THE RUNOFF FROM PHASE III BASIN A WILL DISCHARGE THROUGH TWO PROPOSED SIDEWALK CULVERTS INTO RUTLEDGE AND ULTIMATELY IN THE EXISTING STORM DRAIN SYSTEM. THIS PROPOSED GRADING PLAN ADDS A NEW SIDEWALK CULVERT IN THE NORTHWEST CORNER OF THE EXPANDED PARKING LOT THAT DRAINS THE WEST (BASIN C) PARKING LOT IN TO SNAPROLL ROAD TO THE WEST OF THE SITE IN ACCORDANCE WITH THE EXISTING MASTER DRAINAGE PLAN PREPARED BY BOHANNAN HUSTON. THE SOUTHERN PORTION OF THE BUILDING AND SOUTH ACCESS DRIVES, BASIN B WILL DRAIN WEST THROUGH THE SOUTHERN PORTION OF THE WEST PARKING LOT AND INTO SNAPROLL ROAD THROUGH THE PROPOSED DRIVEPAD NEAR THE SOUTHWEST CORNER OF THE SITE. THIS IS IN CONTRAST TO THE BOHANNAN HUSTON MASTER DRAINAGE PLAN AS IT WILL DIVERT AN ADDITIONAL 5.40 CFS INTO SNAPROLL ROAD. THIS DRAINAGE WILL ULTIMATELY BE CONVEYED THROUGH A DEVELOPMENT ON THE WEST SIDE OF SNAPROLL TO THE NORTH DIVERSION CHANNEL. SINCE THE DEVELOPER OF THE SITE WEST OF SNAPROLL THIS ADDITIONAL RUNOFF WILL PASS THROUGH IS THE SAME AS THE DEVELOPER OF THIS PROJECT, WE HAVE COORDINATED WITH WILSON AND COMPANY, THE DESIGNER OF THE ADJACENT SITE, AND THE CITY OF ALBUQUERQUE HYDROLOGY DEPARTMENT TO REDESIGN THEIR RUNDOWNS INTO THE NORTH DIVERSION CHANNEL TO CONVEY THIS ADDITIONAL FLOW.

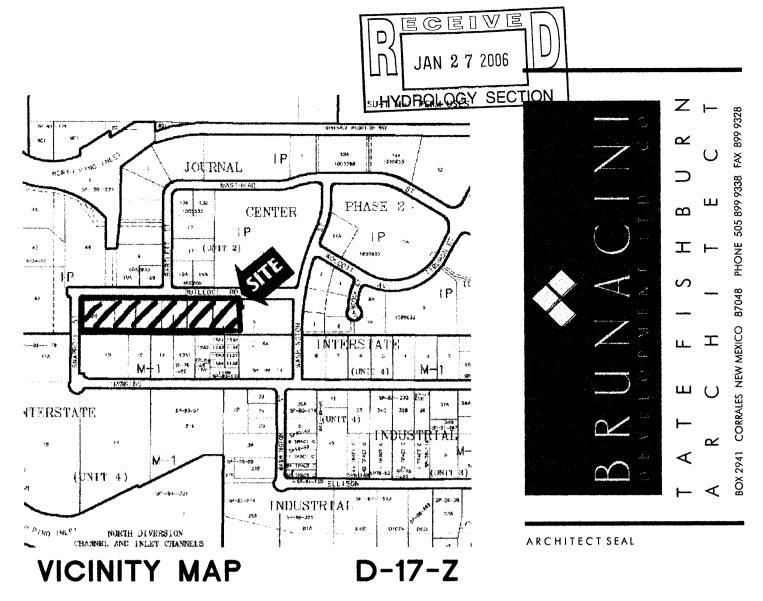

LEGAL DESCRIPTION

LOTS 16-19, JOURNAL CENTER 2 (PHASE I, II, AND ORIGINAL III) LOTS 19 AND 20, JOURNAL CENTER 2 (EXPANDED PHASE III)

ENGINEER SEAL

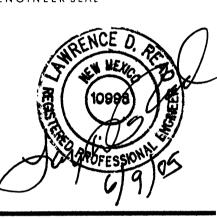


PROJECT

I, Larry D. Read, NMPE 10998, of the firm Larry Read & Associates, Inc., hereby certify that this project has been graded and will drain in substantial compliance with and in accordance with the design intent of the approved plan dated 6/9/2005. The record information edited onto the original design document has been obtained by Joaquin Arguelles, NMPS 7472. I further certify that I have personally visited the project site on 01/27/2006 and have determined by visual inspection that the survey data provided is representative of actual site conditions and is true and correct to the best of my knowledge and belief. This certification is submitted in support

Exceptions: The developer reverted to a previous Master Grading Plan for the site and constructed 4 24" sidewalk culverts on Rutledge and routed all runoff from the eastern portion of the site to them eliminating the runoff discharge through the drivepad. The pad for the western 1/4 of the site is graded but the building is not constructed at this time. However, all grading and drainage was constructed for the full buildout.


The record information presented hereon is not necessarily complete and intended only to verify substantial compliance of the Grading and Drainage aspects of this project. Those relying on this record document are advised to obtain independent verification of its accuracy before using it for any other purpose.

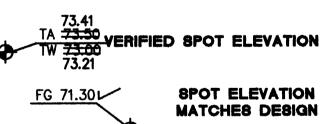



NTER PLA 出 111 URNAL MODIFIE DRAIN JOURNAI EW QUERQU 20 PARK AND SITE GRADII INDUSTRIAL I LBU


REVISIONS

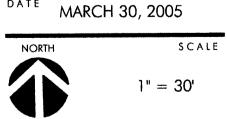

GRADING PLAN

SHEET NUMBER

DRAWING NAME

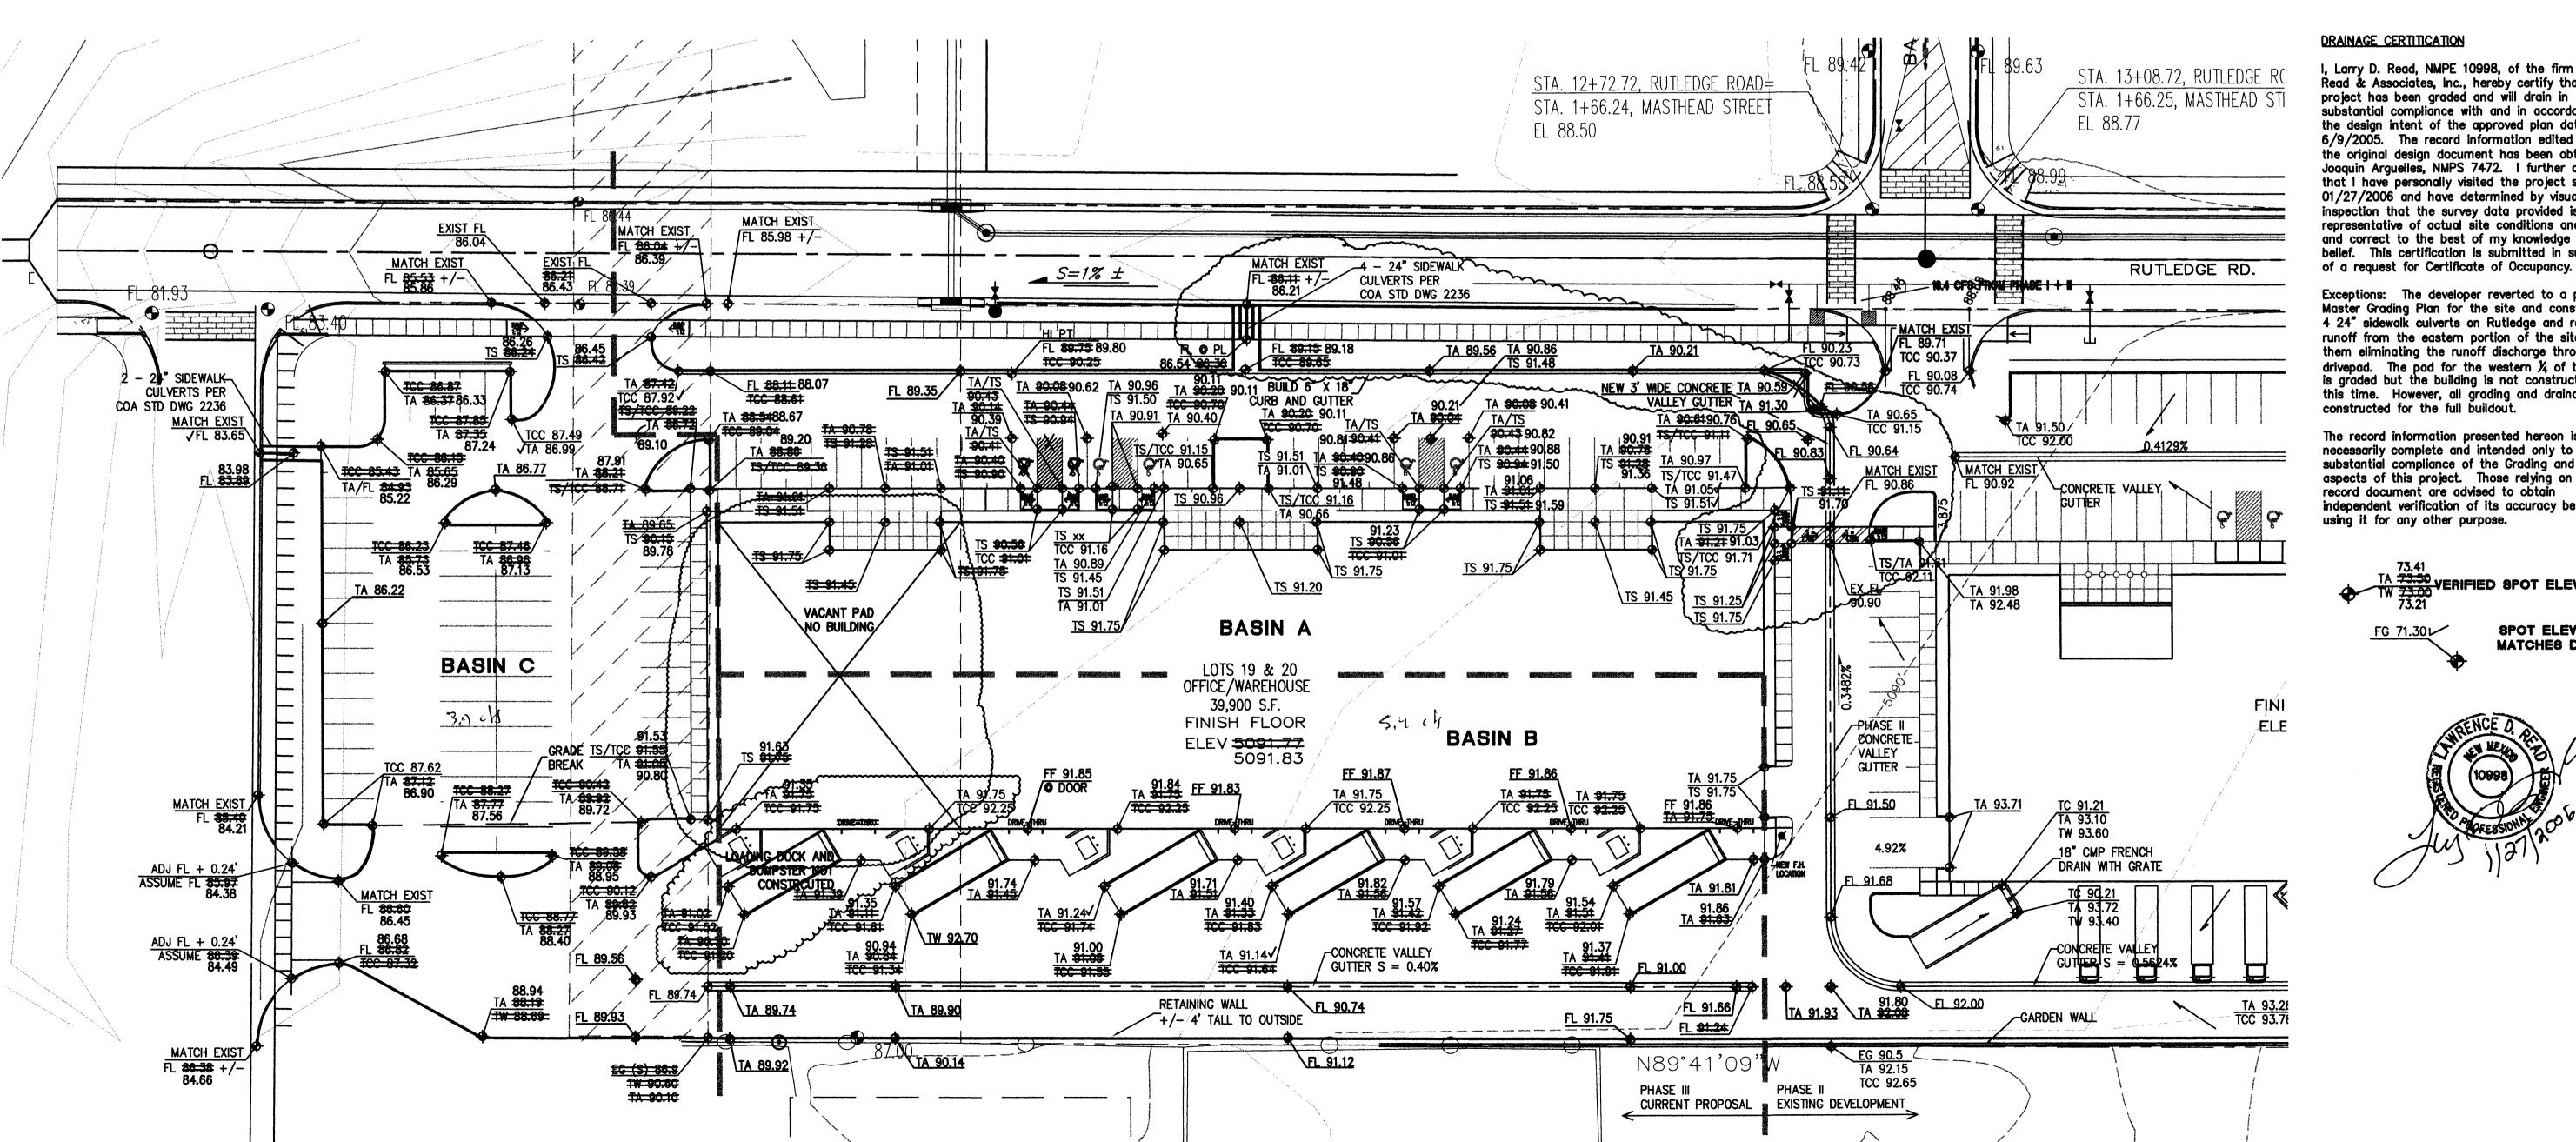

SO-19 FORM

NOTICE TO CONTRACTOR

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- ALL STORM DRAINAGE FACILITIES SHALL BE COMPLETED, INSPECTED AND APPROVED PRIOR TO FINAL ACCEPTANCE.

DISCUSSION

PHASE 1

APPROVALS ENGINEERS DATE

A.C.E. /DESIGN

INSPECTOR

A.C.E./FIELD

PHASE I OF THE DEVELOPMENT OF THIS PROJECT, ON EXISTING PARCEL 16, INCLUDED THE BUILDING, ASSOCIATED 24-FOOT WIDE PAVED DRIVE WEST OR THE BUILDING, ASSOCIATED PAVED PARKING WEST OF THE BUILDING, PAVED SERVICE YARD SOUTH OF THE BUILDING, RETAINING WALL AT THE EAST PROPERTY LINE, THE CONCRETE/CRUSHER FINE CHANNEL AT THE WEST PROPERTY LINE, AND THE NEW SIDEWALK CULVERTS TO RUTLEDGE ROAD.

A CERTIFICATE OF OCCUPANCY FOR PHASE I WAS ISSUED ON DECEMBER 18, 2003

PHASE II

PHASE II OF THE DEVELOPMENT OF THIS PROJECT, ON EXISTING PARCELS 17 AND 18, INCLUDED THE CENTER BUILDING, ASSOCIATED 24-FOOT WIDE PAVED DRIVES EAST AND WEST OR THE BUILDING, ASSOCIATED PAVED PARKING EAST AND WEST OF THE BUILDING, AND PAVED SERVICE YARD SOUTH OF THE BUILDING.

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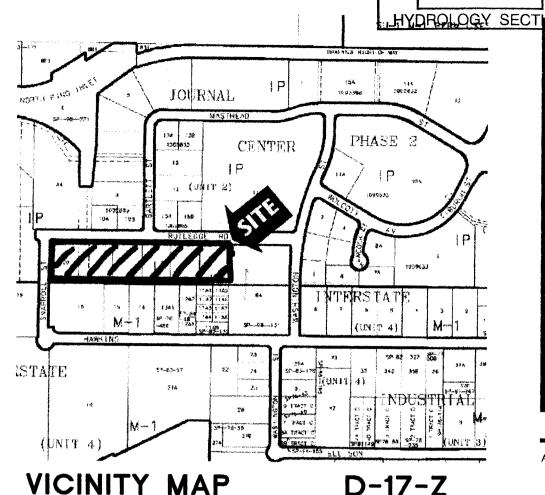
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100-YEAR HYDROLOGIC CALCULATIONS

		L	AND TR	EATMEN	IT	WEIGHTED						
BASIN	AREA	A	В	C	D	E	V (6-hr)	V (6-hr)	V(10 day)	V(10 day)	Q	
#	(acre)	(%)	(%)	(%)	(%)	(in)	(acre-ft)	(cu-ft)	(acre-ft)		(cfs)	
					EXSTI	NG CONDITIO	ONS					
BASIN A	1.0652	100.00	10.00	0.00	0.00	0.61	0.05	2,351	0.05	2,351	1.90	
BASIN B	1.1489	100.00	0.00	0.00	0.00	0.53	0.05	2,210	0.05	2,210	1.79	
BASIN C	0.8814	100.00	0.00	0.00	0.00	0.53	0.04	1,696	0.04	1,696	1.37	
					DEVOF	PED CONDITION	ONS					
BASIN A	1.0652	0.00	5.70	5.00	89.30	1.99	0.18	7,710	0.30	13,235	4.78	
BASIN B	1.1489	0.00	0.00	0.00	100.00	2.12	0.20	8,841	0.36	15,514	5.40	
BASIN C	0.8814	0.00	6.20	6.10	87.70	1.98	0.15	6,324	0.25	10,813	3.93	
EXCESS PRE		0.53	0.78	1.13	2.12	E: (in)						
PEAK DISCH	ARGE	1.56	2.28	3.14	4.7	Qei (cfs)						
							'		ZONE =	: 2		
WEIGHTED F	WEIGHTED E (in) = $(E_A)(%A) + (E_B)(%B) + (E_C)(%C) + (E_C)(%D)$						P_{6-HR} (in.) = 2.35					
V _{6-HR} (acre-ft)) = (WEIGH	ITED E)(A	REA)/12	2			P_{24-HR} (in.) = 2.75					
V10DAY (acre-ft									P10DAY (in.) =			
$Q (cfs) = (Q_{PA})$	$J(A_A) + (Q_P)$	a)(Aa) + (C	JPc)(Ac)	+ (Q _{PD})(A	vo)							

PHASE III

IN THE ORIGINAL SITE DRAINAGE PLAN, PHASE III INCLUDED A BUILDING ON PARCEL 19 AS WELL AS ASSOCIATED PAVED PARKING, DRIVES, AND SOUTH SERVICE YARD AND WAS THE CONCLUSION TO THIS DEVELOPMENT. SINCE THE SITE MASTER DRAINAGE PLAN WAS COMPLETED. THE DEVELOPER HAS PURCHASED LOT 20 AND IS PROPOSING TO CONSTRUCT A 40.000 SQUARE FOOT BUILDING WITH ASSOCIATED PAVED PARKING ON BOTH LOT 19 AND 20 AS SHOWN ON THIS PLAN. THE DRAINAGE CONCEPT SHOWN ON THE ORIGINAL SITE MASTER DRAINAGE PLAN IS STILL FOLLOWED ON THIS PROPOSED PLAN EXCEPT THE CHANNEL ALONG THE WEST SIDE OF LOT 19 IS NO LONGER NEEDED. THE SIDEWALK CULVERTS ORIGINALLY PROPOSED ON RUTLEDGE WILL STILL BE USED TO DRAIN THE NORTHERN PORTION (BASIN A) OF THE PHASE III DEVELOPMENT. THE RUNOFF FROM PHASES I AND I HAVE BEEN DIVERTED THROUGH THE EXISTING DRIVEPAD ON THE WEST EDGE OF PHASE II. INTO RUTLEDGE AND INTO THE EXISTING STORM DRAIN SYSTEM NORTH OF THE CENTER OF THE PHASE III DEVELOPMENT. IN ADDITION TO THE PHASE I AND II RUNOFF DIRECTED TO THE EXISTING STORM DRAIN SYSTEM. THE RUNOFF FROM PHASE III BASIN A WILL DISCHARGE THROUGH TWO PROPOSED SIDEWALK CULVERTS INTO RUTLEDGE AND ULTIMATELY IN THE EXISTING STORM DRAIN SYSTEM. THIS PROPOSED GRADING PLAN ADDS A NEW SIDEWALK CULVERT IN THE NORTHWEST CORNER OF THE EXPANDED PARKING LOT THAT DRAINS THE WEST (BASIN C) PARKING LOT IN TO SNAPROLL ROAD TO THE WEST OF THE SITE IN ACCORDANCE WITH THE EXISTING MASTER DRAINAGE PLAN PREPARED BY BOHANNAN HUSTON. THE SOUTHERN PORTION OF THE BUILDING AND SOUTH ACCESS DRIVES, BASIN B WILL DRAIN WEST THROUGH THE SOUTHERN PORTION OF THE WEST PARKING LOT AND INTO SNAPROLL ROAD THROUGH THE PROPOSED DRIVEPAD NEAR THE SOUTHWEST CORNER OF THE SITE. THIS IS IN CONTRAST TO THE BOHANNAN HUSTON MASTER DRAINAGE PLAN AS IT WILL DIVERT AN ADDITIONAL 5.40 CFS INTO SNAPROLL ROAD. THIS DRAINAGE WILL ULTIMATELY BE CONVEYED THROUGH A DEVELOPMENT ON THE WEST SIDE OF SNAPROLL TO THE NORTH DIVERSION CHANNEL. SINCE THE DEVELOPER OF THE SITE WEST OF SNAPROLL THIS ADDITIONAL RUNOFF WILL PASS THROUGH IS THE SAME AS THE DEVELOPER OF THIS PROJECT. WE HAVE COORDINATED WITH WILSON AND COMPANY, THE DESIGNER OF THE ADJACENT SITE, AND THE CITY OF ALBUQUERQUE HYDROLOGY DEPARTMENT TO REDESIGN THEIR RUNDOWNS INTO THE NORTH DIVERSION CHANNEL TO CONVEY THIS ADDITIONAL FLOW.




D-17-Z

ARCHITECT SEAL

LEGAL DESCRIPTION

LOTS 16-19, JOURNAL CENTER 2 (PHASE I, II, AND ORIGINAL III) LOTS 19 AND 20, JOURNAL CENTER 2 (EXPANDED PHASE III)

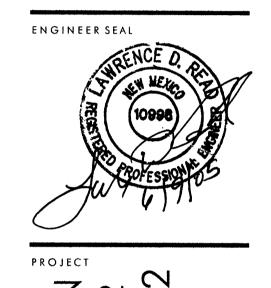

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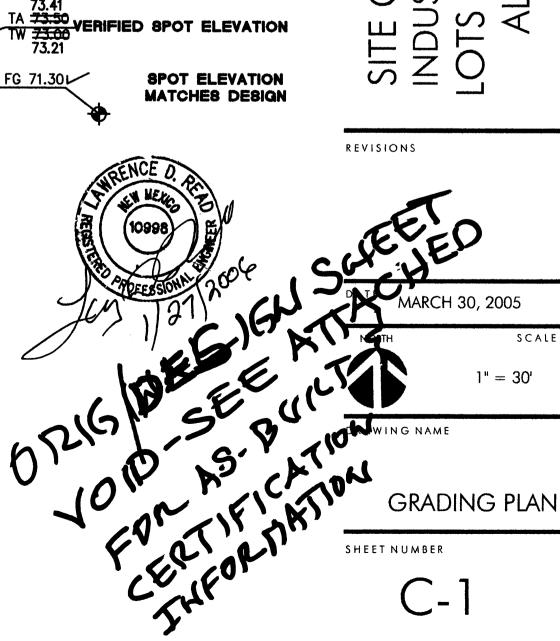



I, Larry D. Read, NMPE 10998, of the firm Larry Read & Associates, Inc., hereby certify that this project has been graded and will drain in substantial compliance with and in accordance with the design intent of the approved plan dated 6/9/2005. The record information edited onto the original design document has been obtained by Joaquin Arguelles, NMPS 7472. I further certify that I have personally visited the project site on 01/27/2006 and have determined by visual inspection that the survey data provided is representative of actual site conditions and is true belief. This certification is submitted in support of a request for Certificate of Occupancy.

Exceptions: The developer reverted to a previous Master Grading Plan for the site and constructed 4 24" sidewalk culverts on Rutledge and routed all runoff from the eastern portion of the site to them eliminating the runoff discharge through the drivepad. The pad for the western ¼ of the site is graded but the building is not constructed at this time. However, all grading and drainage was constructed for the full buildout.

The record information presented hereon is not necessarily complete and intended only to verify substantial compliance of the Grading and Drainage aspects of this project. Those relying on this record document are advised to obtain independent verification of its accuracy before using it for any other purpose.





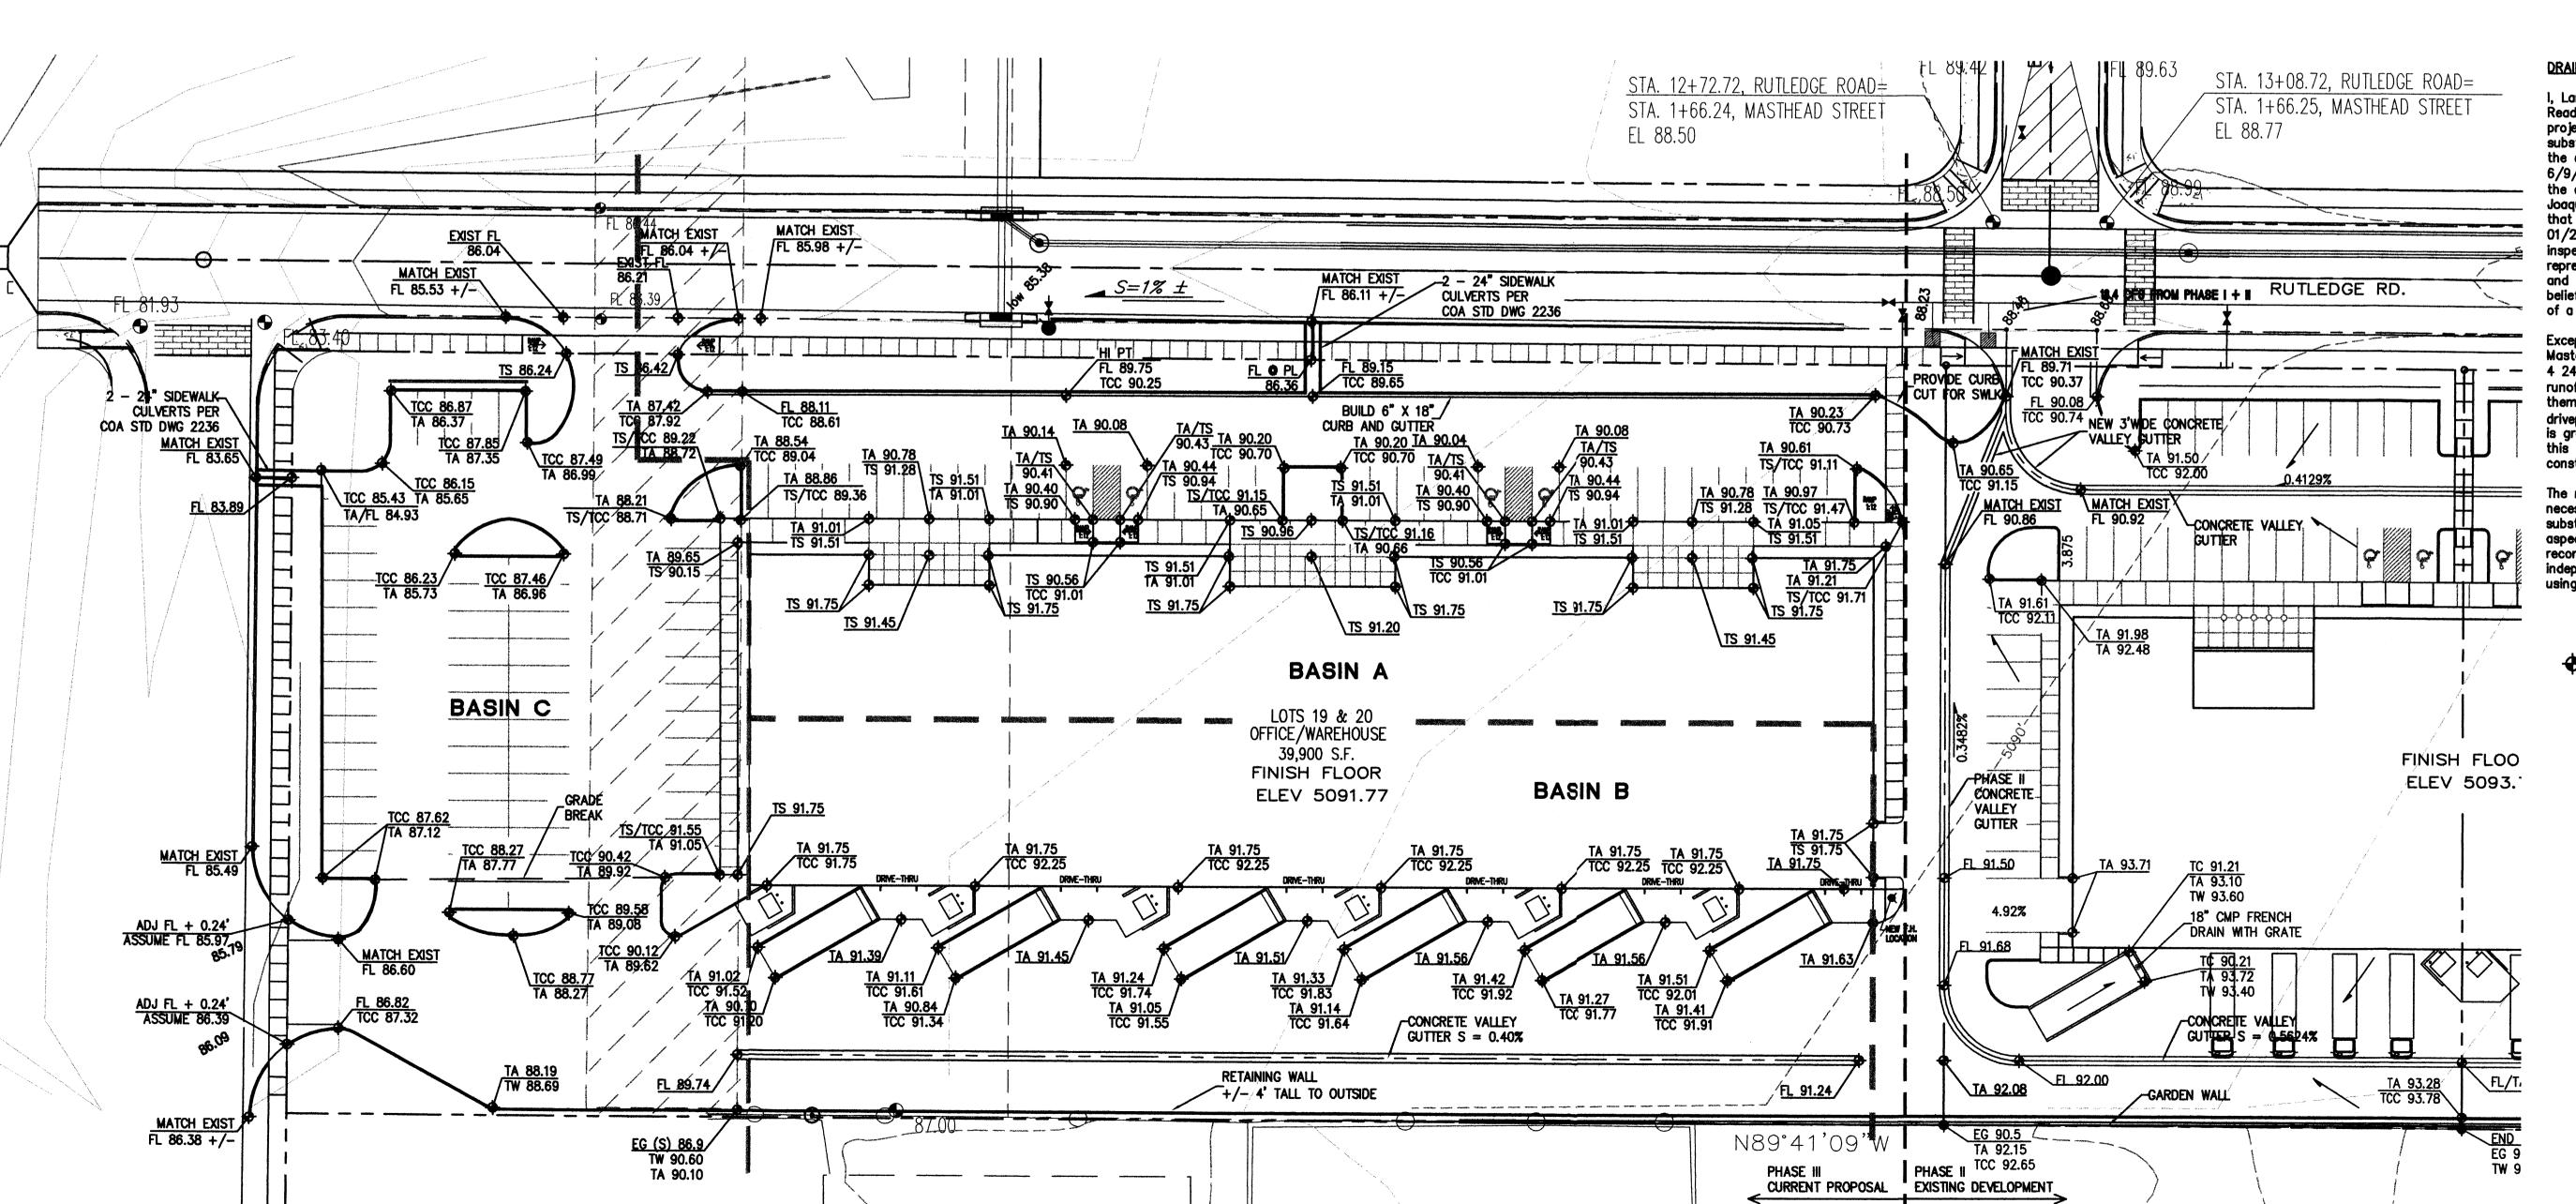

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INSPECTOR

A.C.E./FIELD

APPROVALS

A.C.E./DESIGN

ENGINEERS DATE

DISCUSSION

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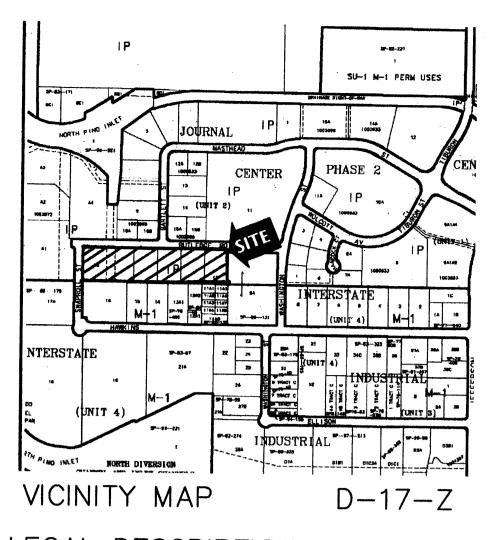
YARD SOUTH OF THE BUILDING.

100-YEAR HYDROLOGIC CALCULATIONS

BASIN AREA # (acre)		L	AND TR	EATMEN	TV	WEIGHTED					
		A (%)	B (%)	C (%)	D (%)	E (in)	V (6-hr) (acre-ft)	V (6-hr) (cu-ft)	V(10 day) (acre-ft)	V(10 day) (cu-ft)	Q (cfs)
10 1 1 1 1 1 1 1 1 1 1 1 1 1 1 1 1 1 1					EXSTI	NG CONDITIO	NS				(0.0)
BASIN A	1.0652	100.00	10.00	0.00	0.00	0.61	0.05	2,351	0.05	2,351	1.90
BASIN B	1.1489	100.00	0.00	0.00	0.00	0.53	0.05	2,210	0.05	2,210	1.79
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VEIGHTED E	= (WEIGH	TED E)(A	REA)/12		C) + (E _D)((%D)	·		ZONE = P6-HR (in.) = P24-HR (in.) =	2.35	
/10DAY (acre-ft (cfs) = (QPA)) = V _{6-HR} + ; (Aa) + (Ope	$(AD)(P_{10DA})$	y - P6-HR)/	/12 · (O)/A	>		•		P10DAY (in.) =		


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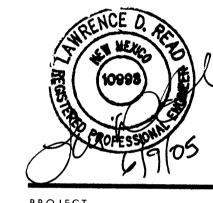


LEGAL DESCRIPTION

LOTS 16-19, JOURNAL CENTER 2 (PHASE I, II, AND ORIGINAL III) LOTS 19 AND 20, JOURNAL CENTER 2 (EXPANDED PHASE III)





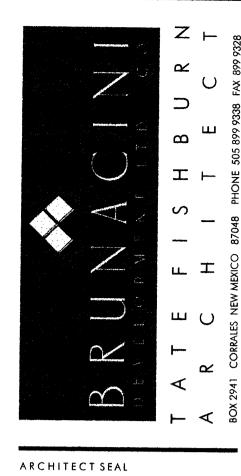

PROJECT

ER E шш JOURNAL ALBUQUERQUE 20, SITE GRALIII...
INDUSTRIAL PARK (INTS 19 AND 20)

REVISIONS

DATE MARCH 30, 2005

1'' = 30'DRAWING NAME

GRADING PLAN

SHEET NUMBER

STA. 13+08.72, RUTLEDGE ROAD= STA. 12+72.72 RUTLEDGE ROAD STA. 1+66.25, MASTHEAD STREET STA. 1+66.24, MASTHEAD STREET EL 88.50 MATCH EXIST FL 85.98 +/-MATCH EXIST 2 - 24" SIDEWALK CULVERTS PER COA STD DWG 2236 RUTLEDGE RD. HI PT FL 89.75 TCC 90.25 - 2 SIDEWALK CULVERTS PER COA STD DWG 2236 MATCH EXIST FL 83.65 TA 90.20 TA 90.04 TCC 90.70 TA/TS TA 90.61 TS/TCC 91.11 TS/1CL

TA 90.78 TA 90.97
TS/TCC 91.47
TA 91.05
TS 91.51 TCC 85.43 TA 85.65 TA/FL 84.93 MATCH EXIST FL 90.86 CONCRETE VALLEY TS/TCC 91.7 TS 91.20 TS 91.45 BASIN A BASIN C LOTS 19 & 20 OFFICE/WAREHOUSE 39,900 S.F. FINISH FLOOR FINISH FLOOR -PHASE II BASIN B ELEV 5093.72 **ELEV 5091.77** CONCRETE VALLEY **GUTTER** TA 91.75 TCC 92.25 FL 91.50 TC 91.21 TA 93.10 TW 93.60 ADJ FL + 0.24' ASSUME FL 85.97₁₉ _18" CMP FRENCH DRAIN WITH GRATE FL 91.68 TA 91.11 TCC 91.6 TCC 91.92 TCC 92.0 ADJ FL + 0.24'
ASSUME 86.39 TA 91.14 TCC 91.64 CONCRETE VALLEY CONCRETE VALLEY
GUTTER S = 0.5624% GUTTER S = 0.40%TA 88.19 TW 88.69 RETAINING WALL FL 92.00 +/-/4' TALL TO OUTSIDE FL/TA 9 TA 92.08 MATCH EXIST FL 86.38 +/-EG (S) 86.9 TW 90.60 TA 90.10 PHASE II TCC 92.65 PHASE III CURRENT PROPOSAL EXISTING DEVELOPMENT

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APPROVALS	ENGINEERS	DATE	
A.C.E./DESIGN			
INSPECTOR			
A.C.E./FIELD			

DISCUSSION

PHASE

PHASE I OF THE DEVELOPMENT OF THIS PROJECT, ON EXISTING PARCEL 16, INCLUDED THE BUILDING, ASSOCIATED 24-FOOT WIDE PAVED DRIVE WEST OF THE BUILDING, ASSOCIATED PAVED PARKING WEST OF THE BUILDING, PAVED SERVICE YARD SOUTH OF THE BUILDING, RETAINING WALL AT THE EAST PROPERTY LINE, THE CONCRETE/CRUSHER FINE CHANNEL AT THE WEST PROPERTY LINE, AND THE NEW SIDEWALK CULVERTS TO RUTLEDGE ROAD.

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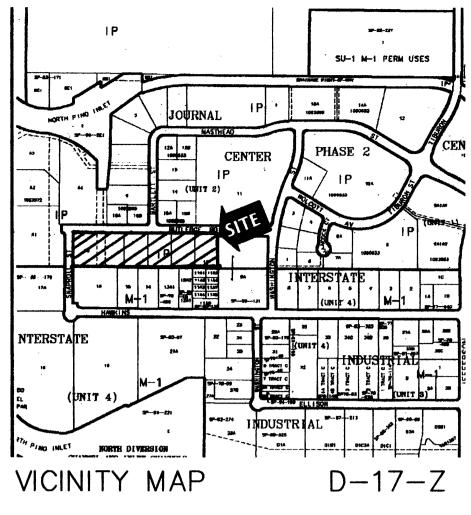
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100-YEAR HYDROLOGIC CALCULATIONS

		L	AND TRE	ATMENT		WEIGHTED					
BASIN	AREA	Α	A B		D	E	V (6-hr)	V (6-hr)	V(24 hour)	V(24 hour)	Q
#	(acre)	(%)	(%)	(%)	(%)	(in)	(acre-ft)	(cu-ft)	(acre-ft)	(cu-ft)	(cfs)
				EXIS1	ING CO	NDITIONS (E	NTIRE LOT)			
BASIN A	0.9099	100.00	0.00	0.00	0.00	0.53	0.04	1,751	0.04	1,751	1.42
BASIN B	2.3104	100.00	0.00	0.00	0.00	0.53	0.10 🗸	4,445	0.10	4,445	3.60
				PROPO	SED CO	ONDITIONS (ENTIRE LO	T)			
BASIN A	0.9099	0.00	0.00	13.90	86.10	1.98	0.15	6,548	0.18	7,685	4.08
BASIN B	2.3104	0.00	0.00	15.20	84.80	1.97	0.38 ~	16,518 ~	0.44	19,363	10.31
EXCESS	PRECIP.	0.53	0.78	1.13	2.12 <	E _i (in)					
PEAK DISC	CHARGE	1.56	2.28 ✓	3.14	4.7	QPi (cfs)					
							•		ZONE =	2/	
WEIGHTED	E (in) = (E	^)(%A) + (Es)(%B) -	+ (Ec)(%C) + (E _D)(⁴	%D)			Pe-HR (in.) =	2.35 🗸	
/6+R (acre-fi) = (WEIGI	HTED EX	AREA)/12						P24+R (in.) =	2.75 🗸	
/10DAY (acre -	ft) = Vehr 1	(AD)(P100	AY - PEHR)	/12					PIODAY (In.) =	3.95 🗸	
) (cfs) = (Q	$a \times A = (C$	beVAel+	(OperVAc)	+ (OppYAr	J				()		



LEGAL DESCRIPTION

LOTS 16-19, JOURNAL CENTER 2 (PHASE I, II, AND ORIGINAL III) LOTS 19 AND 20, JOURNAL CENTER 2 (EXPANDED PHASE III)

 \supset エト шО **ARCHITECT SEAL**



ENGINEER SEAL

ER Ш OURNA SITE GN.
INDUSTRIAL PAN.
LOTS 19 AND 20, JU
ALBUQUERQUE,

REVISIONS

DATE MARCH 30, 2005

APR 0 4 2005

HYDROLOGY SECTION

DRAWING NAME

GRADING PLAN

1" = 30'

SHEET NUMBER

