CITY OF ALBUQUERQ

Planning Department Suzanne Lubar, Director



Mayor Richard J. Berry

February 23, 2017

Fred C. Arfman, P.E. Isaacson & Arfman, PA 128 Monroe St NE Albuquerque, NM 87108

Re:

Elan-Santa Monica Place Senior Assisted Living/Memory Care

6901 San Vicente Ave. NE

Request Permanent C.O. - Accepted

Engineer's Stamp dated: 10-16-15 (D18D054B)

Certification dated: 2-10-17

PO Box 1293

Albuquerque

Dear Mr. Arfman,

Based upon the information provided in your submittal received 2/23/20167, the above referenced

Certification received is acceptable for the release of permanent Certificate of Occupancy by

Hydrology. New Mexico 87103

If you have any questions, you can contact me at 924-3999 or Totten Elliott at 924-3982.

www.cabq.gov

Shahab Biazar, P.E.


Sincerely,

City Engineer, Planning Dept.

Development Review Services

TE/SB

C: email, Cordova, Camille C.; Miranda, Rachel; Sandoval, Darlene M.; Blocker, Lois

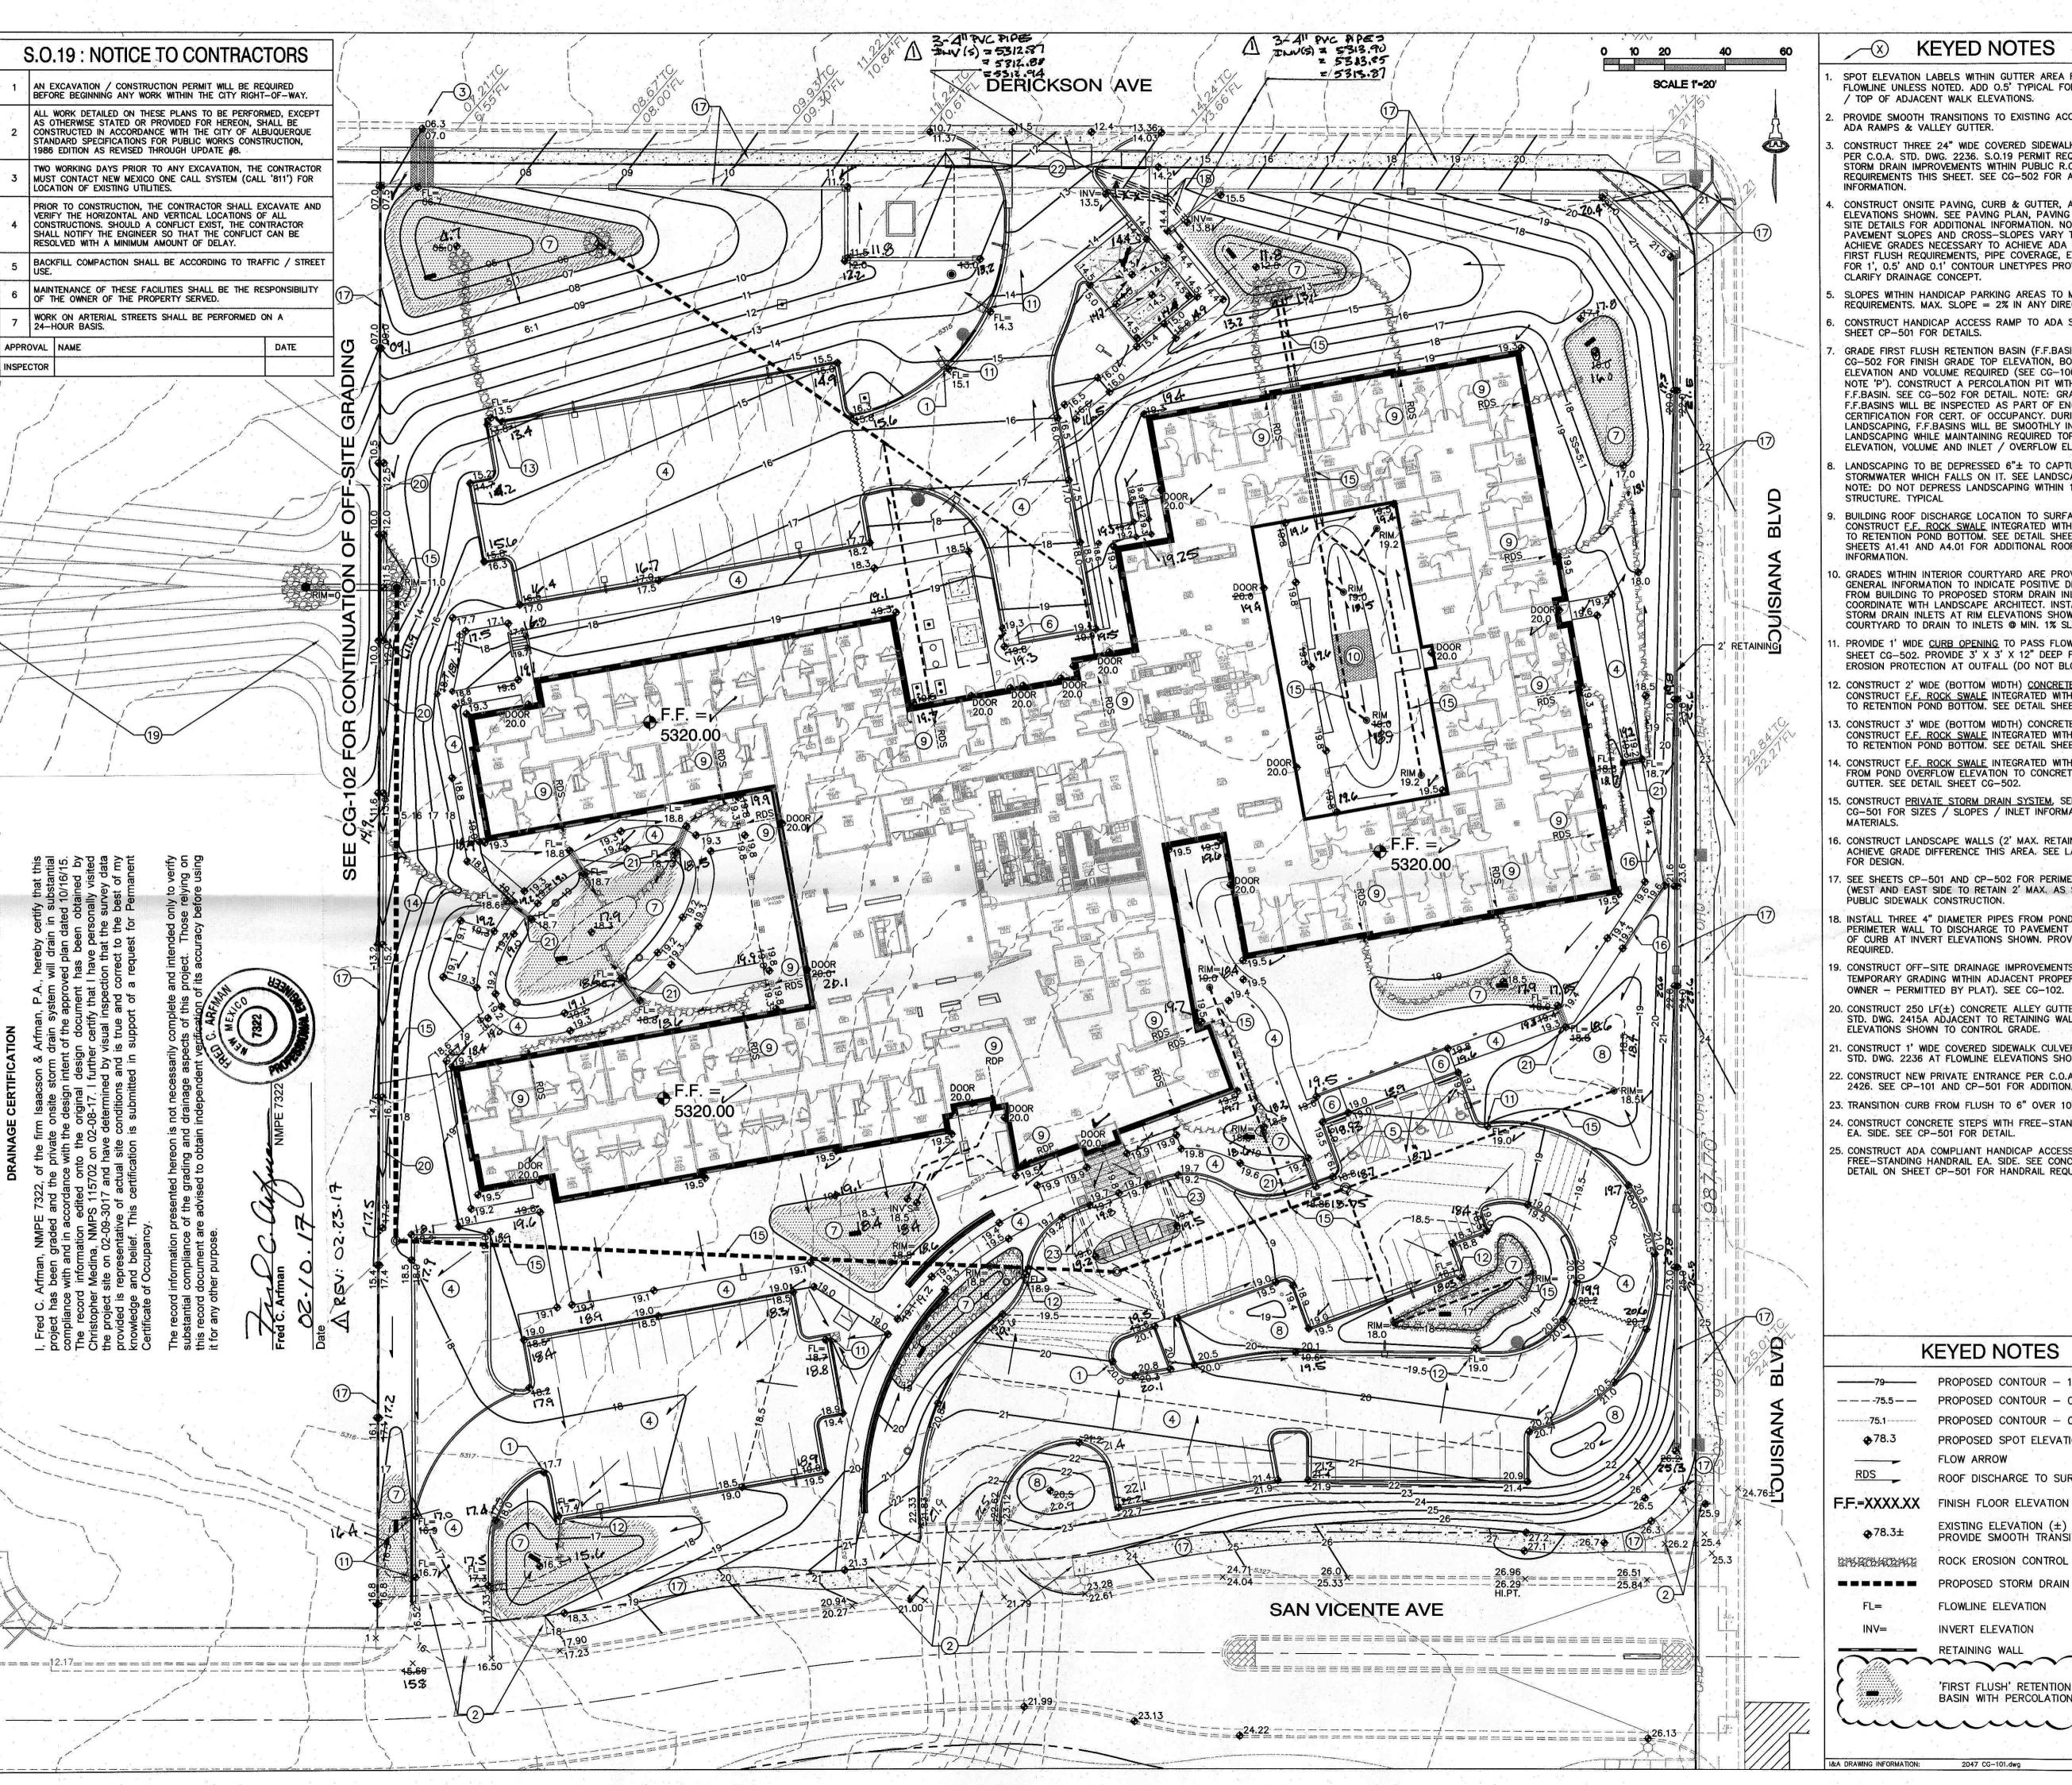



- SPOT ELEVATION LABELS WITHIN GUTTER AREA REPRESENT FLOWLINE UNLESS NOTED. ADD 0.5' TYPICAL FOR TOP OF CURB / TOP OF ADJACENT WALK ELEVATIONS.
- PROVIDE SMOOTH TRANSITIONS TO EXISTING ACCESS DRIVE, ADA RAMPS & VALLEY GUTTER.
- CONSTRUCT THREE 24" WIDE COVERED SIDEWALK CULVERTS
 PER C.O.A. STD. DWG. 2236. S.O.19 PERMIT REQUIRED FOR
 STORM DRAIN IMPROVEMENTS WITHIN PUBLIC R.O.W. SEE S.O.19
 REQUIREMENTS THIS SHEET. SEE CG-502 FOR ADDITIONAL INFORMATION.
- CONSTRUCT ONSITE PAVING, CURB & GUTTER, AND WALKS AT ELEVATIONS SHOWN. SEE PAVING PLAN, PAVING DETAILS AND SITE DETAILS FOR ADDITIONAL INFORMATION. NOTE THAT PAVEMENT SLOPES AND CROSS-SLOPES VARY THROUGHOUT TO ACHIEVE GRADES NECESSARY TO ACHIEVE ADA COMPLIANCE, FIRST FLUSH REQUIREMENTS, PIPE COVERAGE, ETC. SEE LEGEND FOR 1', 0.5' AND 0.1' CONTOUR LINETYPES PROVIDED TO CLARIFY DRAINAGE CONCEPT.
- SLOPES WITHIN HANDICAP PARKING AREAS TO MEET ADA REQUIREMENTS. MAX. SLOPE = 2% IN ANY DIRECTION.
- CONSTRUCT HANDICAP ACCESS RAMP TO ADA STANDARDS. SEE SHEET CP-501 FOR DETAILS.
- GRADE FIRST FLUSH RETENTION BASIN (F.F.BASIN). SEE SHEET CG-502 FOR FINISH GRADE TOP ELEVATION, BOTTOM ELEVATION AND VOLUME REQUIRED (SEE CG-100: GENERAL NOTE 'P'). CONSTRUCT A PERCOLATION PIT WITHIN EACH F.F.BASIN. SEE CG-502 FOR DETAIL. NOTE: GRADING OF F.F.BASINS WILL BE INSPECTED AS PART OF ENGINEER'S CERTIFICATION FOR CERT. OF OCCUPANCY. DURING LANDSCAPING, F.F.BASINS WILL BE SMOOTHLY INTEGRATED INTO LANDSCAPING WHILE MAINTAINING REQUIRED TOP AND BOTTOM ELEVATION, VOLUME AND INLET / OVERFLOW ELEVATIONS.
- LANDSCAPING TO BE DEPRESSED 6"± TO CAPTURE STORMWATER WHICH FALLS ON IT. SEE LANDSCAPE PLAN. NOTE: DO NOT DEPRESS LANDSCAPING WITHIN 10' OF ANY
- BUILDING ROOF DISCHARGE LOCATION TO SURFACE GRADE. CONSTRUCT F.F. ROCK SWALE INTEGRATED WITH LANDSCAPING TO RETENTION POND BOTTOM. SEE DETAIL SHEET CG-502. SEE SHEETS A1.41 AND A4.01 FOR ADDITIONAL ROOF DRAIN
- O. GRADES WITHIN INTERIOR COURTYARD ARE PROVIDED FOR GENERAL INFORMATION TO INDICATE POSITIVE DRAINAGE AWAY FROM BUILDING TO PROPOSED STORM DRAIN INLETS. COORDINATE WITH LANDSCAPE ARCHITECT. INSTALL FOUR STORM DRAIN INLETS AT RIM ELEVATIONS SHOWN. GRADE COURTYARD TO DRAIN TO INLETS @ MIN. 1% SLOPE.
- . PROVIDE 1' WIDE <u>CURB OPENING</u> TO PASS FLOW. SEE DETAIL SHEET CG-502. PROVIDE 3' X 3' X 12" DEEP F.F. ROCK EROSION PROTECTION AT OUTFALL (DO NOT BLOCK FLOWLINE).
- . CONSTRUCT 2' WIDE (BOTTOM WIDTH) CONCRETE RUNDOWN. CONSTRUCT F.F. ROCK SWALE INTEGRATED WITH LANDSCAPING TO RETENTION POND BOTTOM. SEE DETAIL SHEET CG-502.
- 3. CONSTRUCT 3' WIDE (BOTTOM WIDTH) CONCRETE RUNDOWN. CONSTRUCT F.F. ROCK SWALE INTEGRATED WITH LANDSCAPING TO RETENTION POND BOTTOM. SEE DETAIL SHEET CG-502.
- 4. CONSTRUCT F.F. ROCK SWALE INTEGRATED WITH LANDSCAPING FROM POND OVERFLOW ELEVATION TO CONCRETE ALLEY GUTTER. SEE DETAIL SHEET CG-502.
- 15. CONSTRUCT PRIVATE STORM DRAIN SYSTEM, SEE SHEET CG-501 FOR SIZES / SLOPES / INLET INFORMATION /
- 16. CONSTRUCT LANDSCAPE WALLS (2' MAX. RETAINING WALL) TO ACHIEVE GRADE DIFFERENCE THIS AREA. SEE LANDSCAPE PLAN
- . SEE SHEETS CP-501 AND CP-502 FOR PERIMETER WALL (WEST AND EAST SIDE TO RETAIN 2' MAX. AS SHOWN) AND PUBLIC SIDEWALK CONSTRUCTION.
- 18. INSTALL THREE 4" DIAMETER PIPES FROM POND THROUGH OF CURB AT INVERT ELEVATIONS SHOWN. PROVIDE FITTINGS AS
- 9. CONSTRUCT OFF-SITE DRAINAGE IMPROVEMENTS AND TEMPORARY GRADING WITHIN ADJACENT PROPERTY (SAME
- OWNER PERMITTED BY PLAT). SEE CG-102. 20. CONSTRUCT 250 LF(±) CONCRETE ALLEY GUTTER PER C.O.A. STD. DWG. 2415A ADJACENT TO RETAINING WALL AT FLOWLINE
- ELEVATIONS SHOWN TO CONTROL GRADE.
- 1. CONSTRUCT 1' WIDE COVERED SIDEWALK CULVERT PER C.O.A. STD. DWG. 2236 AT FLOWLINE ELEVATIONS SHOWN.
- 22. CONSTRUCT NEW PRIVATE ENTRANCE PER C.O.A. STD. DWG. 2426. SEE CP-101 AND CP-501 FOR ADDITIONAL INFORMATION. 23. TRANSITION CURB FROM FLUSH TO 6" OVER 10'.
- 24. CONSTRUCT CONCRETE STEPS WITH FREE-STANDING HANDRAIL EA. SIDE. SEE CP-501 FOR DETAIL.
- 25. CONSTRUCT ADA COMPLIANT HANDICAP ACCESS RAMP WITH FREE-STANDING HANDRAIL EA. SIDE. SEE CONCRETE STEP DETAIL ON SHEET CP-501 FOR HANDRAIL REQUIREMENTS.

KEYED NOTES

FLOW ARROW

PROPOSED CONTOUR - 1' INCREMENT PROPOSED CONTOUR - 0.5' INCREMENT

PROPOSED CONTOUR - 0.1' INCREMENT

PROPOSED SPOT ELEVATION

ROOF DISCHARGE TO SURFACE

EXISTING ELEVATION (±) TO MATCH. PROVIDE SMOOTH TRANSITION.

FINISH FLOOR ELEVATION



Monica Place 6901 San Vicente Ave. NE

Albuquerque, NM 87109



TITAN SENIOR LIVING 6300 Riverside Plaza Ln. NW #200 Albuquerque, New Mexico 87120

DEVELOPMENT CONSULTANT:




Suite 400 Charlotte NC 28210

DESIGN TEAM:



D2 Architecture, L.L.C. 2001 North Lamar Street, Suite 300 Dallas, Texas 75202 www.d2-architecture.com

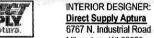

STRUCTURAL ENGINEERING

Hart, Gaugler & Associates 12801 N. Central Expressway


MEP ENGINEERING

3535 Travis Street, Suite 115

CIVIL ENGINEERING: Isaacson & Arfman, P.A. 128 Monroe Street NE

LANDSCAPE ARCHITECT Hilltop Landscape Architects 7909 Edith NE Albuquerque, NM 87184

FOOD SERVICES DESIGNER:

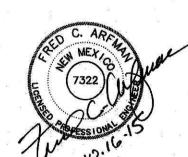

10.16.15	
1.	h 10.,
Date	Revisions
	NOT USED THIS SHEET
12/24/2015	NOT USED THIS SHEET PER COA HYDROLOGY CO
-11	
	A CONTRACTOR OF THE PARTY OF TH
- 1 - 1 - 1 - 1 - 1 - 1 - 1 - 1 - 1 - 1	
	4
<u> </u>	
	4
	S. Charles
2000	
	The second secon

D2 Project No: CONSTRUCTION DOCUMENTS Sheet Issue Date: 01/06/16 As indicated

Dwg. Name: **GRADING AND** DRAINAGE PLAN

CG-101

9/2/2015 5:50:23 PM

PROPOSED STORM DRAIN (SEE CG5.1) FLOWLINE ELEVATION INVERT ELEVATION RETAINING WALL 'FIRST FLUSH' RETENTION BASIN WITH PERCOLATION PIT



STORM DRAIN SYSTEM WILL REQUIRE REGULAR MAINTENANCE

TO ENSURE PROPER FUNCTIONING DURING STORM EVENTS.

ENGINEER RECOMMENDS THAT OWNER PUT IN PLACE INSPECTION AND MAINTENANCE REQUIREMENTS SCHEDULED TO OCCUR MONTHLY AND AFTER EACH STORM EVENT.

STORM DRAIN GENERAL NOTES

ELAN Élan-Santa

6901 San Vicente Ave. NE Albuquerque, NM 87109

TITAN SENIOR LIVING 6300 Riverside Plaza Ln. NW #200 Albuquerque, New Mexico 87120

DEVELOPMENT CONSULTANT:





D2 Architecture, L.L.C. 2001 North Lamar Street, Suite 300 Dallas, Texas 75202

> STRUCTURAL ENGINEERING: Hart, Gaugler & Associates 12801 N. Central Expressway

INTERIOR DESIGNER:

MEP ENGINEERING: Tellos 3535 Travis Street, Suite 115

CIVIL ENGINEERING: Isaacson & Arfman, P.A. 128 Monroe Street NE

LANDSCAPE ARCHITECT: Hilltop Landscape Architects 7909 Edith NE Albuquerque, NM 87184

FOOD SERVICES DESIGNER:

Direct Supply Aptura 6767 N. Industrial Road



Date 1 11/11/2015 BID CLARIFICATIONS

CONSTRUCTION DOCUMENTS Sheet Issue Date: 11/20/15

As indicated Dwg. Name:

STORM DRAIN **DETAILS**

CG-501

9/2/2015 5:50:23 PM

I&A DRAWING INFORMATION: 2047 CG-501.dwg

MH# MANHOLES SHALL BE CONSTRUCTED WITH:

• ADS NYLOPLAST BASIN (*)

LOCKING GRATE (*)
8" WIDE X 6" DEEP CONCRETE COLLAR

STORM DRAIN STRUCTURES

(*SEE INDIVIDUAL BASIN DESIGNS THIS SHEET)

• 2' SUMP

ADS NYLOPLAST BASIN MANHOLES

GENERAL DESIGN INFORMATION

Nov 12,2015

SCALE: N.T.S.