

XXXX PALOMAS AVENUE NE

LEGAL DESCRIPTION

LOT X-1-A OF LOTS 1 THRU 5 BLOCK 22, TRACT A, UNIT A, NORTH ALBUQUERQUE ACRES

BENCHMARK

<u>ADDRESS</u>

ACS BRASSCAP "HEAVEN", LOCATED ON THE SOUTH SIDE OF PASEO DEL NORTE, 800' WEST OF WYOMING BLVD. ELEVATION = 5378.79

**LEGEND** 

EXISTING SPOT ELEVATION

• 36.20 NEW SPOT ELEVATION

-----36 ----EXISTING CONTOUR

-----35 -----NEW CONTOUR

VERIFIED ELEVATION

-36.2 AS-BUILT ELEVATION

- BASIN BOUNDARY

### GRADING AND DRAINAGE PLAN FOR TRACT X-1-A

#### DRAINAGE PLAN

THE FOLLOWING ITEMS CONCERNING THE TRACT X-1-A GRADING AND DRAINAGE PLAN ARE CONTAINED HEREON:

- 1. VICINITY MAP
- 2. GRADING PLAN 3. CALCULATIONS

THE PROPOSED IMPROVEMENTS, AS SHOWN BY THE VICINITY MAP, ARE LOCATED AT THE SOUTHEAST CORNER OF THE INTERSECTION OF PALOMAS AVENUE NE AND WYOMING BLVD. NE. THE SITE IS UNDEVELOPED AND SLOPES FROM EAST TO WEST. THE SITE DOES NOT LIE WITHIN A FLOOD HAZARD ZONE. THE SITE IS HIGHER THAN THE LAND TO THE SOUTH AND THE STREETS TO THE NORTH AND WEST. THE SITE IS LOWER THAN THE LAND TO THE EAST, BUT A BLOCK WALL RUNOFF FROM ENTERING THE SITE. THEREFORE, OFFSITE FLOWS ARE NEGLIGIBLE.

THE SITE IS THE NORTHERN 2 ACRES OF A 5 ACRE PARCEL ZONED SU-1. THE GRADING PLAN FOR THE SOUTHERN 3 ACRES IS BEING SUBMITTED CONCURRENTLY WITH THIS PLAN BY CHAVES & GRIEVES. A DRAINAGE PLAN WAS APPROVED FOR THIS SITE IN 1998. THE APPROVED PLAN REQUIRED THAT ALL RUNOFF BE CONVEYED TO THE DOMINGO BACA CHANNEL WITHOUT DETAINING ANY OF THE FLOW. TRACTS X-1-A AND X-1-B WILL UTILIZE THE SAME CONCEPT AS OUTLINED IN THE APPROVED PLAN.

THE GRADING PLAN SHOWS 1) EXISTING AND PROPOSED GRADES, INDICATED BY SPOT ELEVATIONS, AND CONTOURS AT 1'-0" INTERVALS, 2) CONTINUITY BETWEEN EXISTING AND PROPOSED ELEVATIONS, 3) THE LIMIT AND CHARACTER OF THE EXISTING IMPROVEMENTS AND 4) THE LIMIT AND CHARACTER OF THE PROPOSED IMPROVEMENTS. THE PROPOSED IMPROVEMENTS CONSIST OF AN OFFICE BUILDING WITH ASSOCIATED PARKING AND LANDSCAPING. THE SITE WILL BE GRADED TO CONVEY THE RUNOFF TO INLETS AT THE WEST EDGE OF THE PARKING AREAS. THE FLOW FROM THE INLETS WILL BE CONVEYED TO AN EXISTING 18" STORM DRAIN AT THE SOUTHWEST CORNER OF THE SITE. THE 18" WILL CONVEY THE FLOW TO THE DOMINGO BACA CHANNEL.

THE CALCULATIONS, WHICH APPEAR BELOW, ANALYZE THE EXISTING AND PROPOSED CONDITIONS FOR THE 6-HOUR, 100-YEAR RAINFALL EVENT. THE ANALYSIS IS IN ACCORDANCE WITH THE CITY OF ALBUQUERQUE DEVELOPMENT PROCESS MANUAL, VOLUME II. AS SHOWN BY THESE CALCULATIONS, THE RATE OF RUNOFF AND THE VOLUME OF RUNOFF WILL INCREASE. THIS PLAN IS IN ACCORDANCE WITH THE PREVIOUSLY APPROVED DRAINAGE PLAN.

#### CALCULATIONS

PRECIPITATION ZONE = 3 AREA = 2.00 ACRES
EXISTING CONDITIONS
LAND TREATMENT B=100%

LAND TREATMENT B=100%

E = 0.92\*1.00 = 0.92 INCHES

V = 0.92\*2.00/12 = 0.15 ACRE FEET

Q = 2.60\*1.00\*2.00 = 5.20 CFS

DEVELOPED CONDITIONS

LAND TREATMENT B=57% D=43%


E = 0.92\*0.57+2.36\*0.43 = 1.54 INCHES

V =1.54\*2.00/12 = 0.26 ACRE FEET

Q = (2.60\*0.57+5.02\*0.43)2.00 = 7.28 CFS

INCREASE IN RATE OF RUNOFF = 7.28-5.20 = 2.08 CFS

INCREASE IN VOLUME OF RUNOFF = 0.26-0.15 = 0.11 ACRE INCREASE IN VOLUME OF RUNOFF = 0.26-0.15 = 0.11 ACRE FEET

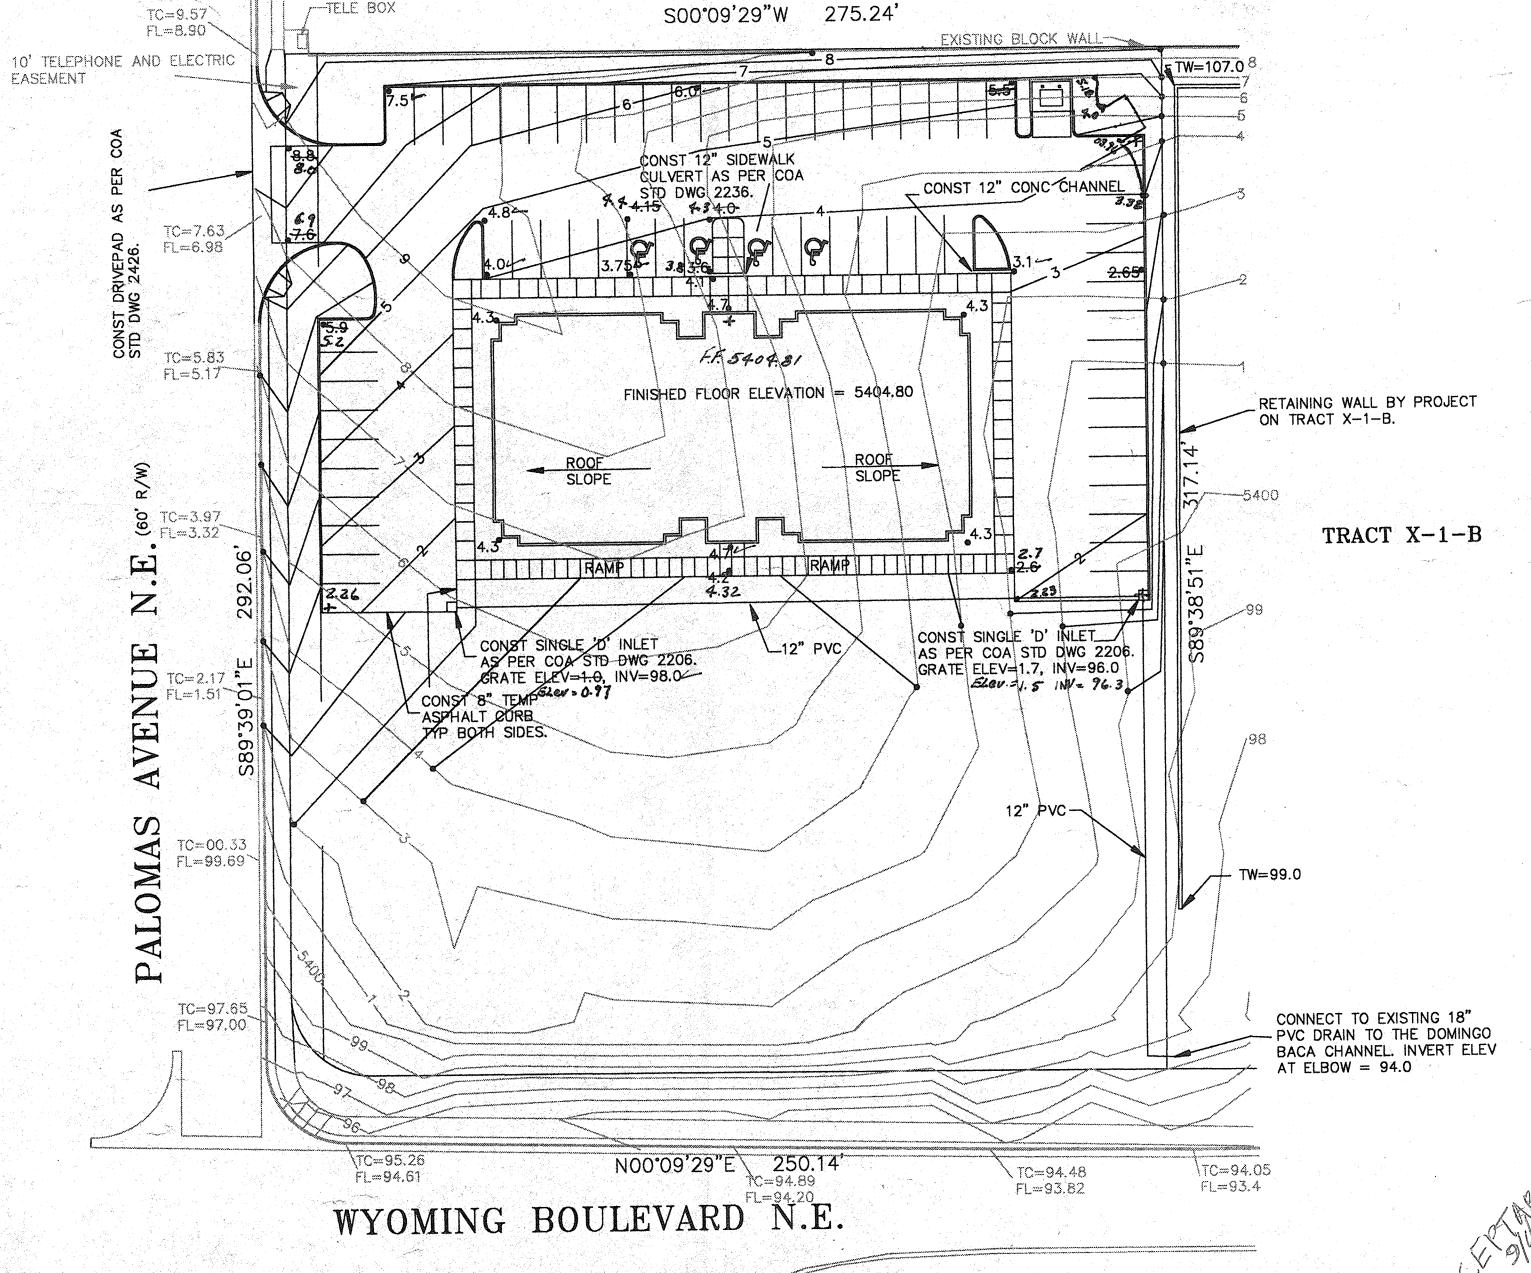

COUNTRYWOOD SUBDIVISION

- BLOCK WALL


SEP 01 1999 THIS PROJECT WAS CONSTRUCTED IN SUBSTANTIAL COMPLIANCE WITH THE APPROJED OF AMAGE PLAN. HYDROLOGY SECTION


8.23.99

DRAWING SCALE: 1" = 30'

Engineering & Surveying Associates, Inc.

SHEET NO.

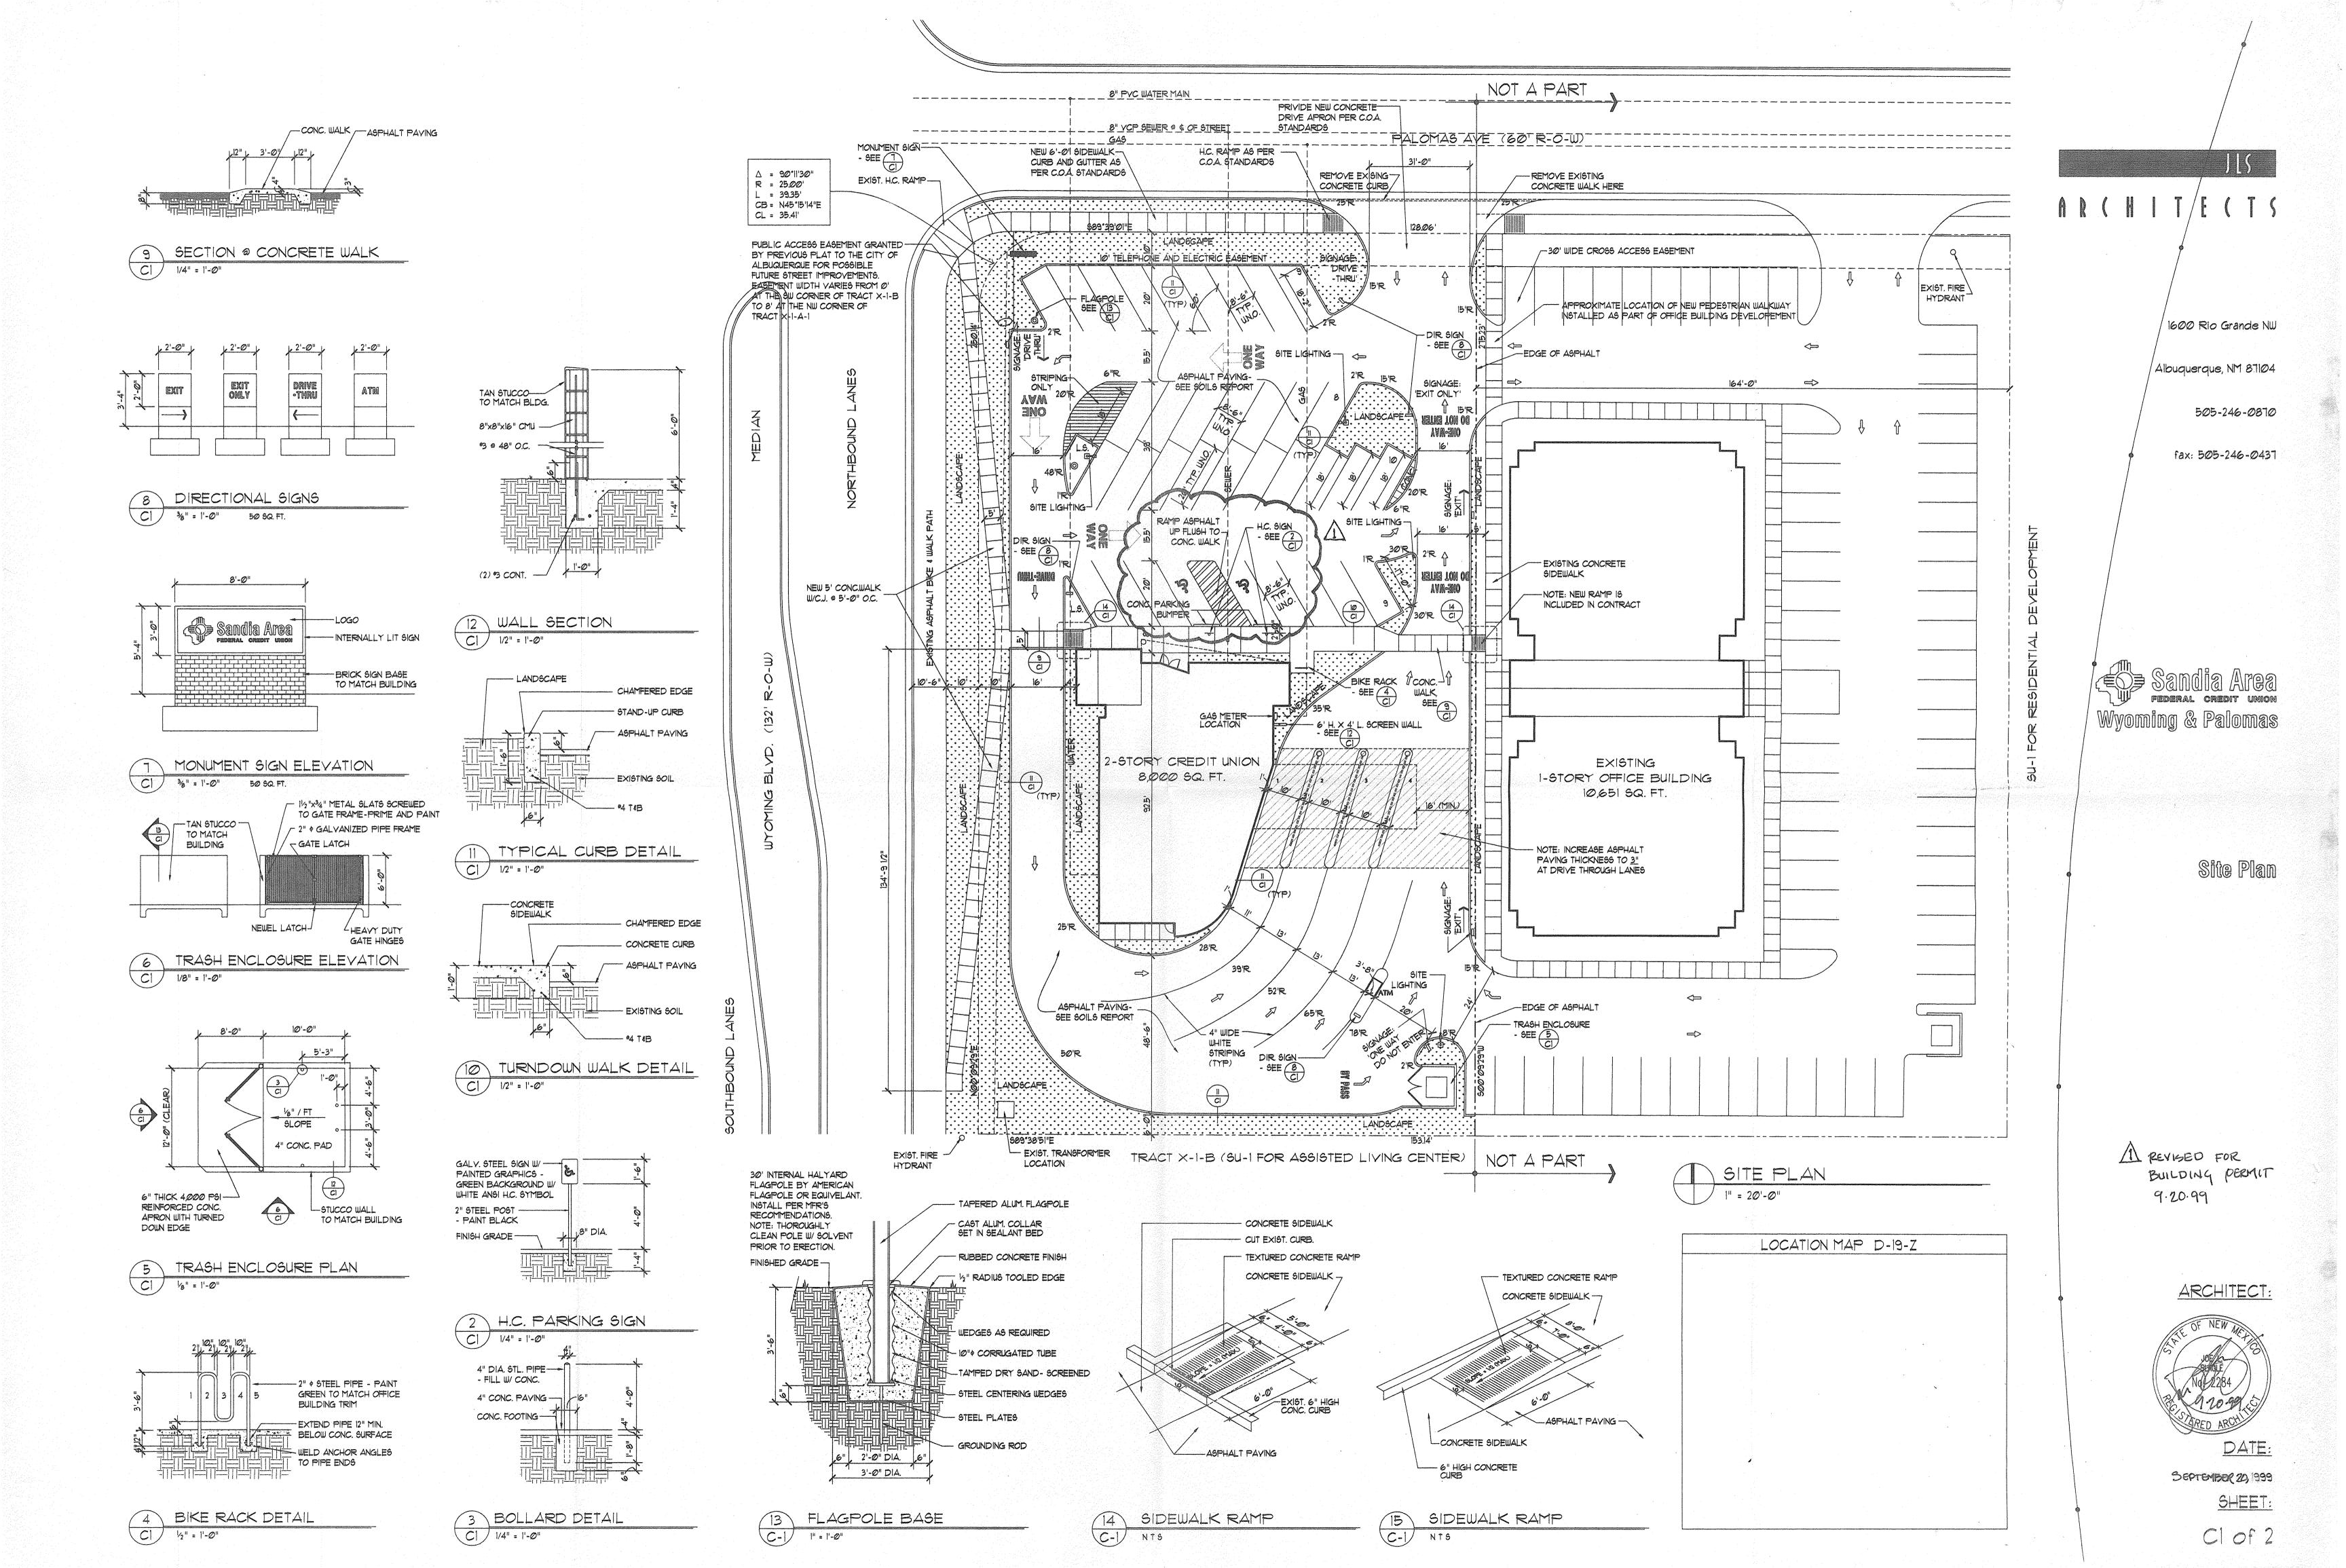

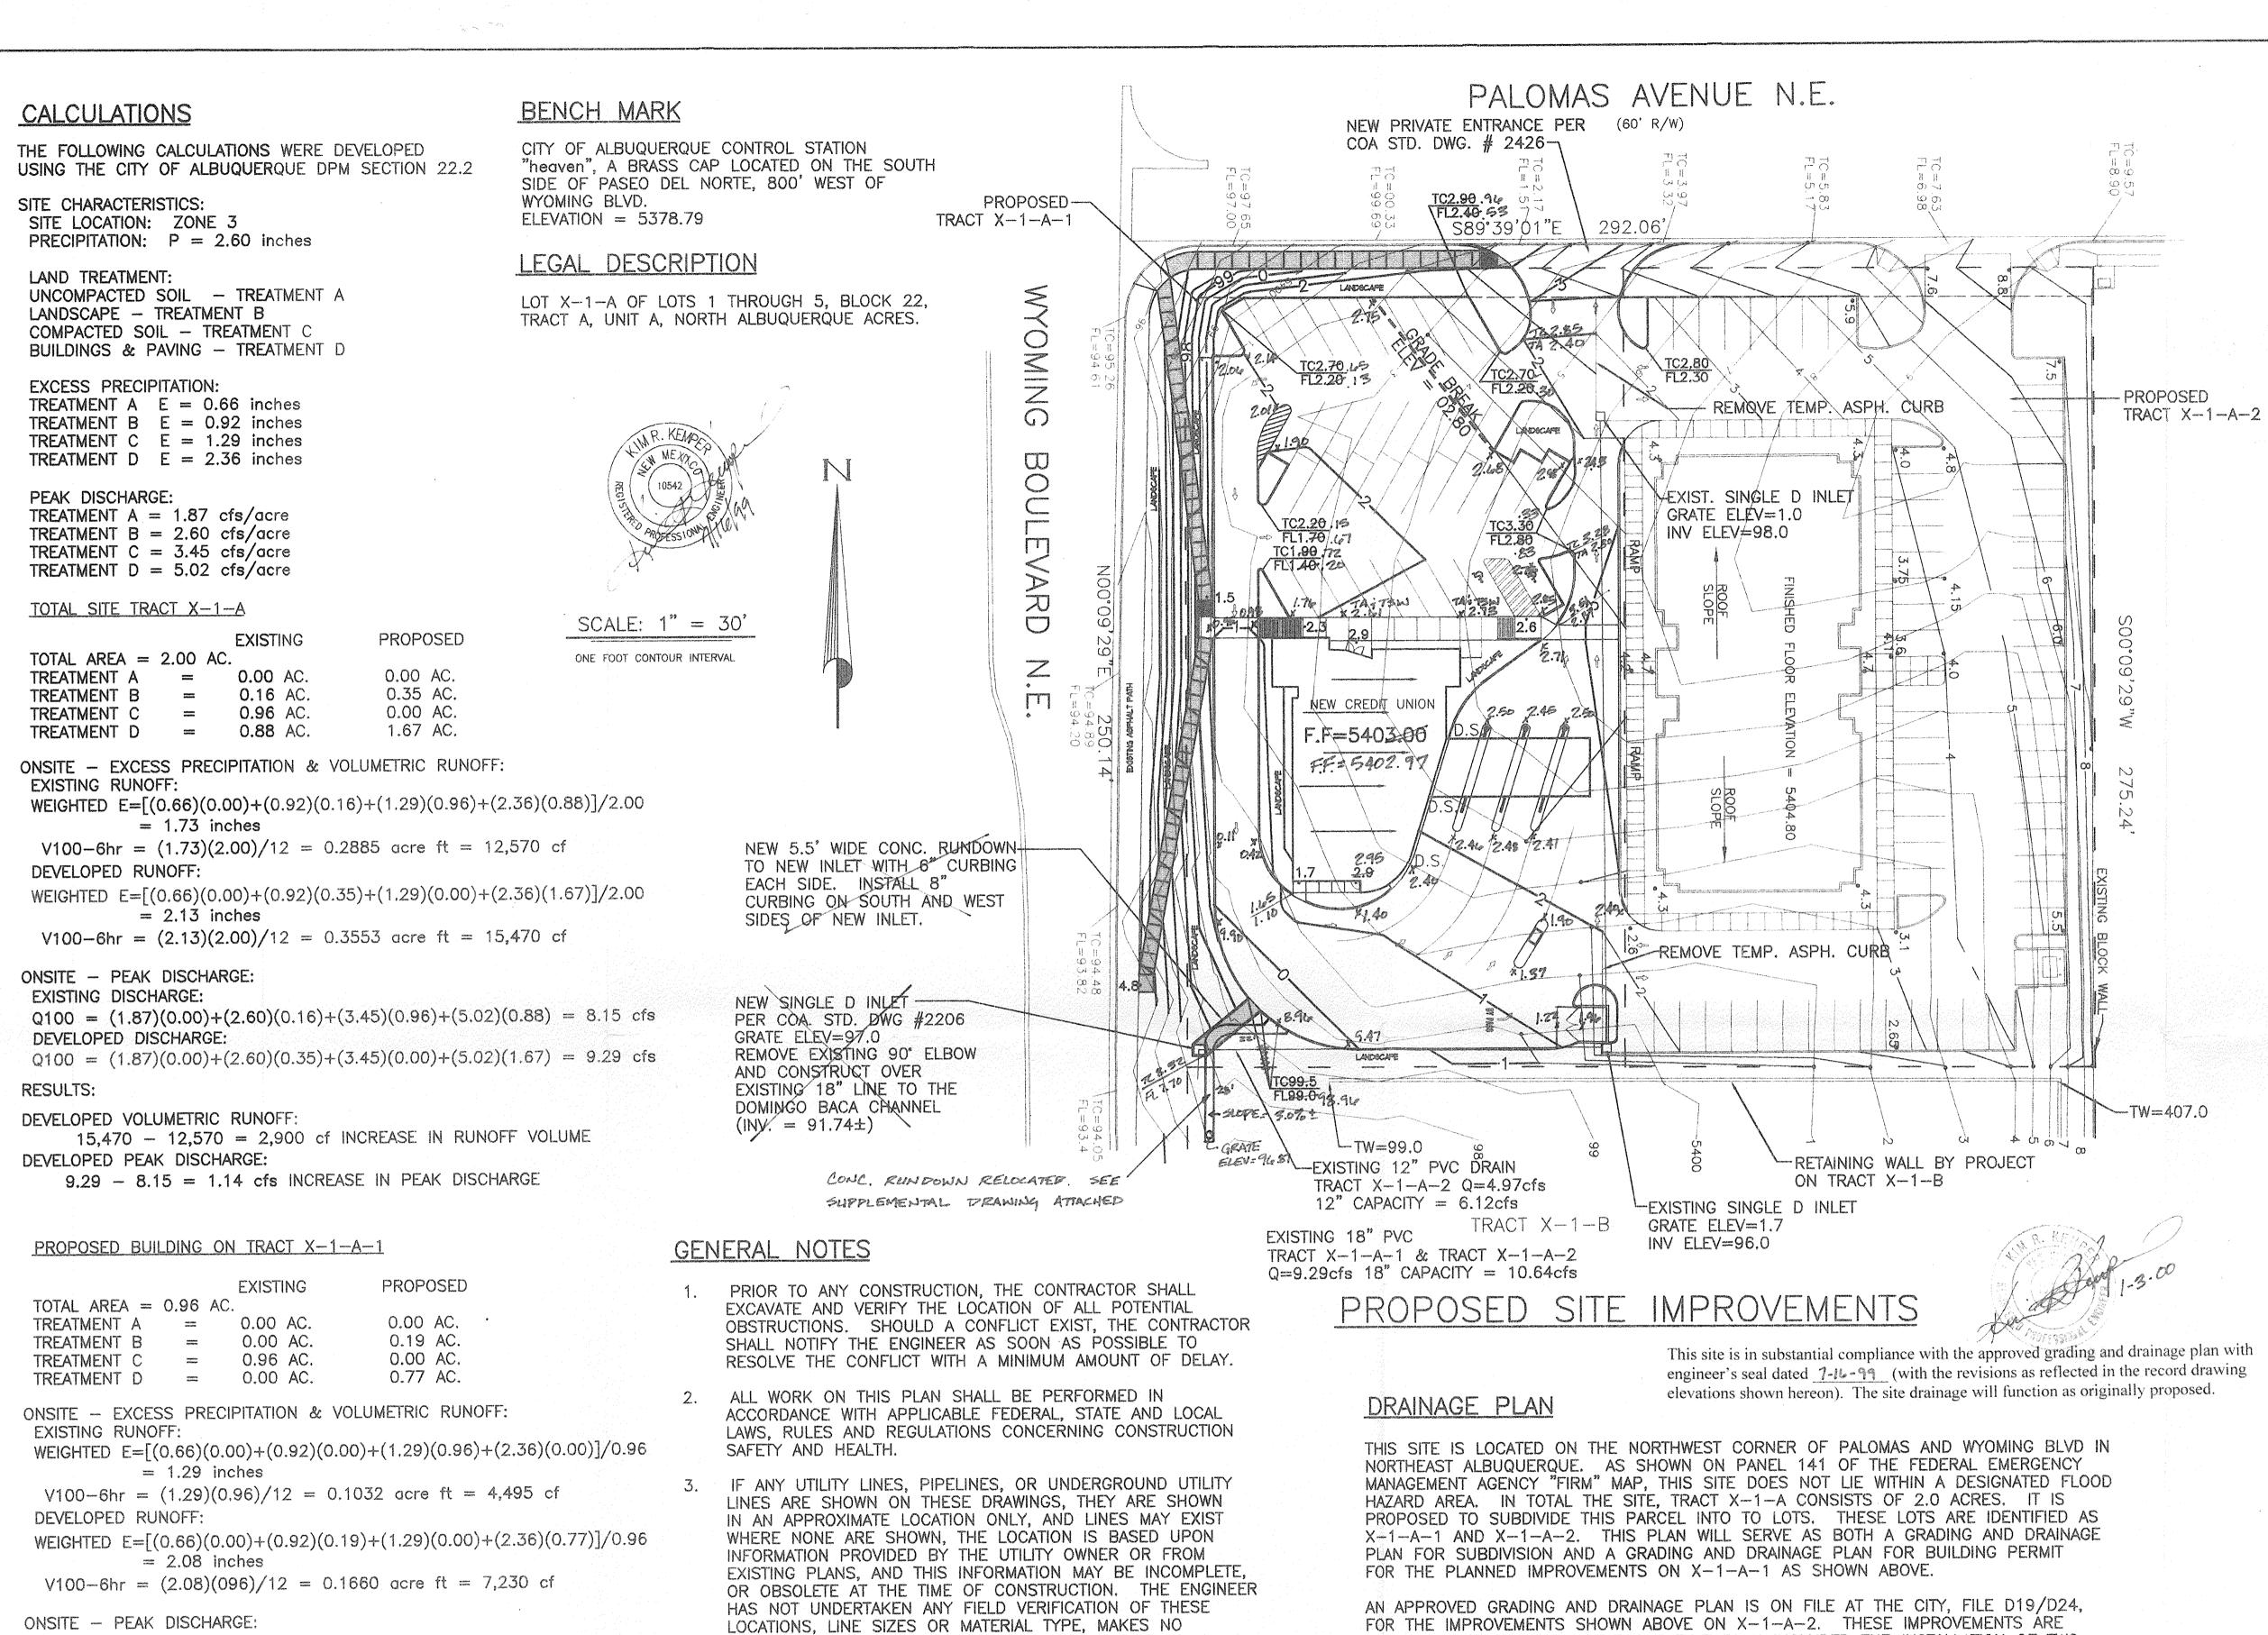

This site is in substantial compliance with the approved grading and drainage plan with engineer's seal dated 7-16-99 (with the revisions as reflected in the record drawing elevations shown hereon). The site drainage will function as originally proposed.

FOR THE IMPROVEMENTS SHOWN ABOVE ON X-1-A-2. THESE IMPROVEMENTS ARE CURRENTLY UNDER CONSTRUCTION. THAT PLAN INCLUDED THE INSTALLATION OF TWO NEW SINGLE D INLETS AND A STORM DRAIN CONNECTION TO THE DOMINGO BACA CHANNEL "CROSS LOT" DRAINAGE EASEMENTS ARE TO BE PROVIDED ON THE PLAT IN ORDER FOR BOTH PARCELS TO UTILIZE THESE IMPROVEMENTS. IN ACCORDANCE WITH PREVIOUSLY APPROVED PLANS FOR THIS SITE, ALL STORM WATERS WILL BE CONVEYED TO THE DOMINGO BACA CHANNEL. ALL THE IMPROVEMENTS CURRENTLY UNDERWAY ON THE PROPOSED X-1-A-2 ARE IDENTIFIED AS "EXISTING" ON THIS PLAN. FURTHER, THE TOPOGRAPHY SHOWN INCLUDES THE EXISTING CONTOURS PRIOR TO AND CONSTRUCTION ACTIVITIES. THE PROPOSED CONTOURS AS SHOWN ON THE APPROVED PLAN FOR X-1-A-2, (FILE D19/D24) AND THE PROPOSED CONTOURS FOR THE PLANNED IMPROVEMENTS ON

TWO SETS OF CALCULATIONS ARE PROVIDED HEREON, ALL IN ACCORDANCE WITH THE CITY'S DPM SECTION 22.2. THE FIRST SET OF CALCULATIONS INCLUDE THE ENTIRE TRACT X-1-A. (INCLUSIVE OF BOTH PROPOSED LOTS). THE SECOND SET OF CALCULATIONS REFLECT BOTH EXISTING AND PROPOSED CONDITIONS ON X-1-A-1 WHERE THE SUBJECT IMPROVEMENTS ARE PROPOSED.

ALL THE SURVEY INFORMATION SHOWN WAS PROVIDED BY ENGINEERING AND SURVEYING ASSOCIATES, AND AS STATED ABOVE GRADING ON THIS SITE IS CURRENTLY UNDERWAY.

GENERAL LEGEND

ZONE MAP

LOCATION MAP

AVIATION

EROCK MENONSHIP STORMER STORME	
EXISTING CONTOUR	96
PROPOSED CONTOUR (X-1-A-	-1)
PROPOSED CONTOUR (X1-A	1-2)
PROPOSED SPOT ELEVATION	56.4
FLOWLINE	
FLOW DIRECTION ARROW	
PROPOSED CONCRETE	
TOP OF CURB ELEVATION	TC
TOP OF WALL ELEVATION	TW
FLOWLINE ELEVATION	FL
TOP OF ASPHALT	TA
POWER POLE	PP
ROOF DRAIN/DOWN SPOUT	D.S.
RECORD DRAWING ELEV.	x 98.94

PROJECT LOCATION

D - 19

#### SANDIA CREDIT UNION GRADING AND DRAINAGE PLAN

# KEMPER-VAUGHAN

CONSULTING ENGINEERS

			COMOCLING	Inn 1 V W 11 V from East 1	S arms	
3700	COORS RD.	N.W. ·	ALBUQUERQUE,	NEW MEXICO	87120 •	(505) 831-452
romation to respect to the company of the	ed KRK	Drawn		hecked KRK		
File	PALOMA	S G&D	Date <sub>JULY</sub>	1999	ported to the state of the stat	V

ONSITE - PEAK DISCHARGE:

**EXISTING DISCHARGE:** 

Q100 = (1.87)(0.00) + (2.60)(0.00) + (3.45)(0.96) + (5.02)(0.00) = 3.31 cfs**DEVELOPED DISCHARGE:** 

Q100 = (1.87)(0.00) + (2.60)(0.19) + (3.45)(0.00) + (5.02)(0.77) = 4.36 cfs

**RESULTS:** 

DEVELOPED VOLUMETRIC RUNOFF:

7,230 - 4,495 = 2,735 cf INCREASE IN RUNOFF VOLUME DEVELOPED PEAK DISCHARGE:

4.36 - 3.31 = 1.05 cfs INCREASE IN PEAK DISCHARGE

TOTAL DISCHARGE FROM TRACT X-1-A-1 & X-1-A-2 = 9.29cfs CAPACITY OF EXISTING 18" SD = 10.67cfs TOTAL DISCHARGE FROM TRACT X-1-B = 13.4cfs THEREFORE THE TOTAL FLOW TO THE DOMINGO BACA CHANNEL = 22.69cfs CAPACITY OF EXISTING  $24^{\circ}$  SD = 22.67cfs

FULLY RESPONSIBLE FOR ANY AND ALL DAMAGES CAUSED BY ITS FAILURE TO LOCATE, IDENTIFY AND PRESERVE ANY AND ALL EXISTING UTILITIES, PIPELINES AND UNDERGROUND FACILITIES IN PLANNING AND CONDUCTING EXCAVATIONS, THE CONTRACTOR SHALL COMPLY WITH ALL STATE STATUTES, MUNICIPAL AND LOCAL ORDINANCES. RULES AND REGULATIONS, IF ANY, PERTAINING TO THE LOCATION OF THESE LINES AND FACILITIES. THE CONTRACTOR SHALL INSURE THAT NO SOIL ERODES FROM

REPRESENTATION THERETO, AND ASSUMES NO RESPONSIBILITY

UNDERGROUND INSTALLATION IN OR NEAR THE AREA IN ADVANCE

OF AND DURING ANY EXCAVATION WORK. THE CONTRACTOR IS

OR LIABILITY THEREFOR. THE CONTRACTOR SHALL INFORM

ITSELF OF THE LOCATION OF ANY UTILITY LINE, PIPELINE OR

PROPERTY. THIS CAN BE ACHIEVED BY CONSTRUCTING TEMPORARY BERMS AND BY WETTING THE SOIL TO KEEP IT FROM BLOWING.

THE SITE INTO PUBLIC RIGHTS-OF-WAY OR ONTO PRIVATE

THE CONTRACTOR SHALL OBTAIN ANY AND ALL PERMITS REQUIRED BY THE CITY OF ALB. FOR THE COMPLETION OF THE WORK PRIOR TO BEGINNING CONSTRUCTION.

## SANDIA CREDIT UNION SUPPLEMENTAL DRAWING ORIGINAL PLAN ENGINEER'S SEAL DATED 7-16-99

1-13-1-12

