CITY OF ALBUQUERQUE



January 10, 2020

Jarrod Cline arcLINE Architectural design LLC PO Box 91462 Albuquerque, NM

Re: Palomas Peak

8310 Palomas Ave 87109 Traffic Circulation Layout

Engineer's/Architect's Stamp 11-01-2019 (D19D031)


Dear Mr. Cline,

Based upon the information provided in your submittal received 01-09-2020, the above referenced plan cannot be approved for Building Permit until the following comments are addressed:

- 1. I am attaching the on-street requirements in terms of dimension.
- Please list the width and length for all proposed parking spaces. Some dimensions are not shown.

PO Box 1293

Figure 3.8-2 Parallel Parking Dimensions

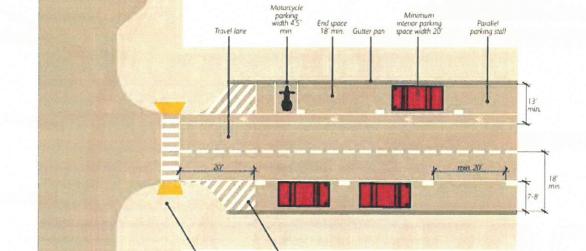

Albuquerque

NM 87103

www.cabq.gov

- 2. The gutter pan may be used as part of the stall width.
- 3. Where parallel on-street parking is adjacent to a bicycle lane (and there is insufficient space for reverse angle parking), the minimum combined width for the bike lane and the parallel parking stall is 13' (with a recommended 7'-wide parallel parking stall and a 6'-wide bike lane).
- 4. The combined width of a parallel on-street parking stall and the adjacent travel lane should be a minimum of 18'.
- A 1.5' shy zone space or offset shall be provided between the curb edge and any vertical elements in the landscape/buffer zone.
- Individual stalls may be marked to increase the parking capacity. The minimum stall length for interior spaces shall be 20', and all end spaces shall be a minimum 18' long. See Figure 3.8-2.
- Per MUTCD, there shall be a 20' long space between the crosswalk or pedestrian crossing and the nearest on-street parking space. A curb extension may be used within that 20' area.
- 1. The Traffic Circulation Layout
- 2. A Drainage Transportation Information Sheet (DTIS)
- 3. Send an electronic copy of your submittal to PLNDRS@cabq.gov.
- 4. No Fee!

for log in and evaluation by Transportation.

If you have any questions, please contact me at (505) 924-3675.

Sincerely,


Mojgan Maadandar, E.I.

Associate Engineer, Planning Dept.

Development Review Services

\MM via: email

C: CO Clerk, File

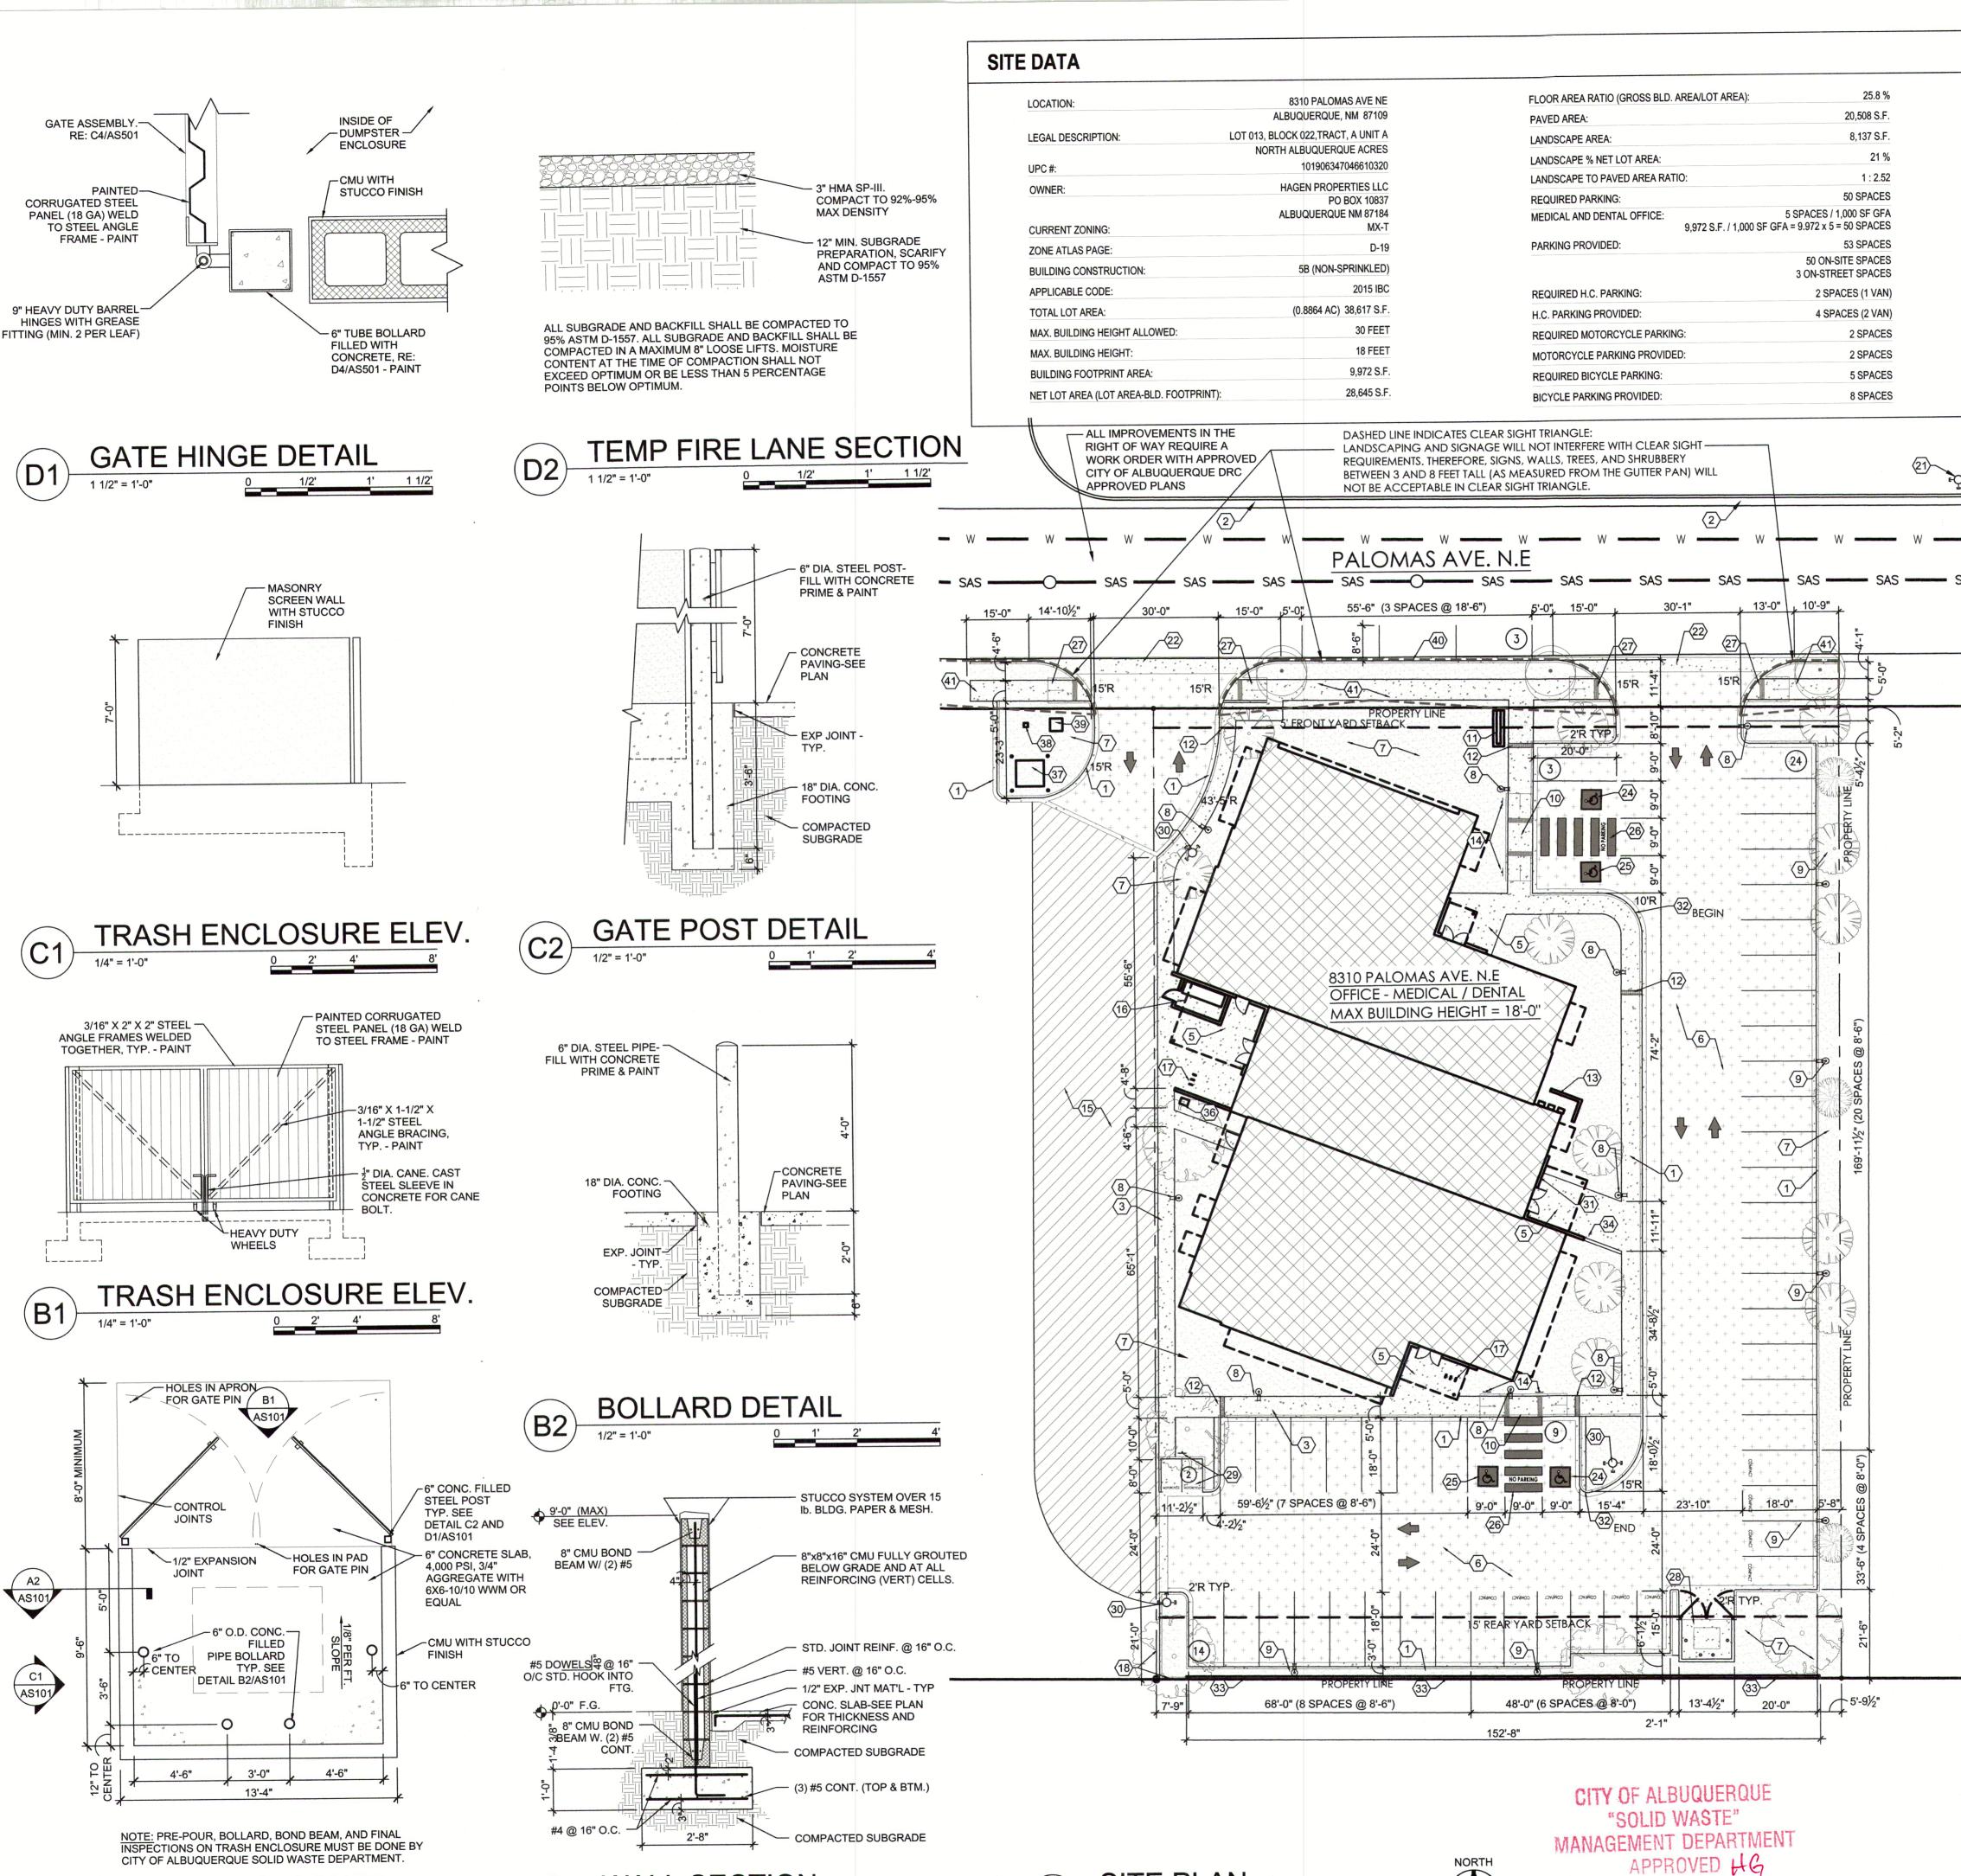

SITE PLAN

WALL SECTION

1/2" = 1'-0"

TRASH ENCLOSURE

GENERAL SHEET NOTES

A. VERIFY SITE UTILITY ROUTING AND NEW UTILITY CONNECTIONS WITH UTILITY

B. CURBS DIMENSIONED TO FACE OF CURB U.N.O.

C. PATCH AND REPAIR OR REPLACE EXISTING CURB & GUTTER ALONG STREET FRONTAGES AS NECESSARY IN COORDINATION WITH DRIVEWAY CONSTRUCTION. VERIFY ALL NEW DRIVEWAY REQUIREMENTS WITH CITY OF ALBUQUERQUE

STANDARDS. SITE LIGHTING LIGHTING PROVIDED ON BUILDING FACADES AND IN THE PARKING LOT TO BE

CUT-OFF TYPE ANGLED TO BE NON-INTRUSIVE TO ADJACENT PROPERTIES AND RIGHT-OF-WAYS. SEE GEO-TECHNICAL REPORT FOR SUB-GRADE PREP REQUIREMENTS OF THE

BUILDING AND PARKING LOT.

G. ALL IMPROVEMENTS IN THE RIGHT OF WAY REQUIRE A WORK ORDER WITH APPROVED CITY OF ALBUQUERQUE DRC APPROVED PLANS.

KEYED NOTES

CONCRETE CURB AND GUTTER, RE: D1/AS102. EXISTING CURB & GUTTER (WHERE OCCURS) TO REMAIN.

CONCRETE SIDEWALK PER DETAIL D2/AS102.

EXISTING CONCRETE SIDEWALK TO REMAIN. 5. 4" THICK CONCRETE FLAT WORK, JOINTED AS SHOWN, WITH TURN DOWN EDGE. RE: C1/AS102

ASPHALT PAVING. RE: SOILS REPORT.

LANDSCAPE AREA, RE: LANDSCAPE DRAWINGS.

POLE MOUNTED LIGHT ON CONCRETE BASE, RE: B1/AS102.

9. POLE MOUNTED LIGHT ON CONCRETE BASE, RE: A5/AS102. 10. ACCESSIBLE SIDEWALK RAMP, RE: C2/AS102.

11. MONUMENT SIGN, RE: B4/AS102. 12. 12" WIDE 6" HIGH OPEN SPACE CONCRETE CULVERT. PROVIDE 1" STEEL CHECKER PLATE COVER ATTACHED TO CONCRETE EMBEDDED

1-1/2"x1-1/2"x4" STEEL ANGLE, PAINT, TYPICAL.

13. GAS METER ENCLOSURE. 14. ACCESSIBLE PARKING SIGN, ADD TEXT "VIOLATORS ARE SUBJECT TO A FINE AND/OR TOWING". RE: C4/AS102

15. COMPACTED BASE COURSE ACCESS ROAD TO CARRY MINIMUM WEIGHT OF 75,000 LB FIRE TRUCK, RE: D2/AS101.

16. ELECTRICAL GEAR ENCLOSURE.

17. BICYCLE RACK, RE: B3/AS102.

18. CONCRETE HEADER CURB, RE: A1/AS102. 19. BACKFLOW PREVENTER AND HOUSING, RE: CIVIL.

20. EXISTING ASPHALT PAVEMENT. 21. EXISTING FIRE HYDRANT.

22. NEW DRIVEWAY AND APRON PER C.O.ABQ. STANDARDS (TYP.) - DRWG. 23. PARKING STRIPING PER C.O.ABQ. STANDARDS - 4" WIDE - SAFETY WHITE.

24. HANDICAP PARKING SPACE PER C.O.ABQ. STANDARDS WITH ACCESSIBLE PARKING SPACE PAVEMENT SIGNAGE, RE: B2/AS102.

25. HANDICAP VAN PARKING SPACE PER C.O.ABQ. STANDARDS WITH ACCESSIBLE PARKING SPACE PAVEMENT SIGNAGE, RE: B2/AS102.

26. HANDICAP ACCESSIBLE AISLE PER C.O.ABQ. STANDARDS WITH PAINTED "NO PARKING". EACH LETTER TO BE MIN. 12" HIGH AND 2" WIDE AND

PLACED AT THE REAR OF THE PARKING SPACE. 27. HANDICAP RAMP W/TRUNCATED DOME SURFACE, RE: B5/AS102.

28. TRASH ENCLOSURE PER C. O. ABQ. REQUIREMENTS, RE: A1/AS101. 29. MOTORCYCLE PARKING SPACES 5'x8' WITH PAVEMENT SIGNAGE - 4" WIDE

SAFETY WHITE, RE: C3/AS102.

30. NEW FIRE HYDRANT PER C.O. ABQ. AND FIRE DEPT. STANDARDS.

31. 'KNOX BOX' INSTALLED PER C.O. ABQ. FIRE DEPT.

32. CURB PAINTED RED WITH "NO PARKING FIRE LANE" PER IFC SECTION 505.3

'MARKINGS' 33. CMU RETAINING WALL, RE: C5/AS102.

34. CAST-IN-PLACE CONCRETE RETAINING WALL, RE: A4/AS102. 35. CAST-IN-PLACE CONCRETE RETAINING WALL, RE: A3/AS102.

36. LANDSCAPE IRRIGATION REDUCED PRESSURE BACKFLOW PREVENTER IN

HEATED ENCLOSURE. RE: LP101 FOR REQUIREMENTS.

37. ELECTRICAL TRANSFORMER WITH SURROUNDING 6" PIPE BOLLARDS, RE:

38. COMMUNICATIONS PEDESTAL, RE: ELEC.

39. WATER UTILITY REDUCED PRESSURE BACKFLOW PREVENTER IN HEATED ENCLOSURE, RE: CIVIL FOR REQUIREMENTS.

40. STANDARD CONCRETE CURB AND GUTTER, PER C.O.ABQ. STANDARDS (TYP.) - DRWG. #2415A.

41. CONCRETE SIDEWALK PER C.O.ABQ. STANDARDS (TYP.) - DRWG. #2430.

LEGEND

DEL

R-1A 3

01.17-20

+ + + + **NEW ASPHALT PAVING NEW CONCRETE PAVING** NEW LANDSCAPING COMPACTED BASE COURSE ACCESS ROAD CITY RESERVOIR SITE TRACT 2 LA CUEVA OFFICE PARK

PASEO DEL NORTE BLVD NE MX-L NORTH ALBUQUERQUE ACRES MX-T 1004564 22A1 TRACT A UNIT A NORTH ALBUQUERQUE ACRES

1008257 23A TRACT A UNIT A AT PALOMAS

R-1C

LOMITA (8 R-1B 1

ADDN (

R-1C

REVISIONS

PERMIT / BID SET

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ARCHITECT/ENGINEER

11/01/2019

No. 4427


DESCRIPTION

11-01-2019

SITE DEVELOPMENT PLAN FOR BUILDING

SHEET NO.

PROJECT NO. 19-0006 Z UN DRAWING NAME

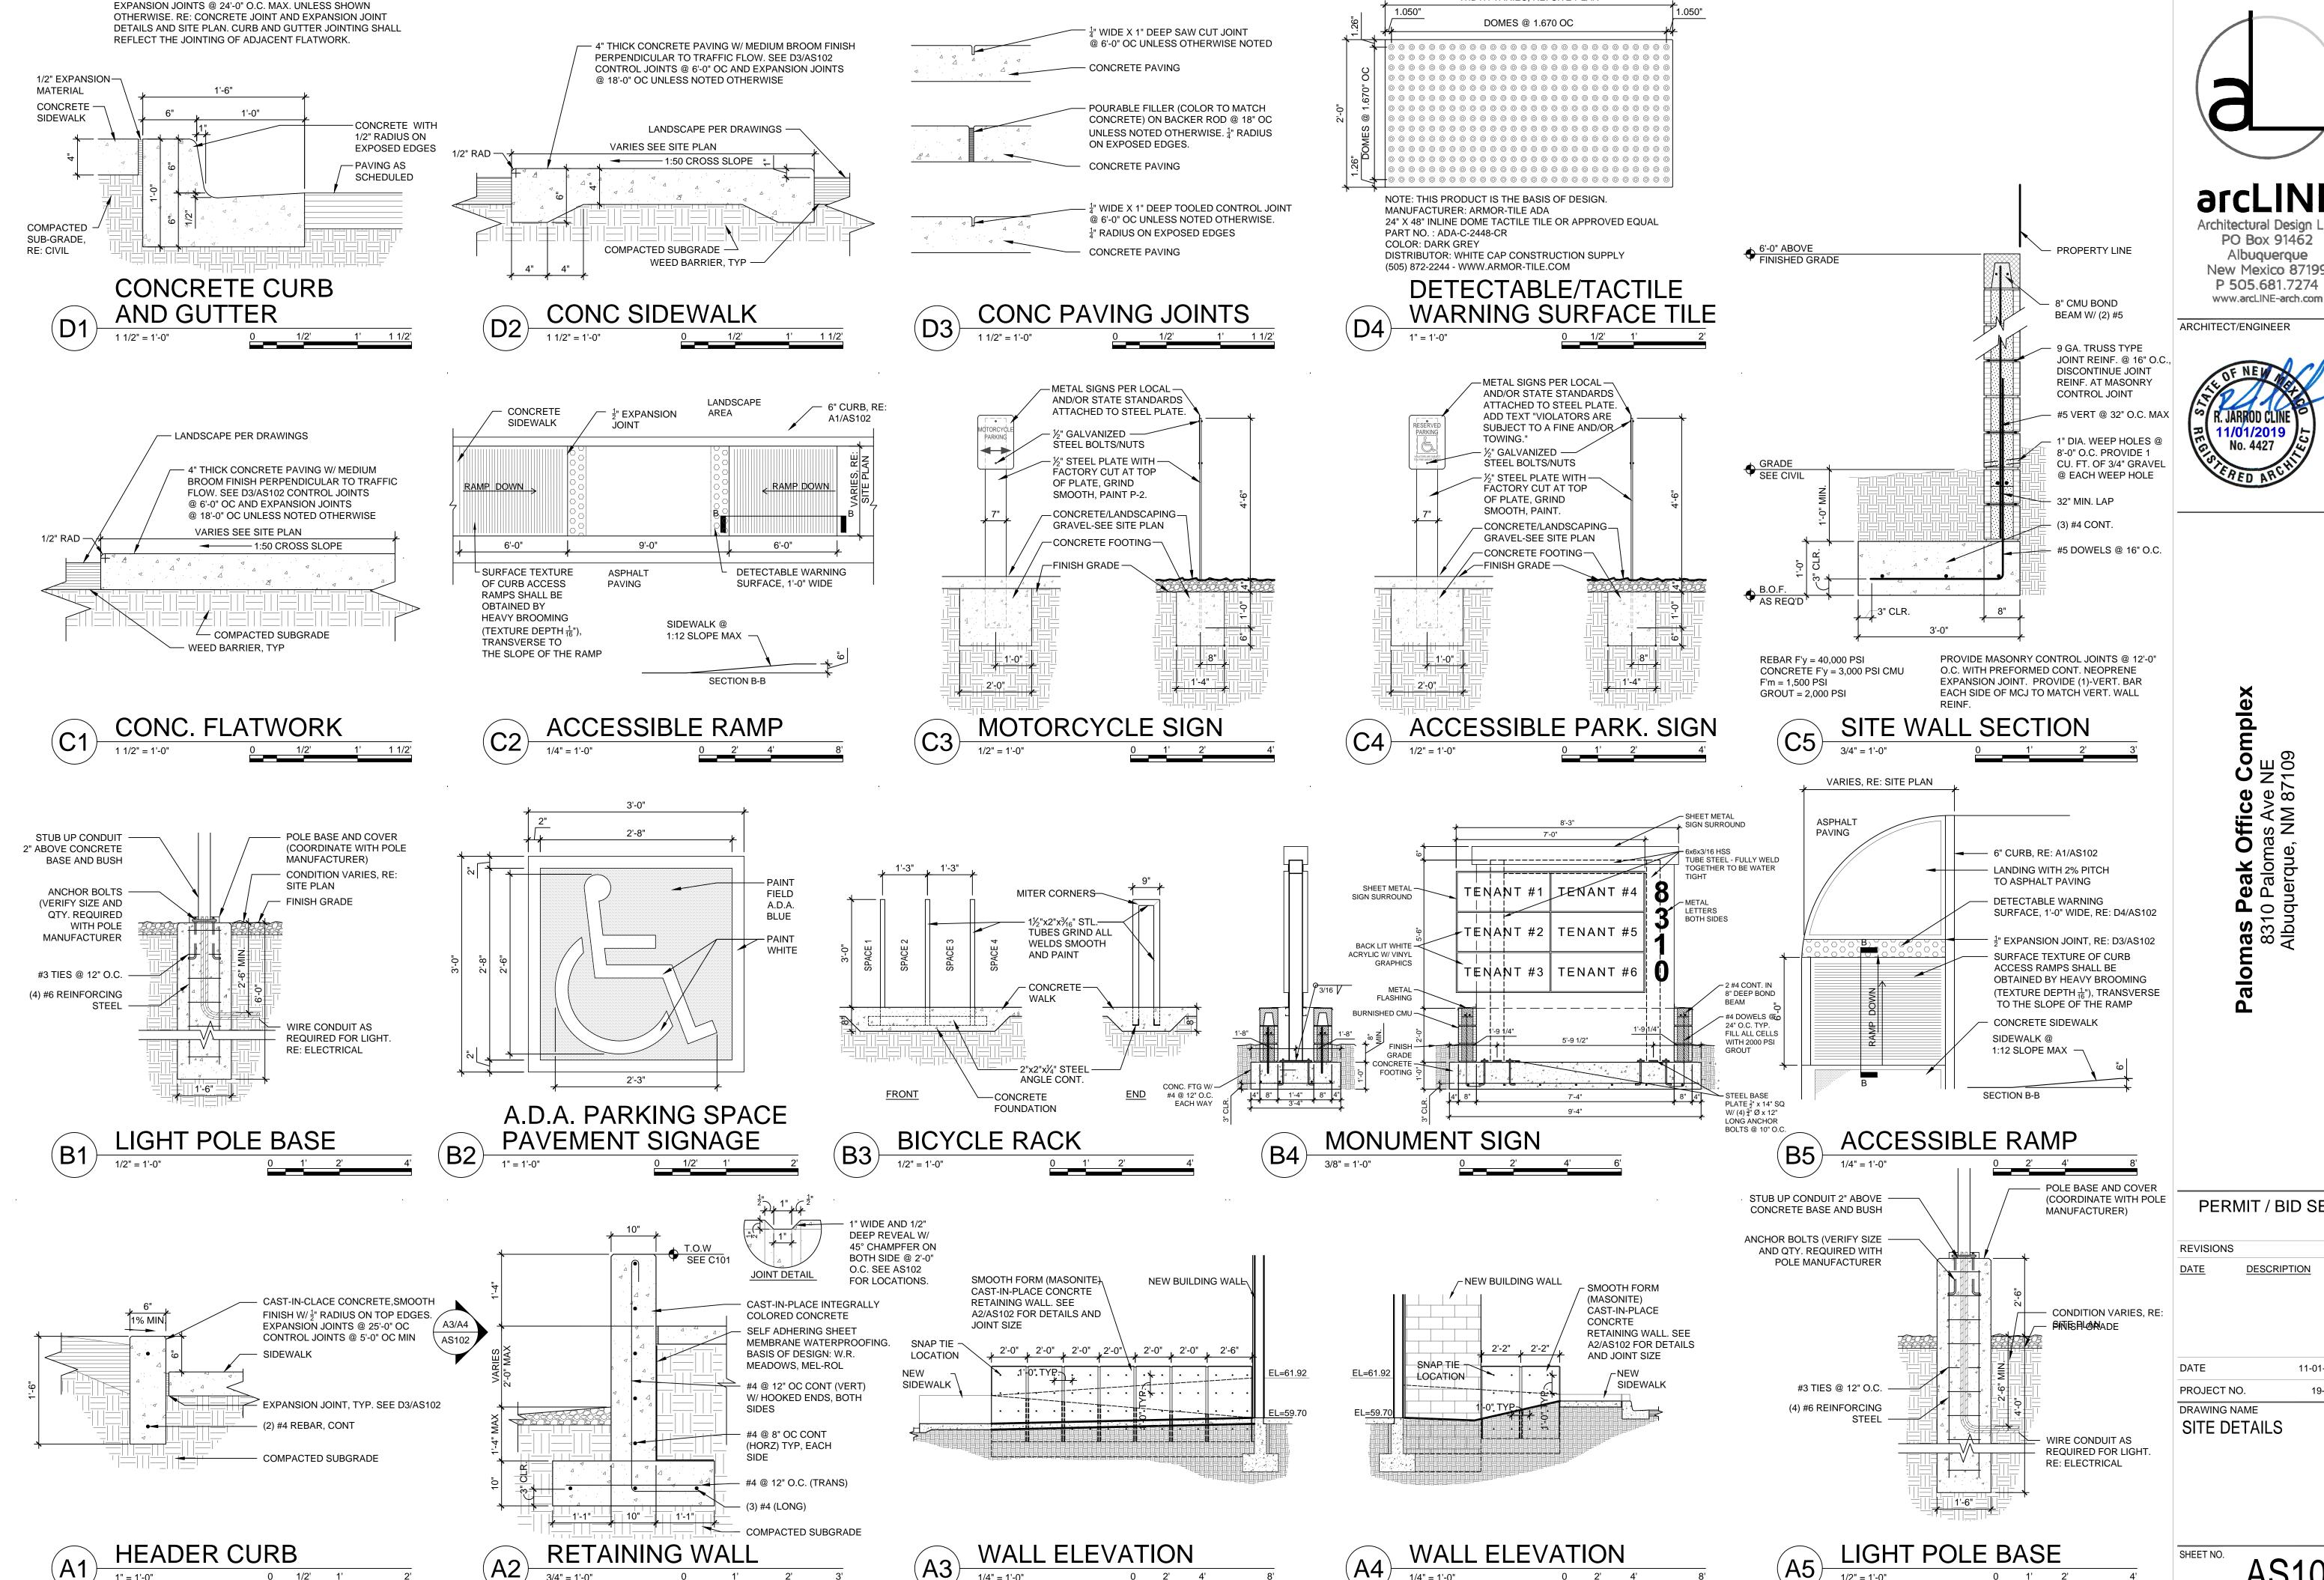

WIDTH VARIES, RE: SITE PLAN

NOTE: PROVIDE CONTROL JOINTS @ 6'-0" O.C. MAX. AND DOWELED

arcLINE

Architectural Design LLC PO Box 91462 Albuquerque New Mexico 87199 P 505.681.7274



PERMIT / BID SET

11-01-2019

19-0006

AS102