
CITY OF ALBUQUERQUE

Planning Department
David Campbell, Director

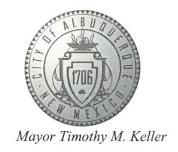

June 26, 2019

David Soule, P.E. Rio Grande Engineering PO Box 93924 Albuquerque, New Mexico 87199

RE: Lot 9 Block 13 Unit 5 SAD 227

6519 Jade Dr. NW

Grading and Drainage Plan

Engineers Stamp Date 4/22/19 (E10D062)

Pad Certification Date 5/29/19

Dear Mr. Soule,

Based upon the information provided in your submittal received 6/19/19, this plan is approved for Puilding Pormit

PO Box 1293 approved for Building Permit.

Please inform the builder/owner to attach a copy of this approved plan and this letter to the construction sets in the permitting process prior to sign-off by Hydrology.

Albuquerque

Reiterate to the Owner/Contractor that a separate permit for a garden/retaining wall must be obtained, with the approved G&D plan dated 4/22/19.

NM 87103

Prior to Certificate of Occupancy release, Engineer Certification per the DPM checklist of this plan will be required.

www.cabq.gov

If you have any questions, please contact me at 924-3986 or Rudy Rael at 924-3977.

Sincerely,

James D. Hughes, P.E.

Principal Engineer, Hydrology

Planning Department

RR/JDH

C: File E10D062



City of Albuquerque


Planning Department

Development & Building Services Division

DRAINAGE AND TRANSPORTATION INFORMATION SHEET (REV 6/2018)


Project Title: 6519 JADE DR NW	_ Building Permit #:	Hydrology File #:	
DRB#:			
Legal Description: LOT 9 , BLOCK	13 VOLCANO CLIFFS UN	IT 5	
City Address: 6519 JADE DR	1135		
Applicant: LUPE SOTELO		Contact:	
Address:			
Phone#:			
Other Contact: RIO GRANDE ENGIN	07100	Contact:Contact:	
Address: PO BOX 93924 ALB NM			
Phone#: 505.321.9099	Fax#:	E-mail: david@riograndeengineering.com	
TYPE OF DEVELOPMENT: PLAT	X RESIDENCE	_ DRB SITE ADMIN SITE	
Check all that Apply:			
DEPARTMENT: X HYDROLOGY/ DRAINAGE TRAFFIC/ TRANSPORTATION TYPE OF SUBMITTAL: ENGINEER/ARCHITECT CERTIFICATIO X PAD CERTIFICATION CONCEPTUAL G & D PLAN GRADING PLAN DRAINAGE REPORT DRAINAGE MASTER PLAN FLOODPLAIN DEVELOPMENT PERMIT ELEVATION CERTIFICATE CLOMR/LOMR TRAFFIC CIRCULATION LAYOUT (TCL TRAFFIC IMPACT STUDY (TIS) STREET LIGHT LAYOUT OTHER (SPECIFY)	X BUILDIN CERTIFI ON PRELIM SITE PL SITE PL FINAL F SIA/ REI APPLIC GRADIN SO-19 A PAVING GRADIN WORK O	PERMIT APPROVAL GG/PAD CERTIFICATION PRDER APPROVAL	
PRE-DESIGN MEETING?	_	FLOODPLAIN DEVELOPMENT PERMIT	
IS THIS A RESUBMITTAL?: X YesN	OTHER	(SPECIFY)	
DATE SUBMITTED:	By:		
COA STAFF:	ELECTRONIC SUBMITTAL RECEIVE	ED:	

FEE PAID:_____

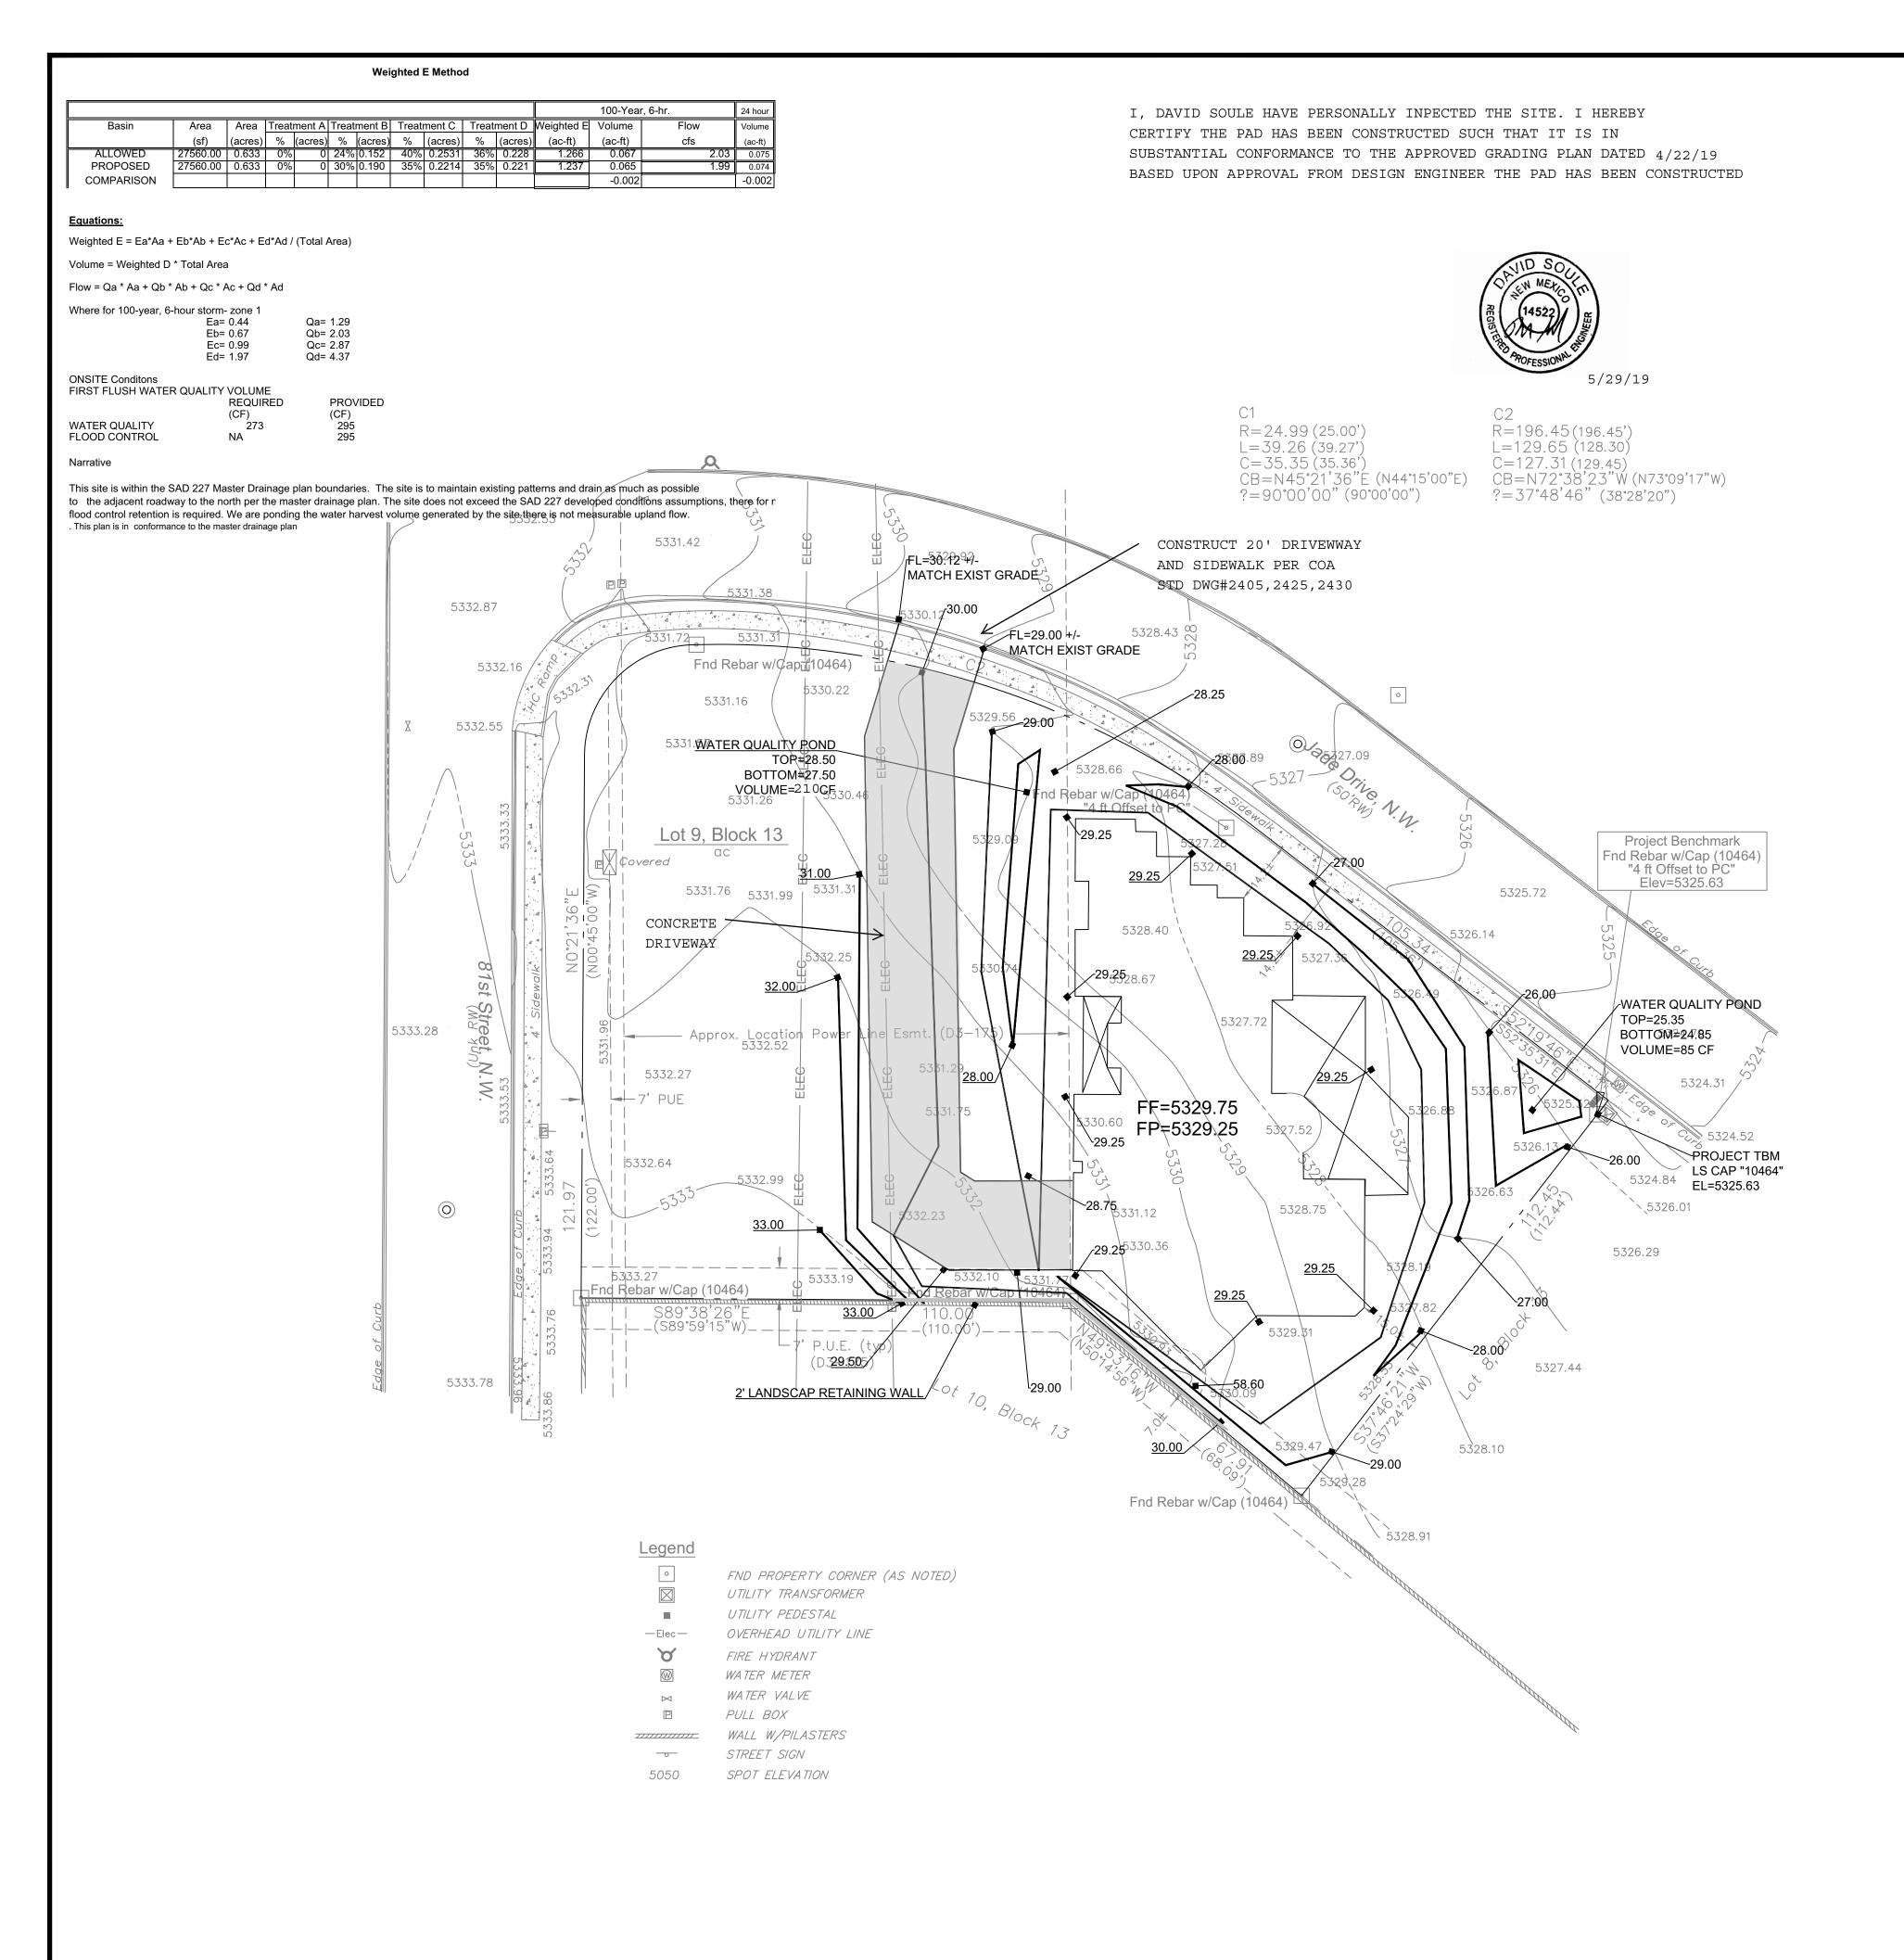

EROSION CONTROL NOTES:

- 1. CONTRACTOR IS RESPONSIBLE FOR OBTAINING A TOPSOIL DISTURBANCE PERMIT PRIOR TO BEGINNING WORK.
- 2. CONTRACTOR IS RESPONSIBLE FOR MAINTAINING RUN-OFF ON SITE DURING CONSTRUCTION.
- 3. CONTRACTOR IS RESPONSIBLE FOR CLEANING ALL SEDIMENT THAT GETS INTO EXISTING RIGHT-OF-WAY.
- 4. REPAIR OF DAMAGED FACILITIES AND CLEANUP OF SEDIMENT ACCUMULATIONS ON ADJACENT PROPERTIES AND IN PUBLIC FACILITIES IS THE RESPONSIBILITY OF THE CONTRACTOR.
- 5. ALL EXPOSED EARTH SURFACES MUST BE PROTECTED FROM WIND AND WATER EROSION PRIOR TO FINAL (CITY) ACCEPTANCE OF ANY PROJECT.

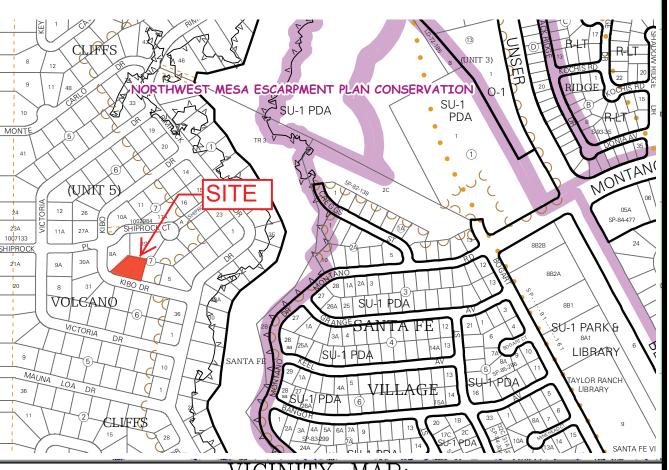



LEGAL DESCRIPTION:

LOT 9, BLOCK 13, UNIT 15, VOLCANO CLIFFS

NOTES:


COMFORM TO THIS PLAN

- 1. ALL SPOT ELEVATIONS REPRESENT FLOWLINE ELEVATION UNLESS OTHERWISE
- 2. TOPOGRAPHIC SURVEY INFORMATION SHOWN ON THIS PLAN WAS OBTAINED BY COMMUNITY SCIENCES APRIL 2019
- 3.. ALL DISTURBED AREAS MUST BE RESEED OR LANDSCAPED PRIOR TO FINAL C.O.. ALL AREAS OUTSIDE THE BUILDING ENVELOPE MUST BE RESEED WITH NATIVE MIX 4. DUE TO EXISTING TOPOGRAPHY AND UNDEVELOPED NATURE OF THE DOWN STEAM
- AREA, PERIODIC MAINTENANCE OF PONDS AND SWALES ARE REQUIRED. 3. A PAD GRADING CERTIFICATION IS REQUIRED PRIOR TO BUILDING PERMIT 4. ALL WALLS MUST BE CONSTRUCTED UNDER SEPARATE PERMITS AND MUST
 - LEGEND

---- EXISTING CONTOUR — — 5410— — EXISTING INDEX CONTOUR 100.00 PROPOSED FLOWLINE ELEVATIONS



SCALE: 1"=20'

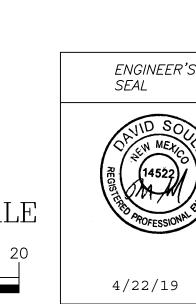

DAVID SOULE

P.E. #14522

ENGINEER'S SEAL	
REGISTER AROFESSIONIAL	I
4/22/19	=

Lot 9, Block 13	DRAWN BY _{JDG}
Volcano Cliffs Unit 5	DATE 04/20/2019
GRADING AND DRAINAGE PLAN	04/20/2019
Rio Grande Engineering	SHEET # 1 OF 1

1606 CENTRAL AVENUE SE SUITE 201

ALBUQUERQUE, NM 87106 (505) 872-0999

JOB #