CITY OF ALBUQUERQUE

Planning Department
David Campbell, Director



April 24, 2019

David Soule, P.E. Rio Grande Engineering PO Box 93924 Albuquerque, New Mexico 87199

RE: Lot 9 Block 13 Unit 5 S.A.D. 227 6519 Jade Dr. NW

> Grading and Drainage Plan Engineers Stamp Date 4/22/19 (E10D062)

Dear Mr. Soule,

PO Box 1293

NM 87103

www.cabq.gov

Based upon the information provided in your submittal received 4/23/19, this plan is approved for Grading Permit. Please inform the builder/owner to attach a copy of this approved plan and letter into the construction sets in the permitting process prior to sign-off by Hydrology.

Reiterate to the Owner/Contractor that a separate permit for any garden/retaining wall must be obtained, with the approved G&D plan.

Prior to Building Permit approval, a **Pad Certification** will be required. Inform the contractor/owner not to pile dirt in the street as a ramp to climb the curb. If dirt is found in the street the pad cert. will be denied.

Prior to Certificate of Occupancy release, Engineer Certification per the DPM checklist of this plan will be required.

If you have any questions, please contact me at 924-3986 or Rudy Rael at 924-3977.

Sincerely,

James D. Hughes, P.E. Principal Engineer, Hydrology

Planning Department

RR/JDH

C: Data Base E10D062



City of Albuquerque


Planning Department

Development & Building Services Division

DRAINAGE AND TRANSPORTATION INFORMATION SHEET (REV 6/2018)


Project Title: 6519 JADE DR NW	Building Permit #:	Hydrology File #:		
DRB#:	EPC#:	Work Order#:	Order#:	
Legal Description: LOT 9 , BLOCK	13 VOLCANO CLIFFS	Work Order#:		
7011 KTD0				
Applicant: LUPE SOTELO		Contact:		
Address:				
		E-mail:		
Other Contact: RIO GRANDE ENGIN	Contact: RIO GRANDE ENGINEERING			
Address: PO BOX 93924 ALB NM	I 87199			
Phone#: 505.321.9099	Fax#: 505.872.0999	E-mail: david@riograndeenginee	ering.com	
TYPE OF DEVELOPMENT: PLAT				
Check all that Apply:				
DEPARTMENT: X HYDROLOGY/ DRAINAGE TRAFFIC/ TRANSPORTATION TYPE OF SUBMITTAL: ENGINEER/ARCHITECT CERTIFICATION X PAD CERTIFICATION CONCEPTUAL G & D PLAN GRADING PLAN DRAINAGE REPORT DRAINAGE MASTER PLAN FLOODPLAIN DEVELOPMENT PERMIT ELEVATION CERTIFICATE CLOMR/LOMR TRAFFIC CIRCULATION LAYOUT (TO: TRAFFIC IMPACT STUDY (TIS) STREET LIGHT LAYOUT OTHER (SPECIFY) PRE-DESIGN MEETING? IS THIS A RESUBMITTAL?: Yes X	X BUI	PF APPROVAL/ACCEPTANCE SOUGHT: ILLDING PERMIT APPROVAL RTIFICATE OF OCCUPANCY ELIMINARY PLAT APPROVAL TE PLAN FOR SUB'D APPROVAL TE PLAN FOR BLDG. PERMIT APPROVAL MAL PLAT APPROVAL AND RELEASE OF FINANCIAL GUARANTEE UNDATION PERMIT APPROVAL ADING PERMIT APPROVAL ADING PERMIT APPROVAL VING PERMIT APPROVAL ADING/PAD CERTIFICATION ORK ORDER APPROVAL OMR/LOMR OODPLAIN DEVELOPMENT PERMIT HER (SPECIFY)		
DATE SUBMITTED:	* '			
COA STAFF:	ELECTRONIC SUBMITTAL RE			

FEE PAID:____

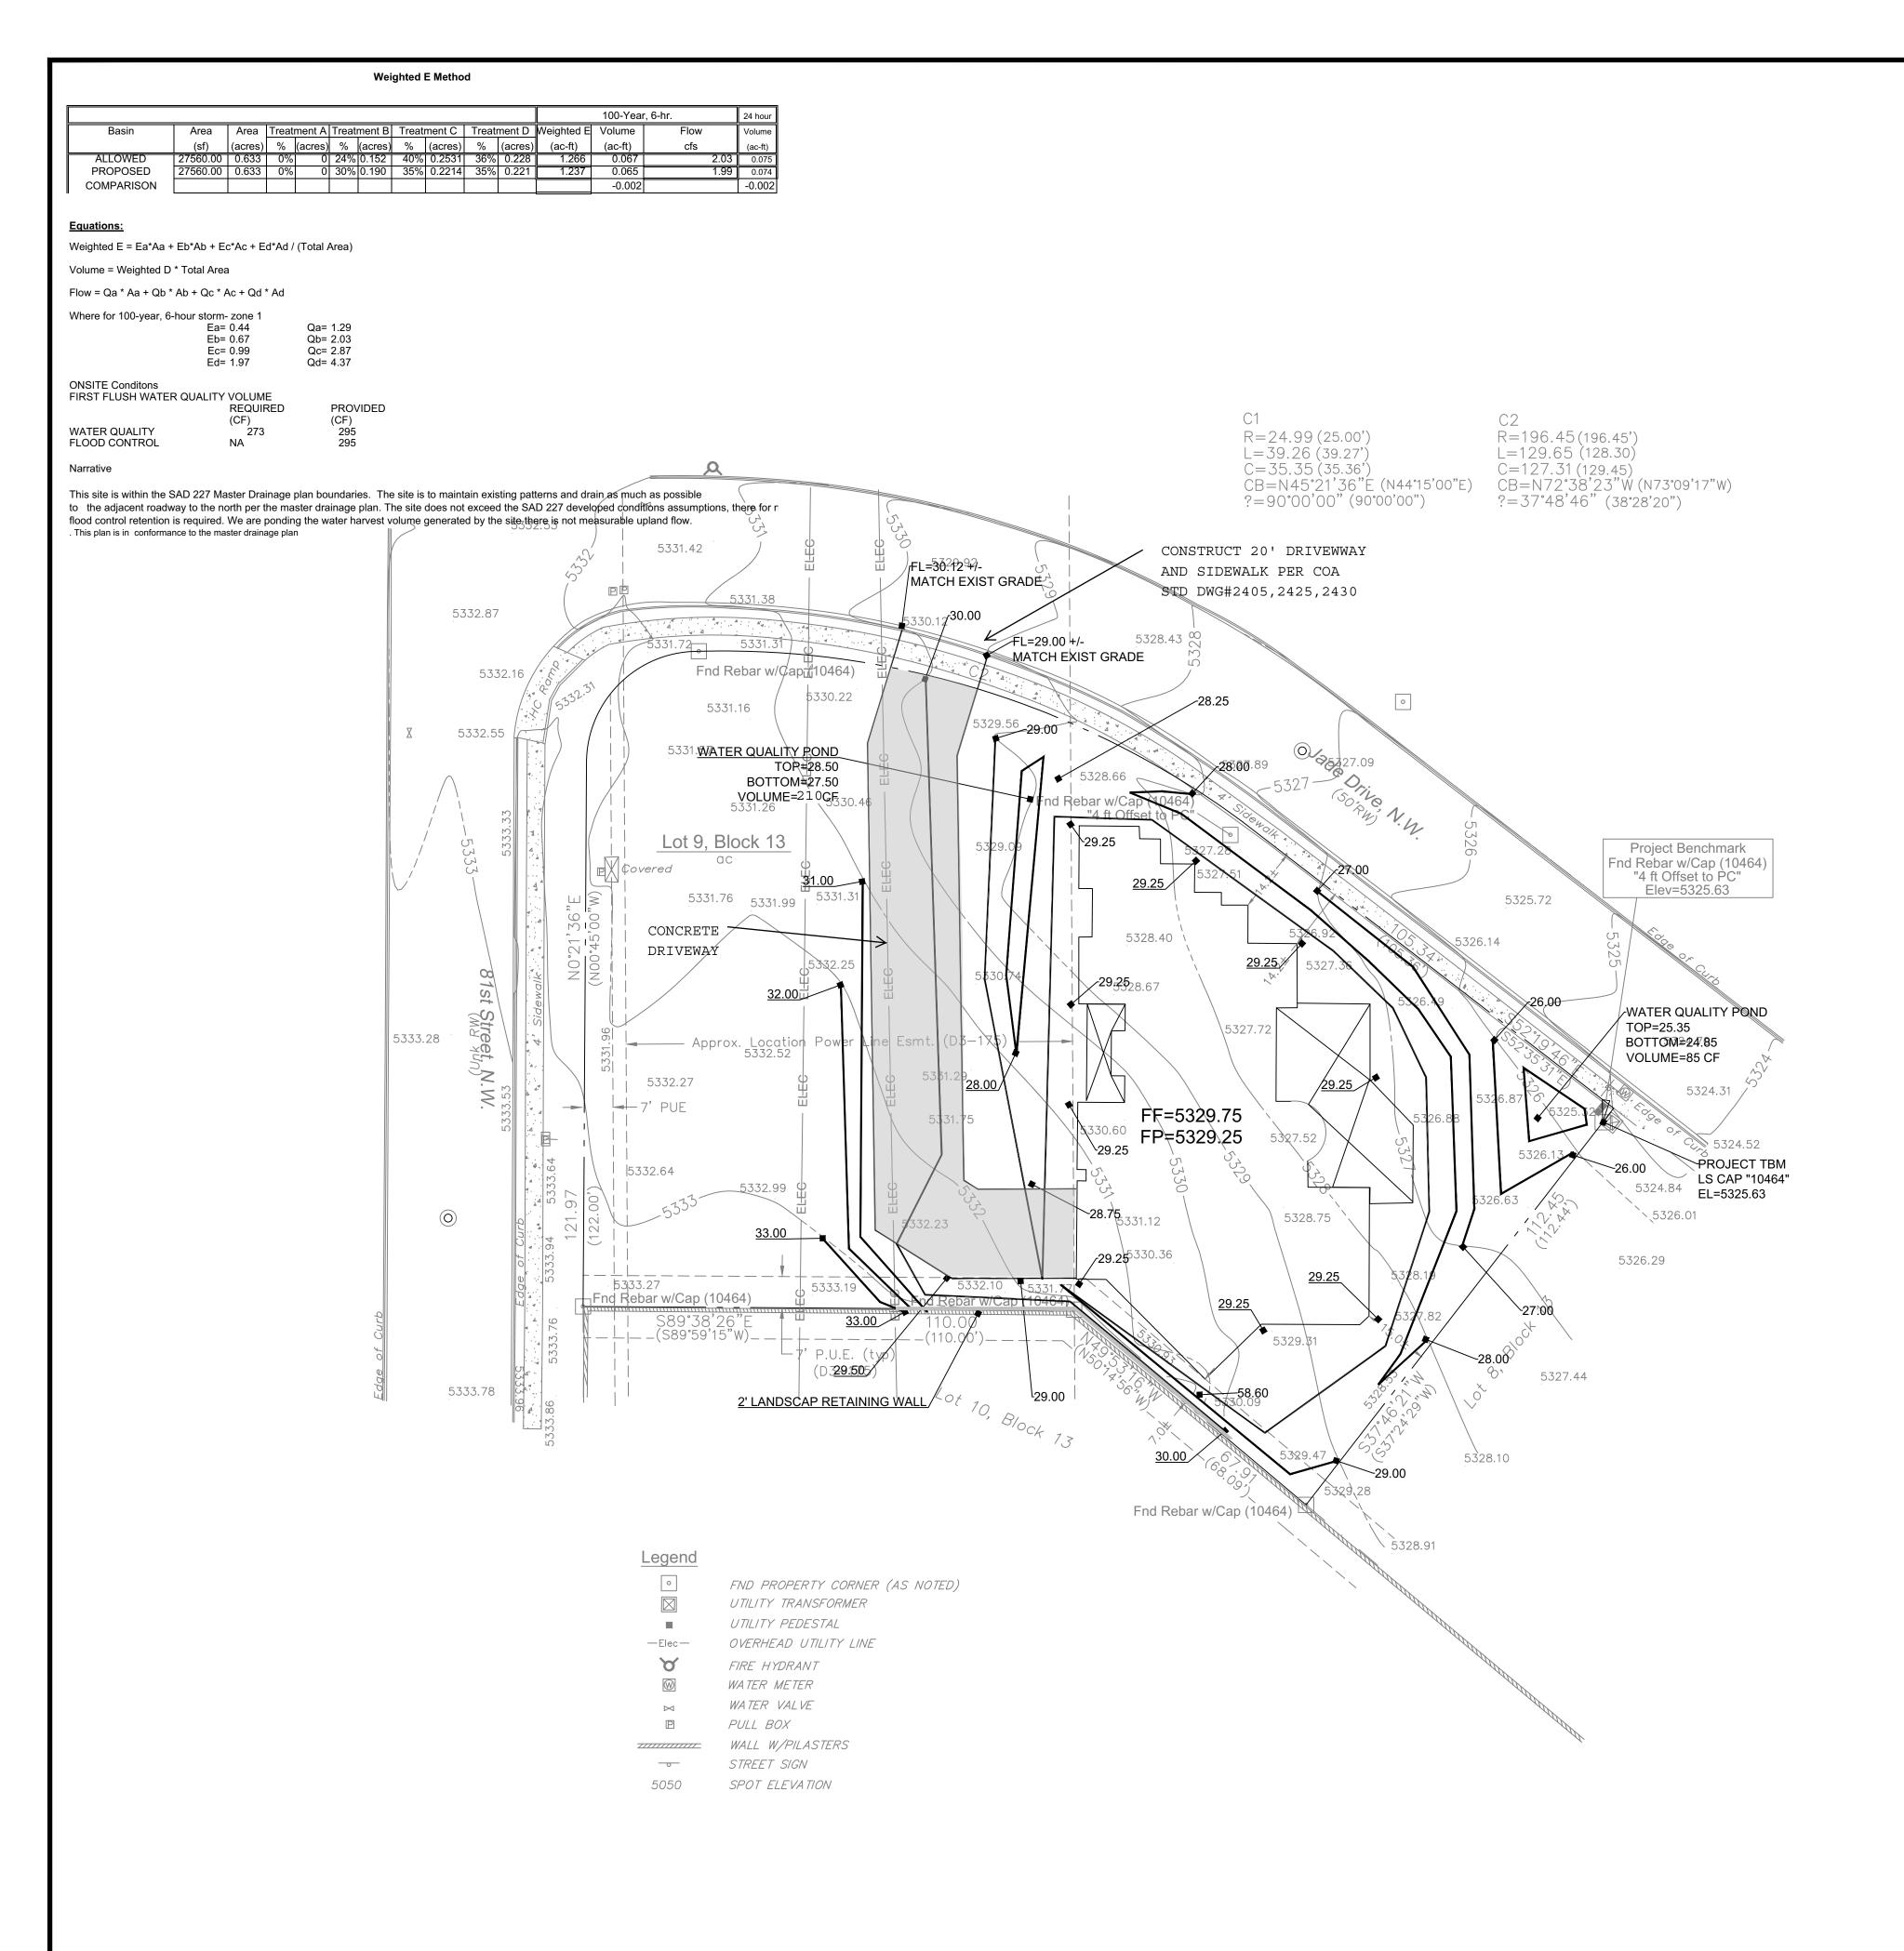

EROSION CONTROL NOTES:

- 1. CONTRACTOR IS RESPONSIBLE FOR OBTAINING A TOPSOIL DISTURBANCE PERMIT PRIOR TO BEGINNING WORK.
- 2. CONTRACTOR IS RESPONSIBLE FOR MAINTAINING RUN-OFF ON SITE DURING CONSTRUCTION.
- 3. CONTRACTOR IS RESPONSIBLE FOR CLEANING ALL SEDIMENT THAT GETS INTO EXISTING RIGHT-OF-WAY.
- 4. REPAIR OF DAMAGED FACILITIES AND CLEANUP OF SEDIMENT ACCUMULATIONS ON ADJACENT PROPERTIES AND IN PUBLIC FACILITIES IS THE RESPONSIBILITY OF THE CONTRACTOR.
- 5. ALL EXPOSED EARTH SURFACES MUST BE PROTECTED FROM WIND AND WATER EROSION PRIOR TO FINAL (CITY) ACCEPTANCE OF ANY PROJECT.

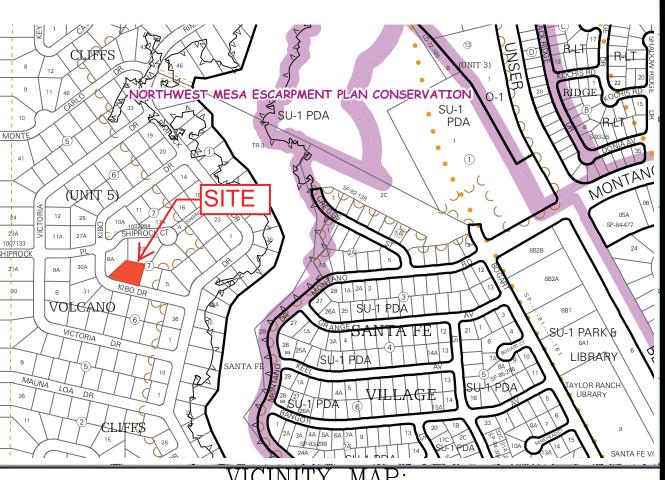



LEGAL DESCRIPTION:

LOT 9, BLOCK 13, UNIT 15, VOLCANO CLIFFS

NOTES:


COMFORM TO THIS PLAN

- 1. ALL SPOT ELEVATIONS REPRESENT FLOWLINE ELEVATION UNLESS OTHERWISE
- 2. TOPOGRAPHIC SURVEY INFORMATION SHOWN ON THIS PLAN WAS OBTAINED BY COMMUNITY SCIENCES APRIL 2019
- 3.. ALL DISTURBED AREAS MUST BE RESEED OR LANDSCAPED PRIOR TO FINAL C.O.. ALL AREAS OUTSIDE THE BUILDING ENVELOPE MUST BE RESEED WITH NATIVE MIX 4. DUE TO EXISTING TOPOGRAPHY AND UNDEVELOPED NATURE OF THE DOWN STEAM
- AREA, PERIODIC MAINTENANCE OF PONDS AND SWALES ARE REQUIRED.


 3. A PAD GRADING CERTIFICATION IS REQUIRED PRIOR TO BUILDING PERMIT

 4. ALL WALLS MUST BE CONSTRUCTED UNDER SEPARATE PERMITS AND MUST

LEGEND

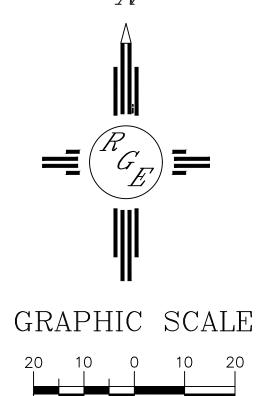

SCALE: 1"=20'

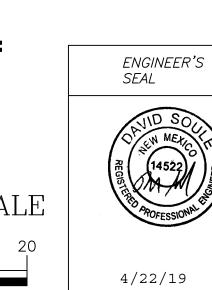

DAVID SOULE

P.E. #14522

Lot 9, Block 13	DRAWN BY _{JDG}
Volcano Cliffs Unit 5	DATE
GRADING AND DRAINAGE PLAN	04/20/2019
Rio Grande Engineering	SHEET # 1 OF 1
Engineering	1 OF' 1

1606 CENTRAL AVENUE SE

ALBUQUERQUE, NM 87106 (505) 872-0999 JOB #