
# CITY OF ALBUQUERQUE

Planning Department
Brennon Williams, Director

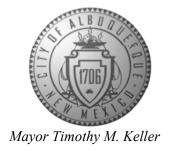

May 14, 2020

David Soule, P.E. Rio Grande Engineering PO Box 93924 Albuquerque, New Mexico 87199

RE: Lot 14 Block 7A S.A.D. 227 Unit 3
6119 Little Joe Dr.. NW
Grading and Drainage Plan
Engineers Stamp Date 5/13/2020 (E10D078)

Dear Mr. Soule,

PO Box 1293

Albuquerque

NM 87103

www.cabq.gov

Based upon the information provided in your submittal received 5/14/2020, this plan is approved for Grading Permit. Please inform the builder/owner to attach a copy of this approved plan and letter into the construction sets in the permitting process prior to sign-off by Hydrology.

Reiterate to the Owner/Contractor that a separate permit for any garden/retaining wall must be obtained, with the approved G&D plan.

Prior to Building Permit approval, a **Pad Certification** will be required. Inform the contractor/owner not to pile dirt in the street as a ramp to climb the curb. If dirt is found in the street the pad cert. will be denied.

Prior to **Certificate of Occupancy release**, Engineer Certification per the DPM checklist of this plan will be required.

If you have any questions, please contact me at 924-3986 or Rudy Rael at 924-3977.

Sincerely,

Ernest Armijo, P.E.

Principal Engineer, Planning Dept. Development Review Services

RR/EA C: File E10D078



# City of Albuquerque

### Planning Department

### Development & Building Services Division

## DRAINAGE AND TRANSPORTATION INFORMATION SHEET (REV 6/2018)

Project Title: 6119 LITTLE JOE	DR Building Permit #	<b>!:</b>	_ Hydrol	ogy File #: E			
DRB#:	EPC#:		Work Order#:				
Legal Description: lot 14 bloc	k 7A volcano cl	lifs unit 3	<del></del>				
City Address: 6119 LITTLE JO	E DR	1,-1,-1					
Applicant:			Contact:				
Address:							
Phone#:			E-mail:				
Other Contact: RIO GRANDE EN							
Address: PO BOX 93924 ALB	NM 87199		Comaci.	-			
Phone#: 505.321.9099		)999	E-mail: d	avid@riograndeengineering.com			
TYPE OF DEVELOPMENT:P							
Check all that Apply:							
DEPARTMENT:  X HYDROLOGY/ DRAINAGE TRAFFIC/ TRANSPORTATION  TYPE OF SUBMITTAL: ENGINEER/ARCHITECT CERTIFICATION PAD CERTIFICATION CONCEPTUAL G & D PLAN GRADING PLAN	ATION	YPE OF APPROVA  BUILDING PERI CERTIFICATE O  PRELIMINARY SITE PLAN FOR SITE PLAN FOR FINAL PLAT A	MIT APPR OF OCCUP PLAT AP R SUB'D A R BLDG. P	ROVAL PANCY PROVAL APPROVAL PERMIT APPROVAL			
DRAINAGE REPORT DRAINAGE MASTER PLAN FLOODPLAIN DEVELOPMENT PER ELEVATION CERTIFICATE CLOMR/LOMR TRAFFIC CIRCULATION LAYOUT TRAFFIC IMPACT STUDY (TIS) STREET LIGHT LAYOUT OTHER (SPECIFY) PRE-DESIGN MEETING?  IS THIS A RESUBMITTAL?: Yes	(TCL)	SIA/ RELEASE ( FOUNDATION I GRADING PERI SO-19 APPROV PAVING PERMI GRADING/ PAD WORK ORDER A CLOMR/LOMR FLOODPLAIN D OTHER (SPECII	PERMIT A MIT APPR AL T APPRO CERTIFI PPROVAL	ROVAL ICATION MENT PERMIT			
DATE SUBMITTED:	By:						
COA STAFF:	ELECTRONIC SUBM	IITTAL RECEIVED:					

FEE PAID:\_\_\_\_

										100-Year, 6-hr.				
Basin	Area	Area	Treat	ment A	Treat	ment B	Treat	ment C	Treatr	ment DV	Veighted I	Volume	Flow	
	(sf)	(acres)	%	(acres)	%	(acres)	%	(acres)	%	(acres)	(ac-ft)	(ac-ft)	cfs	
ALLOWED	7747.00	0.178	0%	0	10%	0.018	40%	0.0711	50%	0.089	1.448	0.021		0.63
PROPOSED	7747.00	0.178	0%	0	10%	0.018	28%	0.0498	62%	0.110	1.566	0.023		0.66
total														

Weighted E Method

## **Equations:**

Weighted E = Ea\*Aa + Eb\*Ab + Ec\*Ac + Ed\*Ad / (Total Area)

Volume = Weighted D \* Total Area

Flow = Qa \* Aa + Qb \* Ab + Qc \* Ac + Qd \* Ad

## Where for 100-year, 6-hour storm-zone 1


Qa= 1.29 Ea= 0.44 Eb= 0.67 Qb= 2.03 Ec= 0.99 Qc= 2.87 Ed= 1.97 Qd= 4.37

ONSITE Conditons FIRST FLUSH WATER QUALITY VOLUME REQUIRED

PROVIDED (CF) WATER QUALITY FLOOD CONTROL

### Narrative

This site is within the SAD 221 Master Drainage plan boundaries. The site is to maintain existing patterns and drain to the the adjacent roadway per the master drainage plan. The site exceeds the land treatment conditions specified within the master gradii plan therefore we are ponding the excess volume. Existing walls eliminate upland flowse. This plan provides ponding in excess of the drainage regulations. This plan is in conformance to the master drainage plan

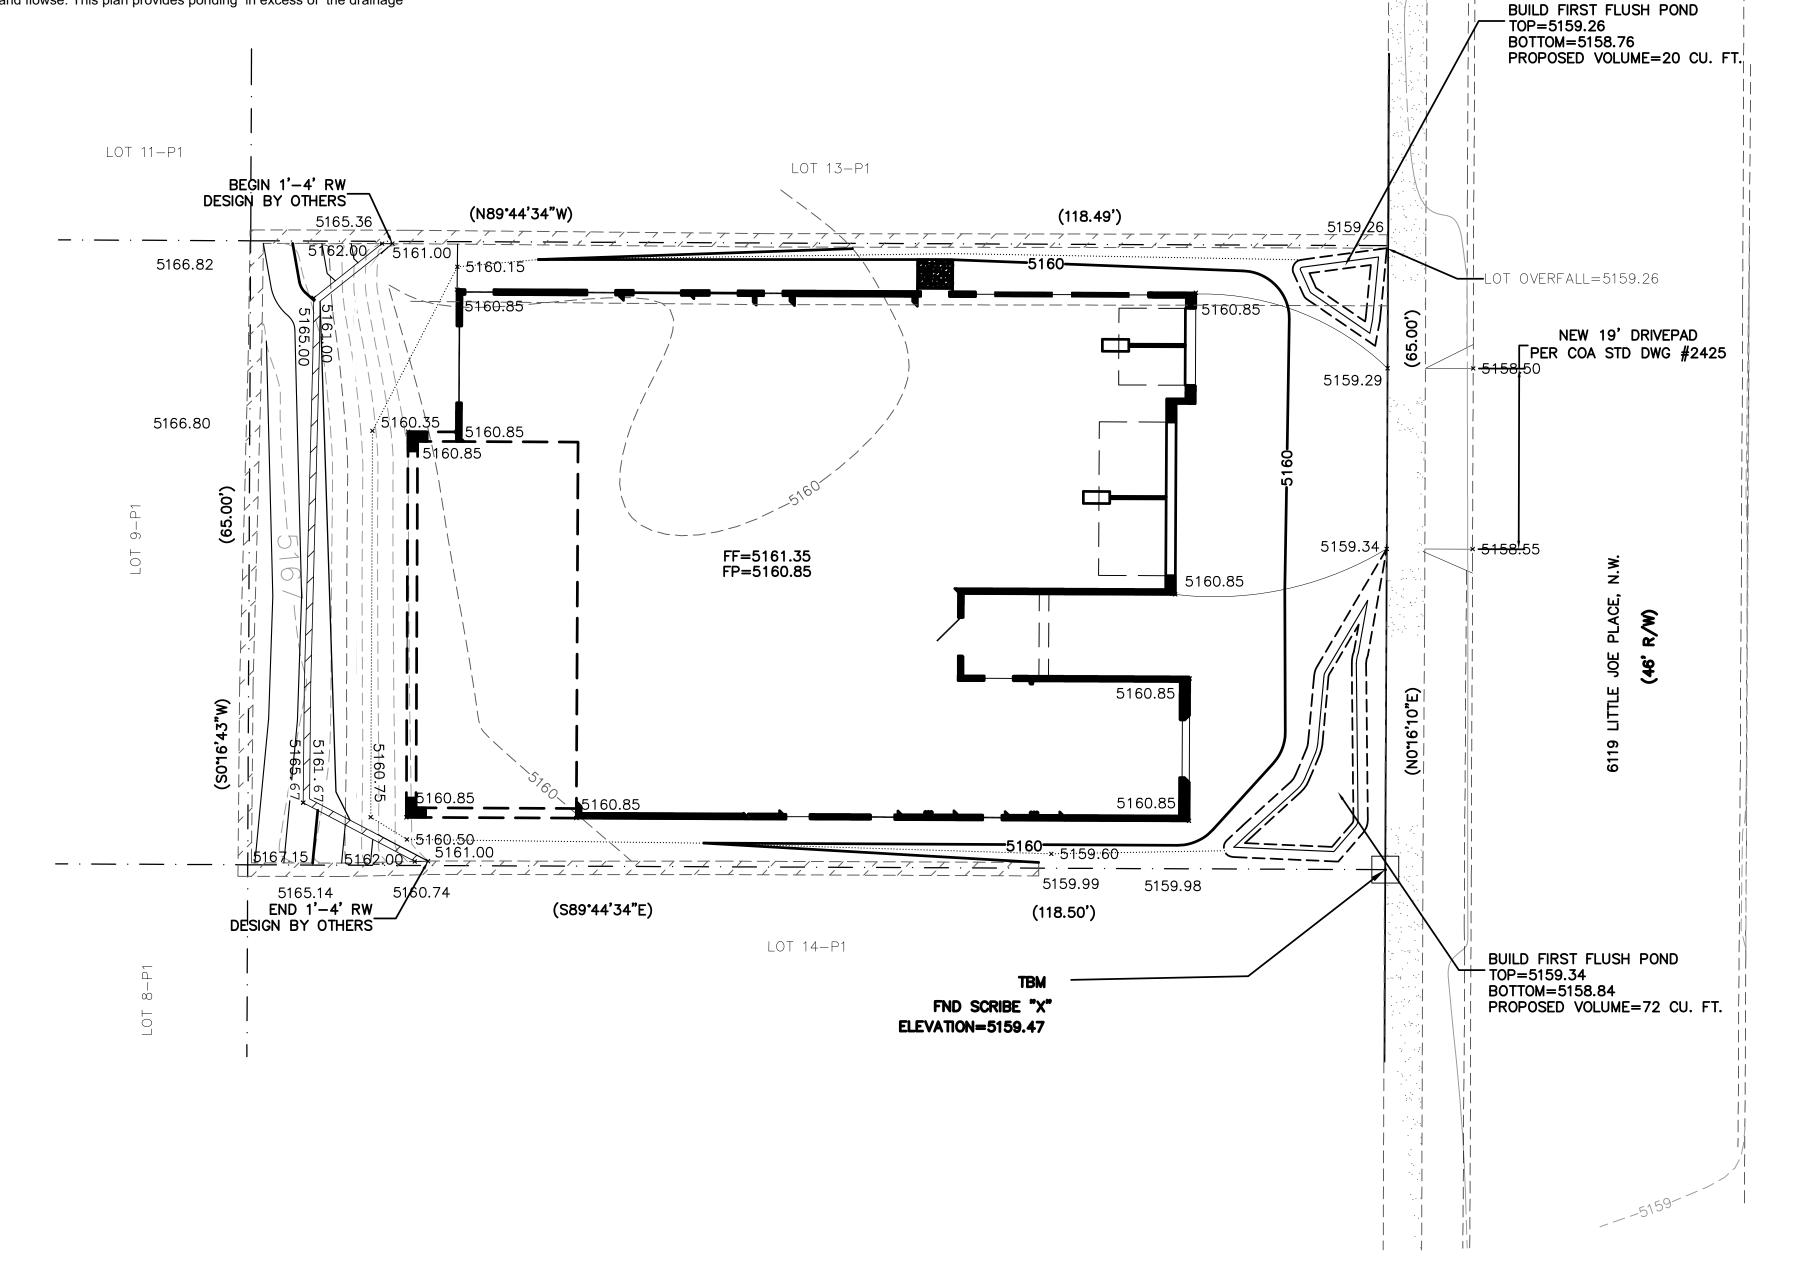


# CAUTION:

EXISTING UTILITIES ARE NOT SHOWN. IT SHALL BE THE SOLE RESPONSIBILITY
OF THE CONTRACTOR TO CONDUCT ALL
NECESSARY FIELD INVESTIGATIONS PRIOR
TO ANY EXCAVATION TO DETERMINE THE ACTUAL LOCATION OF UTILITIES & OTHER IMPROVEMENTS.

# EROSION CONTROL NOTES:

1. CONTRACTOR IS RESPONSIBLE FOR OBTAINING A TOPSOIL DISTURBANCE PERMIT PRIOR TO BEGINNING WORK.

- 2. CONTRACTOR IS RESPONSIBLE FOR MAINTAINING RUN-OFF ON SITE DURING CONSTRUCTION.
- 3. CONTRACTOR IS RESPONSIBLE FOR CLEANING ALL SEDIMENT THAT GETS INTO EXISTING RIGHT-OF-WAY.
- 4. REPAIR OF DAMAGED FACILITIES AND CLEANUP OF SEDIMENT
- ACCUMULATIONS ON ADJACENT PROPERTIES AND IN PUBLIC FACILITIES IS THE RESPONSIBILITY OF THE CONTRACTOR.
- 5. ALL EXPOSED EARTH SURFACES MUST BE PROTECTED FROM WIND AND WATER EROSION PRIOR TO FINAL ACCEPTANCE OF ANY PROJECT.

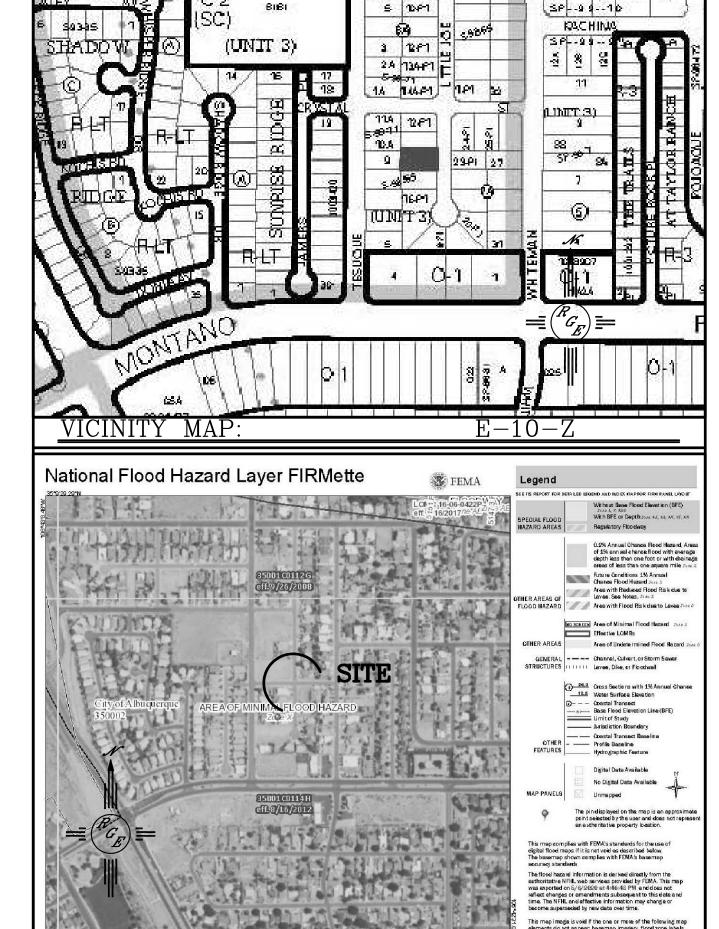

LEGAL DESCRIPTION:

LOT 14-P1, BLOCK 7-A, VOLCANO CLIFFS UNIT 3

## NOTES:


FIRM MAP:

1. ALL SPOT ELEVATIONS REPRESENT FLOWLINE ELEVATION UNLESS OTHERWISE

2. ALL SLOPES SHALL BE 3:1 MAX. AND GRAVEL OR NATIVE SEEDING PRIOR TO CO.

# LEGEND

	EXISTING CONTOUR
	EXISTING INDEX CONTOUR
XXXX	PROPOSED CONTOUR
xxxx	PROPOSED INDEX CONTOUR
<b>—</b>	SLOPE TIE
× XXXX	EXISTING SPOT ELEVATION
× XXXX	PROPOSED SPOT ELEVATION
	BOUNDARY
	CENTERLINE
	RIGHT-OF-WAY
	PROPOSED 4" PVC SD
	POOL DECK TRENCH DRAIN
=========	EXISTING CURB AND GUTTER

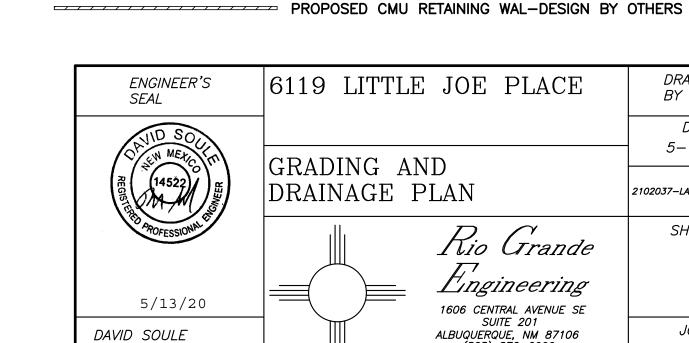

SCALE: 1"=10'

6119 LITTLE JOE PLACE	DRAWN BY WCWJ
	DATE
GRADING AND	5-12-20

DRAINAGE PLAN 2102037-LAYOUT-5-12-20 SHEET # Rio Grande Lingineering 1606 CENTRAL AVENUE SE

JOB #

2102037

SUITE 201 ALBUQUERQUE, NM 87106 (505) 872-0999 P.E. #14522