
CITY OF ALBUQUERQUE

Planning Department Alan Varela, Director

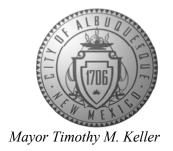

February 27, 2023

David Soule, P.E. Rio Grande Engineering P.O. Box 93924 Albuquerque, NM 87199

RE: 6508 Jade Dr. NW

Revised Grading & Drainage Plan Engineer's Stamp Date: 02/23/23

Hydrology File: E10D113

Dear Mr. Soule:

PO Box 1293

Based upon the information provided in your submittal received 02/27/2023, **the Revised Grading & Drainage Plan is not approved for Building Permit**. The following comments need to be addressed for approval of the above referenced project:

Albuquerque

NM 87103

www.cabq.gov


1. There is an existing 25-foot Public Drainage Easement along the rear Property line that is not shown (The Plat was filed 11-1-1967 in Vol 3, Folio 175). Both the proposed house and proposed pool is within this easement. (see below the trench prism layout that was done during the DRB application PR-2022-006614 for a vacation of this easement which was withdrawn by the applicant in June 2022. This property was previously approved with an incorrect Grading & Drainage Plan which did not show this easement on March 29, 2022. At the DRB, the applicant was informed that the house which encroaches about 10 feet into the existing 25-foot Public Drainage Easement would need to be relocated outside of the easement. Please note that since this did not happen, Hydrology will not be able to approve the house for Permanent Certificate of Occupancy.

CITY OF ALBUQUERQUE

Planning Department Alan Varela, Director



Mayor Timothy M. Keller

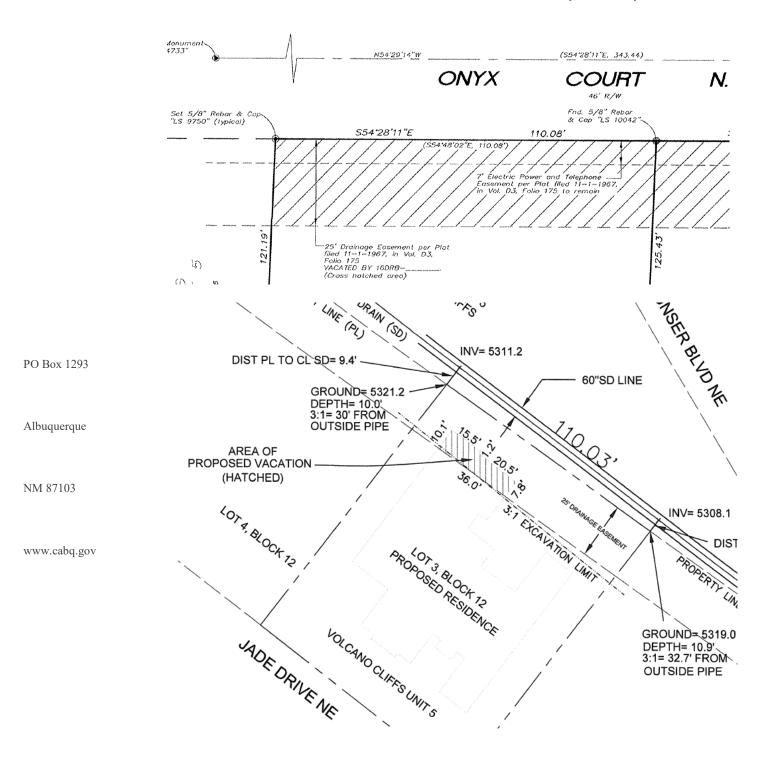

CITY OF ALBUQUERQUE

Planning Department Alan Varela, Director



Mayor Timothy M. Keller

10. PR-2022-006614 SD-2022-00079 – VACATION OF PUBLIC COMMUNITY SCIENCES CORPORATION agent for MICHAEL & EMILY CISNEROS requests the aforementioned action(s) for all or a portion of: LOT 3 BLOCK 12 UNIT 5, VOLCANO CLIFFS zoned R-1D, located at 6508 JADE DR NW between EMERALD DR NW and 81st NW containing approximately 0.3435 acre(s). (E-10) [Deferred from 5/25/22, 6/8/22]

PROPERTY OWNERS: HANNA JOSEPHINE T & HANNA MARK E REQUEST: VACATE EXISTING 25' DRAIN. EASEMENT IN BACK OF LOT 3

APPLICATION WAS WITHDRAWN BY THE APPLICANT.

If you have any questions, please contact me at 924-3995 or rbrissette@cabq.gov.

Sincerely,

Renée C. Brissette, P.E. CFM Senior Engineer, Hydrology Planning Department

Renée C. Brissette

PO Box 1293

Albuquerque

NM 87103

www.cabq.gov



City of Albuquerque


Planning Department

Development & Building Services Division

DRAINAGE AND TRANSPORTATION INFORMATION SHEET (REV 6/2018)

Project Title: 6508 JADE	NW Building Permit #:	Hydrology File #:
DRB#:	EPC#:	Work Order#:
Legal Description: LOT 3, BLO	OCK 12 VOLCANO CLIF	FS UNIT 24
City Address: 6508 JADE		
Applicant:		Contact:
Address:		
Phone#:	Fax#:	E-mail:
Other Contact: RIO GRANDE EN	GINEERING	Contact: DAVID SOULE
Address: PO BOX 93924 ALB		
		E-mail: david@riograndeengineering.com
		DRB SITE ADMIN SITE
Check all that Apply:		
DEPARTMENT: X HYDROLOGY/ DRAINAGE TRAFFIC/ TRANSPORTATION TYPE OF SUBMITTAL: ENGINEER/ARCHITECT CERTIFIC PAD CERTIFICATION CONCEPTUAL G & D PLAN X GRADING PLAN DRAINAGE REPORT DRAINAGE MASTER PLAN FLOODPLAIN DEVELOPMENT PER ELEVATION CERTIFICATE CLOMR/LOMR TRAFFIC CIRCULATION LAYOUT TRAFFIC IMPACT STUDY (TIS) STREET LIGHT LAYOUT OTHER (SPECIFY) PRE-DESIGN MEETING? IS THIS A RESUBMITTAL?: X Yes	ATION RMIT APPLIC (TCL)	E OF APPROVAL/ACCEPTANCE SOUGHT: BUILDING PERMIT APPROVAL CERTIFICATE OF OCCUPANCY PRELIMINARY PLAT APPROVAL SITE PLAN FOR SUB'D APPROVAL SITE PLAN FOR BLDG. PERMIT APPROVAL FINAL PLAT APPROVAL SIA/ RELEASE OF FINANCIAL GUARANTEE FOUNDATION PERMIT APPROVAL GRADING PERMIT APPROVAL SO-19 APPROVAL PAVING PERMIT APPROVAL GRADING/ PAD CERTIFICATION WORK ORDER APPROVAL CLOMR/LOMR FLOODPLAIN DEVELOPMENT PERMIT OTHER (SPECIFY)
	*	
COA STAFF:		L RECEIVED:

FEE PAID:_____

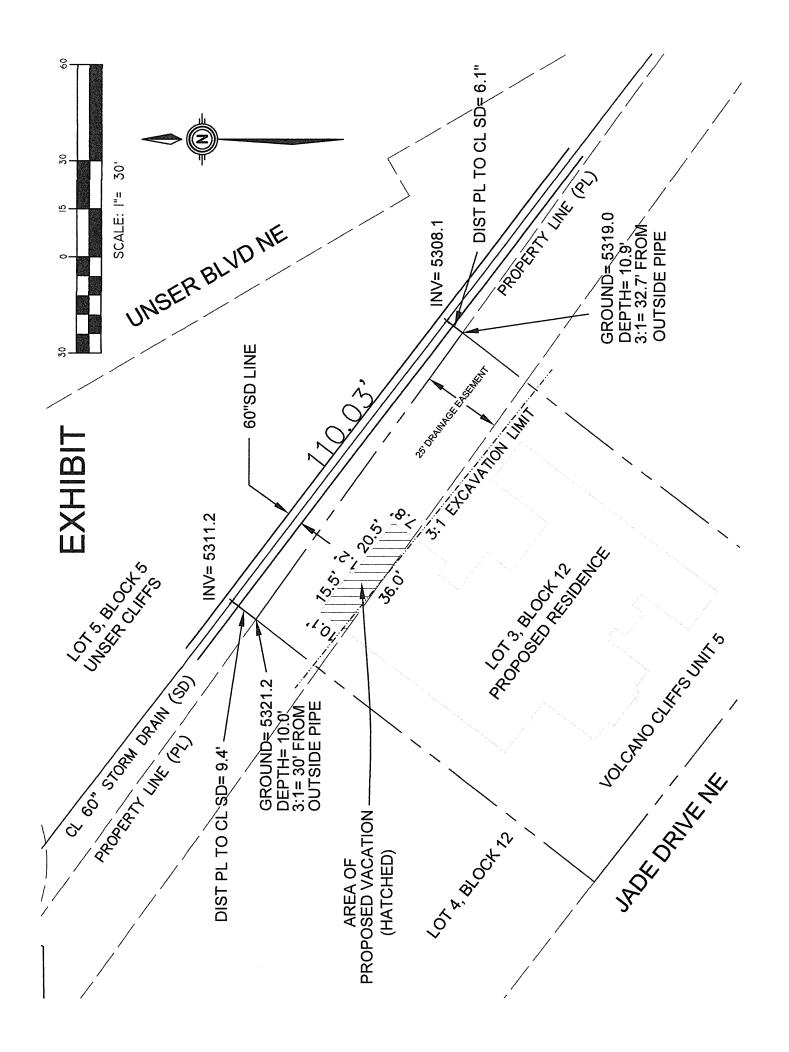

Weighted E Method 100-Year, 6-hr. 24 hour Area | Area | Treatment A | Treatment B | Treatment C | Treatment D | Weighted E | Volume | (acres) % (acres) % (acres) % (acres) (ac-ft) (ac-ft) 14982.00 0.344 0% 0 24% 0.083 40% 0.1376 36% 0.124 1.362 0.039 14982.00 0.344 0% 0 20% 0.069 25% 0.086 55% 0.189 1.616 0.046 PROPOSED COMPARISON 0.007 **Equations:** Weighted E = Ea*Aa + Eb*Ab + Ec*Ac + Ed*Ad / (Total Area) Volume = Weighted D * Total Area Flow = Qa * Aa + Qb * Ab + Qc * Ac + Qd * Ad

Where for 100-year, 6-hour storm- zone 1 Qa= 1.54 Eb= 0.73 Qb= 2.16

Ec= 0.95 Qc= 2.87 Ed= 2.24 Qd= 4.12

ONSITE Conditions FIRST FLUSH WATER QUALITY VOLUME

PROVIDED REQUIRED (CF) 752 WATER QUALITY FLOOD CONTROL 752

Narrative

This site is within the SAD 227Master Drainage plan boundaries. The site is to maintain existing patterns and drain to the adjacent roadway to the north per the master drainage plan. The site does exceed the SAD 227 developed conditions assumptions, therefore ponding of 376cf is required. Due to hight restrictions we have incorporated ponding to minimize the pad height as much as possible. We are ponding the water harvest volume generated by the site. Upland flow does not impact this site. This plan is in conformance to the master drainage plan

I, DAVID SOULE HAVE PERSONALLY INPECTED THE SITE. I HEREBY CERTIFY THE PAD HAS BEEN CONSTRUCTED SUCH THAT IT IS IN SUBSTANTIAL CONFORMANCE TO THE APPROVED GRADING PLAN DATED 11/17/21

REAR YARD

TOP=5319.75

EXISTING WALL

HIGHEST NATURAL GRADE = 5322.12

RETENTION POND TOP = 5320.10

BOTTOM = 5319.85

VOLUME = 36 CF

INSTALL 1-4" PVC PIPE

UNDER DRIVEWAY

INV. IN = 5320.10

NV. OUT = 5320.05

RETENTION POND

BOTTOM=5318.25 VOL=189CF

EARTHEN SWALE

LOWEST NATURAL

FP = 5320.85 AVERAGE NATURAL

GRADE = 5320.33

CRB1 END 5318.74 5319.36

GRADE = 5318.55



EXPOSE WEEP HOLES IN

EXISTING

EXISTING

EARTHEN

RETENTION POND TOP = 5319.99BOTTOM = 5319.00 VOLUME =485CF

INSTALL 12 LF OF 4" PIPE THROUIGHT CURB PPER COA STD DTW 2225

INV. IN = 5319.99 INV. OUT = 5319.85

EROSION CONTROL NOTES:

REAR YARD

TOP=5319.75

VOL=42CF

NEW POOL WITH DECK

DECK=5320.25

DECK TRENCH

GRATE=5320.10

CONSTRUCT ALL SWALES AND EROSION PROTECTION (SHOWN HATCHED) BELOW ADJACENT GRADE TO ENDSURE RUNOFF CAN BE CAPTURED AND CONVEYED PROPERLY.

EARTHEN SWALE

PLACE 2" LAYER OF

GRAVEL AT FLOW LINE


RETENTION POND

BOTTOM=5318.75

- 1. CONTRACTOR IS RESPONSIBLE FOR OBTAINING A TOPSOIL DISTURBANCE PERMIT PRIOR TO BEGINNING WORK.
- 2. CONTRACTOR IS RESPONSIBLE FOR MAINTAINING RUN-OFF ON SITE DURING CONSTRUCTION.
- 3. CONTRACTOR IS RESPONSIBLE FOR CLEANING ALL SEDIMENT THAT GETS INTO EXISTING RIGHT-OF-WAY.
- 4. REPAIR OF DAMAGED FACILITIES AND CLEANUP OF SEDIMENT ACCUMULATIONS ON ADJACENT PROPERTIES AND IN PUBLIC FACILITIES IS THE RESPONSIBILITY OF THE CONTRACTOR.
- 5. ALL EXPOSED EARTH SURFACES MUST BE PROTECTED FROM WIND AND WATER EROSION PRIOR TO FINAL ACCEPTANCE OF ANY PROJECT.





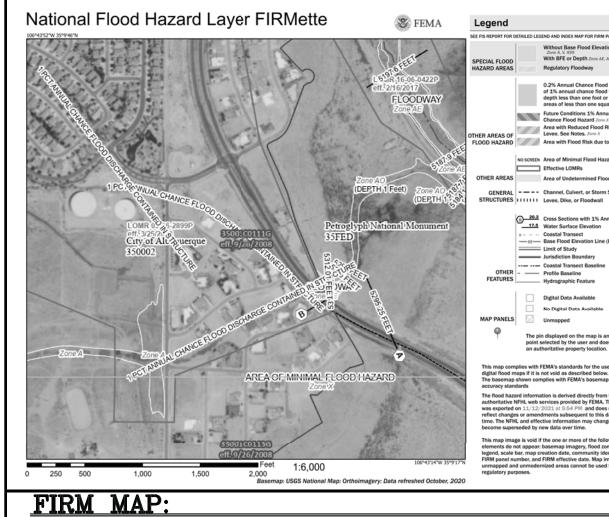

LEGAL DESCRIPTION:

LOT 3, BLOCK 12 VOLCANO CLIFFS UNIT 24

NOTES:


- 1. ALL SPOT ELEVATIONS REPRESENT FLOWLINE ELEVATION UNLESS OTHERWISE NOTED.
- 2. ALL SLOPES SHALL BE 3:1 MAX. AND GRAVEL OR NATIVE SEEDING PRIOR TO CO.
- 3. ANY PERIMETER WALLS MUST BE PERMITED SEPARATELY ALL RETAINING WALL DESIGN SHALL BE BY OTHERS.
- DATUM 1988.

4. SURVEY INFORMATION PROVIDED BY COMMUNITY SCIENCES CORPORATION USING NAVD

5. A PAD ELEVATION CERTIFICATION SHALL BE REQUIRED PRIOR TO RELEASE OF BUILDING

LEGEND

XXXX	EXISTING CONTOUR
XXXX	EXISTING INDEX CONTOUR
XXXX -	PROPOSED CONTOUR
—XXXX—	PROPOSED INDEX CONTOUR
× XXXX	EXISTING SPOT ELEVATION
● XXXX	PROPOSED SPOT ELEVATION
	BOUNDARY
	ADJACENT BOUNDARY
=========	EXISTING CURB AND GUTTER
	PROPOSED EARTHEN SWALE
	PROPOSED CONCRETE

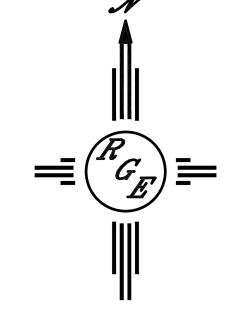




DAVID SOULE

P.E. #14522

ADDED POOL, UPDATED CALCULATIONS

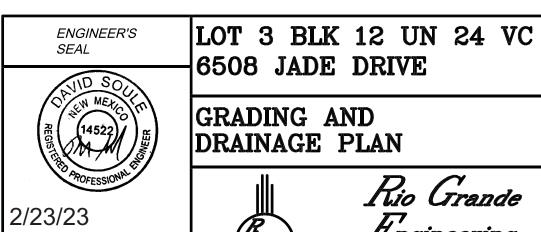

11/17/2

6508 JADE DRIVE GRADING AND

DRAINAGE PLAN

Rio Grande Lingineering PO BOX 93924 ALBUQUERQUE, NM 87199

(505) 321-9099

DRAWN

 BY DEM

DATE

11-16-21

6508 Jade Dr .DWG

SHEET#

C1

JOB#

SCALE: 1"=20'

CAUTION:

EXISTING UTILITIES ARE NOT SHOWN. IT SHALL BE THE SOLE RESPONSIBILITY OF THE CONTRACTOR TO CONDUCT ALL **NECESSARY FIELD INVESTIGATIONS PRIOR** TO ANY EXCAVATION TO DETERMINE THE ACTUAL LOCATION OF UTILITIES & OTHER IMPROVEMENTS.