

EXCEPTION

Plant Schedule

MEDIUM BOULDER

3/4" GREY CRUSHED GRAVEL


2" DEPTH OVER FILTER FABRIC

DESCRIPTION

NATIVE SEEDING

WOOD CHIPS

GRASS PAVERS

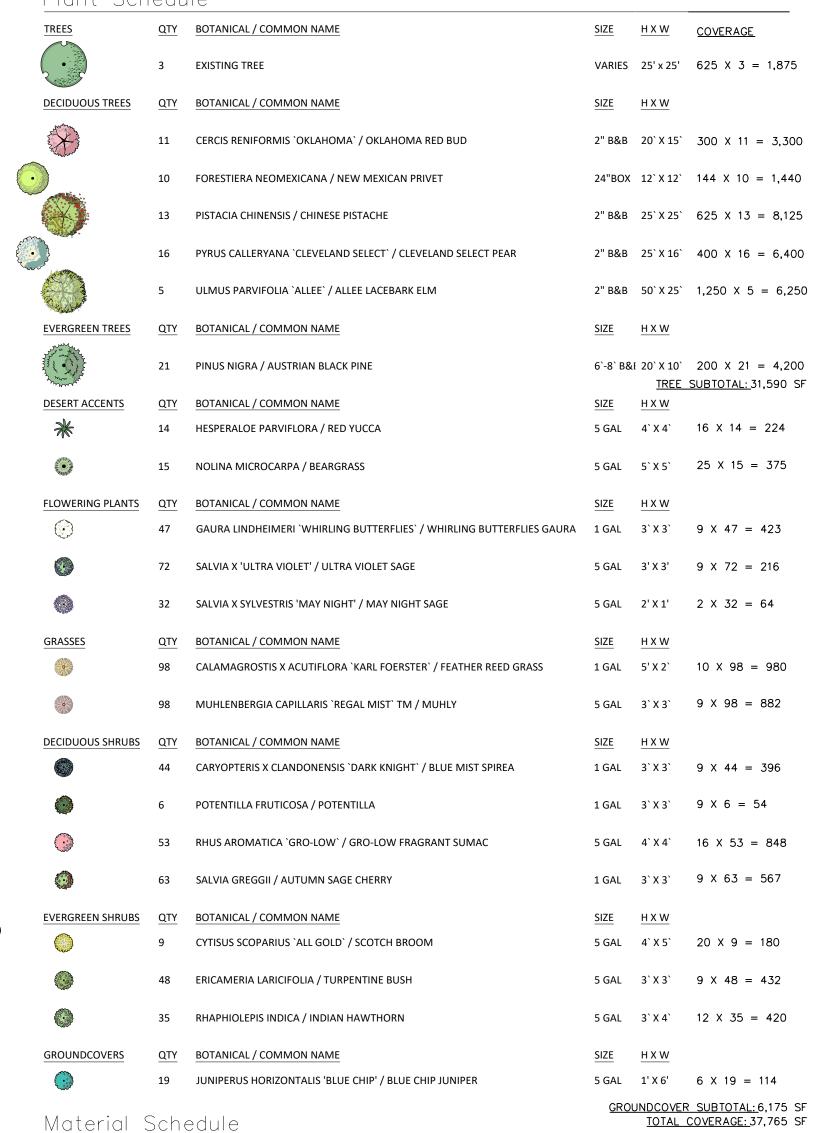

---- LEADER LEFT UNPRUNED

RUBBING, CROSSED OR

DAMAGED BRANCHES ARE REMOVED - TRUNK PROTECTED BY LOOSE TRE

GUARD, REMOVED AFTER ONE YEAR

2/3 NATIVE SOIL AND 1/3 CWA SCREENED

BARK MULCH TO BE USED AS BACKFILL

- PLANTING HOLE 2-3 TIMES ROOT BALL

WIDTH DEPTH SAME AS ROOT BALL

- 2"-3" DEPTH ORGANIC MULCH APPLIED WELL AWAY FROM TRUNI (NO BLACK PLASTIC)

OF BURLAP AND WIRE BASKET

REMOVED, BURLAP SLIT FOR

ROOT EXTENSION

SITE DATA GROSS LOT AREA (3.44 ACRES) ____149,871 SF ____<u>52,938</u> SF LESS BUILDING(S) NET LOT AREA _____96,933 SF REQUIRED LANDSCAPE _____14,540 SF 15% OF NET LOT AREA PROPOSED LANDSCAPE <u>76,671</u> SF PERCENT OF NET LOT AREA <u>79</u> % REQUIRED LANDSCAPE COVERAGE STREET TREES (1 TREE PER 25 LF) PARKING LOT TREES (1 TREE PER 10 SPACES) 3 SITE TREES (1 TREE PER DWELLING UNIT) 57,503 SF LIVE COVERAGE (75% of 76,671) PROVIDED LANDSCAPE COVERAGE STREET TREES PARKING LOT TREES SITE TREES 37,765 SF PLANTING LIVE COVERAGE 42,431 SF NATIVE SEEDING COVERAGE 48,606 SF GROUNDCOVER PLANTING (25% MINIMUM) TOTAL LIVE COVERAGE FOR SITE 80,196 SF (104%)

LEGAL DESCRIPTION: LOT 27A2 SUBDIVISION- TAYLOR RANCH. IDO-ZONE MX-L **GENERAL NOTES**:

1. MAINTENANCE OF THE LANDSCAPE AND IRRIGATION PROVIDED BY THE PROPERTY

2. LANDSCAPE AREAS SHALL BE DEPRESSED TO PROVIDE POSITIVE DRAINAGE FOR SITE RUN OFF. SEE CIVIL DRAWINGS FOR DRAINAGE INFORMATION AND PLACEMENT OF

3. THE LANDSCAPE PLAN IS DESIGNED TO MEET ALL CITY OF ALBUQUERQUE, AND IDO REQUIREMENTS.

4. PLANT MATERIALS AND SIGNING WILL NOT INTERFERE WITH CLEAR SIGHT REQUIREMENTS. THEREFORE SIGNS, WALLS, TREES, AND SHRUBBERY BETWEEN 3 AND 8 FEET TALL (AS MEASURED FROM THE GUTTER PAN) ARE NOT ACCEPTABLE IN 'CLEAR SIGHT' AREAS.

5. THE LANDSCAPE PLAN IS DESIGNED TO COMPLY WITH THE GENERAL IDO LANDSCAPING REGULATIONS(section 14-16-5-6) INCLUDING PROVISION OF A MINIMUM OF 75% LIVE GROUND COVERAGE, MEASURED AT MATURITY, OF ALL REQUIRED LANDSCAPE AREAS, AND A MINIMUM OF 25% REQUIRED VEGETATIVE COVERAGE OF GROUND LEVEL PLANTS.

PLANTINGS NOTES:

1. THE LANDSCAPE DESIGN SHALL COMPLY WITH THE CITY OF ALBUQUERQUE WASTE WATER CONSERVATION, LANDSCAPE, IDO, AND WATER WASTE ORDINANCE.. 2.THE R.O.W. (WHEN DEDICATED TO THE PUBLIC) SHALL BE MAINTAINED BY THE PROPERTY OWNER. THE PLAN SHALL FOLLOW THE COA DESIGN GUIDELINES FOR STREET TREES UNLESS OBSTRUCTED BY UTILITY EASEMENTS. 3. ALL LANDSCAPE AREAS SHALL BE COVERED WITH MULCH. USE GRAVEL MULCH AT

2"-3" DEPTH OVER FILTER FABRIC 4. WHERE MULCH IS ADJACENT TO THE CONCRETE, FINISH GRADE OF MULCH SHALL BE

APPROXIMATELY 1/2" BELOW THE TOP OF CONCRETE. 5. ORGANIC MULCH, SUCH AS WOOD CHIPS OR PECAN SHELLS, IS REQUIRED AS GROUND COVER OVER THE PORTION OF ANY LANDSCAPED AREAS SURROUNDING THE VEGETATION ROOT BALL, AS WELL AS BENEATH THE ENTIRE TREE CANOPY OR DRIPLINE

, IN EACH REQUIRED LANDSCAPE AREA. 6. ALL NATIVE SEED AREA SOILS ARE TO BE AMENDED WITH COMPOST MULCH BEFORE

7. BROWN STEEL EDGING IS TO BE PLACED BETWEEN ALL AREAS OF GRAVEL AND NATIVE SEEDING. BETWEEN AREAS OF GRAVEL AND SOD, OPTIONAL 6" MOW CURB OR GREEN STEEL EDGING IS TO BE PLACED.

IRRIGATION NOTES:

1. ALL NEW PLANTINGS TO BE WATERED BY AUTO DRIP IRRIGATION SYSTEM. 2. WATER MANAGEMENT AND THE MAINTENANCE OF THE IRRIGATION SYSTEM IS THE SOLE RESPONSIBILITY OF THE PROPERTY OWNER.

3. THE IRRIGATION SYSTEM SHALL BE CONNECTED TO CITY WATER. THE POINT OF CONNECTION SHALL CONSIST OF A WATER METER, BACKFLOW PREVENTER, AND


4. USE SIX 2 GPH EMITTERS PER EACH TREE AND TWO 2 GPH EMITTERS PER EACH SHRUB/GROUNDCOVER. USE SIX 2 GPH DRIP EMITTERS PER TREES IN POTS. SEPARATE IRRIGATION ZONES SHALL BE DESIGNED FOR TREES AND SHRUBS/GROUNDCOVERS. 5. ALL NATIVE SEED TO BE SPRAY IRRIGATED.

6. INSTALL THRUST BLOCKS WHEREVER THE MAINLINE BENDS IN NINETY DEGREE

7. INSTALL SLEEVES TWO SIZES LARGER THAN THE SLEEVED PIPE UNDER ALL HARD SURFACES.

8. THE BACKFLOW SIZE AND LOCATION IS ASSUMED ONLY, BASED ON THE LATEST AVAILABLE UTILITY PLAN. GENERAL CONTRACTOR TO PROVIDE THE IRRIGATION WATER STUB OUT AND ELECTRICITY FOR THE HOTBOX.

9. ALL SLEEVES ARE ASSUMED TO BE PLACED PRIOR HARDSCAPE WITHOUT THE NEED OF BORING.

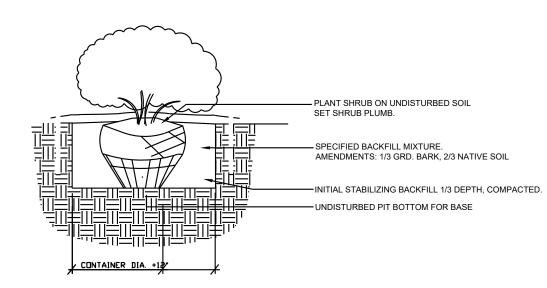

N.T.S.

SHRUB PLANTING DETAIL

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Date: <u>1/13/2022</u> Revisions: Drawn by: RC Reviewed by: <u>CM</u>

7 0

NORTH

Scale: 1" = 30'

Sheet Title:

Landscape Plan

Sheet Number: