
CITY OF ALBUQUERQUE

Planning Department Alan Varela, Director

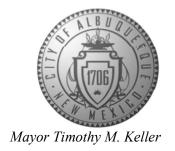

March 11, 2025

David Soule, P.E. Rio Grande Engineering P.O. Box 93924 Albuquerque, NM 87199

RE: 6624 mojave St NW

Grading and Drainage Plan Engineer's Stamp Date: 3/5/25 Hydrology File: E11D033 Case # HYDR-2025-00074

Dear Mr. Soule:

PO Box 1293

Based upon the information provided in your submittal received 06/06/2025, the Grading & Drainage Plan is approved for Building Permit and Grading Permit. Please attach a copy of this approved plan in the construction sets for Building Permit processing along with a copy of this letter.

Albuquerque

PRIOR TO CERTIFICATE OF OCCUPANCY:

NM 87103

1. Engineer's Certification, per the DPM Part 6-14 (F): *Engineer's Certification Checklist For Non-Subdivision* is required.

www.cabq.gov

As a reminder, if the project total area of disturbance (including the staging area and any work within the adjacent Right-of-Way) is 1 acre or more, then an Erosion and Sediment Control (ESC) Plan and Owner's certified Notice of Intent (NOI) is required to be submitted to the Stormwater Quality Engineer (Doug Hughes, PE, jhughes@cabq.gov, 505-924-3420) 14 days prior to any earth disturbance.

If you have any questions, please contact me at 505-924-3314 or amontoya@cabq.gov.


Sincerely,

Anthony Montoya, Jr., P.E., CFM

Senior Engineer, Hydrology


anth Mars

Planning Department, Development Review Services

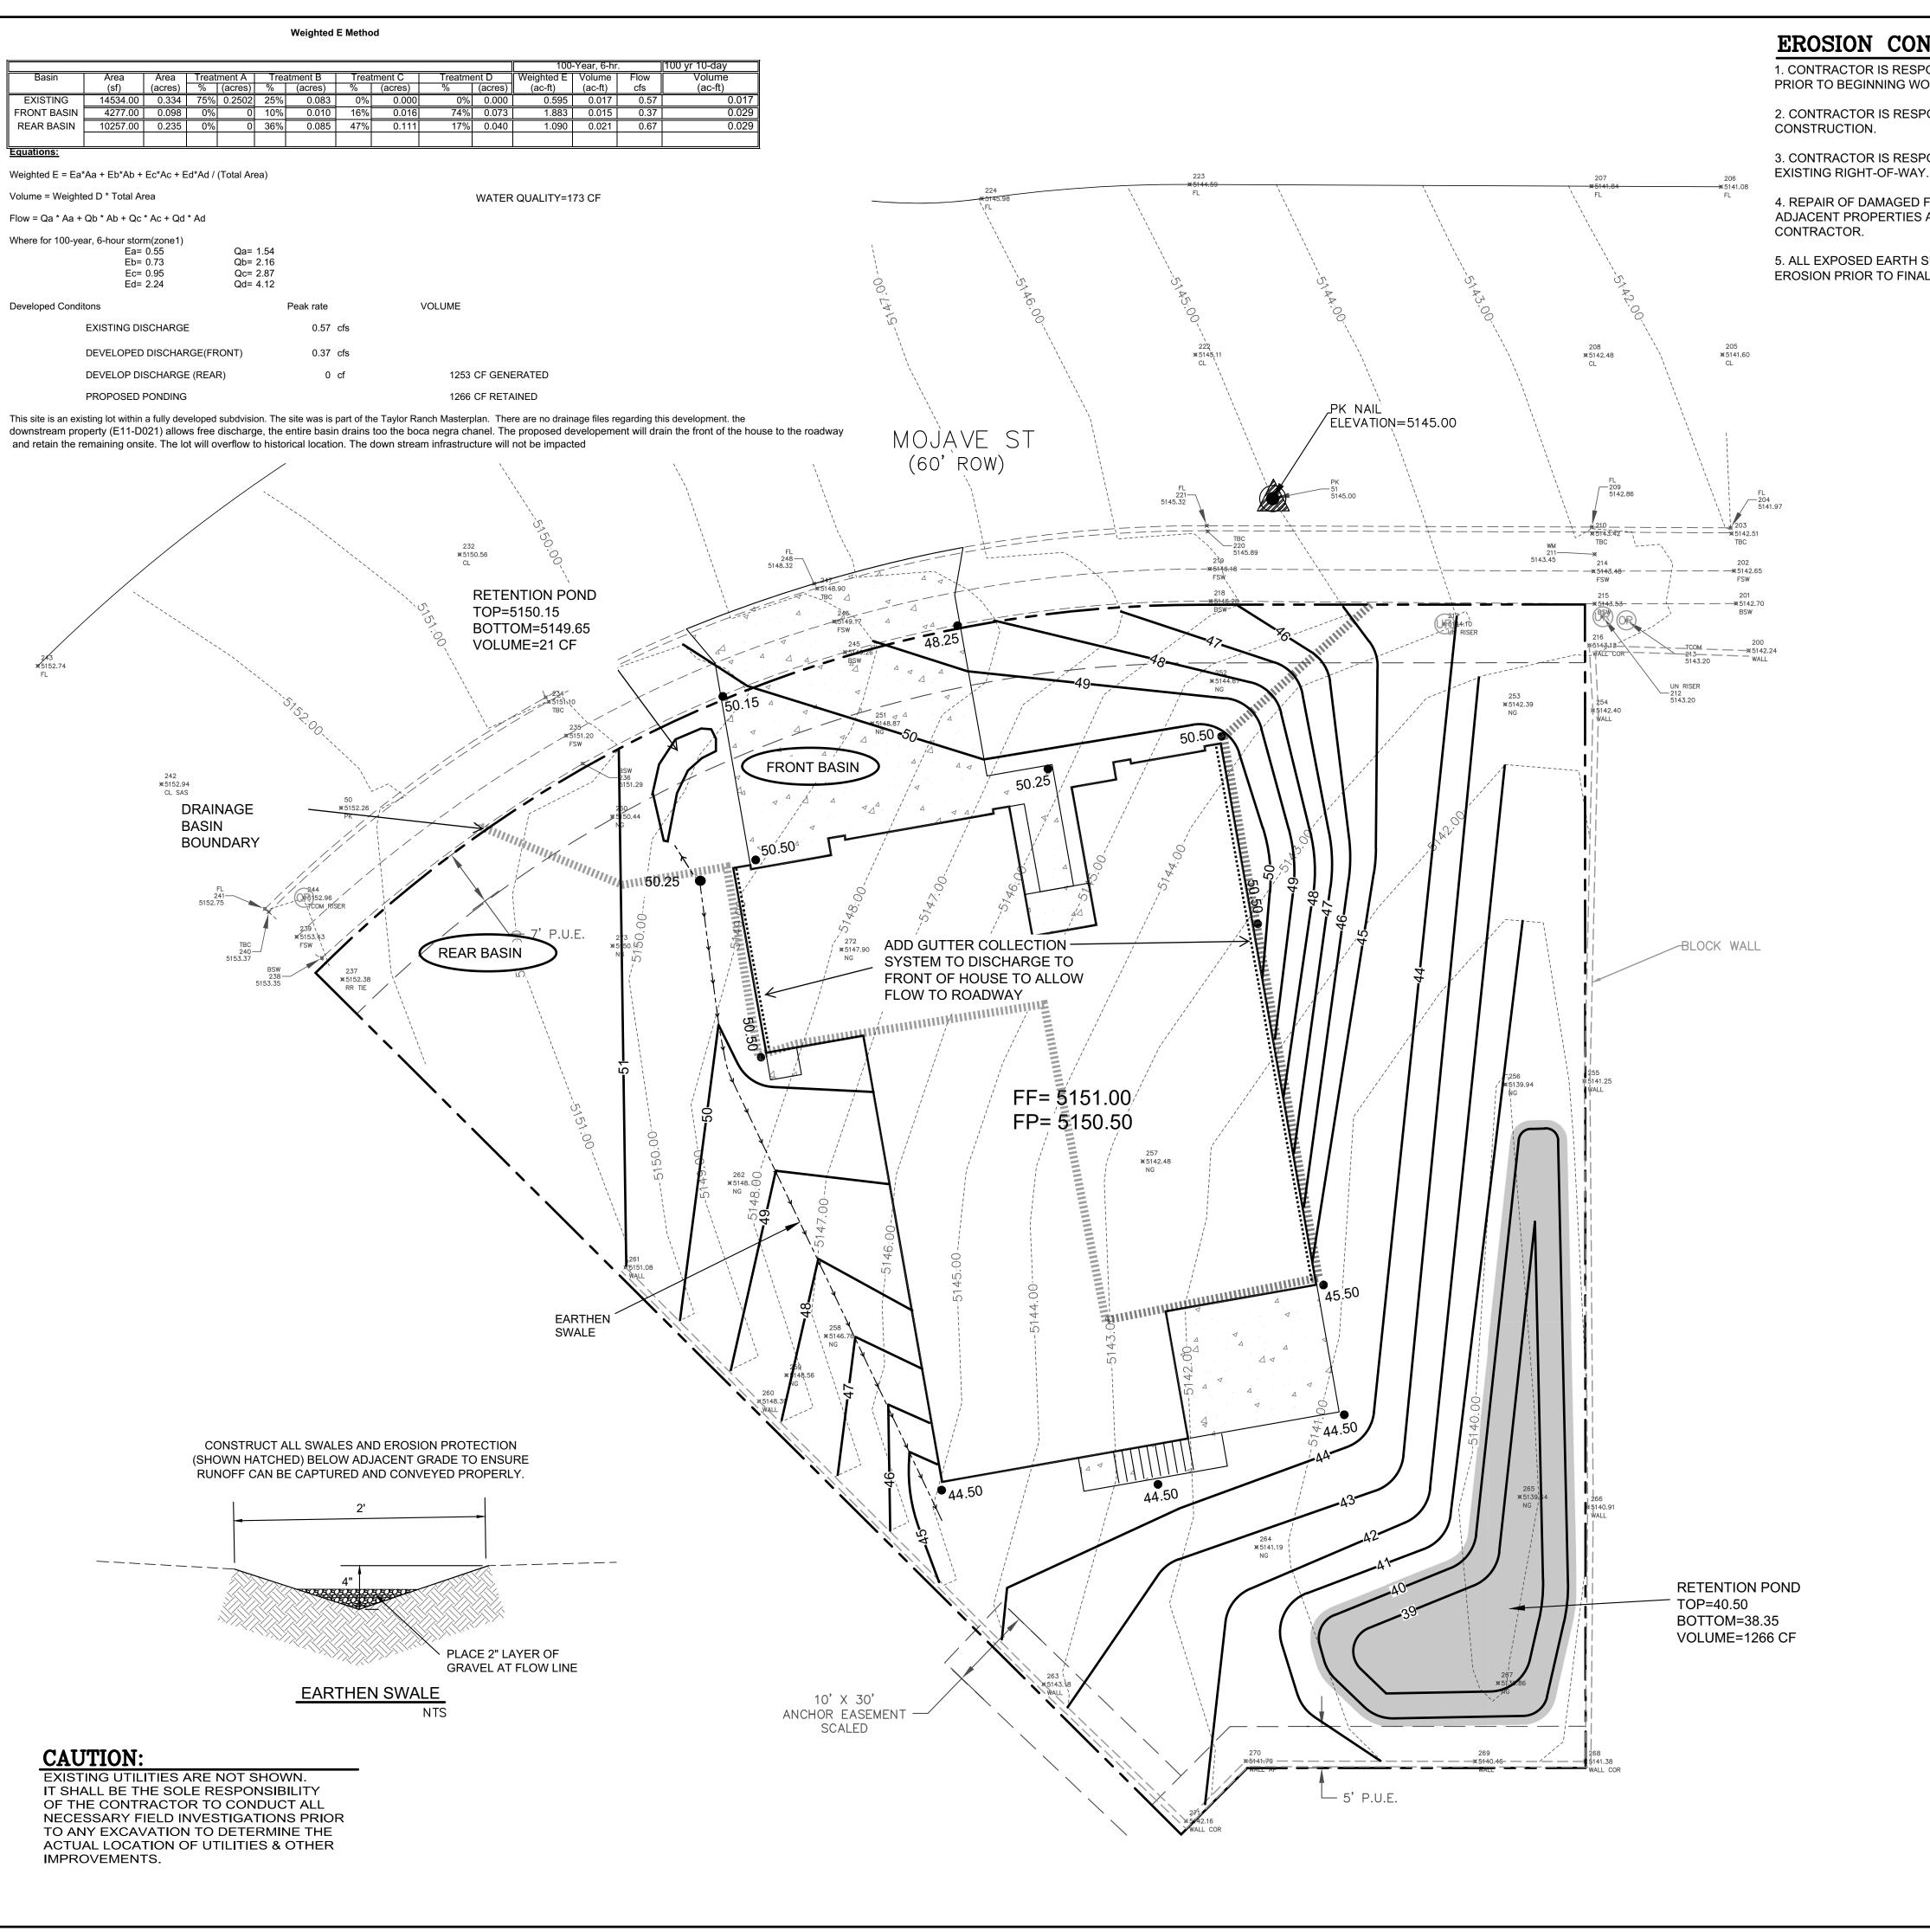

EROSION CONTROL NOTES:

- 1. CONTRACTOR IS RESPONSIBLE FOR OBTAINING A TOPSOIL DISTURBANCE PERMIT PRIOR TO BEGINNING WORK.
- 2. CONTRACTOR IS RESPONSIBLE FOR MAINTAINING RUN-OFF ON SITE DURING
- 3. CONTRACTOR IS RESPONSIBLE FOR CLEANING ALL SEDIMENT THAT GETS INTO
- 4. REPAIR OF DAMAGED FACILITIES AND CLEANUP OF SEDIMENT ACCUMULATIONS ON ADJACENT PROPERTIES AND IN PUBLIC FACILITIES IS THE RESPONSIBILITY OF THE
- 5. ALL EXPOSED EARTH SURFACES MUST BE PROTECTED FROM WIND AND WATER EROSION PRIOR TO FINAL ACCEPTANCE OF ANY PROJECT.

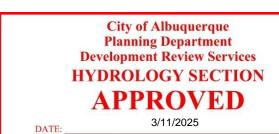

anth Mars E11D033 HvdroTrans #

THE APPROVAL OF THESE PLANS/REPORTS SHALL NOT BE CONSTRUED TO PERMIT VIOLATIONS OF ANY CITY ORDINANCE OR STATE LAW, AND SHALL NOT PREVENT THE CITY OF ALBUQUERQUE FROM REQUIRING CORRECTIONS FOR ERRORS OR DIMENSIONS IN PLANS, SPECIFICATIONS, THE APPROVAL OF THESE PLANS/REPORTS SHALL EXPIRE TWO (2)



Effective LOMRs

VICINITY MAP: D-11-Z



LEGAL DESCRIPTION:

LOT 9, BLOCK 7 VOLCANO CLIFFS SUBDIVISION CITY OF ALBUQUERQUE, BERNALILLO COUNTY, NEW MEXICO


- 1. ALL SPOT ELEVATIONS REPRESENT FLOWLINE ELEVATION UNLESS OTHERWISE NOTED.
- 2. ALL SLOPES SHALL BE 3:1 MAX. AND GRAVEL OR NATIVE SEEDING PRIOR TO CO.
- 3. ANY PERIMETER WALLS MUST BE PERMITED SEPARATELY ALL RETAINING WALL DESIGN SHALL BE BY OTHERS.
- 5. LONG TERM MAINTAINANCE OF ALL PONDS, SWALES AND OVERFLOWS IS REQUIRED

EXISTING CONTOUR ----XXXX------- EXISTING INDEX CONTOUR -----XXXX-----—xxxx PROPOSED CONTOUR PROPOSED INDEX CONTOUR EXISTING SPOT ELEVATION * XXXX XXXX PROPOSED SPOT ELEVATION BOUNDARY — — — — ADJACENT BOUNDARY ≡≡≡≡≡≡≡≡≡≡ EXISTING CURB AND GUTTER PROPOSED EARTHEN SWALE PROPOSED RETAINING WALL PROPOSED GRAVEL 4 4 PROPOSED CONCRETE

DAVID SOULE P.E. #14522

SCALE: 1"=10'

PROPOSED 2' WIDE COBBLE SWALE

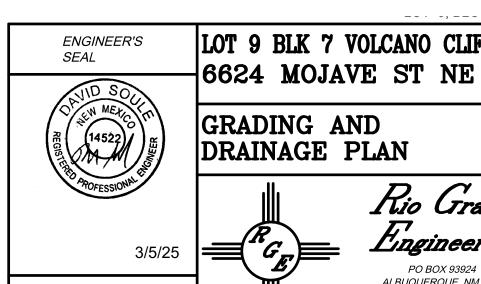

LOT 9 BLK 7 VOLCANO CLIFFS SUB DRAWN BY DEM DATE *3-4-25* 6624 Mojave St NE.dwg Rio Grande SHEET# C1 Lingineering PO BOX 93924 ALBUQUERQUE, NM 87199 (505) 321-9099 JOB#

- USING NAVD DATUM 1988.

4. SURVEY INFORMATION PROVIDED BY DYNAMIC CONSTRUCTION AND TECHNOLOGY LLC

- 6. A PAD ELEVATION CERTIFICATION SHALL BE REQUIRED PRIOR TO RELEASE OF BUILDING

LEGEND