

City of Albuquerque

Planning Department

Development & Building Services Division


DRAINAGE AND TRANSPORTATION INFORMATION SHEET

(REV 02/2013)

Project Title:	Andalucia Villas		Building Permit #:		City Drainage #: E12/D015C
DRB#:	1004473	EPC#:		Work Order	#:
Legal Description: Tract 6, North Andalucia at La Luz					
City Address: Southeast corner of Oak St and Central Ave.					
Engineering Firm: Bohannan Huston, Inc.				Contact: Gle	enn Broughton
0 0	500 Jefferson St NE Courtyard 1 Albuque	raue NM 87109		Comaci. On	Sim Broughton
Phone#: (505		Fax#: (505)		F-mail: obro	oughton@bhinc.com
Thones. (ooc	7,020 1000	1 axii. (666)	100 1000	L-man. gove	<u> </u>
Owner: An	dalucia Villas			Contact: Ro	bert Aiello
	O. Box 6155 Bossier City, LA 71171				
Phone#: (318	3) 742-6677	Fax#:		E-mail: aiell	loturner@aol.com
Architect:				Contact:	
Address:					
Phone#:		Fax#:		E-mail:	
Surveyor:				Contact:	
Address:					
Phone#:		Fax#:		E-mail:	
Contractor:				Contact:	
Address:					
Phone#:		Fax#:		E-mail:	
TYPE OF SUBMITTAL: CHECK TYPE OF APPROVAL/ACCEPTANCE SOUGHT:					
	NAGE REPORT		SIA/FINANCIAL GUARAN		
	NAGE PLAN 1st SUBMITTAL		PRELIMINARY PLAT APPR		, L
	NAGE PLAN RESUBMITTAL		S. DEV. PLAN FOR SUB'D		
	EPTUAL G & D PLAN		S. DEV. FOR BLDG. PERMI		
	ING PLAN		SECTOR PLAN APPROVAL		Requesting
	ON & SEDIMENT CONTROL PL	AN (ESC)	FINAL PLAT APPROVAL	_	Permanent CO for
	NEER'S CERT (HYDROLOGY)	in (ESC)	× CERTIFICATE OF OCCUPA	NCV (PERM	Buildings 1 and 24
	R/LOMR		CERTIFICATE OF OCCUPA	•	·
	FIC CIRCULATION LAYOUT (TO	'T)	FOUNDATION PERMIT AP	•	EWII)
	NEER'S CERT (TCL)	.L)	BUILDING PERMIT APPRO		
ENGINEER'S CERT (DRB SITE PLAN)			GRADING PERMIT APPRO		SO-19 APPROVAL
ENGINEER'S CERT (DRD SITE FLAN) ENGINEER'S CERT (ESC)				-	ESC PERMIT APPROVAL
SO-19			PAVING PERMIT APPROVAL WORK ORDER APPROVAL ESC CERT. ACCEPTANCE		
OTHER (SPECIFY)			GRADING CERTIFICATION OTHER (SPECIFY)		
OTHE	K (SI ECIF I)		GRADING CERTIFICATION		_ OTHER (SPECIFI)
WAS A PRE-DESIGN CONFERENCE ATTENDED: Yes No Copy Provided					
DATE SUBM	IITTED: October 23, 2014		By: Glenn Broughton		

Requests for approvals of Site Development Plans and/or Subdivision Plats shall be accompanied by a drainage submittal. The particular nature, location, and scope to the proposed development defines the degree of drainage detail. One or more of the following levels of submittal may be required based on the following

- 1. Conceptual Grading and Drainage Plan: Required for approval of Site Development Plans greater than five (5) acres and Sector Plans
- 2. Drainage Plans: Required for building permits, grading permits, paving permits and site plans less than five (5) acres
- 3. **Drainage Report**: Required for subdivision containing more than ten (10) lots or constituting five (5) acres or more
- 4. **Erosion and Sediment Control Plan:** Required for any new development and redevelopment site with 1-acre or more of land disturbing area, including project less than 1-acre than are part of a larger common plan of development

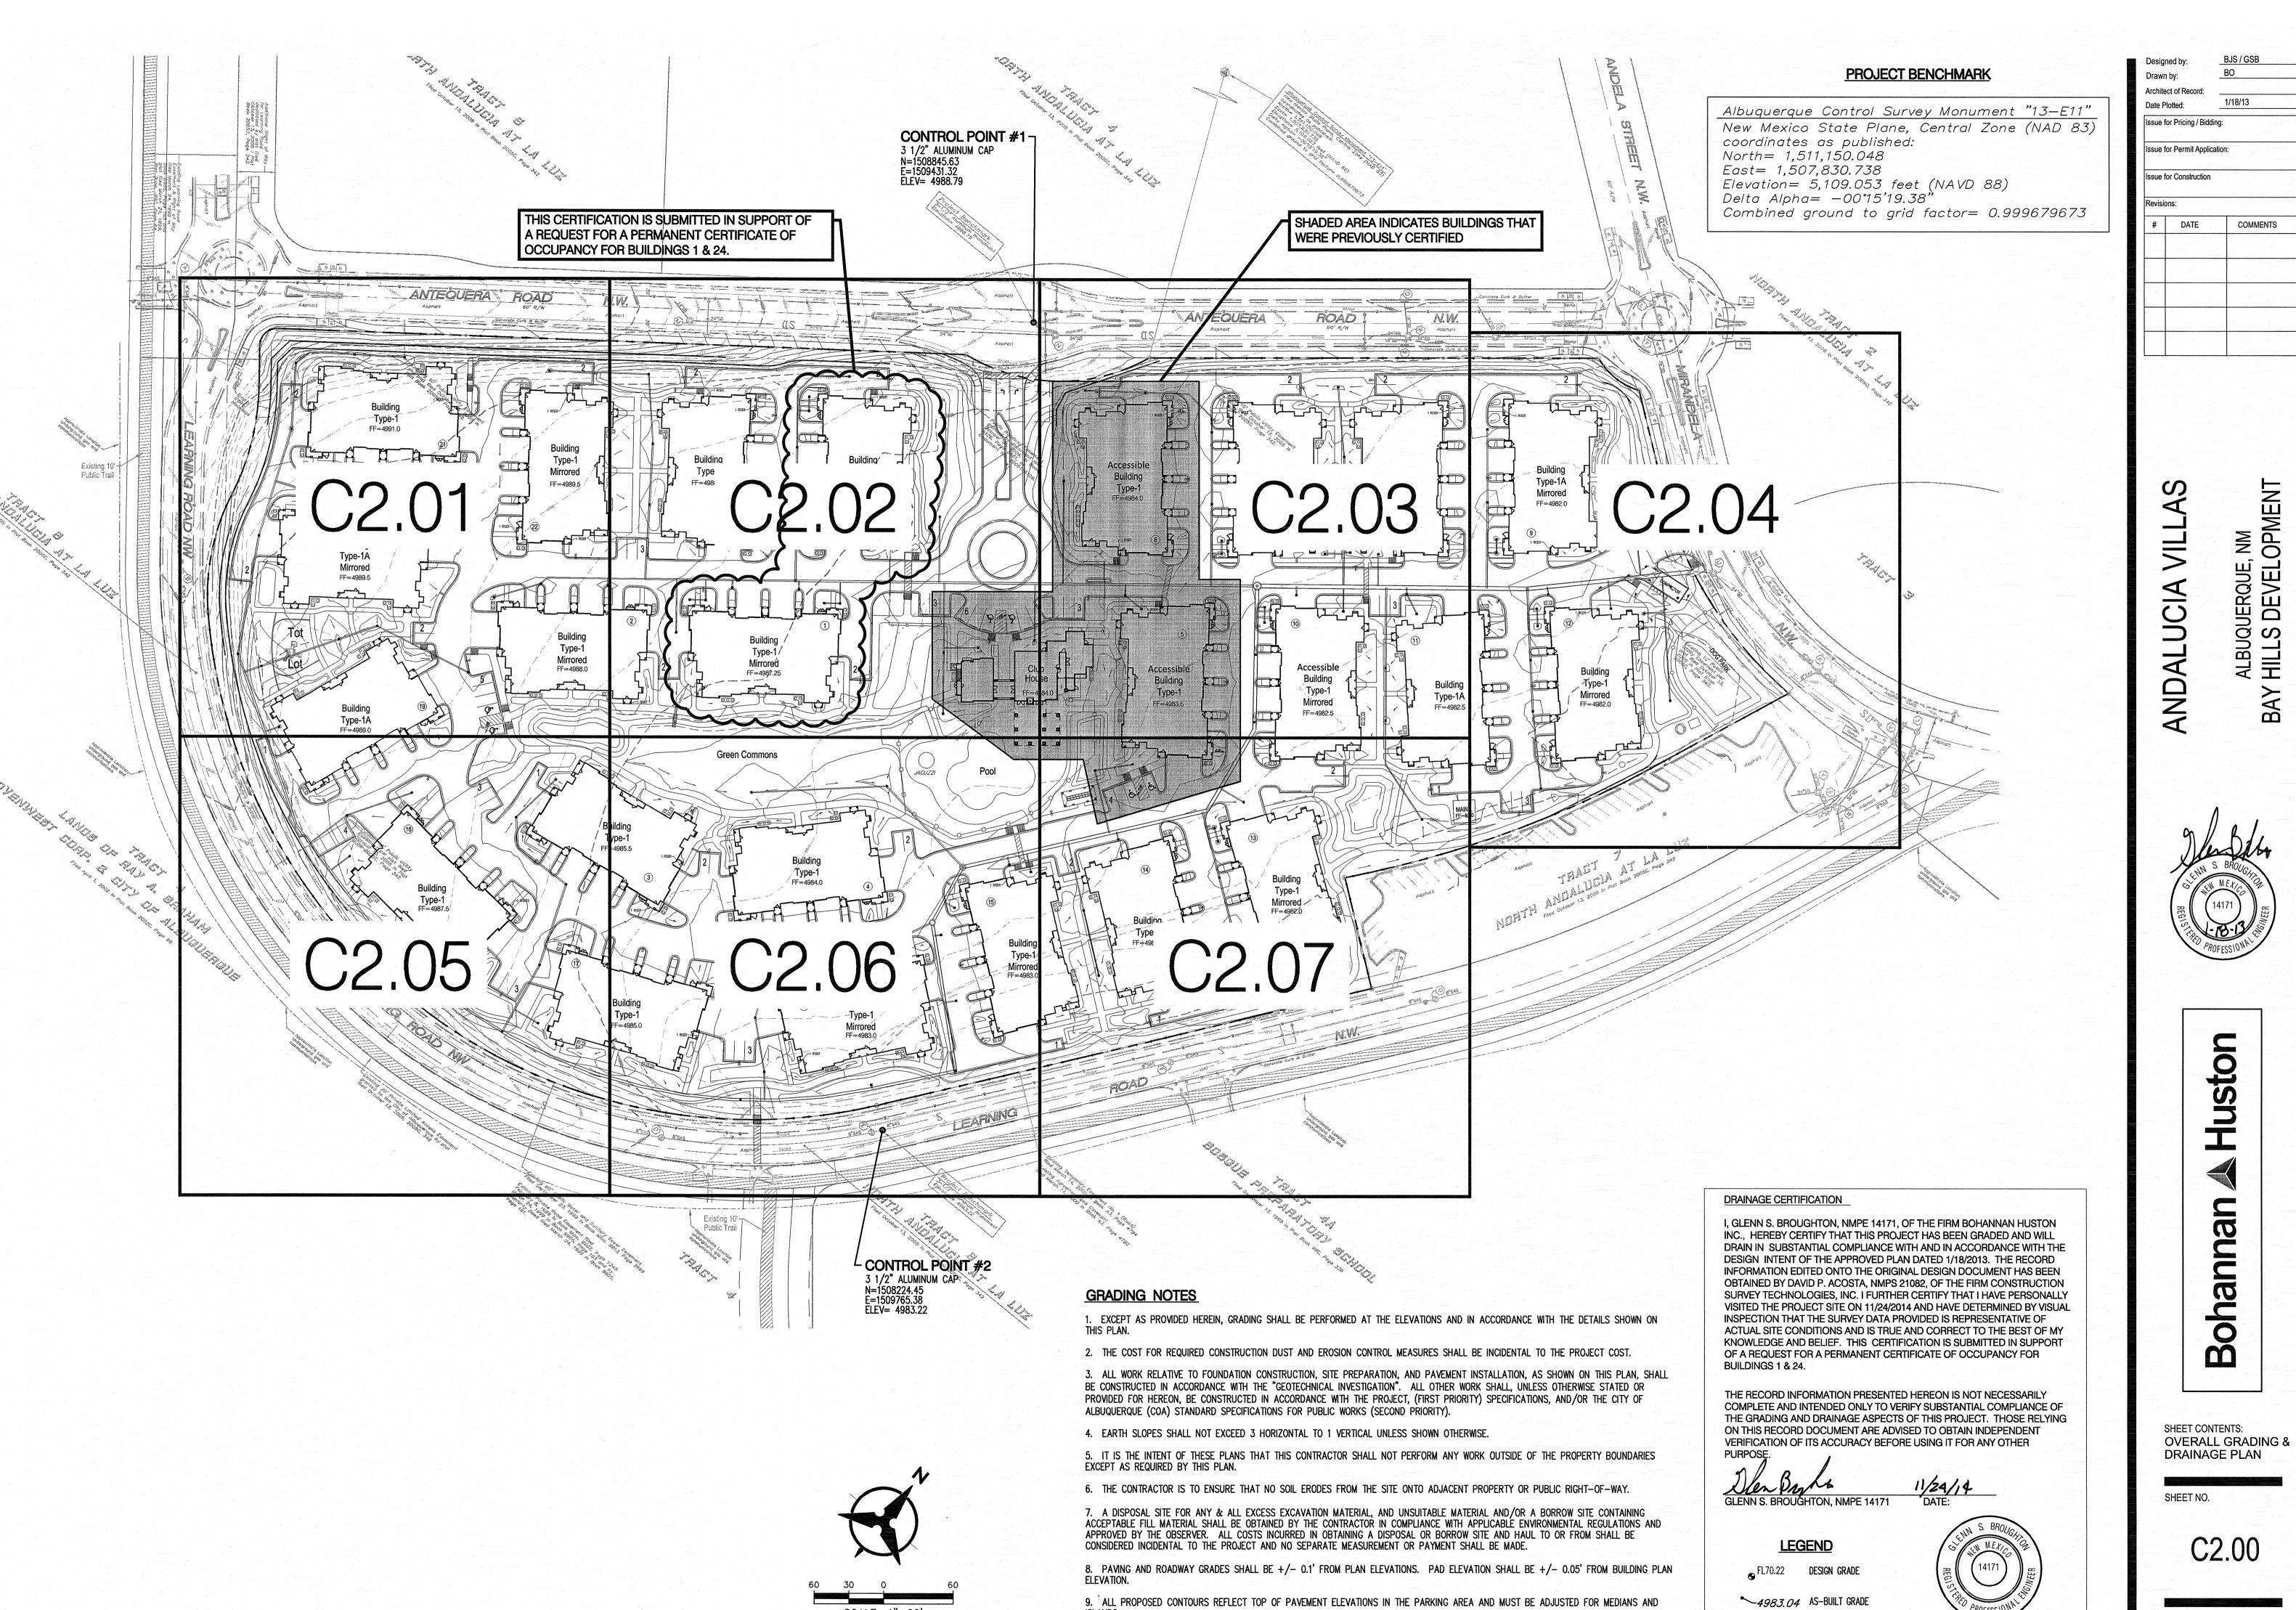

10. VERIFY ALL ELEVATIONS SHOWN ON PLAN FROM BASIS OF ELEVATION CONTROL STATION PRIOR TO BEGINNING CONSTRUCTION.

SCALE: 1"=60'

COMMENTS

GRADING KEYED NOTES

- 1. INSTALL HDPE STORM DRAIN WITH WITH WATER TIGHT JOINTS, SEE PLAN FOR SIZE, SLOPE & INVERT ELEVATIONS.
- 2. INSTALL NYLOPLAST INLINE DRAIN WITH 12" DOMED GRATE.
- 3. INSTALL NYLOPLAST 2'x2' TRAFFIC RATED INLET & GRATE.
- 4. INSTALL PREFABRICATED BEND WITH WATER TIGHT JOINTS.
- 5. INSTALL PREFABRICATED INSERTA TEE.
- 6. CONNECT TO EXISTING STORM DRAIN STUB OUT WITH CONCRETE COLLAR.
- 7. INSTALL 18" WIDE SIDEWALK CULVERT PER COA STD DWG 2236.
- 8. CONSTRUCT 12" WIDE CURB OPENING FOR DRAINAGE.
- 9. INSTALL PREFABRICATED INSERTA WYE.
- 10. INSTALL 4' DIA TYPE "E" STORM DRAIN MANHOLE PER COA STD DWG 2102.
- 11. INSTALL 12" WIDE SIDEWALK CULVERT PER COA STD DWG 2236.
- 12. INSTALL 6' DIA TYPE "E" STORM DRAIN MANHOLE PER COA STD DWG 2102.
- 13. INSTALL 6" SDR-35 PVC PIPE.
- 14. TRANSITION FROM 6" HIGH CURB TO FLUSH CURB.
- 15. MAINTAIN A 4' WIDE PEDESTRIAN WALKWAY WITH A 2.0% MAXIMUM CROSS SLOPE.
- 16. INSTALL NYLOPLAST INLINE DRAIN WITH 8" DOMED GRATE.
- 17. INSTALL NYLOPLAST INLINE DRAIN WITH 18" DOMED GRATE.
- 18. INSTALL NYLOPLAST JUNCTION STRUCTURE.
- 19. INSTALL 4' DIA TYPE "C" STORM DRAIN MANHOLE PER COA STD
- 20. CONSTRUCT 12" WIDE CONCRETE RIBBON CHANNEL PER COA STD DWG 2236, OMIT CHECKERED STEEL PLATE.
- 21. CONSTRUCT 3'-0" WIDE x 12" DEEP RIP-RAP RUNDOWN. 4"-6" ROCK OVER NON-WOVEN FILTER FABRIC.
- 22. INSTALL NYLOPLAST 2'x2' TRAFFIC RATED INLET & GRATE. CONNECT TO SANITARY SEWER SYSTEM. SEE UTILITY PLAN FOR DETAILS.

IN LOCATIONS REQUIRING CURB OPENINGS FOR DRAINAGE (KEYED NOTE 8) THE FINISHED SURFACE OF LANDSCAPE MATERIAL SHALL BE AT EQUAL ELEVATION WITH THE ADJACENT ASPHALT PAVEMENT OR CONCRETE GUTTER.

LEGEND

PROPERTY LINE EXISTING CONTOURS PROPOSED SPOT ELEVATION TC=TOP OF CURB, FL=FLOW LINE TS=TOP OF SIDEWALK, TA=TOP OF ASPHALT EX=EXISTING. FG=FINISHED GRADE TG=TOP OF GRATE, INV=INVERT

FGH=FINISHED GRADE HIGH FGL=FINISHED GRADE LOW PROPOSED DIRECTION OF FLOW S=2.0%

^ WATER BLOCK/RIDGE PROPOSED RETAINING WALL

PROPOSED INTER CONTOURS HEAVY DUTY ASPHALT PAVEMENT PROPOSED PERIMETER FENCE

DRAINAGE CERTIFICATION

I, GLENN S. BROUGHTON, NMPE 14171, OF THE FIRM BOHANNAN HUSTON INC., HEREBY CERTIFY THAT THIS PROJECT HAS BEEN GRADED AND WILL DRAIN IN SUBSTANTIAL COMPLIANCE WITH AND IN ACCORDANCE WITH THE DESIGN INTENT OF THE APPROVED PLAN DATED 1/18/2013. THE RECORD INFORMATION EDITED ONTO THE ORIGINAL DESIGN DOCUMENT HAS BEEN OBTAINED BY DAVID P. ACOSTA, NMPS 21082, OF THE FIRM CONSTRUCTION SURVEY TECHNOLOGIES, INC. I FURTHER CERTIFY THAT I HAVE PERSONALLY VISITED THE PROJECT SITE ON 11/24/2014 AND HAVE DETERMINED BY VISUAL INSPECTION THAT THE SURVEY DATA PROVIDED IS REPRESENTATIVE OF ACTUAL SITE CONDITIONS AND IS TRUE AND CORRECT TO THE BEST OF MY KNOWLEDGE AND BELIEF. THIS CERTIFICATION IS SUBMITTED IN SUPPORT OF A REQUEST FOR A PERMANENT CERTIFICATE OF OCCUPANCY FOR BUILDINGS 1 & 24.

THE RECORD INFORMATION PRESENTED HEREON IS NOT NECESSARILY COMPLETE AND INTENDED ONLY TO VERIFY SUBSTANTIAL COMPLIANCE OF THE GRADING AND DRAINAGE ASPECTS OF THIS PROJECT. THOSE RELYING ON THIS RECORD DOCUMENT ARE ADVISED TO OBTAIN INDEPENDENT VERIFICATION OF ITS ACCURACY BEFORE USING IT FOR ANY OTHER

GLENN S. BROUGHTON, NMPE 14171

LEGEND

DESIGN GRADE

~_4983.04 AS−BUILT GRADE

Issue for Pricing / Bidding: Issue for Permit Application: Issue for Construction COMMENTS

ALBUQUERQUE, NM BAY HILLS DEVELOPMENT



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SHEET CONTENTS: **GRADING & DRAINAGE PLAN**

SHEET NO.

CITY OF ALBUQUERQUE

November 25, 2014



Glenn Broughton, PE Bohannan-Huston 7500 Jefferson St NE Courtyard I Albuquerque, NM 87109

Re: Andalucia Villas

5300 Antequera NW, Buildings 1 and 24

Request Permanent C.O. - Accepted

Engineer's Stamp dated: 1-18-13 (E12D015C)

Certification dated: 11-24-14

Dear Mr. Broughton,

Based on the Certification received 11/24/2014, the site is acceptable for release of Certificate of Occupancy by Hydrology for buildings 1 and 24.

However, the next CO will be held up until a few of the domed inlets are cleaned out.

If you have any questions, you can contact me at 924-3695 or Rudy Rael at 924-3977.

PO Box 1293

Albuquerque

New Mexico 87103

Sincerely,

Curtis Cherne, P.E.

Principal Engineer, Planning Dept. Development and Review Services

www.cabq.gov

RR/CC

C:

email