CITY OF ALBUQUERQUE



June 11, 2015

Glen Broughton, PE Bohannan-Huston 7500 Jefferson St NE Courtyard I Albuquerque, NM 87109

Re: Andalucia Villas 5300 Antequera NW Buildings 7, 8 &10 Request Permanent C.O. – Not Accepted Engineer's Stamp dated: 1-18-14 (E12D15C) Certification dated: 6-8-15

Dear Mr. Broughton,

Based on the Certification received 6/10/2015, the site cannot be accepted for release of Certificate of Occupancy by Hydrology until the following comments are addressed.

PO Box 1293

- Three (3) inlets are missing.
- A manhole was relocated, need new inverts and reason why the relocation. How is maintenance going to be performed in the three way intersection of the storm sewer?

Albuquerque If you have any questions, you can contact me at 924-3695 or Rudy Rael at 924-3977.

New Mexico 87103

www.cabq.gov

Sincerely,

Rita Harmon, P.E. Senior Engineer, Hydrology Planning Department

RR/RH email

C:

Albuquerque - Making History 1706-2006



City of Albuquerque

Planning Department

Development & Building Services Division

DRAINAGE AND TRANSPORTATION INFORMATION SHEET

(REV 02/2013)

Project Title:	Building Permit #:	City Drainage #:
DRB#: EPC#:		Work Order#:
Legal Description:		
City Address:		
Engineering Firm:		Contact:
Address:		
Phone#: Fax#:		E-mail:
Owner:		Contact:
Address:		
Phone#: Fax#:		E-mail:
Architect:		Contact:
Address:		
Phone#: Fax#:		E-mail:
Surveyor:		Contact:
Address:		
Phone#: Fax#:		E-mail:
Contractor:		Contact:
Address:		
Phone#: Fax#:		E-mail:
TYPE OF SUBMITTAL:	CHECK TYPE OF APPROV	AL/ACCEPTANCE SOUGHT:
DRAINAGE REPORT	SIA/FINANCIAL GUARAN	TEE RELEASE
DRAINAGE PLAN 1st SUBMITTAL	PRELIMINARY PLAT APPI	ROVAL
DRAINAGE PLAN RESUBMITTAL	S. DEV. PLAN FOR SUB'D	APPROVAL
CONCEPTUAL G & D PLAN	S. DEV. FOR BLDG. PERMI	IT APPROVAL
GRADING PLAN	SECTOR PLAN APPROVAL	_
EROSION & SEDIMENT CONTROL PLAN (ESC)	FINAL PLAT APPROVAL	
ENGINEER'S CERT (HYDROLOGY)	CERTIFICATE OF OCCUPA	ANCY (PERM)
CLOMR/LOMR	CERTIFICATE OF OCCUPA	ANCY (TCL TEMP)
TRAFFIC CIRCULATION LAYOUT (TCL)	FOUNDATION PERMIT AP	PROVAL
ENGINEER'S CERT (TCL)	BUILDING PERMIT APPRO	DVAL
ENGINEER'S CERT (DRB SITE PLAN)	GRADING PERMIT APPRO	VAL SO-19 APPROVAL
ENGINEER'S CERT (ESC)	PAVING PERMIT APPROV	AL ESC PERMIT APPROVAL
SO-19	WORK ORDER APPROVAL	ESC CERT. ACCEPTANCE
OTHER (SPECIFY)	GRADING CERTIFICATION	N OTHER (SPECIFY)
WAS A PRE-DESIGN CONFERENCE ATTENDED:	Yes No Co	ppy Provided
DATE SUBMITTED:	By:	


Requests for approvals of Site Development Plans and/or Subdivision Plats shall be accompanied by a drainage submittal. The particular nature, location, and scope to the proposed development defines the degree of drainage detail. One or more of the following levels of submittal may be required based on the following


1. Conceptual Grading and Drainage Plan: Required for approval of Site Development Plans greater than five (5) acres and Sector Plans

2. Drainage Plans: Required for building permits, grading permits, paving permits and site plans less than five (5) acres

3. **Drainage Report**: Required for subdivision containing more than ten (10) lots or constituting five (5) acres or more

4. Erosion and Sediment Control Plan: Required for any new development and redevelopment site with 1-acre or more of land disturbing area, including project less than 1-acre than are part of a larger common plan of development

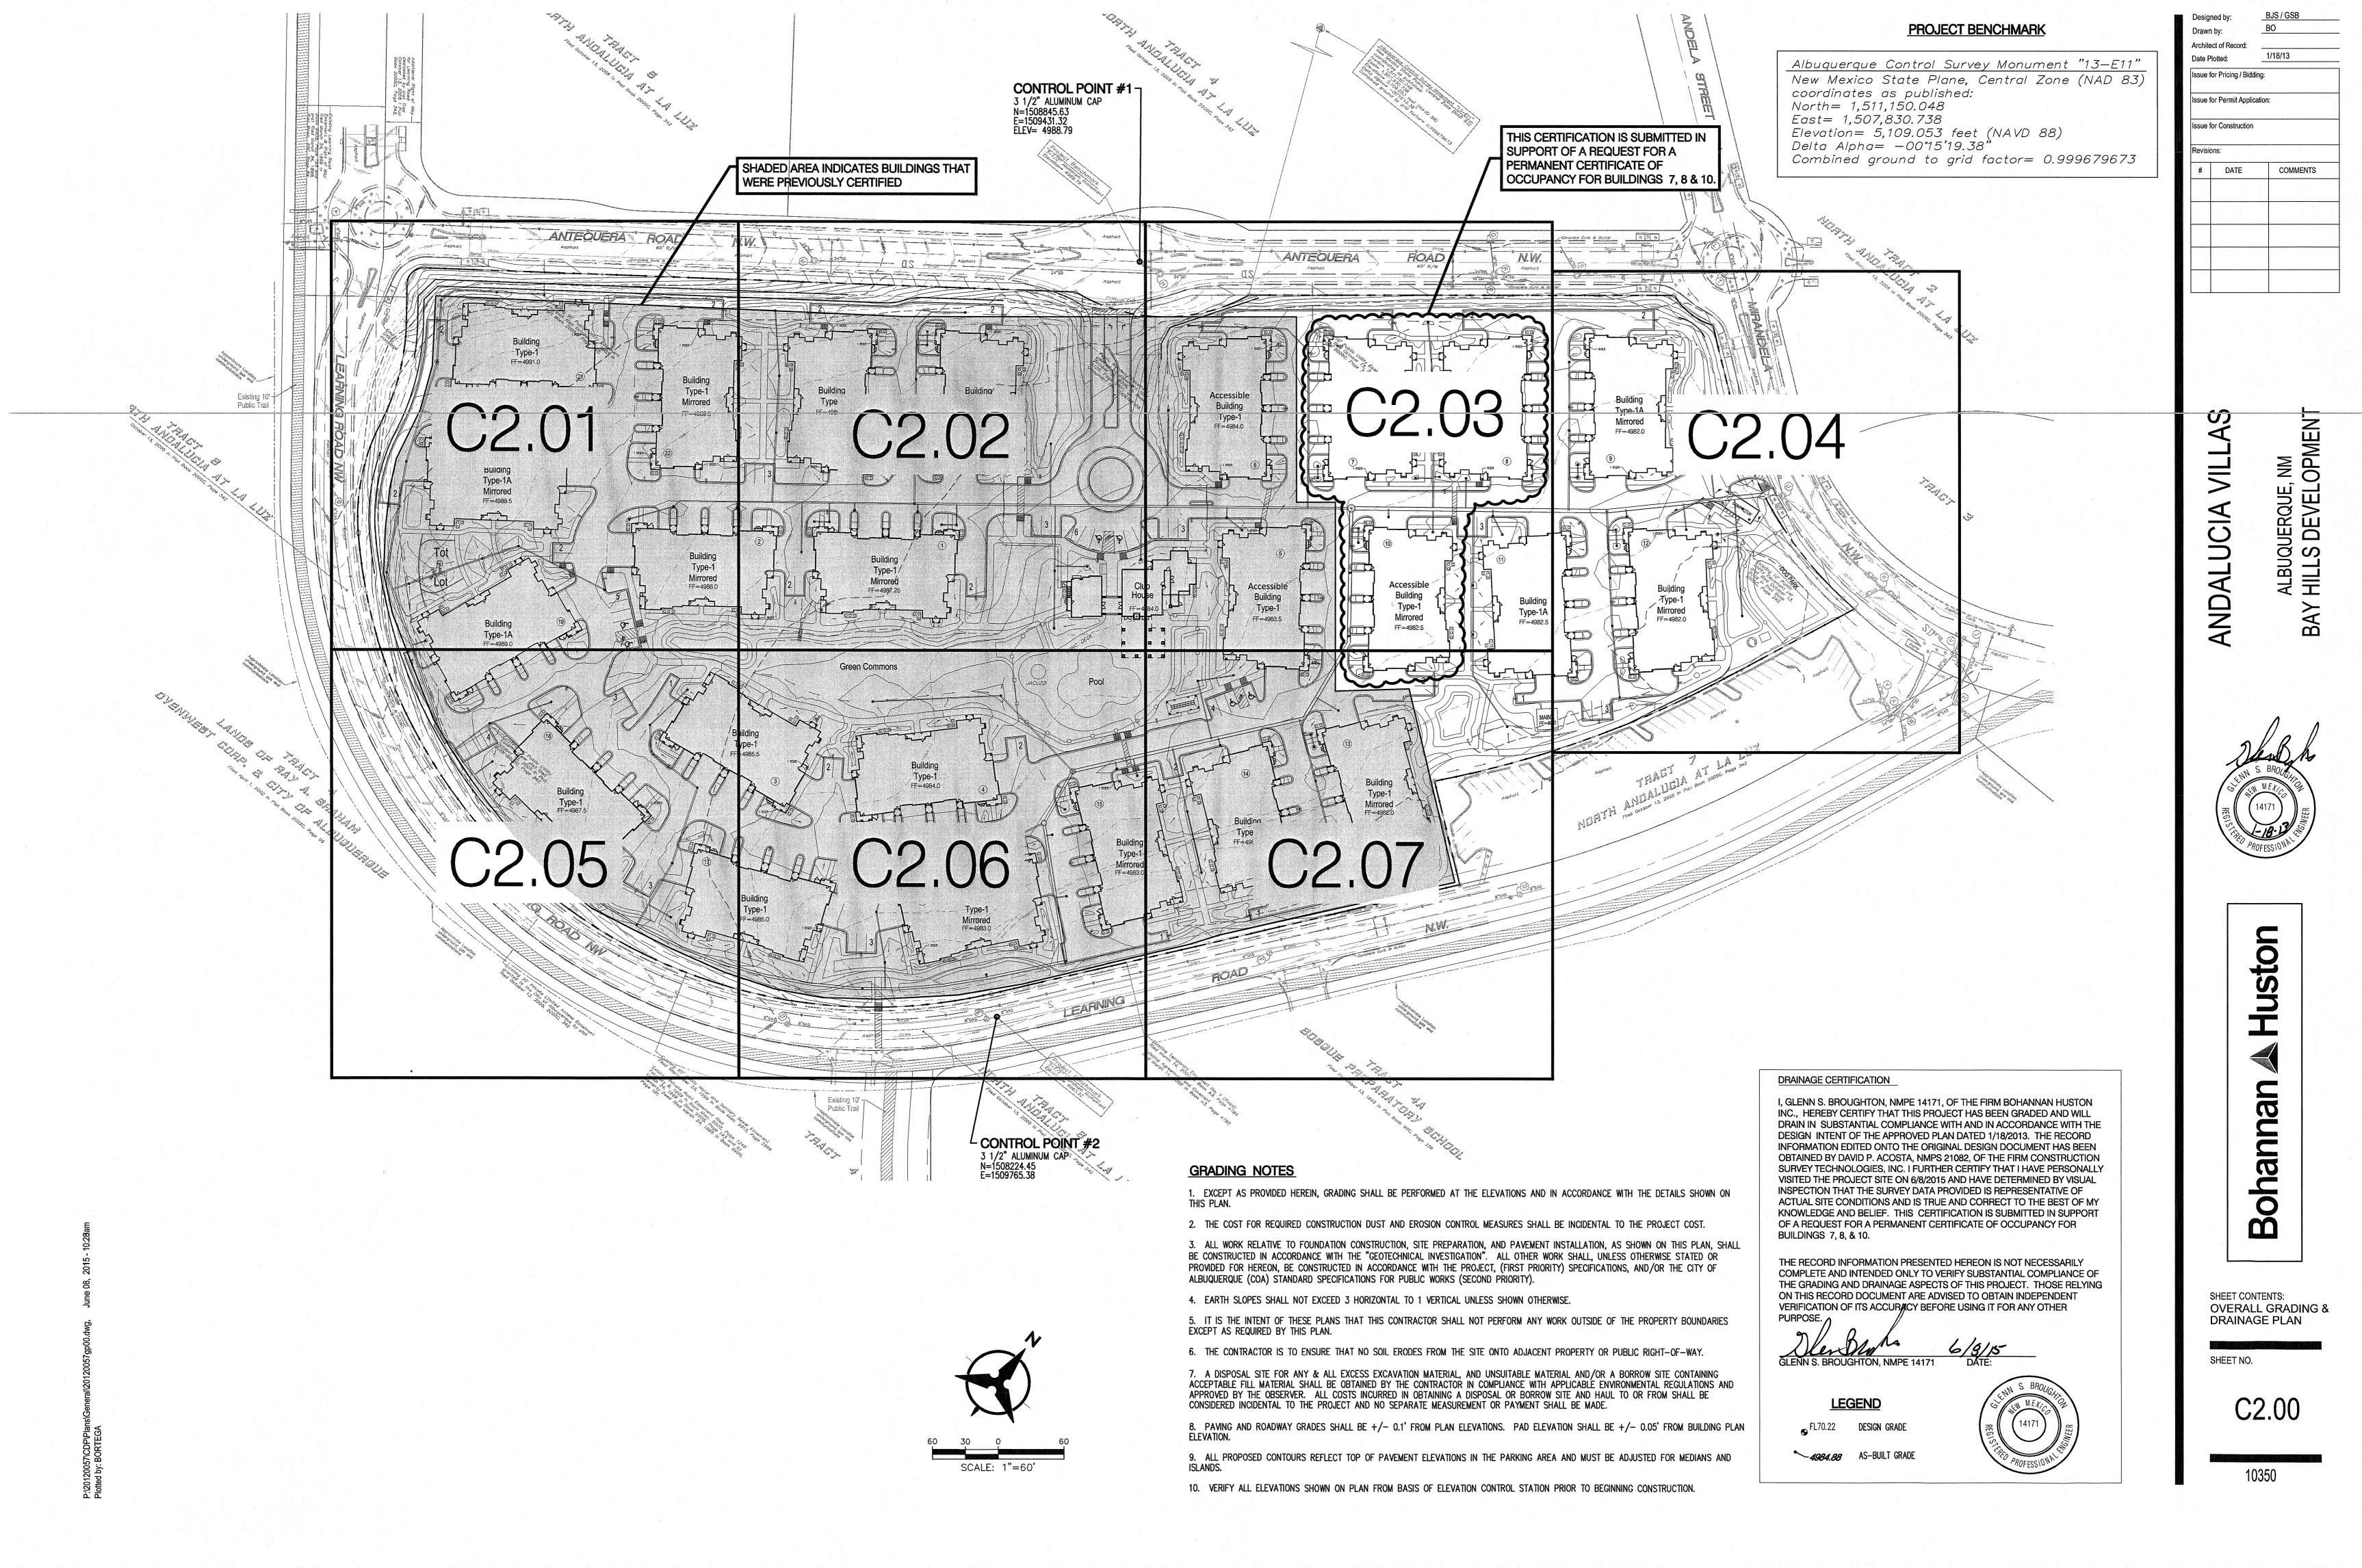

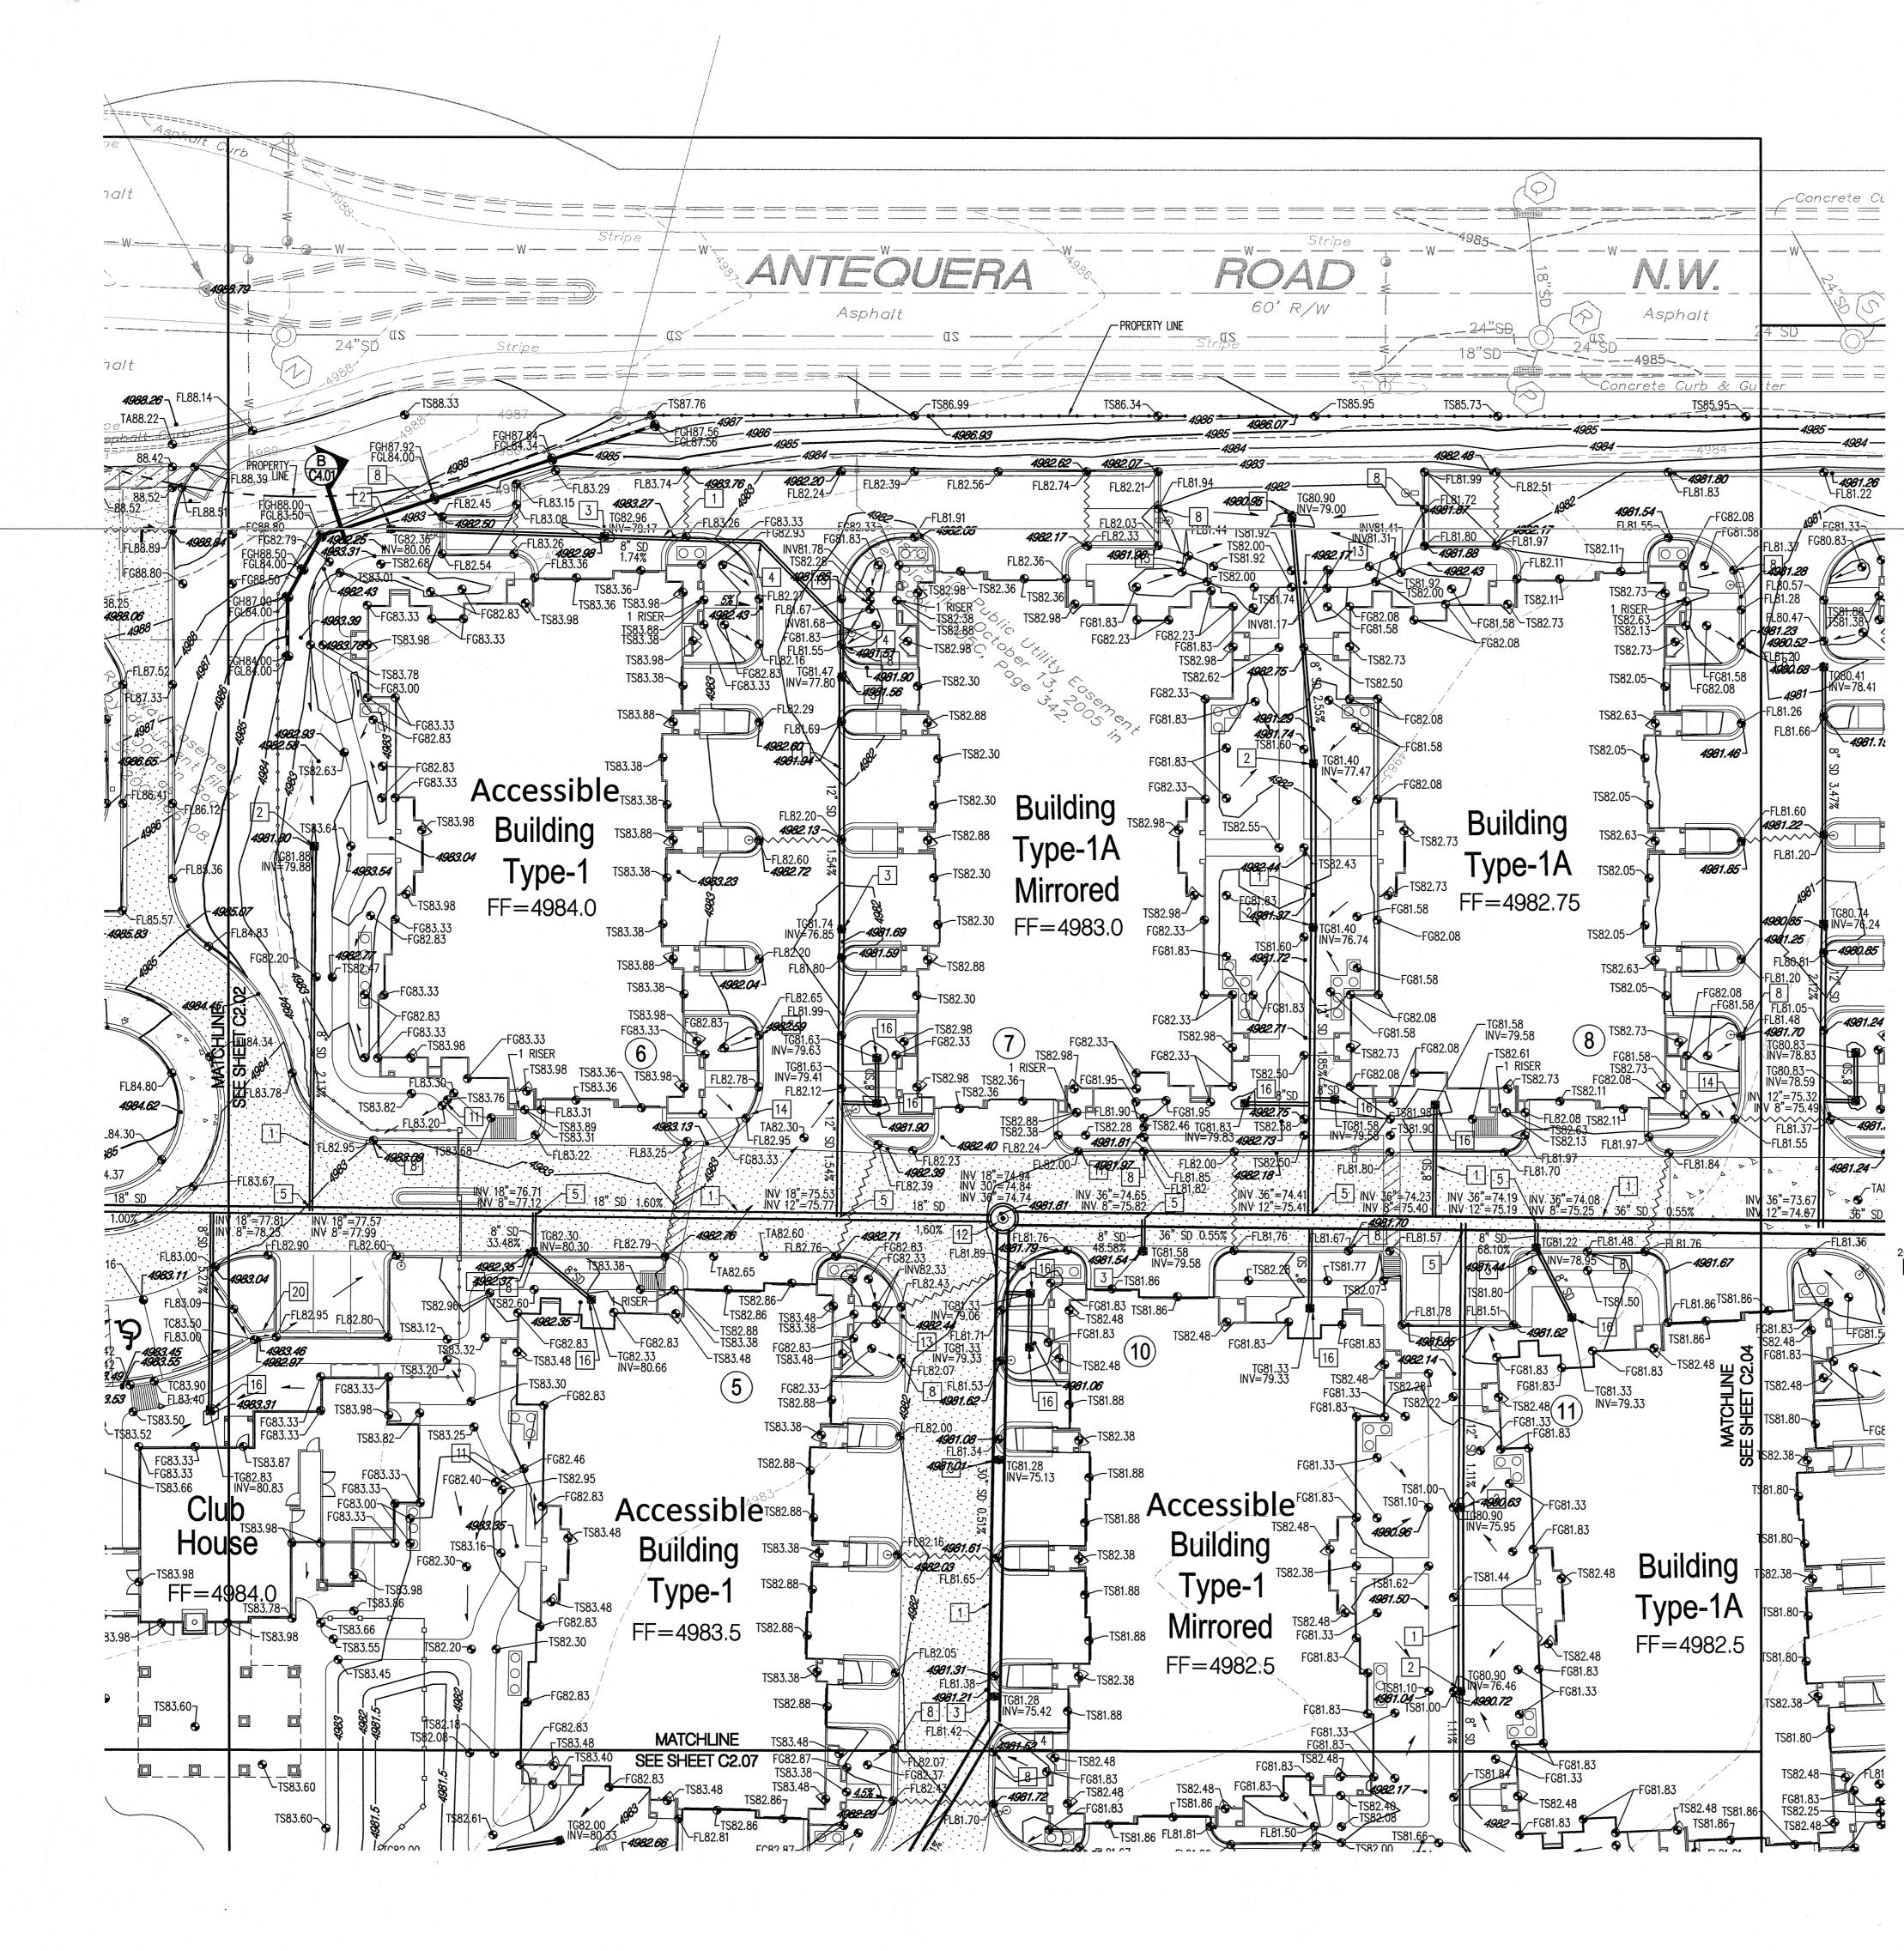

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1. INSTALL HDPE STORM DRAIN WITH WITH WATER TIGHT JOINTS. SEE PLAN FOR SIZE, SLOPE & INVERT ELEVATIONS.

2. INSTALL NYLOPLAST INLINE DRAIN WITH 12" DOMED GRATE.

- 3. INSTALL NYLOPLAST 2'x2' TRAFFIC RATED INLET & GRATE.
- 4. INSTALL PREFABRICATED BEND WITH WATER TIGHT JOINTS.

5. INSTALL PREFABRICATED INSERTA TEE.

6. CONNECT TO EXISTING STORM DRAIN STUB OUT WITH CONCRETE COLLAR.

7. INSTALL 18" WIDE SIDEWALK CULVERT PER COA STD DWG 2236.

- 8. CONSTRUCT 12" WIDE CURB OPENING FOR DRAINAGE.
- 9. INSTALL PREFABRICATED INSERTA WYE.

10. INSTALL 4' DIA TYPE "E" STORM DRAIN MANHOLE PER COA STD DWG 2102.

- 11. INSTALL 12" WIDE SIDEWALK CULVERT PER COA STD DWG 2236.
- 12. INSTALL 6' DIA TYPE "E" STORM DRAIN MANHOLE PER COA STD DWG 2102.
- 13. INSTALL 6" SDR-35 PVC PIPE.
- 14. TRANSITION FROM 6" HIGH CURB TO FLUSH CURB.
- 15. MAINTAIN A 4' WIDE PEDESTRIAN WALKWAY WITH A 2.0% MAXIMUM CROSS SLOPE.
- 16. INSTALL NYLOPLAST INLINE DRAIN WITH 8" DOMED GRATE.
- 17. INSTALL NYLOPLAST INLINE DRAIN WITH 18" DOMED GRATE.18. INSTALL NYLOPLAST JUNCTION STRUCTURE.
- 19. INSTALL 4' DIA TYPE "C" STORM DRAIN MANHOLE PER COA STD DWG 2101.
- 20. CONSTRUCT 12" WIDE CONCRETE RIBBON CHANNEL PER COA STD DWG 2236, OMIT CHECKERED STEEL PLATE.
- 21. CONSTRUCT 3'-0" WIDE x 12" DEEP RIP-RAP RUNDOWN. 4"-6" ROCK OVER NON-WOVEN FILTER FABRIC.
- 22. INSTALL NYLOPLAST 2'x2' TRAFFIC RATED INLET & GRATE. CONNECT TO SANITARY SEWER SYSTEM. SEE UTILITY PLAN FOR DETAILS.

NOTE: IN LOCATIONS REQUIRING CURB OPENINGS FOR DRAINAGE (KEYED NOTE 8) THE FINISHED SURFACE OF LANDSCAPE MATERIAL SHALL BE AT EQUAL ELEVATION WITH THE ADJACENT ASPHALT PAVEMENT OR CONCRETE GUTTER.



SCALE: 1"=20'

DRAINAGE CERTIFICATION

I, GLENN S. BROUGHTON, NMPE 14171, OF THE FIRM BOHANNAN HUSTON INC., HEREBY CERTIFY THAT THIS PROJECT HAS BEEN GRADED AND WILL DRAIN IN SUBSTANTIAL COMPLIANCE WITH AND IN ACCORDANCE WITH THE DESIGN INTENT OF THE APPROVED PLAN DATED 1/18/2013. THE RECORD INFORMATION EDITED ONTO THE ORIGINAL DESIGN DOCUMENT HAS BEEN OBTAINED BY DAVID P. ACOSTA, NMPS 21082, OF THE FIRM CONSTRUCTION SURVEY TECHNOLOGIES, INC. I FURTHER CERTIFY THAT I HAVE PERSONALLY VISITED THE PROJECT SITE ON 6/8/2015 AND HAVE DETERMINED BY VISUAL INSPECTION THAT THE SURVEY DATA PROVIDED IS REPRESENTATIVE OF ACTUAL SITE CONDITIONS AND IS TRUE AND CORRECT TO THE BEST OF MY KNOWLEDGE AND BELIEF. THIS CERTIFICATION IS SUBMITTED IN SUPPORT OF A REQUEST FOR A PERMANENT CERTIFICATE OF OCCUPANCY FOR BUILDINGS 7, 8 & 10.

THE RECORD INFORMATION PRESENTED HEREON IS NOT NECESSARILY COMPLETE AND INTENDED ONLY TO VERIFY SUBSTANTIAL COMPLIANCE OF THE GRADING AND DRAINAGE ASPECTS OF THIS PROJECT. THOSE RELYING ON THIS RECORD DOCUMENT ARE ADVISED TO OBTAIN INDEPENDENT VERIFICATION OF ITS ACCURACY BEFORE USING IT FOR ANY OTHER

PURPOSE 6/8/15 DATE: GLENN S. BROUGHTON, NMPE 14171

LEGEND FL70.22 DESIGN GRADE

-4983.04 AS-BUILT GRADE



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Date I	Plotted:	1/18/13
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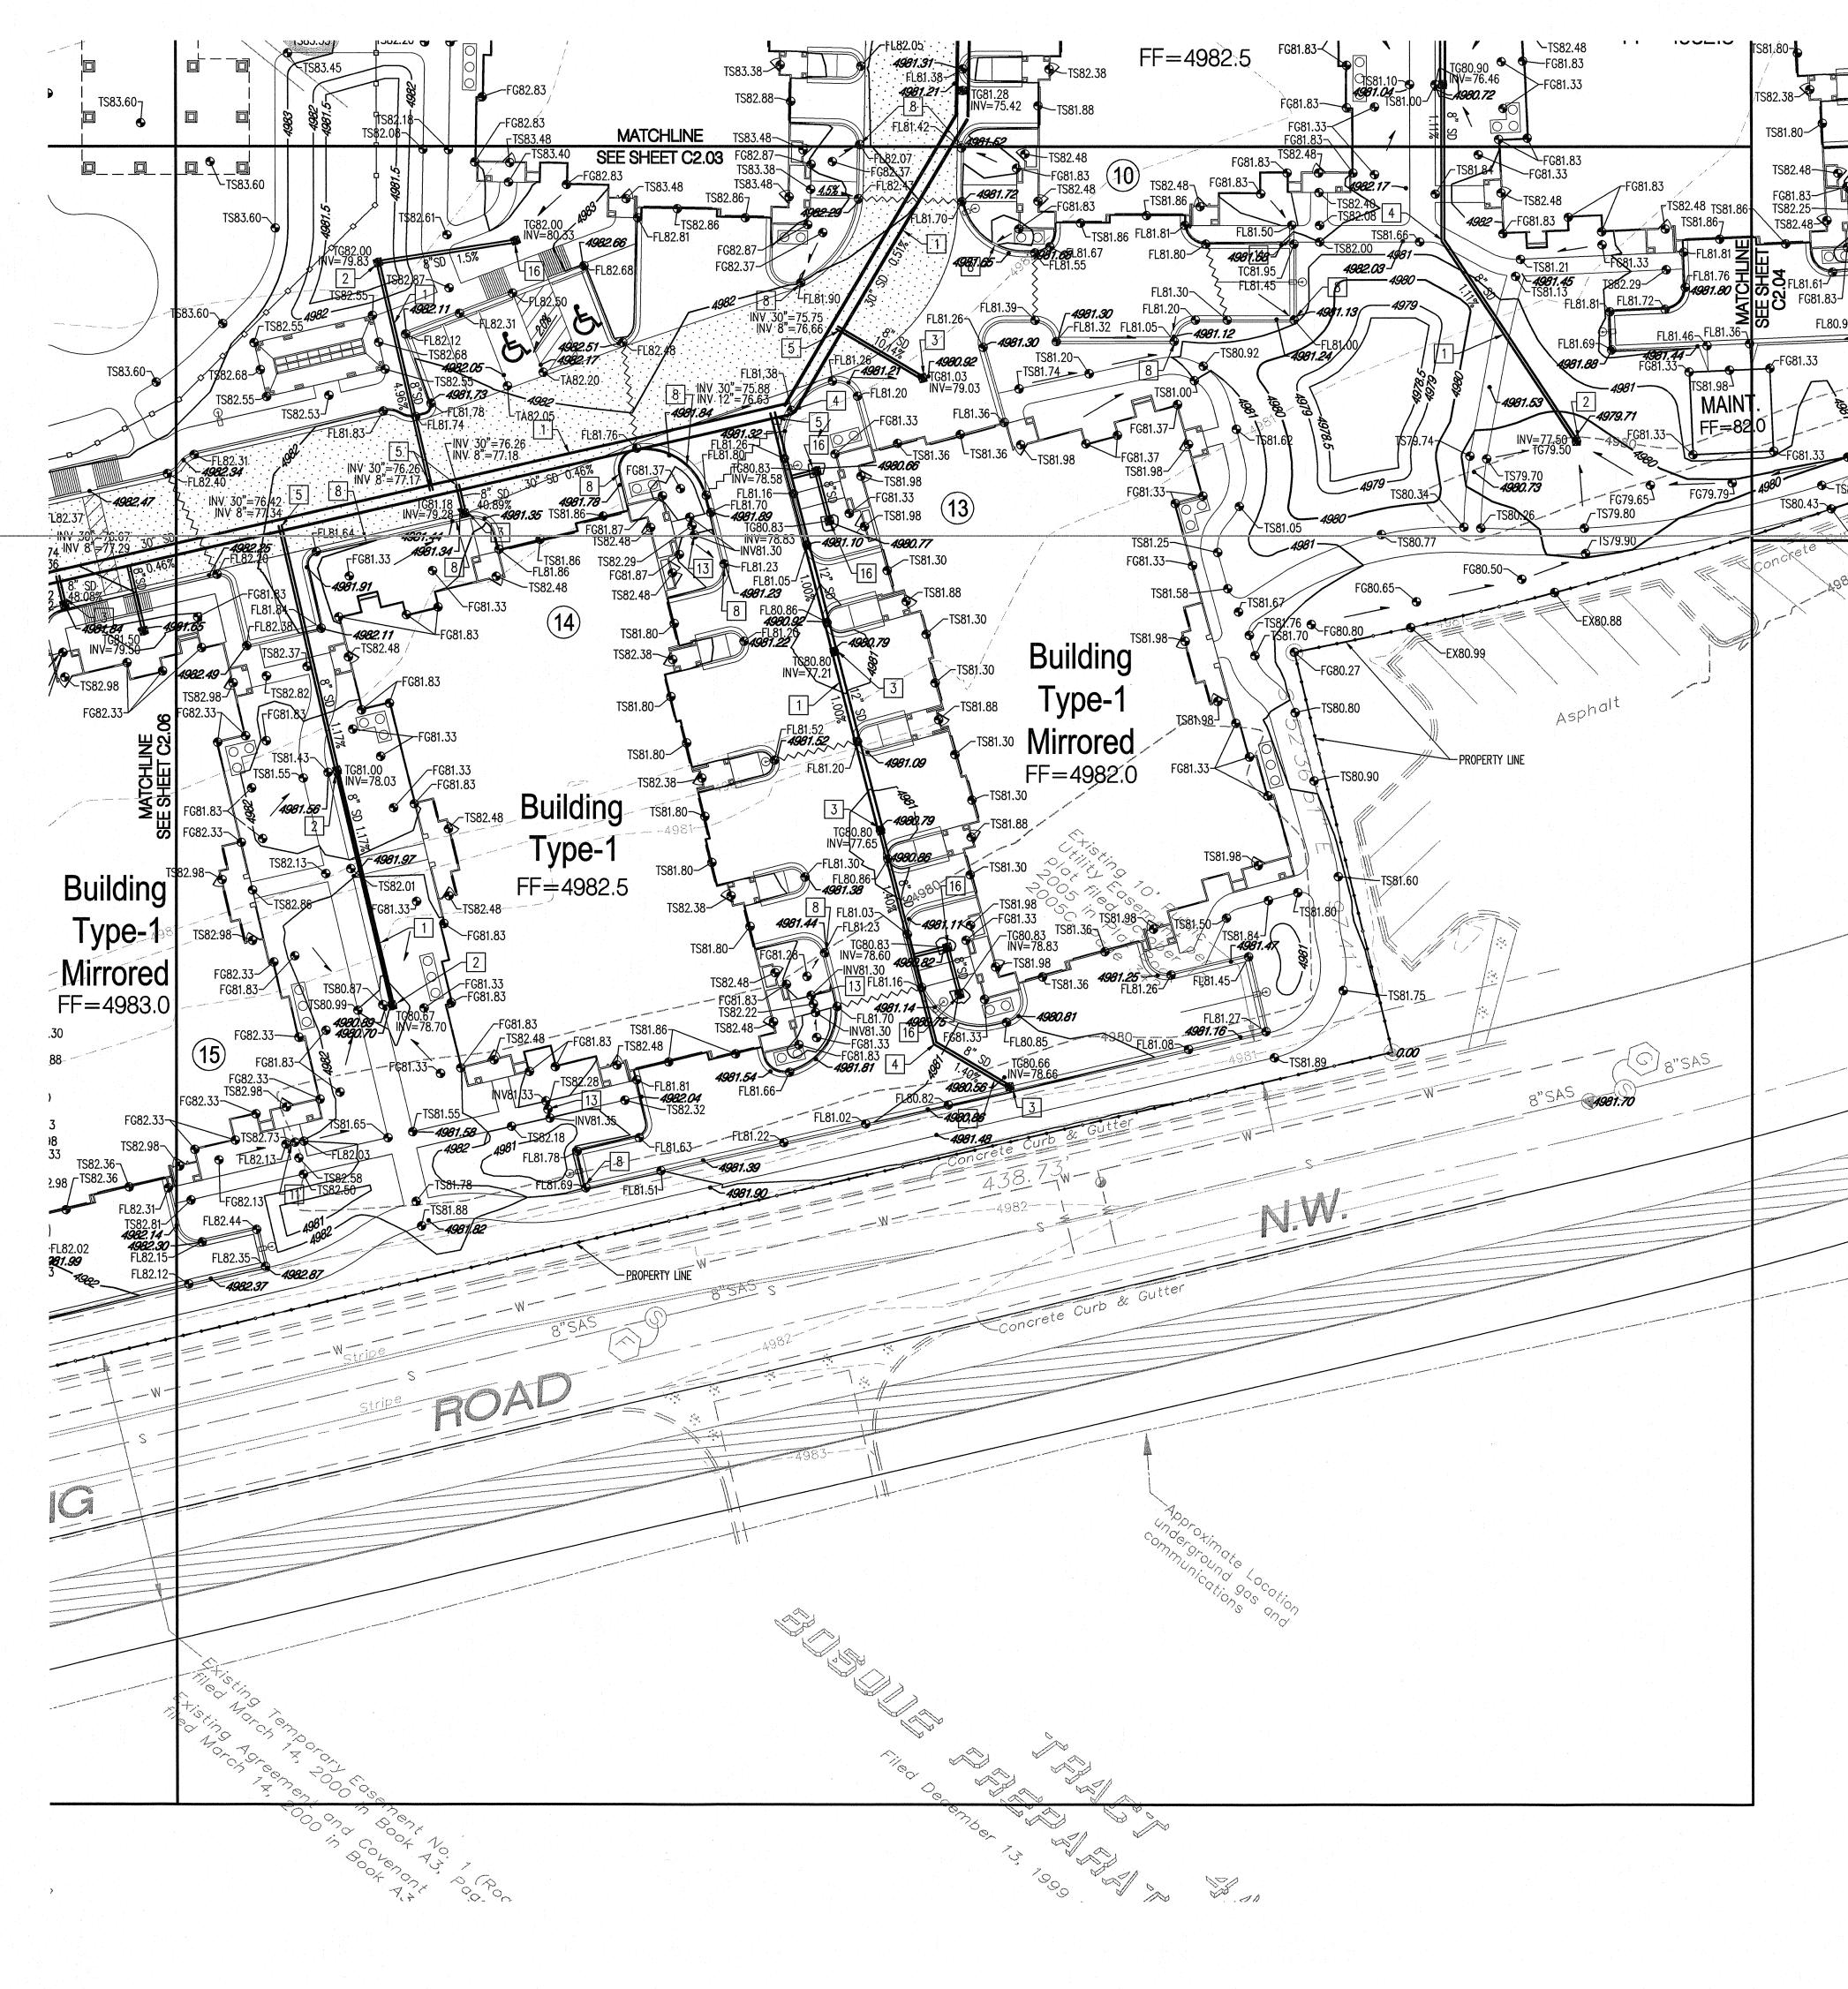



SHEET CONTENTS: GRADING & DRAINAGE PLAN

SHEET NO.

C2.03

10350



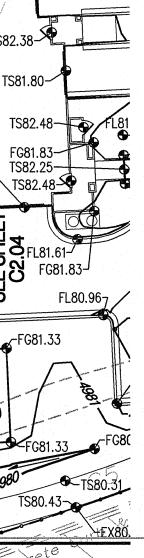

GRADING KEYED NOTES


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I FNN S. BROUGHTON,

LEGEND ● FL70.22 DESIGN GRADE



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Issue	for Construction	
Revisi	ons:	
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SHEET CONTENTS: **GRADING &** DRAINAGE PLAN



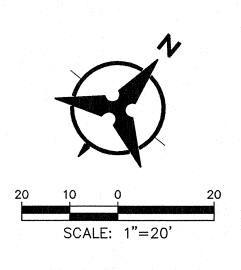

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