CITY OF ALBUQUERQUE

ALL ALL BUT

April 23, 2015

Glen Broughton, PE Bohannan-Huston 7500 Jefferson St NE Courtyard I Albuquerque, NM 87109

Re: Andalucia Villas 5300 Antequera NW, Buildings 16 and 17 Request Permanent C.O. - Accepted Engineer's Stamp dated: 1-18-13 (E12D015C) Certification dated: 4-22-15

Dear Mr. Broughton,

Based on the Certification received 4/22/2015, the site is acceptable for release of Certificate of Occupancy by Hydrology for buildings 16 & 17.

If you have any questions, you can contact me at 924-3695 or Rudy Rael at 924-3977.

PO Box 1293

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Albuquerque

New Mexico 87103

www.cabq.gov C: email

Sincerely, Rite

> Rita Harmon, P.E. Senior Engineer, Hydrology Planning Department

> > Albuquerque - Making History 1706-2006



City of Albuquerque

Planning Department

Development & Building Services Division

DRAINAGE AND TRANSPORTATION INFORMATION SHEET

(REV 02/2013)

| Project Title: | Building Permit #: | City Drainage #: |
|---------------------------------------|-------------------------|------------------------|
| DRB#: EPC#: | | Work Order#: |
| Legal Description: | | |
| City Address: | | |
| Engineering Firm: | | Contact: |
| Address: | | |
| Phone#: Fax#: | | E-mail: |
| Owner: | | Contact: |
| Address: | | |
| Phone#: Fax#: | | E-mail: |
| Architect: | | Contact: |
| Address: | | |
| Phone#: Fax#: | | E-mail: |
| Surveyor: | | Contact: |
| Address: | | |
| Phone#: Fax#: | | E-mail: |
| Contractor: | | Contact: |
| Address: | | |
| Phone#: Fax#: | | E-mail: |
| TYPE OF SUBMITTAL: | CHECK TYPE OF APPROV | AL/ACCEPTANCE SOUGHT: |
| DRAINAGE REPORT | SIA/FINANCIAL GUARAN | TEE RELEASE |
| DRAINAGE PLAN 1st SUBMITTAL | PRELIMINARY PLAT APPI | ROVAL |
| DRAINAGE PLAN RESUBMITTAL | S. DEV. PLAN FOR SUB'D | APPROVAL |
| CONCEPTUAL G & D PLAN | S. DEV. FOR BLDG. PERMI | IT APPROVAL |
| GRADING PLAN | SECTOR PLAN APPROVAL | _ |
| EROSION & SEDIMENT CONTROL PLAN (ESC) | FINAL PLAT APPROVAL | |
| ENGINEER'S CERT (HYDROLOGY) | CERTIFICATE OF OCCUPA | ANCY (PERM) |
| CLOMR/LOMR | CERTIFICATE OF OCCUPA | ANCY (TCL TEMP) |
| TRAFFIC CIRCULATION LAYOUT (TCL) | FOUNDATION PERMIT AP | PROVAL |
| ENGINEER'S CERT (TCL) | BUILDING PERMIT APPRO | DVAL |
| ENGINEER'S CERT (DRB SITE PLAN) | GRADING PERMIT APPRO | VAL SO-19 APPROVAL |
| ENGINEER'S CERT (ESC) | PAVING PERMIT APPROV | AL ESC PERMIT APPROVAL |
| SO-19 | WORK ORDER APPROVAL | ESC CERT. ACCEPTANCE |
| OTHER (SPECIFY) | GRADING CERTIFICATION | N OTHER (SPECIFY) |
| WAS A PRE-DESIGN CONFERENCE ATTENDED: | Yes No Co | ppy Provided |
| DATE SUBMITTED: | By: | |


Requests for approvals of Site Development Plans and/or Subdivision Plats shall be accompanied by a drainage submittal. The particular nature, location, and scope to the proposed development defines the degree of drainage detail. One or more of the following levels of submittal may be required based on the following

1. Conceptual Grading and Drainage Plan: Required for approval of Site Development Plans greater than five (5) acres and Sector Plans


2. Drainage Plans: Required for building permits, grading permits, paving permits and site plans less than five (5) acres

3. **Drainage Report**: Required for subdivision containing more than ten (10) lots or constituting five (5) acres or more

4. Erosion and Sediment Control Plan: Required for any new development and redevelopment site with 1-acre or more of land disturbing area, including project less than 1-acre than are part of a larger common plan of development

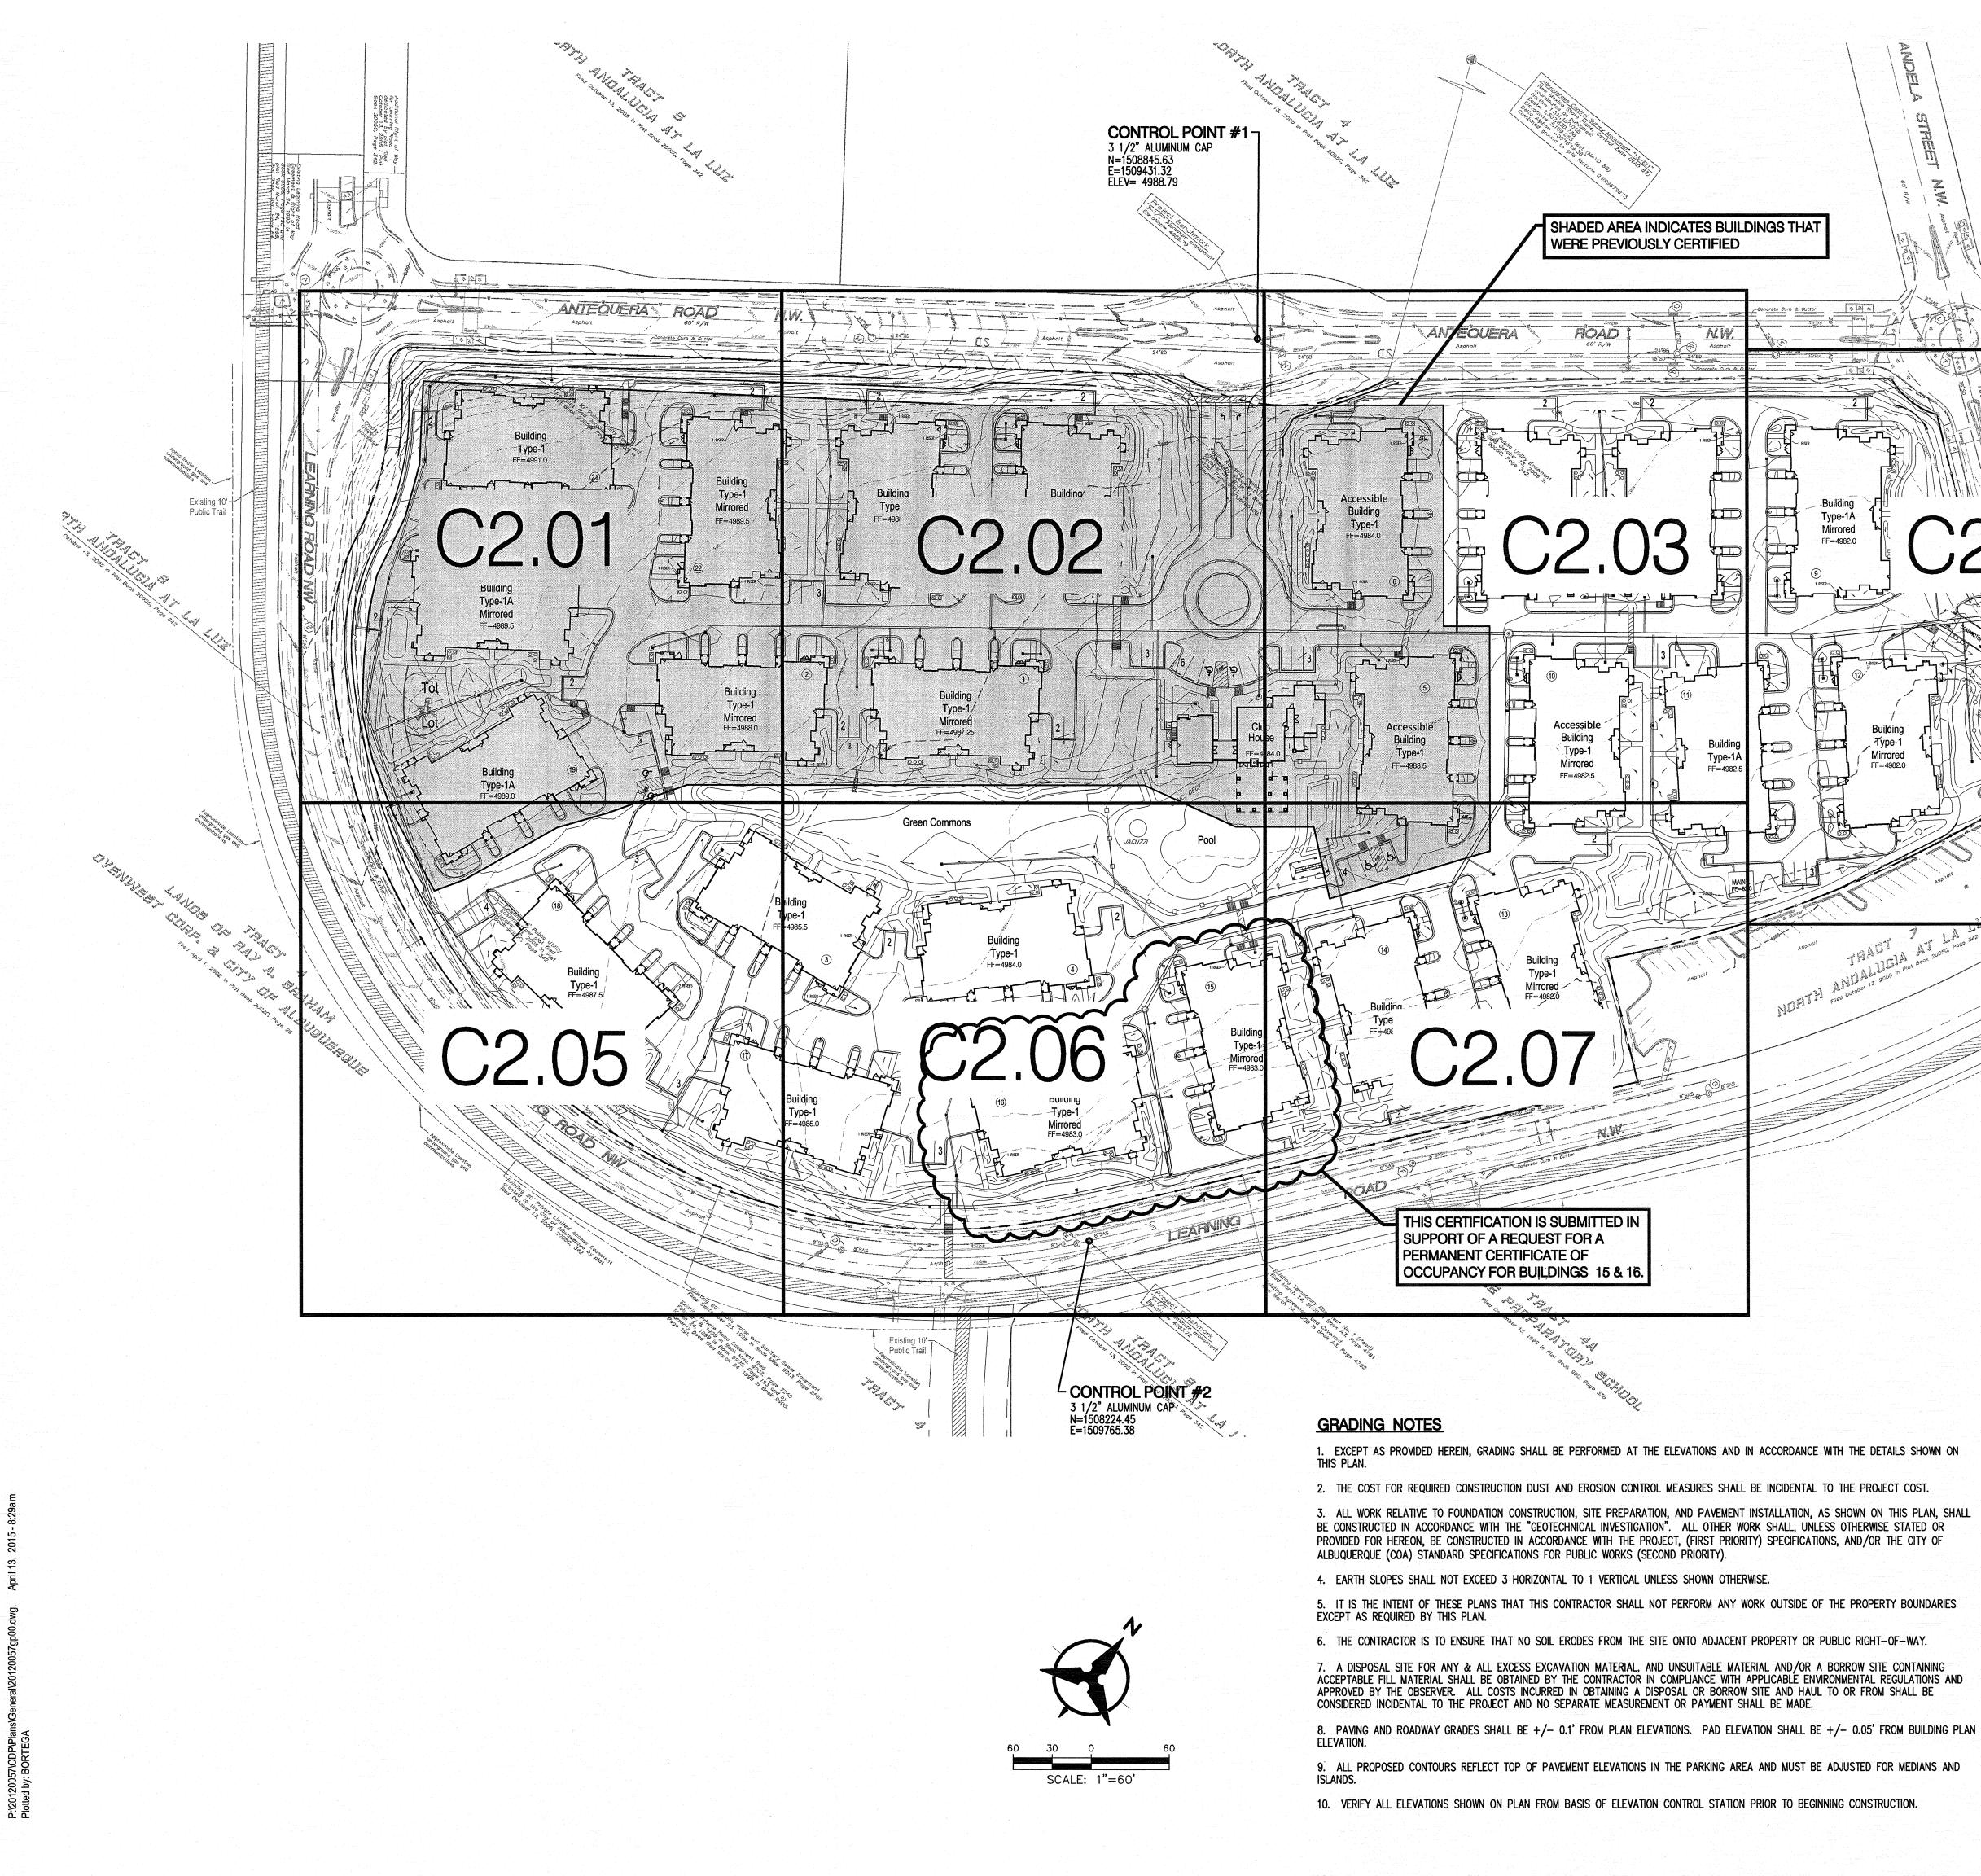

Designed by: PROJECT BENCHMARK Drawn by: Architect of Record: 1/18/13 Date Plotted: Albuquerque Control Survey Monument "13-E11" Issue for Pricing / Bidding: ŝ New Mexico State Plane, Central Zone (NAD 83) coordinates as published: North= 1,511,150.048East= 1,507,830.738Elevation= 5,109.053 feet (NAVD 88) Delta Alpha= $-00^{\circ}15'19.38"$ Issue for Permit Application: ssue for Construction Williams Come Combined ground to grid factor= 0.999679673 DATE COMMENTS S ALBUQUERQUE, NM BAY HILLS DEVELOPMENT UCIA. ANDAL 14171 usto DRAINAGE CERTIFICATION \mathbf{C} nna I, GLENN S. BROUGHTON, NMPE 14171, OF THE FIRM BOHANNAN HUSTON INC., HEREBY CERTIFY THAT THIS PROJECT HAS BEEN GRADED AND WILL DRAIN IN SUBSTANTIAL COMPLIANCE WITH AND IN ACCORDANCE WITH THE DESIGN INTENT OF THE APPROVED PLAN DATED 1/18/2013. THE RECORD INFORMATION EDITED ONTO THE ORIGINAL DESIGN DOCUMENT HAS BEEN OBTAINED BY DAVID P. ACOSTA, NMPS 21082, OF THE FIRM CONSTRUCTION oha SURVEY TECHNOLOGIES, INC. I FURTHER CERTIFY THAT I HAVE PERSONALLY VISITED THE PROJECT SITE ON 4/1/2015 AND HAVE DETERMINED BY VISUAL INSPECTION THAT THE SURVEY DATA PROVIDED IS REPRESENTATIVE OF ACTUAL SITE CONDITIONS AND IS TRUE AND CORRECT TO THE BEST OF MY KNOWLEDGE AND BELIEF. THIS CERTIFICATION IS SUBMITTED IN SUPPORT \mathbf{m} OF A REQUEST FOR A PERMANENT CERTIFICATE OF OCCUPANCY FOR BUILDINGS 15 & 16. THE RECORD INFORMATION PRESENTED HEREON IS NOT NECESSARILY COMPLETE AND INTENDED ONLY TO VERIFY SUBSTANTIAL COMPLIANCE OF THE GRADING AND DRAINAGE ASPECTS OF THIS PROJECT. THOSE RELYING ON THIS RECORD DOCUMENT ARE ADVISED TO OBTAIN INDEPENDENT SHEET CONTENTS: VERIFICATION OF ITS ACCURACY BEFORE USING IT FOR ANY OTHER **OVERALL GRADING &** PURPOSE. DRAINAGE PLAN GLENN S. BROUGHTON, NMPE 14171 DAT SHEET NO. LEGEND C2.00 FL70.22 DESIGN GRADE -4984.88 AS-BUILT GRADE 10350

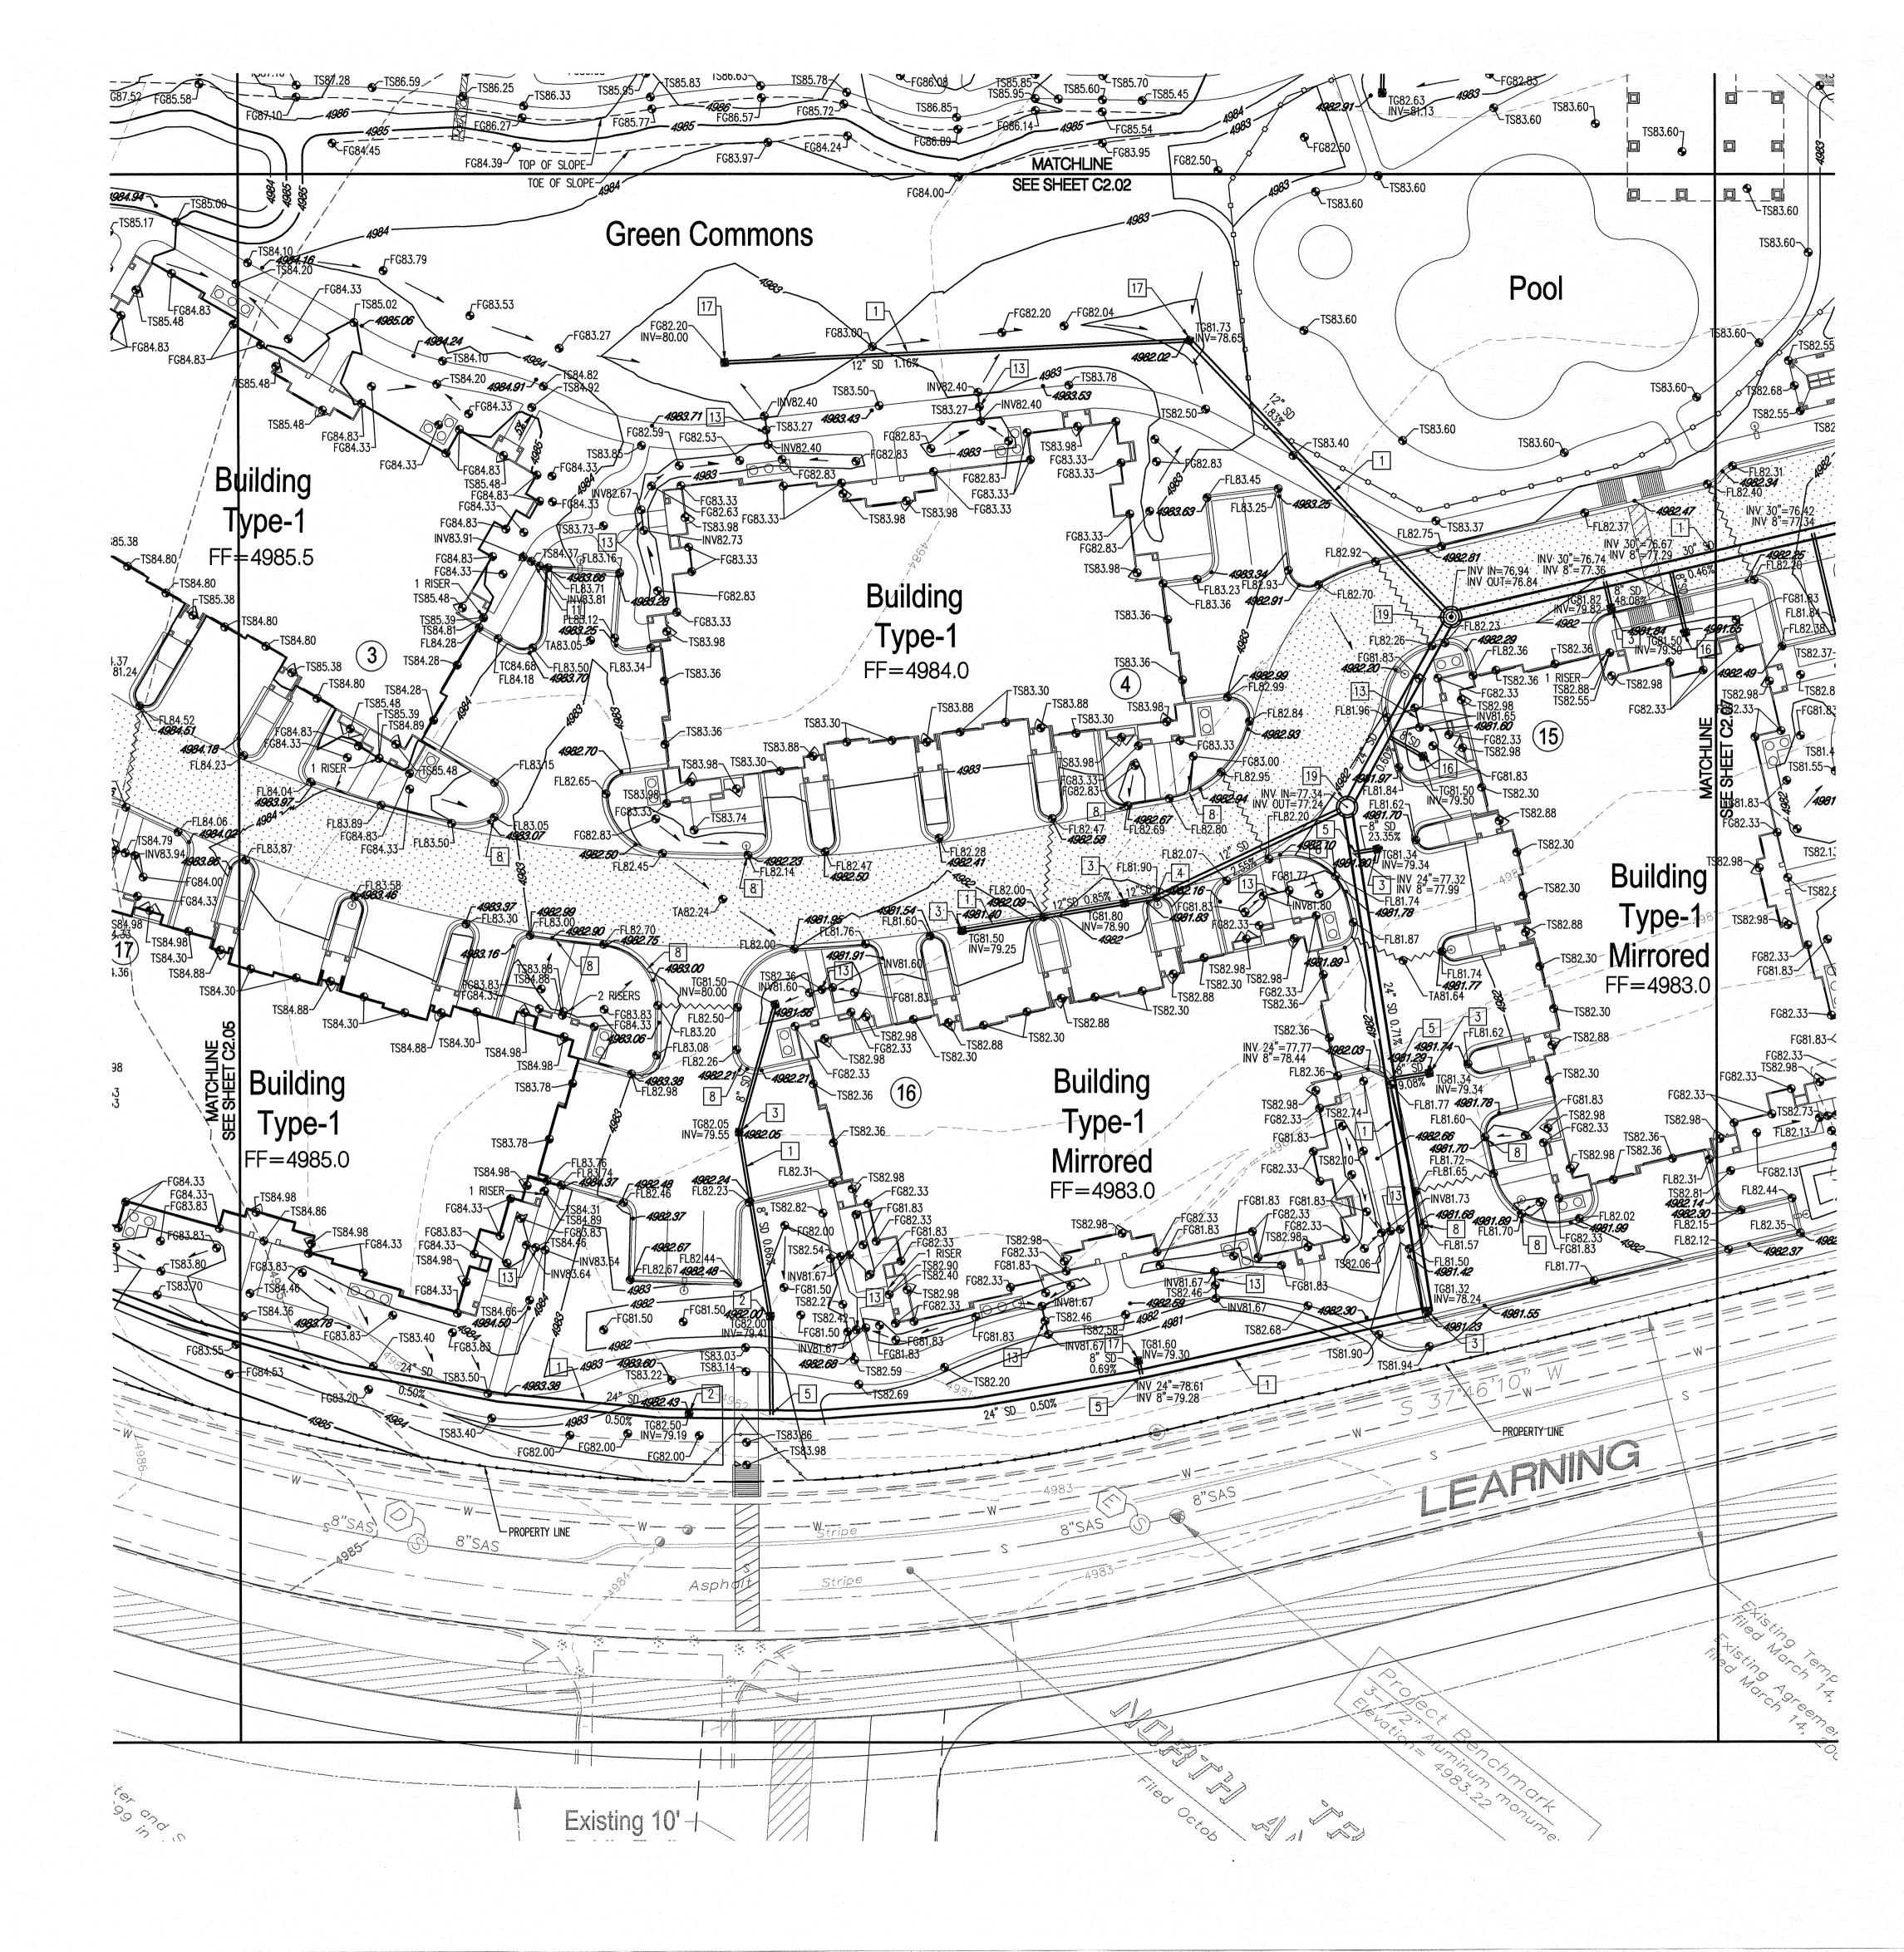

GRADING KEYED NOTES

1. INSTALL HDPE STORM DRAIN WITH WITH WATER TIGHT JOINTS. SEE PLAN FOR SIZE, SLOPE & INVERT ELEVATIONS.

2. INSTALL NYLOPLAST INLINE DRAIN WITH 12" DOMED GRATE.


- 3. INSTALL NYLOPLAST 2'x2' TRAFFIC RATED INLET & GRATE.
- 4. INSTALL PREFABRICATED BEND WITH WATER TIGHT JOINTS.
- 5. INSTALL PREFABRICATED INSERTA TEE.

6. CONNECT TO EXISTING STORM DRAIN STUB OUT WITH CONCRETE COLLAR.

7. INSTALL 18" WIDE SIDEWALK CULVERT PER COA STD DWG 2236.

- 8. CONSTRUCT 12" WIDE CURB OPENING FOR DRAINAGE.
- 9. INSTALL PREFABRICATED INSERTA WYE.
- 10. INSTALL 4' DIA TYPE "E" STORM DRAIN MANHOLE PER COA STD DWG 2102.
- 11. INSTALL 12" WIDE SIDEWALK CULVERT PER COA STD DWG 2236.
- 12. INSTALL 6' DIA TYPE "E" STORM DRAIN MANHOLE PER COA STD DWG 2102.
- 13. INSTALL 6" SDR-35 PVC PIPE.
- 14. TRANSITION FROM 6" HIGH CURB TO FLUSH CURB.
- 15. MAINTAIN A 4' WIDE PEDESTRIAN WALKWAY WITH A 2.0% MAXIMUM CROSS SLOPE.
- 16. INSTALL NYLOPLAST INLINE DRAIN WITH 8" DOMED GRATE.
- 17. INSTALL NYLOPLAST INLINE DRAIN WITH 18" DOMED GRATE.
- 18. INSTALL NYLOPLAST JUNCTION STRUCTURE.
- 19. INSTALL 4' DIA TYPE "C" STORM DRAIN MANHOLE PER COA STD DWG 2101.
- 20. CONSTRUCT 12" WIDE CONCRETE RIBBON CHANNEL PER COA STD DWG 2236, OMIT CHECKERED STEEL PLATE.
- 21. CONSTRUCT 3'-0" WIDE x 12" DEEP RIP-RAP RUNDOWN. 4"-6" ROCK OVER NON-WOVEN FILTER FABRIC.
- 22. INSTALL NYLOPLAST 2'x2' TRAFFIC RATED INLET & GRATE. CONNECT TO SANITARY SEWER SYSTEM. SEE UTILITY PLAN FOR DETAILS.

NOTE: IN LOCATIONS REQUIRING CURB OPENINGS FOR DRAINAGE (KEYED NOTE 8) THE FINISHED SURFACE OF LANDSCAPE MATERIAL SHALL BE AT EQUAL ELEVATION WITH THE ADJACENT ASPHALT PAVEMENT OR CONCRETE GUTTER.

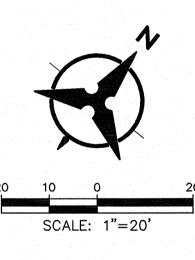

DRAINAGE CERTIFICATION

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PURPOSE. Jen non GLENN S. BROUGHTON, NMPE 14171 LEGEND FL70.22 DESIGN GRADE

~4984.88 AS-BUILT GRADE

Designed by: Drawn by: Architect of Record: 1/18/13 Date Plotted: Issue for Pricing / Bidding: Issue for Permit Application: Issue for Construction DATE COMMENTS



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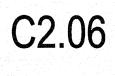
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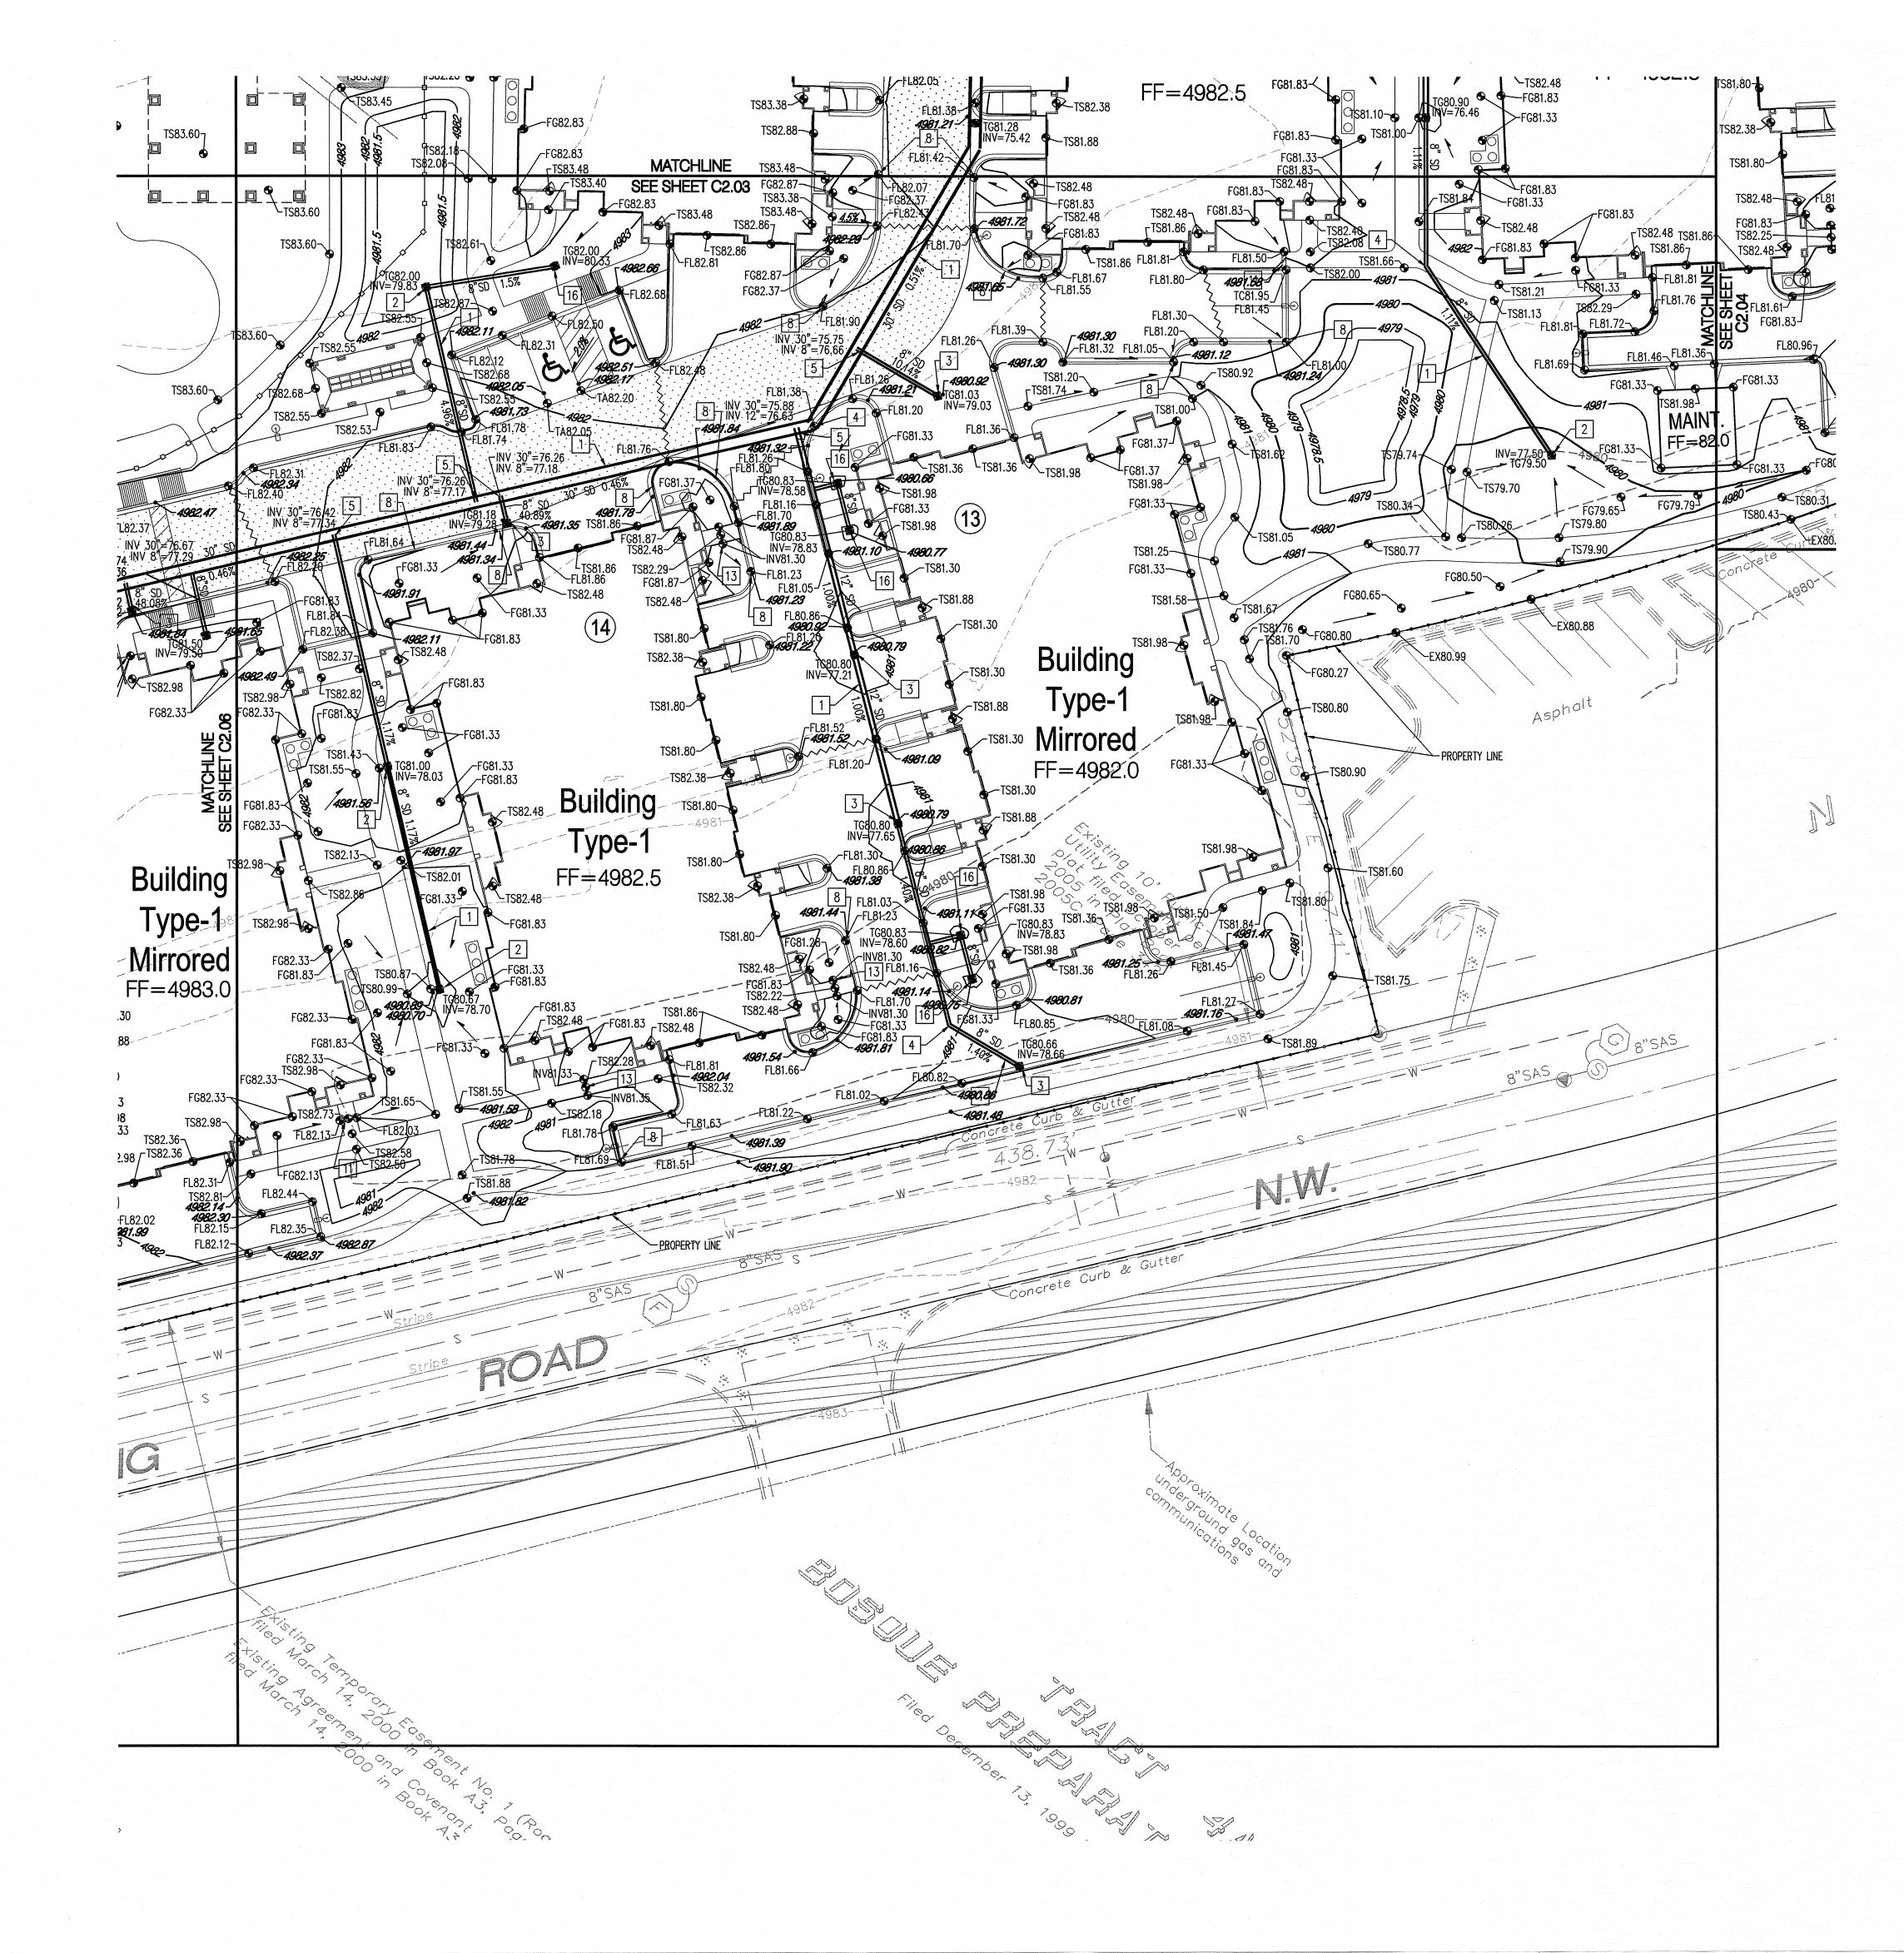




SHEET CONTENTS: **GRADING &** DRAINAGE PLAN

SHEET NO.





o:/20120057/CDP/Plans/General/20120057gp07.dwg, April 13, 2015 - 8 Plotted by: BORTEGA

GRADING KEYED NOTES

1. INSTALL HDPE STORM DRAIN WITH WITH WATER TIGHT JOINTS. SEE PLAN FOR SIZE, SLOPE & INVERT ELEVATIONS.

2. INSTALL NYLOPLAST INLINE DRAIN WITH 12" DOMED GRATE.

3. INSTALL NYLOPLAST 2'x2' TRAFFIC RATED INLET & GRATE.

4. INSTALL PREFABRICATED BEND WITH WATER TIGHT JOINTS.

5. INSTALL PREFABRICATED INSERTA TEE.

9. INSTALL PREFABRICATED INSERTA WYE.

6. CONNECT TO EXISTING STORM DRAIN STUB OUT WITH CONCRETE COLLAR.

7. INSTALL 18" WIDE SIDEWALK CULVERT PER COA STD DWG 2236.

8. CONSTRUCT 12" WIDE CURB OPENING FOR DRAINAGE.

10. INSTALL 4' DIA TYPE "E" STORM DRAIN MANHOLE PER COA STD DWG 2102.

INSTALL 12" WIDE SIDEWALK CULVERT PER COA STD DWG 2236.
INSTALL 6' DIA TYPE "E" STORM DRAIN MANHOLE PER COA STD DWG 2102.

13. INSTALL 6" SDR-35 PVC PIPE.

14. TRANSITION FROM 6" HIGH CURB TO FLUSH CURB.

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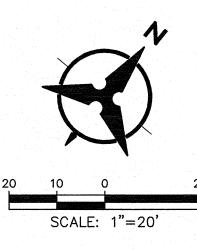
19. INSTALL 4' DIA TYPE "C" STORM DRAIN MANHOLE PER COA STD DWG 2101.

20. CONSTRUCT 12" WIDE CONCRETE RIBBON CHANNEL PER COA STD DWG 2236, OMIT CHECKERED STEEL PLATE.

21. CONSTRUCT 3'-0" WIDE x 12" DEEP RIP-RAP RUNDOWN. 4"-6" ROCK OVER NON-WOVEN FILTER FABRIC.

22. INSTALL NYLOPLAST 2'x2' TRAFFIC RATED INLET & GRATE. CONNECT TO SANITARY SEWER SYSTEM. SEE UTILITY PLAN FOR DETAILS.

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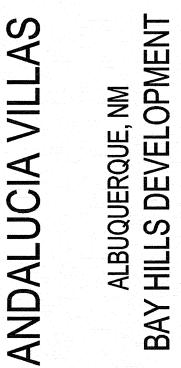
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PURPOSE. LEGEND FL70.22 DESIGN GRADE ~4984.88 AS-BUILT GRADE

| Designed by: Drawn by: | | BJS / GSB | | |
|---------------------------|------------------------|-----------|--|--|
| | | BO | | |
| Archite | ect of Record: | | | |
| Date Plotted: | | 1/18/13 | | |
| Issue | for Pricing / Bidding: | | | |
| Issue | for Permit Applicatior |): | | |
| Issue | for Construction | | | |
| Revisi | ons: | | | |
| # | DATE | COMMENTS | | |
| | | | | |
| | | | | |
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SHEET CONTENTS: GRADING & DRAINAGE PLAN

SHEET NO.

C2.07

10350



City of Albuquerque

Planning Department

Development & Building Services Division

DRAINAGE AND TRANSPORTATION INFORMATION SHEET

(REV 02/2013)

| Project Title: | Building Permit #: | City Drainage #: |
|---------------------------------------|-------------------------|------------------------|
| DRB#: EPC#: | | Work Order#: |
| Legal Description: | | |
| City Address: | | |
| Engineering Firm: | | Contact: |
| Address: | | |
| Phone#: Fax#: | | E-mail: |
| Owner: | | Contact: |
| Address: | | |
| Phone#: Fax#: | | E-mail: |
| Architect: | | Contact: |
| Address: | | |
| Phone#: Fax#: | | E-mail: |
| Surveyor: | | Contact: |
| Address: | | |
| Phone#: Fax#: | | E-mail: |
| Contractor: | | Contact: |
| Address: | | |
| Phone#: Fax#: | | E-mail: |
| TYPE OF SUBMITTAL: | CHECK TYPE OF APPROV | AL/ACCEPTANCE SOUGHT: |
| DRAINAGE REPORT | SIA/FINANCIAL GUARAN | TEE RELEASE |
| DRAINAGE PLAN 1st SUBMITTAL | PRELIMINARY PLAT APPI | ROVAL |
| DRAINAGE PLAN RESUBMITTAL | S. DEV. PLAN FOR SUB'D | APPROVAL |
| CONCEPTUAL G & D PLAN | S. DEV. FOR BLDG. PERMI | IT APPROVAL |
| GRADING PLAN | SECTOR PLAN APPROVAL | _ |
| EROSION & SEDIMENT CONTROL PLAN (ESC) | FINAL PLAT APPROVAL | |
| ENGINEER'S CERT (HYDROLOGY) | CERTIFICATE OF OCCUPA | ANCY (PERM) |
| CLOMR/LOMR | CERTIFICATE OF OCCUPA | ANCY (TCL TEMP) |
| TRAFFIC CIRCULATION LAYOUT (TCL) | FOUNDATION PERMIT AP | PROVAL |
| ENGINEER'S CERT (TCL) | BUILDING PERMIT APPRO | DVAL |
| ENGINEER'S CERT (DRB SITE PLAN) | GRADING PERMIT APPRO | VAL SO-19 APPROVAL |
| ENGINEER'S CERT (ESC) | PAVING PERMIT APPROV | AL ESC PERMIT APPROVAL |
| SO-19 | WORK ORDER APPROVAL | ESC CERT. ACCEPTANCE |
| OTHER (SPECIFY) | GRADING CERTIFICATION | N OTHER (SPECIFY) |
| WAS A PRE-DESIGN CONFERENCE ATTENDED: | Yes No Co | ppy Provided |
| DATE SUBMITTED: | By: | |


Requests for approvals of Site Development Plans and/or Subdivision Plats shall be accompanied by a drainage submittal. The particular nature, location, and scope to the proposed development defines the degree of drainage detail. One or more of the following levels of submittal may be required based on the following

1. Conceptual Grading and Drainage Plan: Required for approval of Site Development Plans greater than five (5) acres and Sector Plans

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4. Erosion and Sediment Control Plan: Required for any new development and redevelopment site with 1-acre or more of land disturbing area, including project less than 1-acre than are part of a larger common plan of development



SCALE: 1"=60'

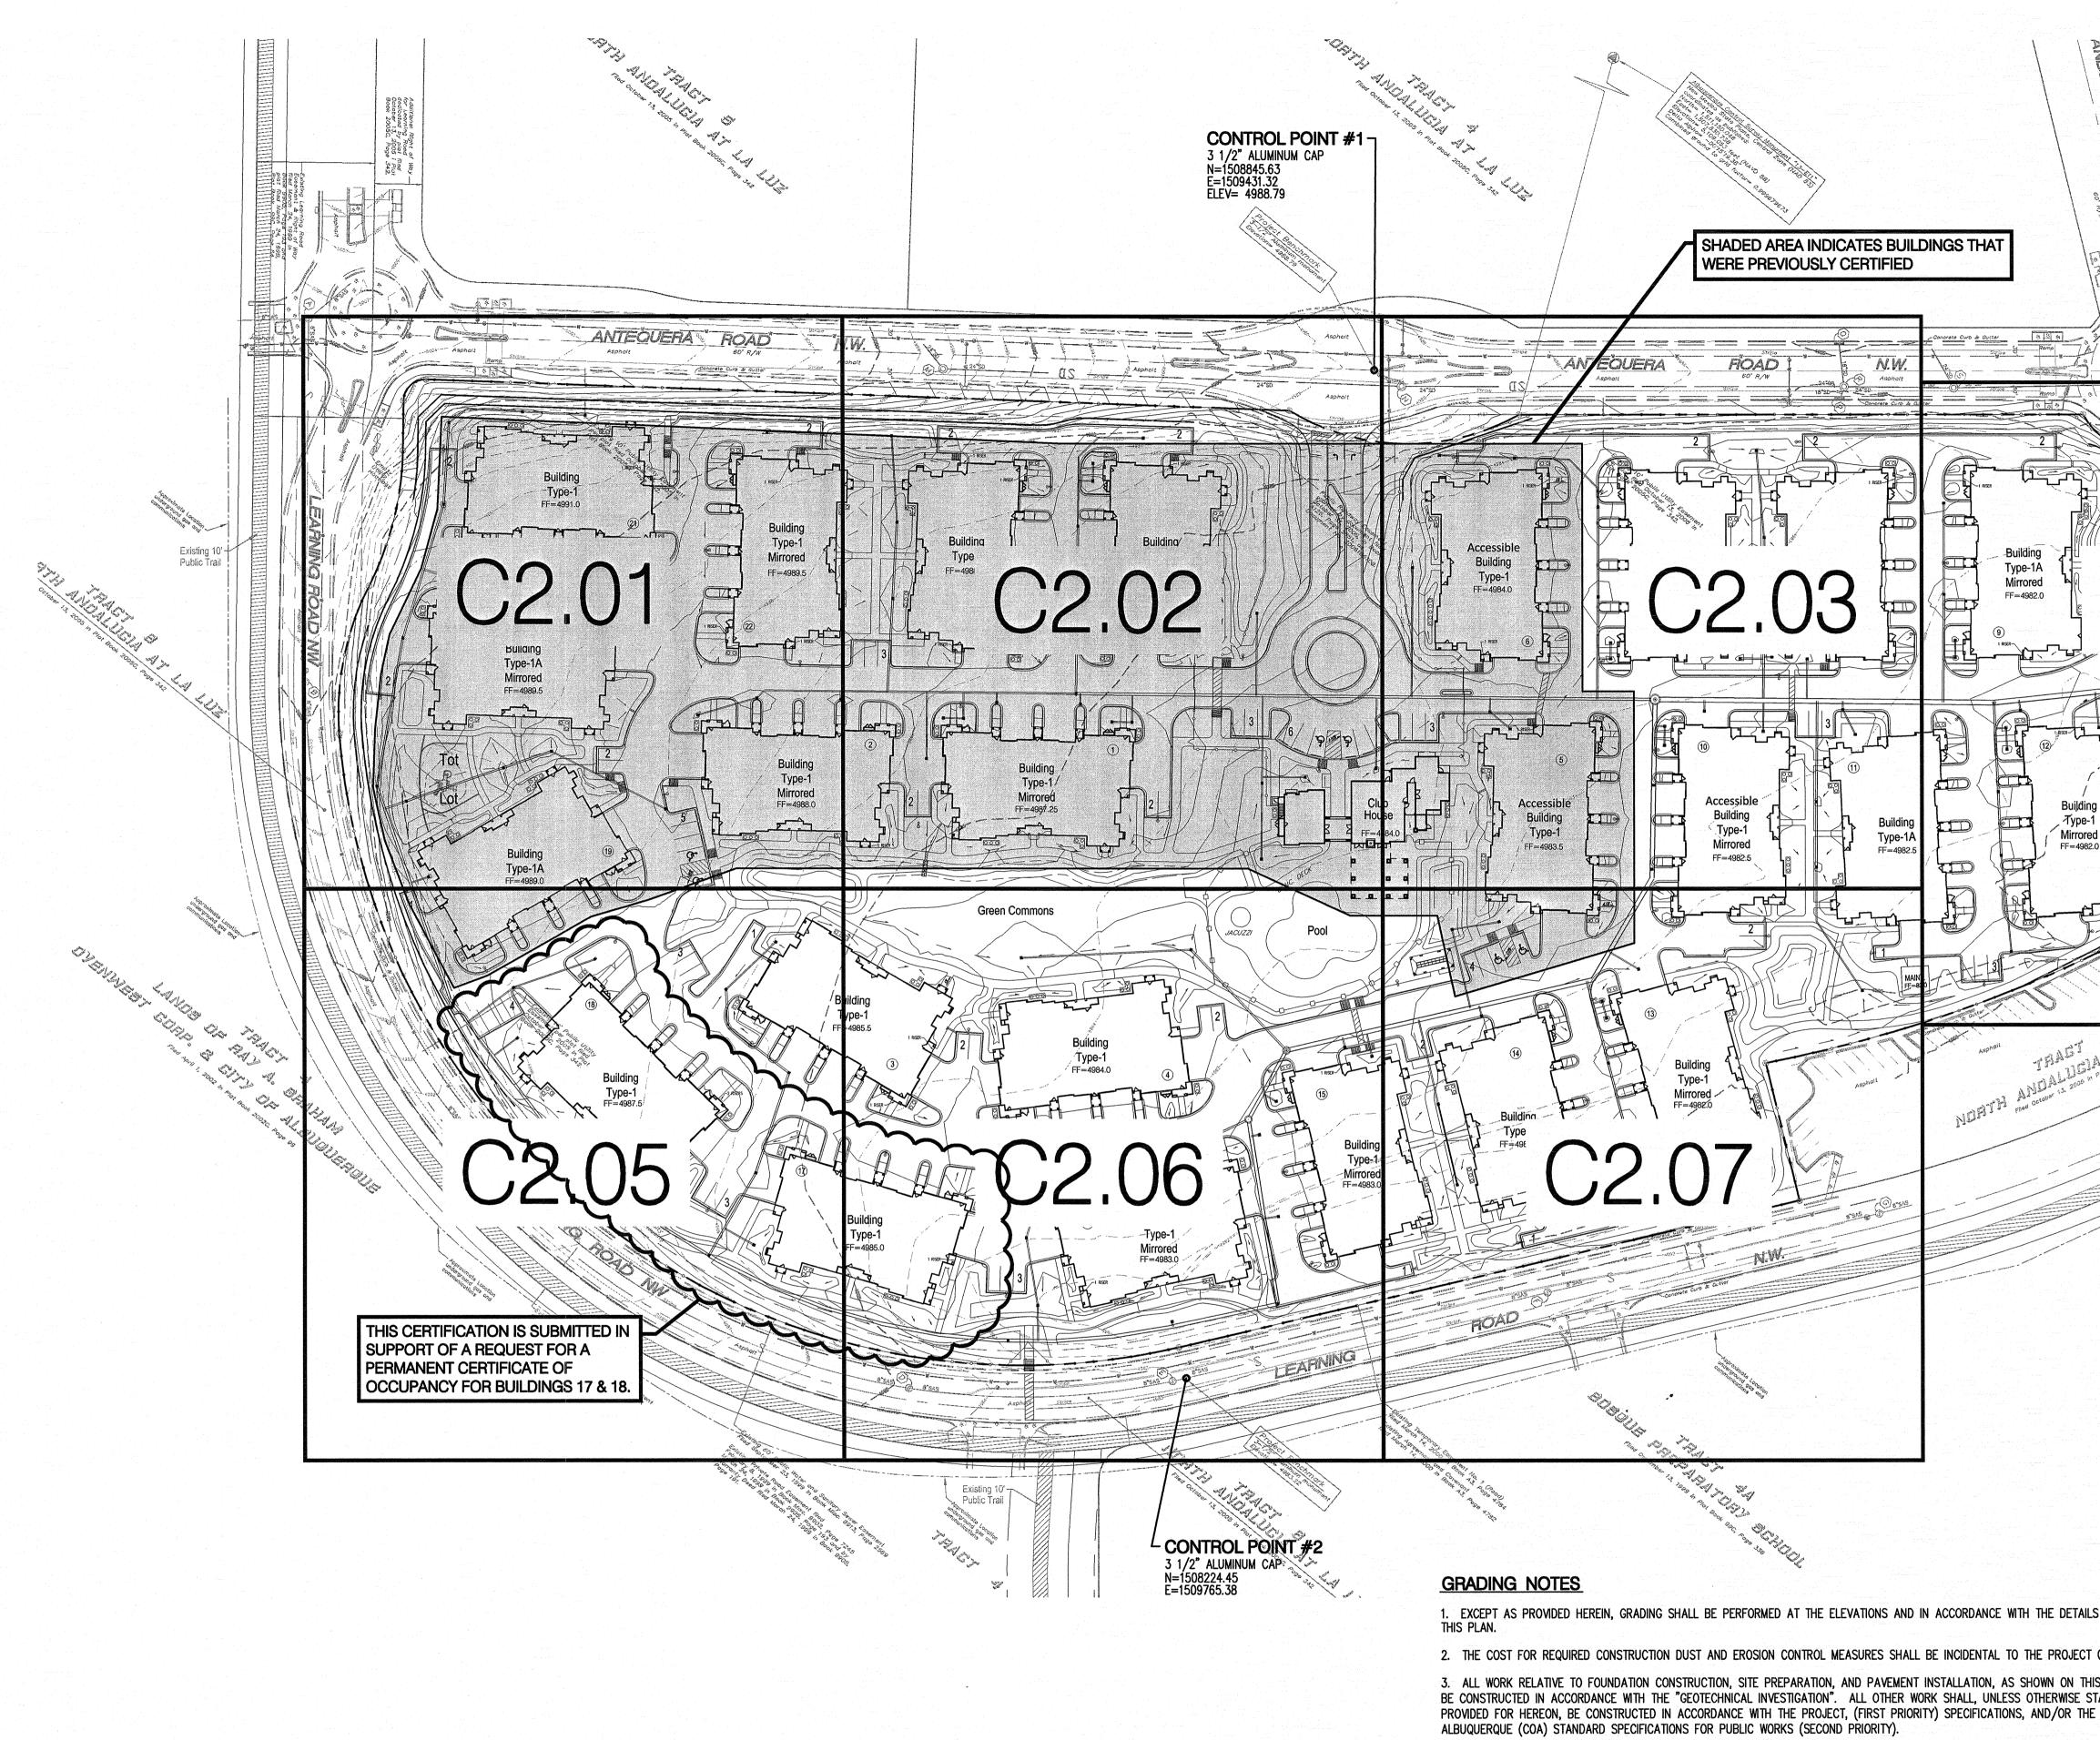4. EARTH SLOPES SHALL NOT EXCEED 3 HORIZONTAL TO 1 VERTICAL UNLESS SHOWN OTHERWISE.

5. IT IS THE INTENT OF THESE PLANS THAT THIS CONTRACTOR SHALL NOT PERFORM ANY WORK OUTSIDE OF THE PROPERTY EXCEPT AS REQUIRED BY THIS PLAN.

6. THE CONTRACTOR IS TO ENSURE THAT NO SOIL ERODES FROM THE SITE ONTO ADJACENT PROPERTY OR PUBLIC RIGHT-OF-


7. A DISPOSAL SITE FOR ANY & ALL EXCESS EXCAVATION MATERIAL, AND UNSUITABLE MATERIAL AND/OR A BORROW SITE CON ACCEPTABLE FILL MATERIAL SHALL BE OBTAINED BY THE CONTRACTOR IN COMPLIANCE WITH APPLICABLE ENVIRONMENTAL REGUL APPROVED BY THE OBSERVER. ALL COSTS INCURRED IN OBTAINING A DISPOSAL OR BORROW SITE AND HAUL TO OR FROM SHA CONSIDERED INCIDENTAL TO THE PROJECT AND NO SEPARATE MEASUREMENT OR PAYMENT SHALL BE MADE.

8. PAVING AND ROADWAY GRADES SHALL BE +/- 0.1' FROM PLAN ELEVATIONS. PAD ELEVATION SHALL BE +/- 0.05' FROM ELEVATION.

9. ALL PROPOSED CONTOURS REFLECT TOP OF PAVEMENT ELEVATIONS IN THE PARKING AREA AND MUST BE ADJUSTED FOR ISLANDS.

10. VERIFY ALL ELEVATIONS SHOWN ON PLAN FROM BASIS OF ELEVATION CONTROL STATION PRIOR TO BEGINNING CONSTRUCTION

| ANDELA STREET N.W. Assent | PROJECT BENCHMARK | Designed by: Drawn by: Architect of Record: Date Plotted: Issue for Pricing / Biddin Issue for Permit Applica Issue for Construction Revisions: # DATE | |
|---|---|--|--|
| C2. | | REGISTE | ALBUQUERQUE, NM BAY HILLS DEVELOPMENT |
| S SHOWN ON COST. S PLAN, SHALL TATED OR CITY OF BOUNDARIES -WAY. DITAINING JLATIONS AND ALL BE I BUILDING PLAN MEDIANS AND | DRAINAGE CERTIFICATION I, GLENN S. BROUGHTON, NMPE 14171, OF THE FIRM BOHANNAN HUSTON INC., HEREBY CERTIFY THAT THIS PROJECT HAS BEEN GRADED AND WILL DRAIN IN SUBSTANTAL COMPLIANCE WITH AND IN ACCORDANCE WITH THE DESIGN INTENT OF THE APPROVED PLAN DATED 1/18/2013. THE RECORD INFORMATION EDITED ONTO THE ORIGINAL DESIGN DOCUMENT HAS BEEN OBTAINED BY DAVID P. ACOSTA, NMPS 21082, OF THE FIRM CONSTRUCTION SURVEY TECHNOLOGIES, INC. I FURTHER CERTIFY THAT I HAVE PERSONALLY WISTED THE PROJECT STEE ON 4/1/2015 AND HAVE DETERMINED BY VISUAL INSPECTION THAT THE SURVEY DATA PROVIDED IS REPRESENTATIVE OF ACTUAL SITE CONDITIONS AND IS TRUE AND CORRECT TO THE BEST OF MY KNOWLEDGE AND BELIEF. THIS CERTIFICATION IS SUBMITTED IN SUPPORT OF A REQUEST FOR A PERMANENT CERTIFICATE OF OCCUPANCY FOR BUILDINGS 17 & 18. THE RECORD INFORMATION PRESENTED HEREON IS NOT NECESSARILY COMPLETE AND INTENDED ONLY TO VERIFY SUBSTANTIAL COMPLIANCE OF THE GRADING AND DRAINAGE ASPECTS OF THIS PROJECT. THOSE RELYING ON THIS RECORD DOCUMENT ARE ADVISED TO OBTAIN INDEPENDENT VERIFICATION OF ITS ACCURACY BEFORE USING IT FOR ANY OTHER PURPOSE URROSE MURDING AND DRAINAGE ASPECTS OF THIS PROJECT. THOSE RELYING ON THIS RECORD DOCUMENT ARE ADVISED TO OBTAIN INDEPENDENT VERIFICATION OF ITS ACCURACY BEFORE USING IT FOR ANY OTHER PURPOSE MURDING AND DRAINAGE ASPECTS OF THIS PROJECT. THOSE RELYING ON THIS RECORD DOCUMENT ARE ADVISED TO OBTAIN INDEPENDENT VERIFICATION OF ITS ACCURACY BEFORE USING IT FOR ANY OTHER PURPOSE MURDING AND DRAINAGE ASPECTS OF THIS PROJECT. THOSE RELYING ON THIS RECORD DOCUMENT ARE ADVISED TO OBTAIN INDEPENDENT VERIFICATION OF ITS ACCURACY BEFORE USING IT FOR ANY OTHER PURPOSE MURDING AND BRAING RADE AS-BULT GRADE MURDING AS AS BROUGHTON, NAMPE 14171 DATE: MURDING AS AS BROUGHTON, MARE 14171 DATE: MURDING AS AS BROUGHTON, MARE 14171 MURDING AS AS AS BULT GRADE | SHEET CON OVERAL DRAINAC SHEET NO. | L GRADING & |

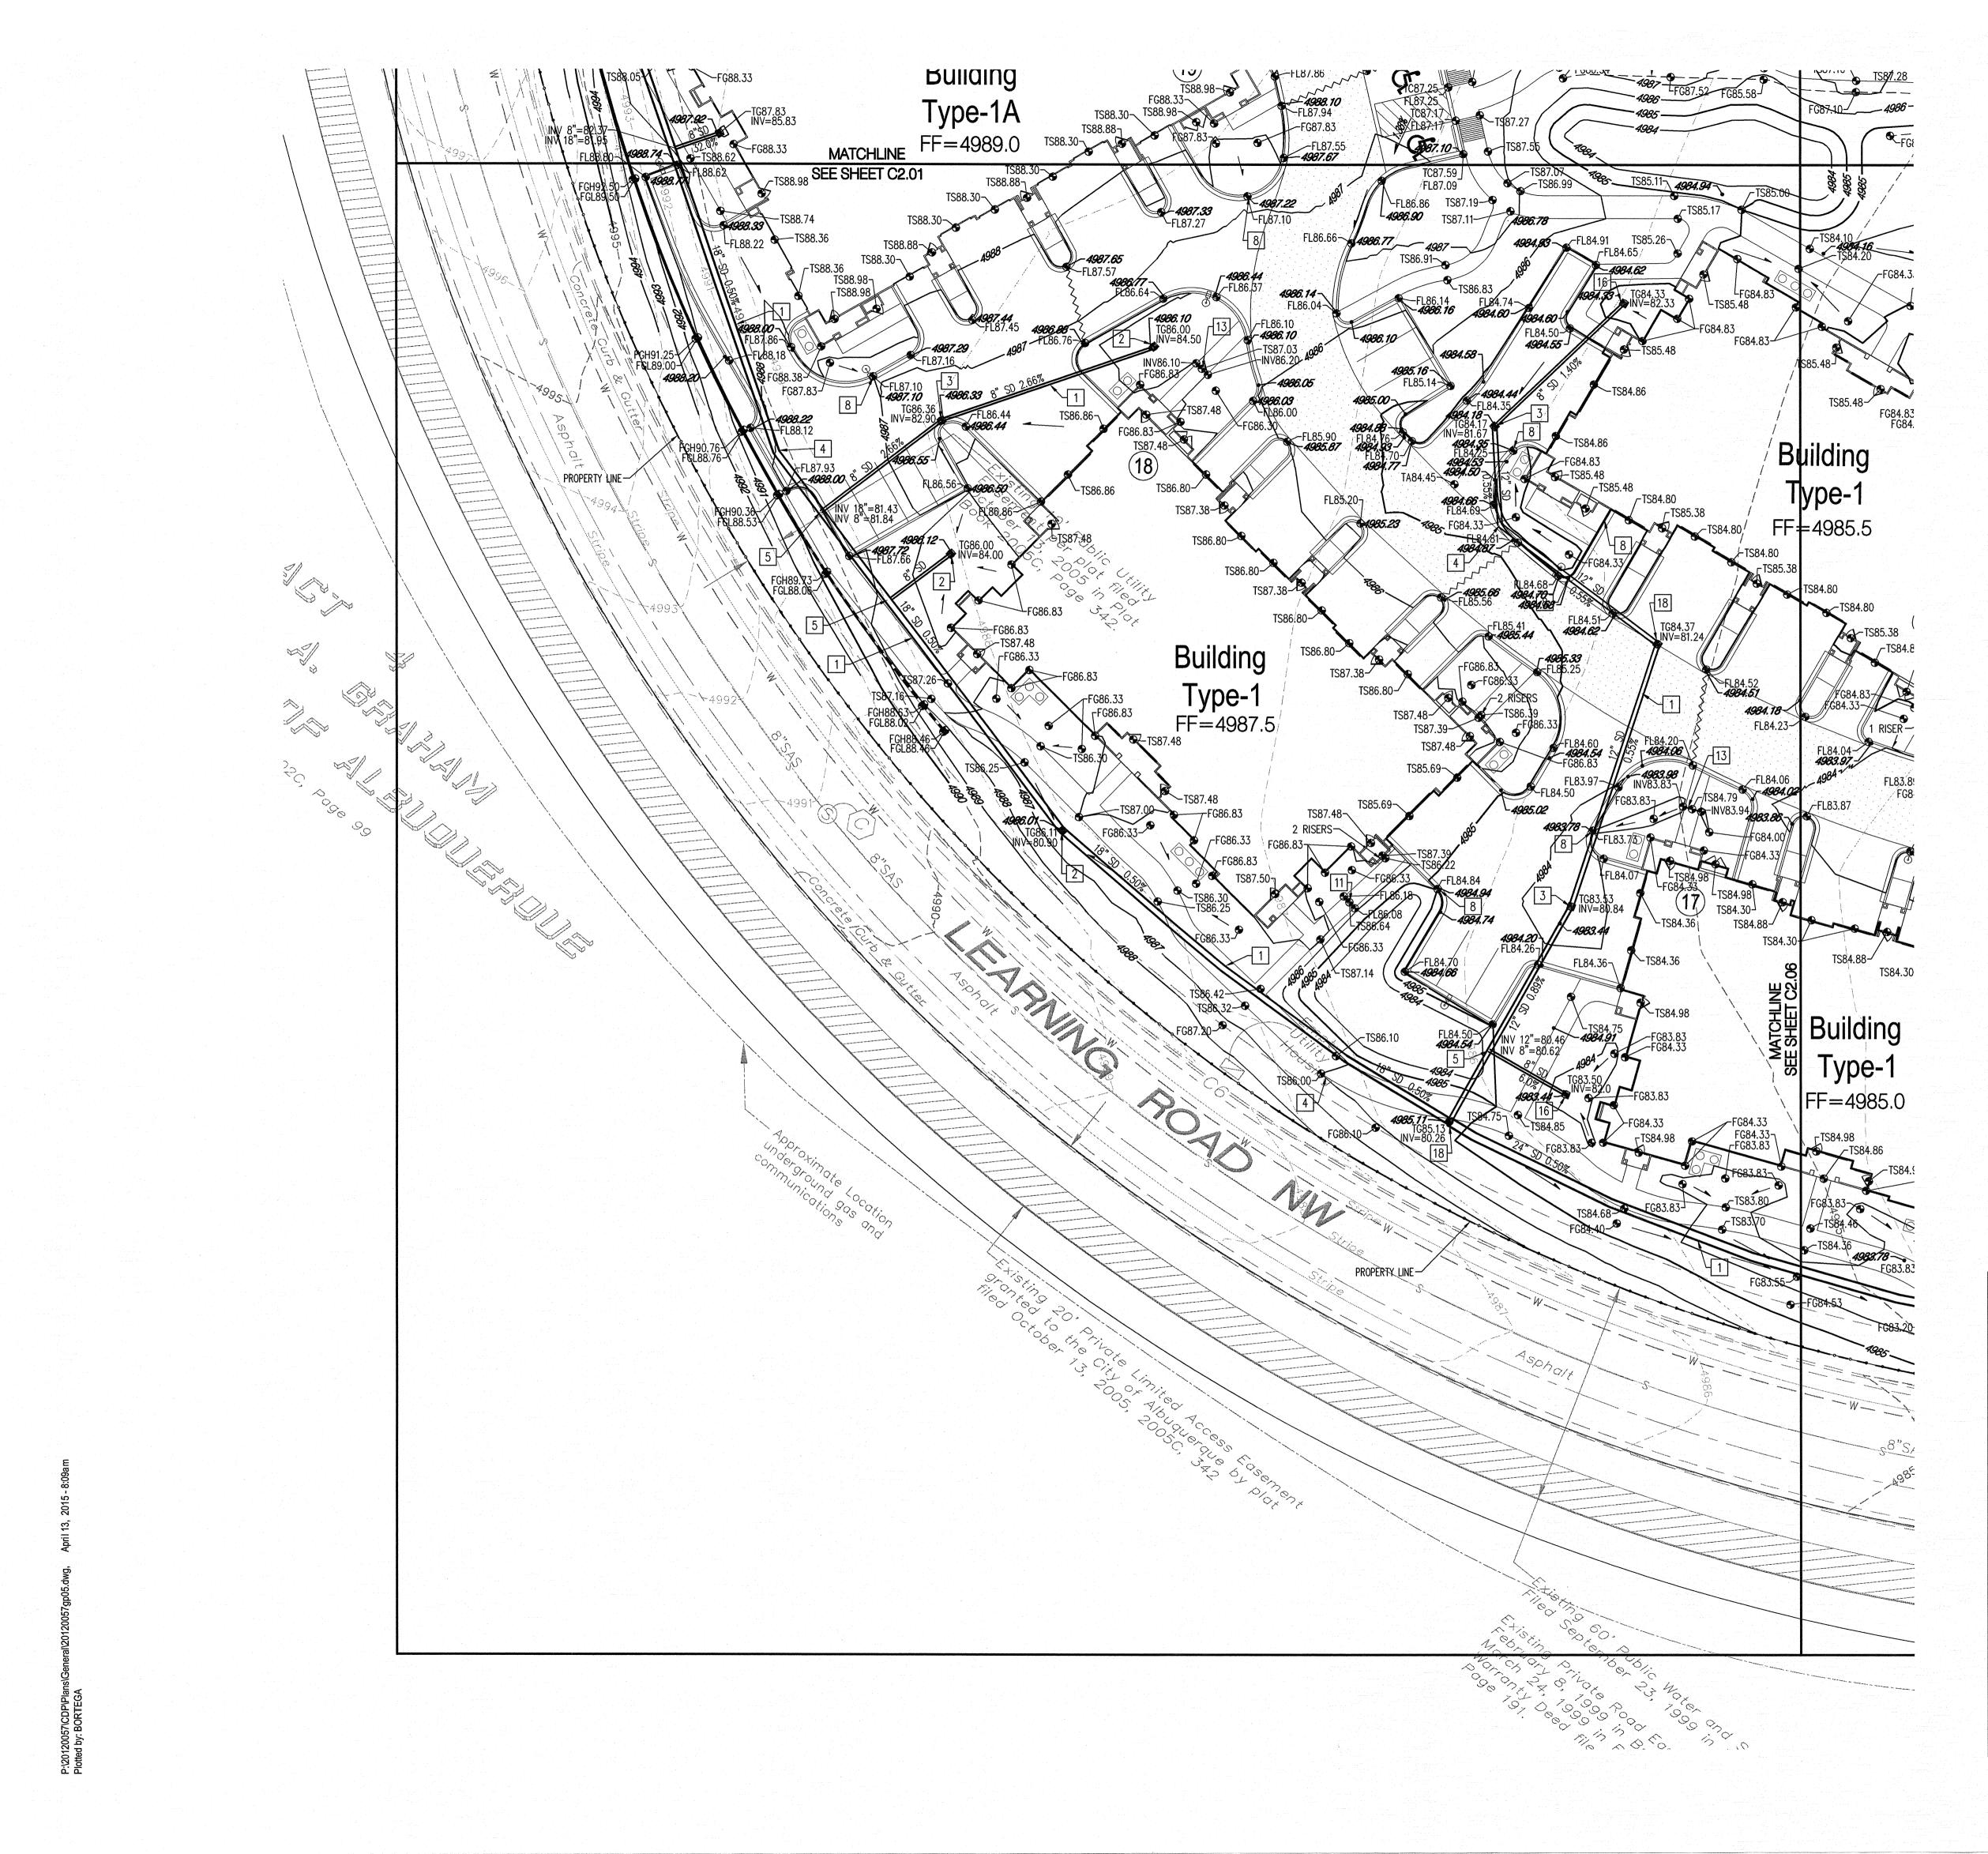


□ GRADING KEYED NOTES

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DRAINAGE CERTIFICATION

I, GLENN S. BROUGHTON, NMPE 14171, OF THE FIRM BOHANNAN HUSTON INC., HEREBY CERTIFY THAT THIS PROJECT HAS BEEN GRADED AND WILL DRAIN IN SUBSTANTIAL COMPLIANCE WITH AND IN ACCORDANCE WITH THE DESIGN INTENT OF THE APPROVED PLAN DATED 1/18/2013. THE RECORD INFORMATION EDITED ONTO THE ORIGINAL DESIGN DOCUMENT HAS BEEN OBTAINED BY DAVID P. ACOSTA, NMPS 21082, OF THE FIRM CONSTRUCTION SURVEY TECHNOLOGIES, INC. I FURTHER CERTIFY THAT I HAVE PERSONALLY VISITED THE PROJECT SITE ON 4/1/2015 AND HAVE DETERMINED BY VISUAL INSPECTION THAT THE SURVEY DATA PROVIDED IS REPRESENTATIVE OF ACTUAL SITE CONDITIONS AND IS TRUE AND CORRECT TO THE BEST OF MY KNOWLEDGE AND BELIEF. THIS CERTIFICATION IS SUBMITTED IN SUPPORT OF A REQUEST FOR A PERMANENT CERTIFICATE OF OCCUPANCY FOR BUILDINGS 17 & 18.

THE RECORD INFORMATION PRESENTED HEREON IS NOT NECESSARILY COMPLETE AND INTENDED ONLY TO VERIFY SUBSTANTIAL COMPLIANCE OF THE GRADING AND DRAINAGE ASPECTS OF THIS PROJECT. THOSE RELYING ON THIS RECORD DOCUMENT ARE ADVISED TO OBTAIN INDEPENDENT VERIFICATION OF ITS ACCURACY BEFORE USING IT FOR ANY OTHER

PURPOSE. 4/13/15 un mon GLENN S. BROUGHTON, NMPE 14171 DATE: LEGEND

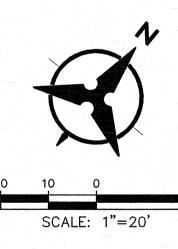DESIGN GRADE

~4984.88 AS-BUILT GRADE

FL70.22

BJS / GSB Designed by: Drawn by: Architect of Record: 1/18/13 Date Plotted: Issue for Pricing / Bidding: Issue for Permit Application: Issue for Construction DATE COMMENTS










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GRADING KEYED NOTES

1. INSTALL HDPE STORM DRAIN WITH WITH WATER TIGHT JOINTS. SEE PLAN FOR SIZE, SLOPE & INVERT ELEVATIONS.

2. INSTALL NYLOPLAST INLINE DRAIN WITH 12" DOMED GRATE.

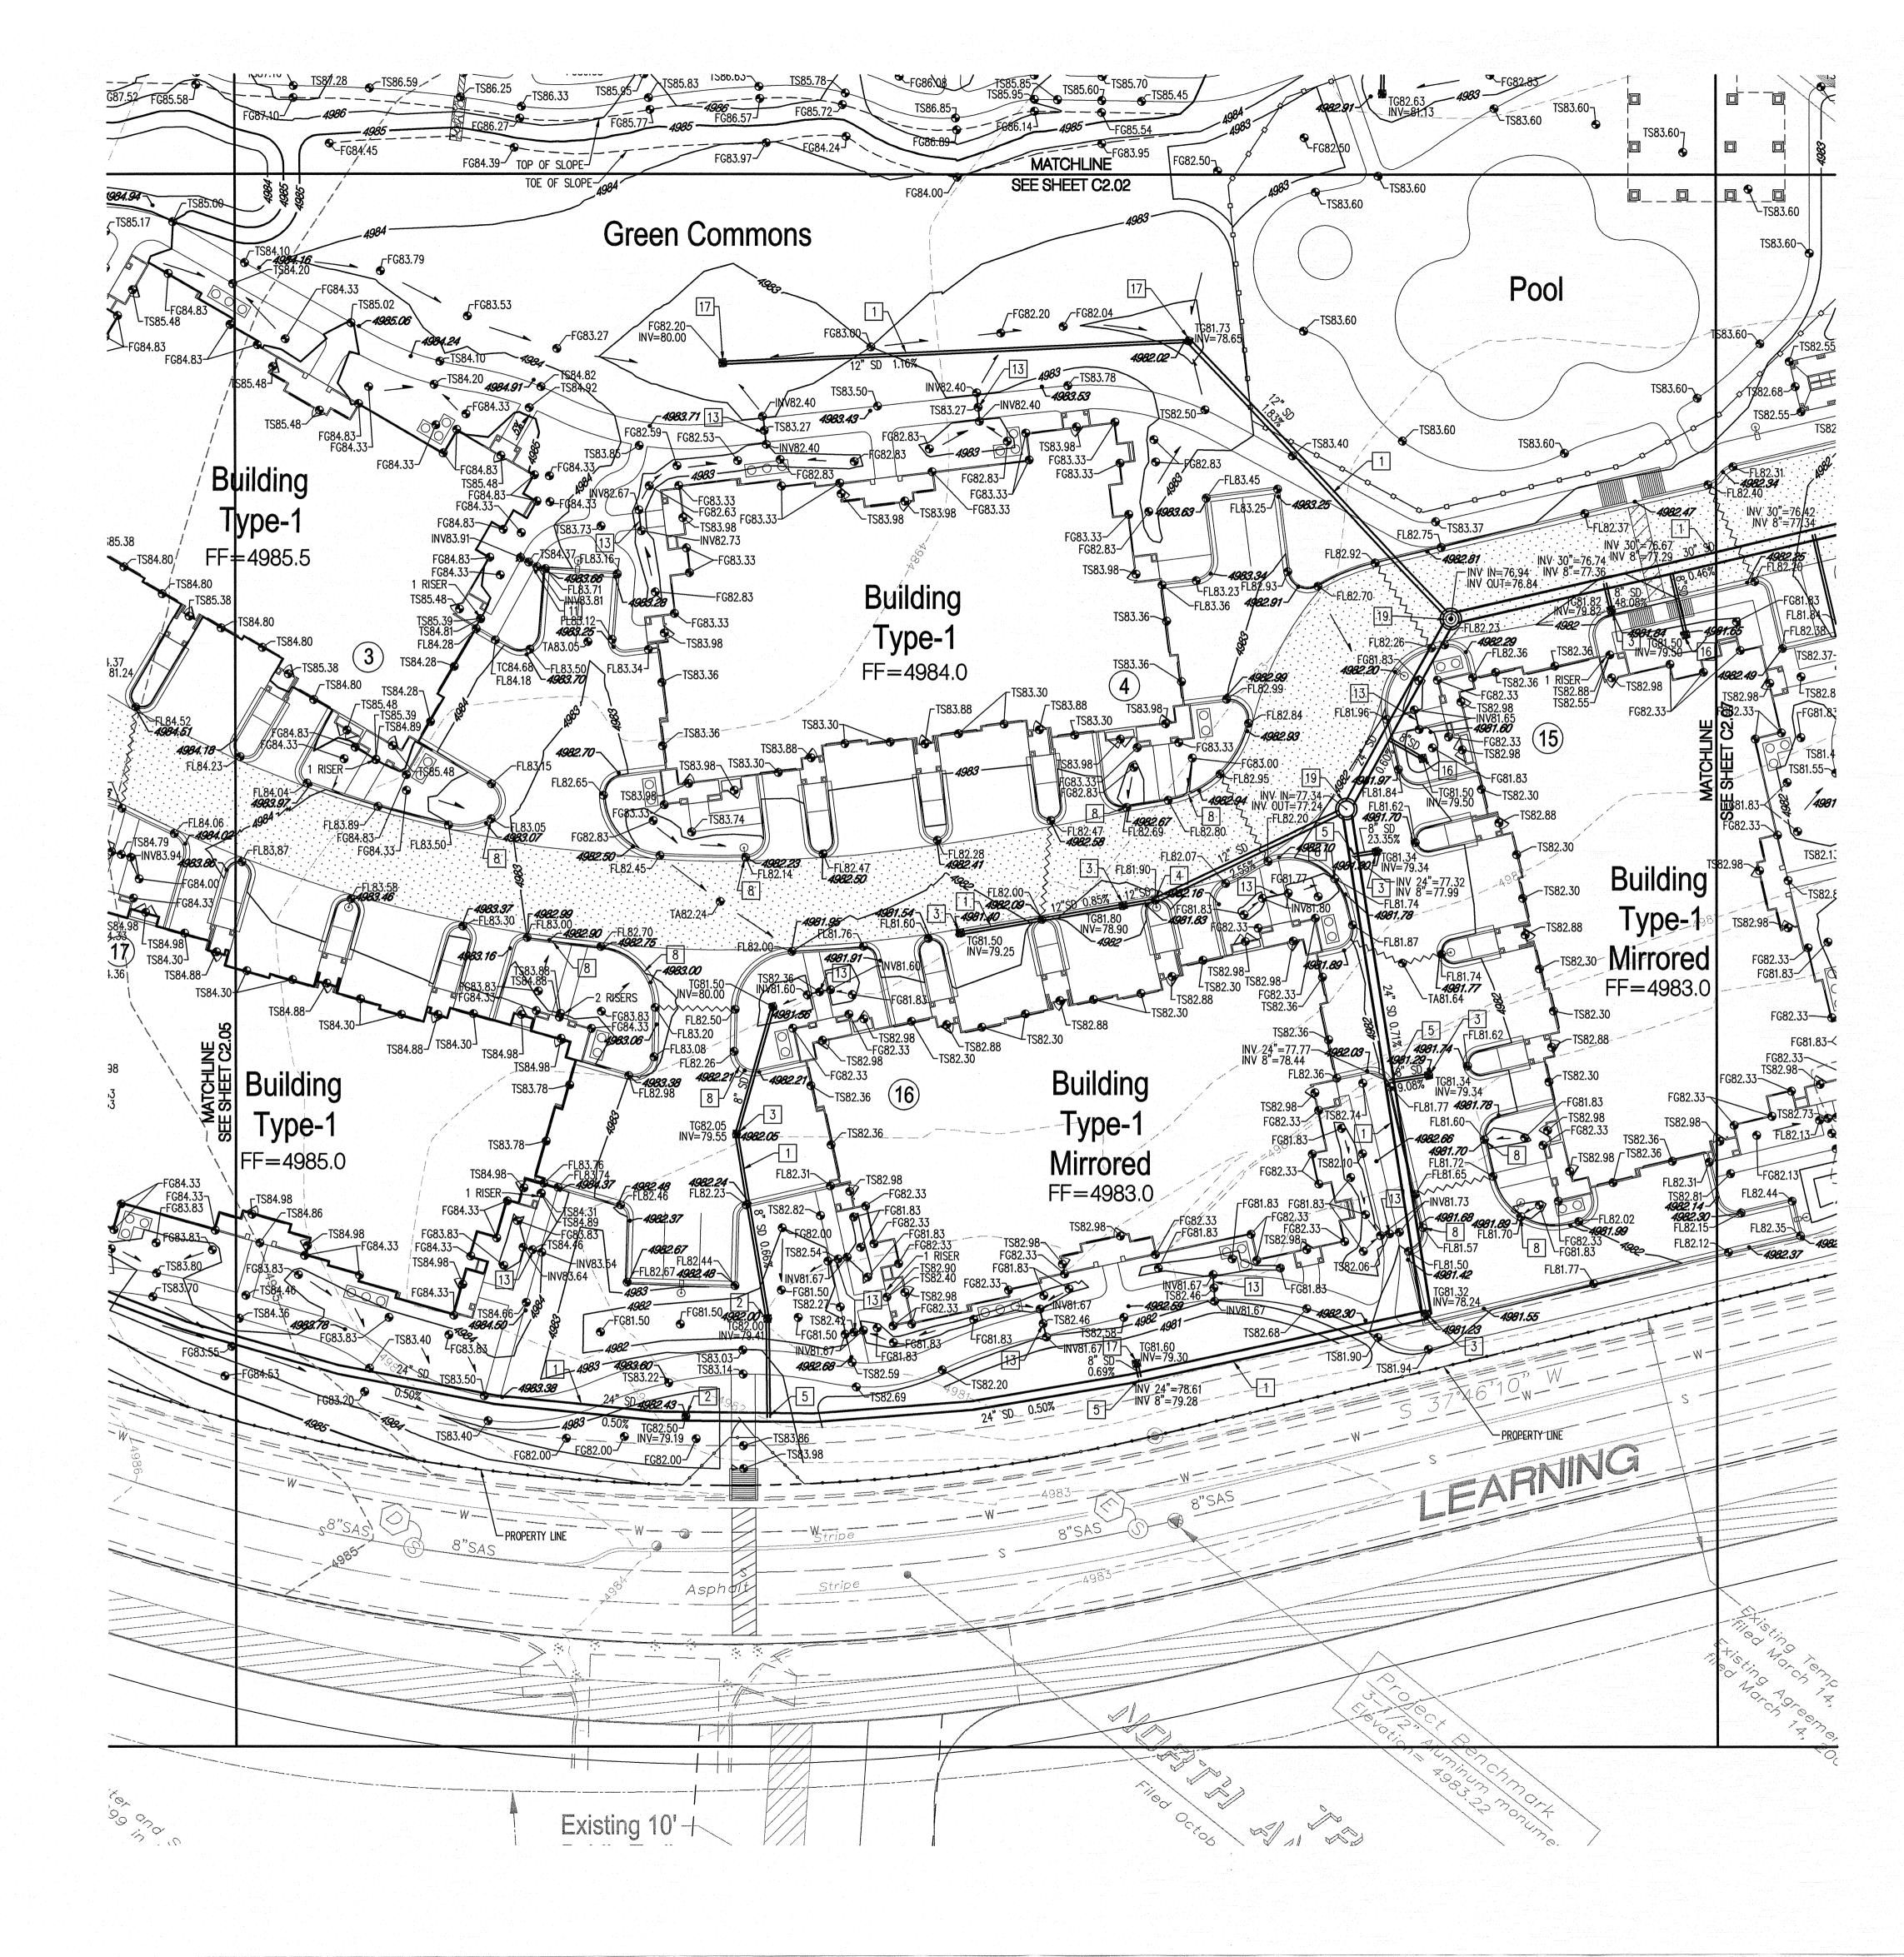- 3. INSTALL NYLOPLAST 2'x2' TRAFFIC RATED INLET & GRATE.
- 4. INSTALL PREFABRICATED BEND WITH WATER TIGHT JOINTS.
- 5. INSTALL PREFABRICATED INSERTA TEE.

6. CONNECT TO EXISTING STORM DRAIN STUB OUT WITH CONCRETE COLLAR.

7. INSTALL 18" WIDE SIDEWALK CULVERT PER COA STD DWG 2236.

- 8. CONSTRUCT 12" WIDE CURB OPENING FOR DRAINAGE.
- 9. INSTALL PREFABRICATED INSERTA WYE.
- 10. INSTALL 4' DIA TYPE "E" STORM DRAIN MANHOLE PER COA STD DWG 2102.


11. INSTALL 12" WIDE SIDEWALK CULVERT PER COA STD DWG 2236. 12. INSTALL 6' DIA TYPE "E" STORM DRAIN MANHOLE PER COA STD

13. INSTALL 6" SDR-35 PVC PIPE.

DWG 2102.

- 14. TRANSITION FROM 6" HIGH CURB TO FLUSH CURB.
- 15. MAINTAIN A 4' WIDE PEDESTRIAN WALKWAY WITH A 2.0% MAXIMUM CROSS SLOPE.
- 16. INSTALL NYLOPLAST INLINE DRAIN WITH 8" DOMED GRATE.
- 17. INSTALL NYLOPLAST INLINE DRAIN WITH 18" DOMED GRATE.18. INSTALL NYLOPLAST JUNCTION STRUCTURE.
- 19. INSTALL 4' DIA TYPE "C" STORM DRAIN MANHOLE PER COA STD DWG 2101.
- 20. CONSTRUCT 12" WIDE CONCRETE RIBBON CHANNEL PER COA STD DWG 2236, OMIT CHECKERED STEEL PLATE.
- 21. CONSTRUCT 3'-0" WIDE x 12" DEEP RIP-RAP RUNDOWN. 4"-6" ROCK OVER NON-WOVEN FILTER FABRIC.
- 22. INSTALL NYLOPLAST 2'x2' TRAFFIC RATED INLET & GRATE. CONNECT TO SANITARY SEWER SYSTEM. SEE UTILITY PLAN FOR DETAILS.

NOTE: IN LOCATIONS REQUIRING CURB OPENINGS FOR DRAINAGE (KEYED NOTE 8) THE FINISHED SURFACE OF LANDSCAPE MATERIAL SHALL BE AT EQUAL ELEVATION WITH THE ADJACENT ASPHALT PAVEMENT OR CONCRETE GUTTER.

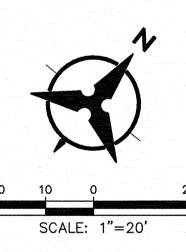


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PURPOSE 4/13/15 GLENN S. BROUGHTON, NMPE 14171 LEGEND FL70.22 DESIGN GRADE



Designed by: Drawn by: Architect of Record 1/18/13 Date Plotted: Issue for Pricing / Bidding: Issue for Permit Application: Issue for Construction evisions DATE COMMENTS



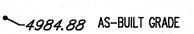



SHEET CONTENTS: GRADING & DRAINAGE PLAN

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SHEET NO.