CITY OF ALBUQUERQUE

Planning Department Brennon Williams, Director



October 1, 2020

David Thompson Thompson Engineering Consultants, Inc. P.O. Box 65760 Albuquerque, NM 87190

Drainage File: E17D076B

RE: Lovelace Medical Group, Phase 2
Lot 4, Independence Square
Request for Certificate of Occupancy - Permanent
Hydrology Final Inspection –Approved
Grading and Drainage Plan Stamp Date: 9/6/19
Certification Dated: 9/21/20

) (m)

PO Box 1293 Dear Mr. Thompson:

Based on the submittal received on 9/21/20 and field inspection 10/1/20, this certification is approved in support of Permanent Certificate of Occupancy by Hydrology.

Albuquerque

If you have any questions, please contact me at 924-3986 or earmijo@cabq.gov.

NM 87103

Sincerely,

www.cabq.gov

Ernest Armijo, P.E.

Principal Engineer, Planning Dept. Development Review Services



City of Albuquerque


Planning Department Development & Building Services Division


DRAINAGE AND TRANSPORTATION INFORMATION SHEET (REV 11/2018)

Project Title:	_		Hydrology File #: Work Order#:	
DRB#:				
Legal Description:				
City Address:				
Applicant:			Contact:	
Address:				
			E-mail:	
Owner:			Contact:	
Address:				
			E-mail:	
TYPE OF SUBMITTAL:PLA	Γ (# OF LOTS)	RESIDENCE	_ DRB SITE ADMIN SITE	
IS THIS A RESUBMITTAL?:	Yes	No		
DEPARTMENT: TRAFFIC/ T	RANSPORTATION _	HYDROLOG	Y/ DRAINAGE	
Check all that Apply: TYPE OF SUBMITTAL: ENGINEER/ARCHITECT CERTIFICATION PAD CERTIFICATION CONCEPTUAL G & D PLAN GRADING PLAN DRAINAGE MASTER PLAN DRAINAGE REPORT FLOODPLAIN DEVELOPMENT PERMIT APPLIC ELEVATION CERTIFICATE CLOMR/LOMR TRAFFIC CIRCULATION LAYOUT (TCL) TRAFFIC IMPACT STUDY (TIS) OTHER (SPECIFY) PRE-DESIGN MEETING?		TYPE OF APPROVAL/ACCEPTANCE SOUGHT: BUILDING PERMIT APPROVAL CERTIFICATE OF OCCUPANCY PRELIMINARY PLAT APPROVAL SITE PLAN FOR SUB'D APPROVAL SITE PLAN FOR BLDG. PERMIT APPROVAL FINAL PLAT APPROVAL SIA/ RELEASE OF FINANCIAL GUARANTEE FOUNDATION PERMIT APPROVAL GRADING PERMIT APPROVAL SO-19 APPROVAL PAVING PERMIT APPROVAL GRADING/ PAD CERTIFICATION WORK ORDER APPROVAL CLOMR/LOMR FLOODPLAIN DEVELOPMENT PERMIT OTHER (SPECIFY)		
DATE SUBMITTED:	By:			

COA STAFF: ELECTRONIC SUBMITTAL RECEIVED:____

FEE PAID:

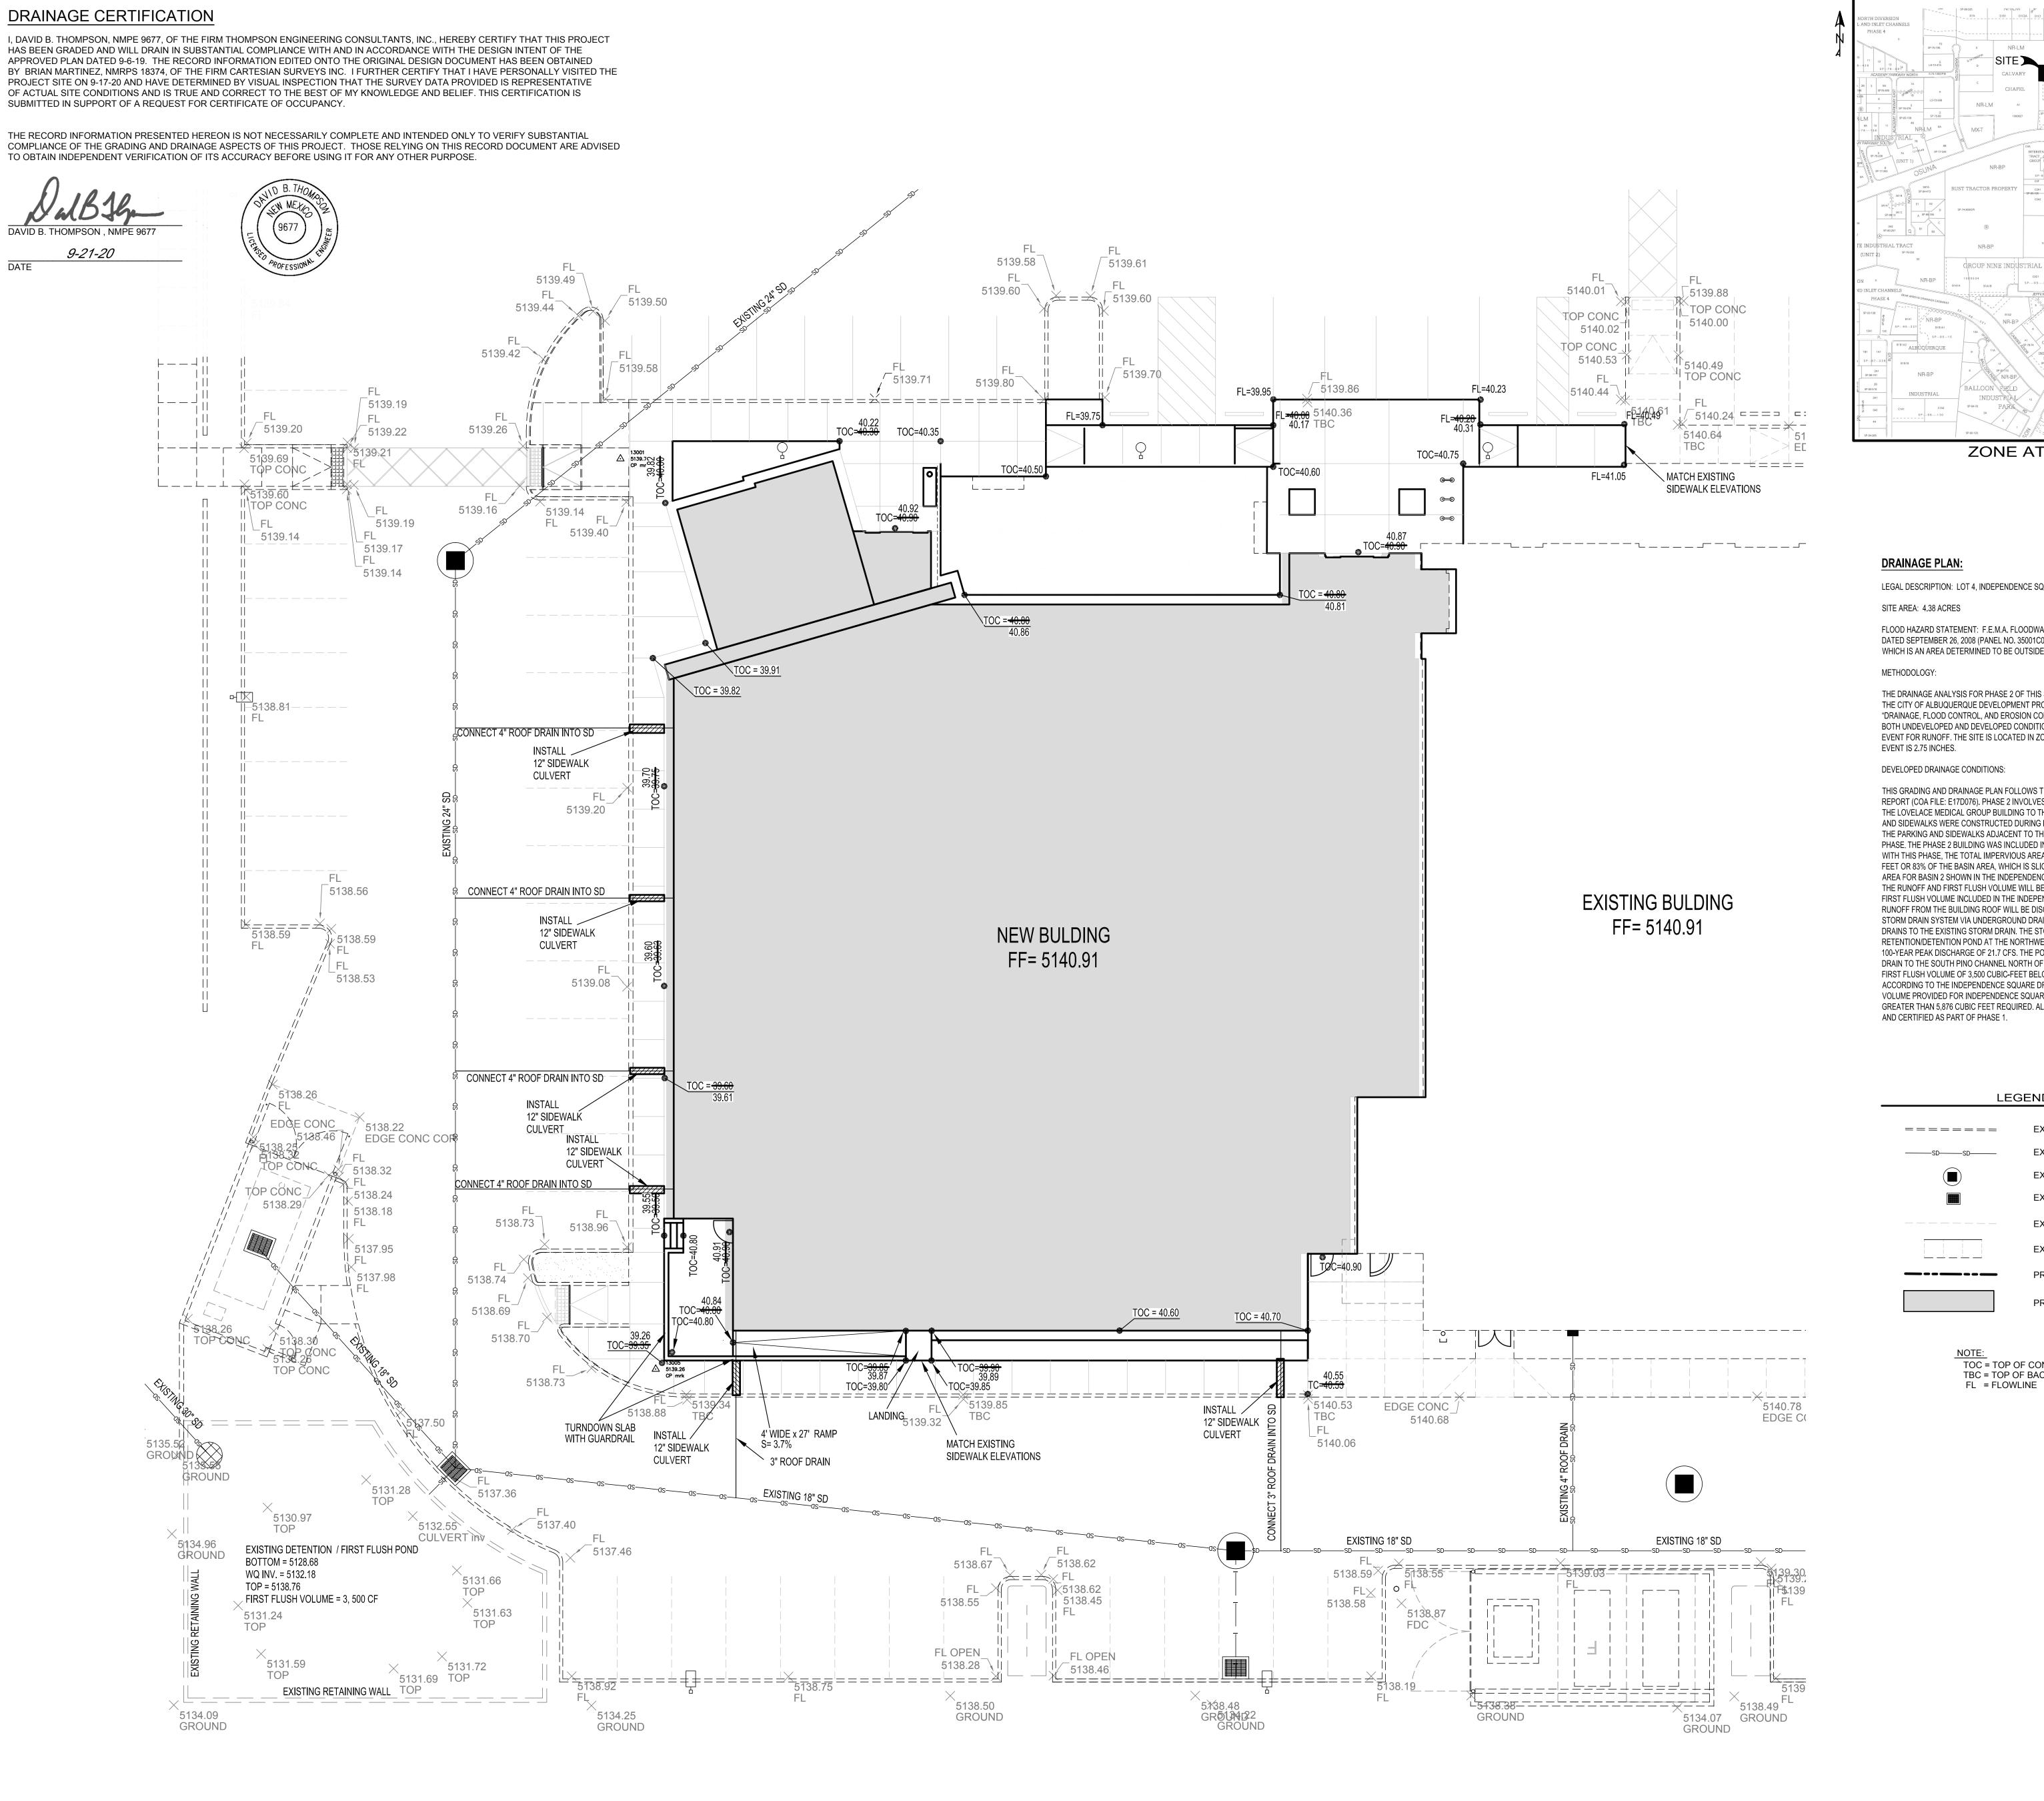

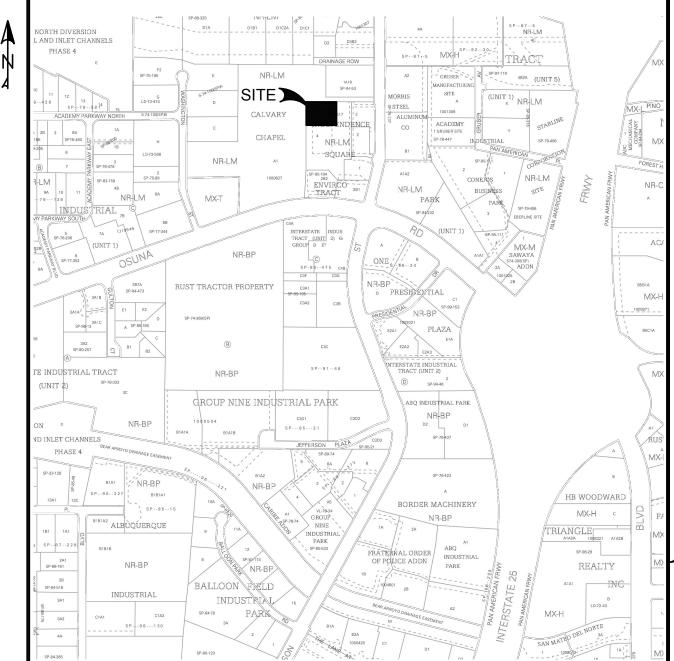

ZONE ATLAS MAP: E-17-Z

LEGAL DESCRIPTION: LOT 4, INDEPENDENCE SQUARE

FLOOD HAZARD STATEMENT: F.E.M.A. FLOODWAY BOUNDARY AND FLOODWAY MAP DATED SEPTEMBER 26, 2008 (PANEL NO. 35001C0136G) INDICATES A FLOOD HAZARD ZONE X WHICH IS AN AREA DETERMINED TO BE OUTSIDE THE 500-YEAR FLOODPLAIN.

THE DRAINAGE ANALYSIS FOR PHASE 2 OF THIS SITE IS IN ACCORDANCE WITH SECTION 22 OF THE CITY OF ALBUQUERQUE DEVELOPMENT PROCESS MANUAL (DPM), ENTITLED "DRAINAGE, FLOOD CONTROL, AND EROSION CONTROL." THE DESIGN STORM USED FOR BOTH UNDEVELOPED AND DEVELOPED CONDITIONS IS THE 100-YEAR, 24-HOUR STORM EVENT FOR RUNOFF. THE SITE IS LOCATED IN ZONE 2 SO THE 100-YEAR, 24-HOUR STORM

THIS GRADING AND DRAINAGE PLAN FOLLOWS THE INDEPENDENCE SQUARE DRAINAGE REPORT (COA FILE: E17D076), PHASE 2 INVOLVES THE CONSTRUCTION OF THE EXPANSION OF THE LOVELACE MEDICAL GROUP BUILDING TO THE NORTH. THE MAJORITY OF THE PAVING AND SIDEWALKS WERE CONSTRUCTED DURING PHASE 1. SOME MINOR ADJUSTMENTS TO THE PARKING AND SIDEWALKS ADJACENT TO THE BUILDING ARE INCLUDED WITH THIS PHASE. THE PHASE 2 BUILDING WAS INCLUDED IN BASIN 2 OF THE ORIGINAL DRAINAGE REPORT. WITH THIS PHASE, THE TOTAL IMPERVIOUS AREA FOR BASIN 2 IS 25,100 SQUARE FEET OR 83% OF THE BASIN AREA, WHICH IS SLIGHTLY LESS THAN THE 85% IMPERVIOUS AREA FOR BASIN 2 SHOWN IN THE INDEPENDENCE SQUARE DRAINAGE REPORT. THEREFORE, THE RUNOFF AND FIRST FLUSH VOLUME WILL BE SLIGHTLY LESS THAN THE RUNOFF AND FIRST FLUSH VOLUME INCLUDED IN THE INDEPENDENCE SQUARE DRAINAGE REPORT. RUNOFF FROM THE BUILDING ROOF WILL BE DISCHARGED DIRECTLY TO THE EXISTING STORM DRAIN SYSTEM VIA UNDERGROUND DRAIN PIPES. ALL RUNOFF FROM PHASE 2 DRAINS TO THE EXISTING STORM DRAIN. THE STORM DRAIN DISCHARGES TO A RETENTION/DETENTION POND AT THE NORTHWEST CORNER OF THE SITE. THIS POND HAS A 100-YEAR PEAK DISCHARGE OF 21.7 CFS. THE POND DRAINS THROUGH A 30-INCH STORM DRAIN TO THE SOUTH PINO CHANNEL NORTH OF THE SITE. THIS POND ALSO INCLUDES A FIRST FLUSH VOLUME OF 3,500 CUBIC-FEET BELOW THE DISCHARGE ELEVATION. ACCORDING TO THE INDEPENDENCE SQUARE DRAINAGE REPORT THE TOTAL FIRST FLUSH VOLUME PROVIDED FOR INDEPENDENCE SQUARE LOT 4 IS 5,878 CUBIC FEET, WHICH IS GREATER THAN 5,876 CUBIC FEET REQUIRED. ALL FIRST FLUSH PONDS WERE CONSTRUCTED

LEGEND

EXISTING CURB & GUTTER EXISTING STORM DRAIN EXISTING STORM DRAIN MANHOLE EXISTING STORM DRAIN INLET EXISTING PARKING STRIPE

> PROPERTY BOUNDARY PROPOSED BUILDING

EXISTING SIDEWALK

NOTE: TOC = TOP OF CONCRETE TBC = TOP OF BACK OF CURB

ADDITION

CLINIC

ARCHITECT

ENGINEER

PROJECT

PHONE: (505) 271-2199

ALBUQUERQUE, NM 87 193 FAX: (505) 830-9248

REVISIONS 90 RFI - 054 <u>∕</u>74 ASI - 019

DRAWN BY	DEM	
REVIEWED BY	DBT	
DATE	August 2019	
PROJECT NO.	19-0041	
DRAWING NAME		

GRADING & DRAINAGE PLAN

SHEET NO.

C101 SCALE: 1"=10'