CITY OF ALBUQUERQUE

Planning Department Brennon Williams, Director



November 13, 2020

Scott McGee, P.E. 9700 Tanoan Drive NE Albuquerque, NM 87111

RE: Harper Apartments Office 6100 Harper Dr. NE Grading and Drainage Plan Engineer's Stamp Date: 08/31/20 Hydrology File: E18D016

Dear Mr. McGee:

Based upon the information provided in your submittal received 10/21/2020, the Grading and Drainage Plan is approved for Building Permit.

PO Box 1293 Drainage Plan is approved for Building Permit

Please attach a copy of this approved plan in the construction sets for Building Permit processing along with a copy of this letter. Prior to approval in support of Permanent Release of Occupancy

by Hydrology, Engineer Certification per the DPM checklist will be required.

Find Hydrology forms and information at: cabq.gov/planning/development-review-services/hydrology-section

If the project total area of disturbance (including the staging area and any work within the adjacent Right-of-Way) is 1 acre or more, then an Erosion and Sediment Control (ESC) Plan and Owner's certified Notice of Intent (NOI) is required to be submitted to the Stormwater Quality Engineer (Doug Hughes, PE, jhughes@cabq.gov, 924-3420) 14 days prior to any earth

www.cabq.gov disturbance.

NM 87103

Also, please provide the Drainage Covenant for the existing detention ponds per Article 6-15(C) of the DPM prior to Permanent Release of Occupancy. There is a recording fee (\$25, payable to Bernalillo County). Please contact Charlotte LaBadie (clabadie@cabq.gov, 924-3996). Due to COVID-19, please follow the instructions:

Either email a pdf copy of the executed drainage covenant and the exhibit to clabadie@cabq.gov or either mail or drop off the originals. Please mail the \$25.00 recording fee check made payable to Bernalillo County to:

Planning Dept./DRC Attn: Charlotte LaBadie 600 2nd St. NW, Ste. 400 ABQ, NM, 87102

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Mayor Timothy M. Keller

If you drop off the originals, there is a drop box outside the building labeled DRC. Once approved and recorded, Charlotte will email you a copy.

If you have any questions, please contact me at 924-3995 or rbrissette@cabq.gov.

Sincerely, Renée C. Brissette

Renée C. Brissette, P.E. CFM Senior Engineer, Hydrology Planning Department

PO Box 1293

Albuquerque

NM 87103

www.cabq.gov



City of Albuquerque


Planning Department Development & Building Services Division


DRAINAGE AND TRANSPORTATION INFORMATION SHEET (REV 11/2018)

Project Title: Building F		Permit #:	Hydrology File #:	
DRB#:	EPC#:		Work Order#:	
Legal Description:				
City Address:				
Applicant:			Contact:	
Address:				
			E-mail:	
Owner:			Contact:	
Address:				
			E-mail:	
TYPE OF SUBMITTAL:PLA	Γ (# OF LOTS)	RESIDENCE	_ DRB SITE ADMIN SITE	
IS THIS A RESUBMITTAL?:	Yes	No		
DEPARTMENT: TRAFFIC/ T	RANSPORTATION _	HYDROLOG	Y/ DRAINAGE	
Check all that Apply: TYPE OF SUBMITTAL: ENGINEER/ARCHITECT CERTIFICATION PAD CERTIFICATION CONCEPTUAL G & D PLAN GRADING PLAN DRAINAGE MASTER PLAN DRAINAGE REPORT FLOODPLAIN DEVELOPMENT PERMIT APPLIC ELEVATION CERTIFICATE CLOMR/LOMR TRAFFIC CIRCULATION LAYOUT (TCL) TRAFFIC IMPACT STUDY (TIS) OTHER (SPECIFY) PRE-DESIGN MEETING?		TYPE OF APPROVAL/ACCEPTANCE SOUGHT: BUILDING PERMIT APPROVAL CERTIFICATE OF OCCUPANCY PRELIMINARY PLAT APPROVAL SITE PLAN FOR SUB'D APPROVAL SITE PLAN FOR BLDG. PERMIT APPROVAL FINAL PLAT APPROVAL SIA/ RELEASE OF FINANCIAL GUARANTEE FOUNDATION PERMIT APPROVAL GRADING PERMIT APPROVAL SO-19 APPROVAL PAVING PERMIT APPROVAL GRADING/ PAD CERTIFICATION WORK ORDER APPROVAL CLOMR/LOMR FLOODPLAIN DEVELOPMENT PERMIT OTHER (SPECIFY)		
DATE SUBMITTED:	By:			


COA STAFF: ELECTRONIC SUBMITTAL RECEIVED:____

FEE PAID:

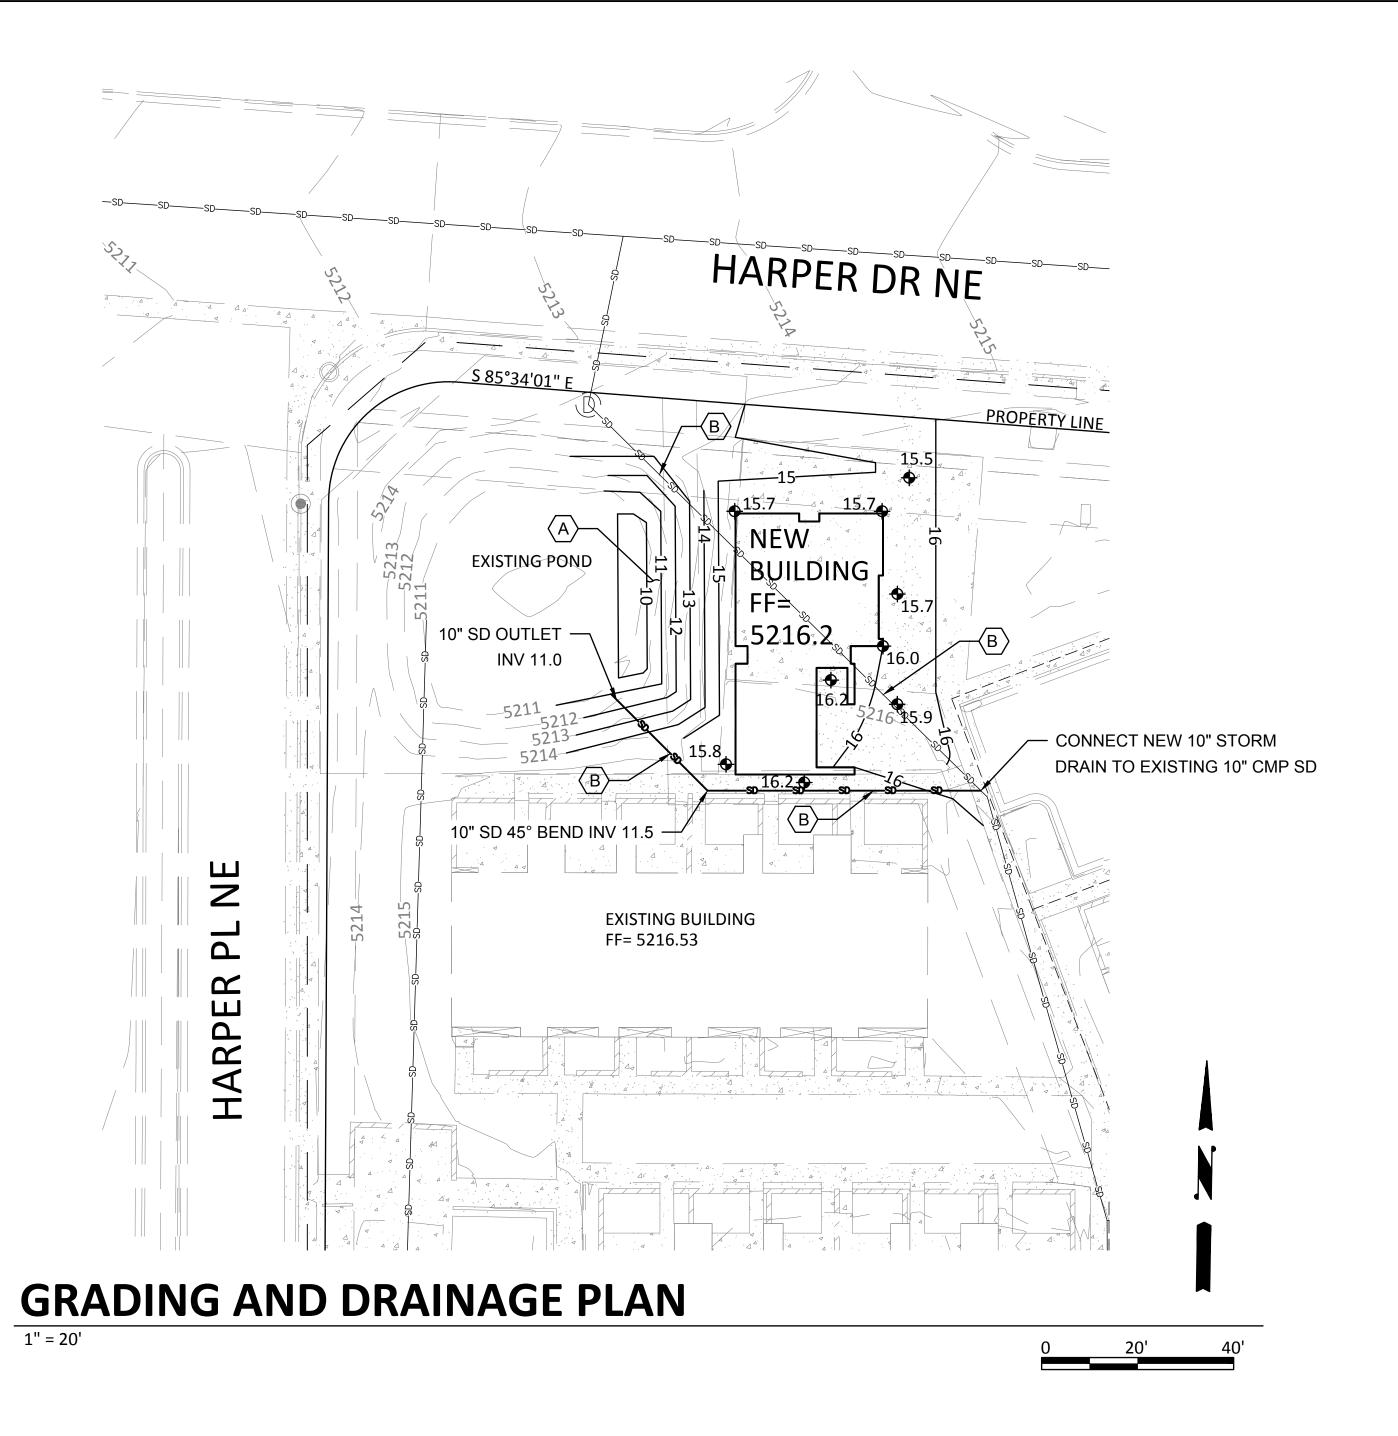


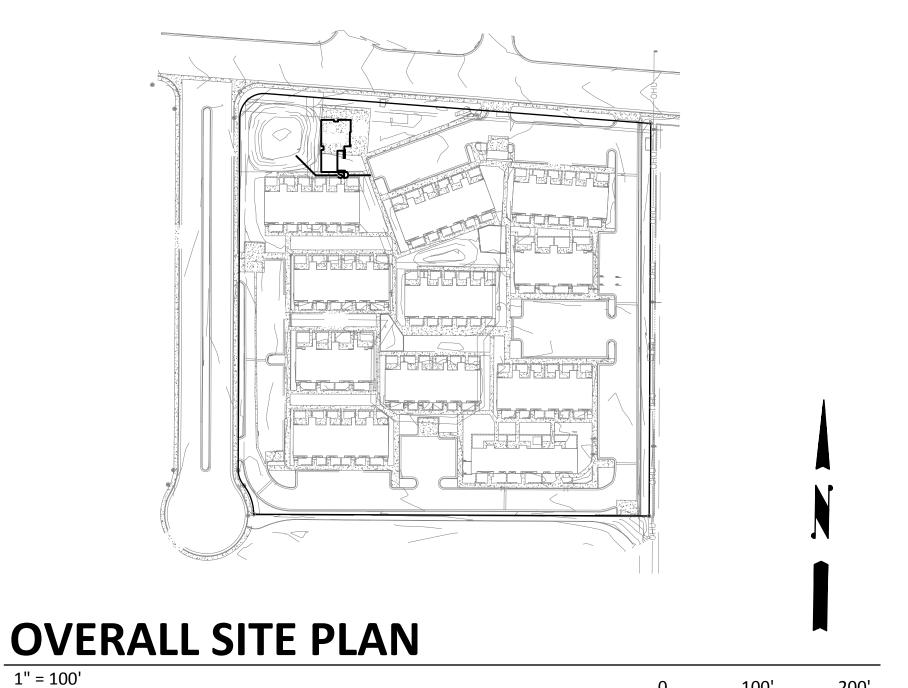

1" = 100'

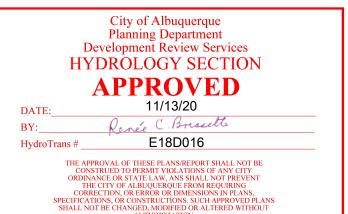



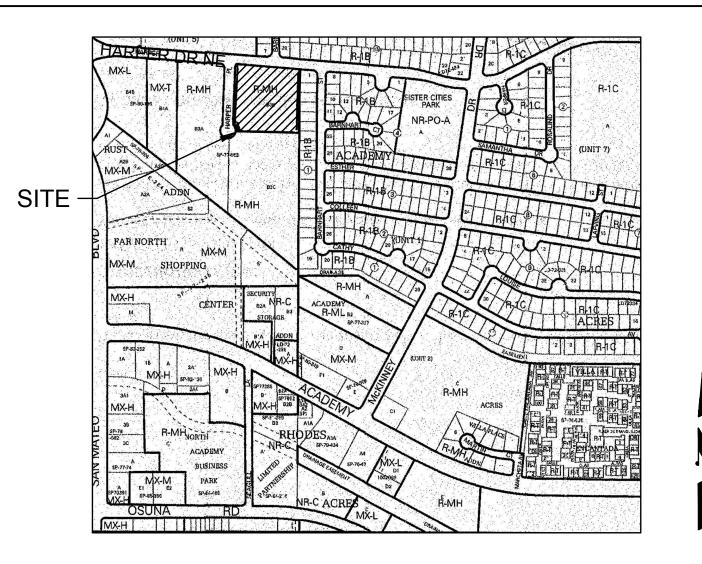

VICINITY MAP

E-18-Z

LEGEND EXISTING CONSTRUCTION NEW CONTOUR FF=5216.2 PROPOSED BUILDING FINISH FLOOR ELEV **♦**36.5 **NEW SPOT ELEVATION NEW CONSTRUCTION ─SD** NEW STORM DRAIN TOP OF CURB

KEYED NOTES

- 100 CF AND REPLACE ROCK ARMORING ON POND SIDE AND BOTTOM.
- REMOVE EXISTING 10" CMP STORM DRAIN UNDER THE NEW BUILDING AND PLUG ENDS WITH GROUT. INSTALL NEW 10" STORM DRAIN AS SHOWN SOUTH OF THE NEW BUILDING TO DISCHARGE INTO THE POND.

DRAINAGE ANALYSIS

ADDRESS: 6100 Harper Drive NE, Albuquerque, NM

LEGAL DESCRIPTION: TRACT B-3-B, SUMMARY REPLAT OF TRACT B-3 ACADEMY ACRES SUBD UNIT #5

SITE AREA: 1.98 AC PROJECT AREA: 11,500 SF (0.264 AC)

BENCHMARK: City of Albuquerque Station '21-E18' being a brass cap located on the north side of Harper Drive across the street. ELEV= 5217.15 (NAVD 1988)

SURVEYOR: Cartesian Surveys Inc. dated August, 2020

FLOOD HAZARD: From FEMA Map 35001C0139G (9/26/2008), this site is identified as being within Zone 'X' which is determined to be outside the 0.2% annual chance floodplain.

OFFSITE FLOW: The site does not accept offsite flow as public streets border the site to the north and west. An existing block wall while Alameda Blvd runs along the east side of the lot.

EXISTING CONDITIONS: The site is currently developed with 11 residential apartment buildings, existing paved access and parking, and landscaped areas. The site slopes down to the west at 0.5 - 1% and discharges to Harper Drive NE. In this NW corner of the site there is an outdoor basketball court and a fenced storm water retention pond.

PROPOSED IMPROVEMENTS: The proposed improvements include a 1,350 SF office and community building, concrete sidewalks, and landscaping. This building will be located where the existing BB court was located.

DRAINAGE APPROACH: The site drainage pattern will follow historic conditions and include the onsite retention of the SWQ volume.

Existing land treatment: 72% C and 28% D PRECIPITATION ZONE: 3 Q = [(0.72)(3.45) + (.28)(5.02)](0.264) = 1.0 CFSProposed land treatment: 71% C and 29% D Q = [(0.71)(3.45)+(0.29)(5.02)](0.264) = 1.0 CFS

SWQ V= (2,070)(0.34/12)= 59 CF

This flow will discharge to an onsite retention ponding area located west of the community building. The SWQ volume of 2,326 CF will be retained in the pond bottom. Site discharge will remain unchanged.

job no: drawn: checked: July 18, 2020 date:

 \approx

sheet no:

100 HARPER BUQUERQUE, 7109

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