WATER HARVESTING POND VOLUME CALCULATIONS

WATER HARVESTING	PUND VULUM	E CALCULATIONS
POND NO. 1		
CONTOUR ELEVATION	AREA (SF)	VOLUME (CF)
5210.00	3 SF	— 50.0 CF
5211.00	97 SF <	— 224.5 CF
5212.00	352 SF	
TOTAL		274.5 CF
POND NO. 2		
CONTOUR ELEVATION	AREA (SF)	VOLUME (CF)
5212.00	3 SF	— 22.5 CF
5213.00	42 SF <	— 70.0 CF
5213.90	113 SF	
TOTAL		92.5 CF
GRAND TOTAL		367.0 CF

NOTE: THE ABOVE POND VOLUMES SHALL BE VERIFIED PRIOR TO THE ISSUANCE OF A CERTIFICATE OF OCCUPANCY. FINAL POND SURFACE IS TO TOP OF COBBLE.

			Pre-	Develop	ed Dra	inage (Calculat	ions	lacina comanda de la comunidad			decentration (
·	:					——————————————————————————————————————	-					
	This	table is based o	on the COA DP	M Section 2	22.2, Zone:	3						
BASIN	Area	Area	Lan	d Treatment	Percentage	es	Q(100)	Q(100)	WTE	V(100)360	V(100)1440	V(100) _{10da} ,
	(SQ. FT)	(AC.)	Α	В	С	D	(cfs/ac.)	(CFS)	(inches)	(CF)	(CF)	(CF)
Pre-Developed	30191	0.69	0.0%	0.0%	10.0%	90.0%	4.86	3.37	2.25	5668	6574	9291
TOTAL	30191	0.69				·		3.37		5668	6574	9291
				en e casación de destre de cade de la constante de la constant			•					
			Post-Dev	reloped	Draina	ge Cal	culation	15			•	
			Ultimate	Developme	nt Conditio	ns Basin t)ata Table					
	This	table is based o	on the COA DP	M Section 2	22.2, Zone:	3						
BASIN	Area	Area	Land Treatment Percentages			Q(100)	Q(100)	WTE	V(100) ₃₆₀	V(100)1440	V(100) _{10da} ,	
	(SQ. FT)	(AC.)	Α	В	С	D	(cfs/ac.)	(CFS)	(inches)	(CF)	(CF)	(CF)
Post-Developed	30191	0.69	0.0%	0.0%	15.0%	85.0%	4.78	3.32	2.20	5534	6389	8955
TOTAL	30191	0.69						3.32		5534	6389	8955

CAUTION - NOTICE TO CONTRACTOR

THE CONTRACTOR IS SPECIFICALLY CAUTIONED THAT THE LOCATION AND/OR ELEVATION OF EXISTING UTILITIES AS SHOWN ON THESE PLANS IS BASED ON RECORDS OF THE VARIOUS UTILITY COMPANIES AND, WHERE POSSIBLE, MEASUREMENTS TAKEN IN THE FIELD. THE INFORMATION IS NOT TO BE RELIED ON AS BEING EXACT OR COMPLETE. THE CONTRACTOR MUST CALL NEW MEXICO ONE CALL (811) AT LEAST 48 HOURS BEFORE ANY EXCAVATION TO REQUEST EXACT FIELD LOCATION OF UTILITIE'S: IT SHALL BE THE RESPONSIBILITY OF THE CONTRACTOR TO RELOCATE ALL EXISTING UTILITIES WHICH CONFLICT WITH THE PROPOSED IMPROVEMENTS SHOWN ON THE PLANS.

LEGEND

PROPOSED TOP OF GRADE/PVMT ELEVATIONS PROPOSED FLOW LINE/GUTTER ELEVATIONS PROPOSED TOP OF CURB ELEVATIONS EXISTING CONTOUR PROPOSED CONTOUR EXISTING STORM DRAIN FLOW LINE RIDGE LINE

DRAINAGE MANAGEMENT PLAN

INTRODUCTION

The purpose of this submittal is to provide a final drainage management plan for the proposed T-Mobile Store located at 5350 Academy Rd NW in Albuquerque, NM. The site is legally described as North Academy Business Park, Tract A. The project consists of demolition of an existing tobacco shop building and a portion of the existing parking lot. A new T-Mobile retail store will be constructed with new parking and landscape areas as required. The site contains approximately 0.6931 acres.


EXISTING HYDROLOGIC CONDITIONS The site is currently developed as a tobacco store with associated parking and drive—thru lane. Surrounding streets and infrastructure are in place. The site currently sheet flows from northeast to southwest and ultimately drains into a drop inlet located in the parking lot to the southwest of the southwest property corner. The existing property is at least 90% Impervious. Basin Calculations for this site can be found on the Basin Calculations Table this sheet. The 100-Yr discharge from the site is currently 3.37 cfs.

PROPOSED HYDROLOGIC CONDITIONS The site will continue to drain to the existing storm drain inlet located just to the southwest of the southwest property corner; however we are providing water harvesting areas on-site in key locations to help capture flows from the proposed building and as much parking areas as feasible. Per the Basin Calculations Table this sheet, there is a slight decrease in runoff discharging from the site-during the 100—Year Storm, which totals 3.32 cfs, 0.05 cfs less that Pre-Developed Conditions. The reduction is due to the increase of landscaped areas and reduction of impervious area. In addition, the site will provide a partial treatment of runoff by routing all of the building's roof and a portion of the parking lot drainage through a new water harvesting pond located along the west property line and adjacent to the building. we have added several other small water harvesting ponds throughout the site. See below for First Flush Calculations.


FIRST FLUSH CALCULATIONS

The first flush volume impervious area is 12,589 SF (Using the New Impervious Areas only)*0.34"/12 = 357 cubic feet. The pond volume provided per calculations this sheet contains +/-367.0 cubic feet which is 10 cubic feet more than that required. The ponds will slowly discharge onto adjacent pavement at a rate lower than Pre-Developed flows.

This drainage management plan provides for grading and drainage elements which are capable of safely passing the 100 year storm and meets city requirements. With this submittal, we are requesting approval of this plan for Grading Permit and Building Permit.

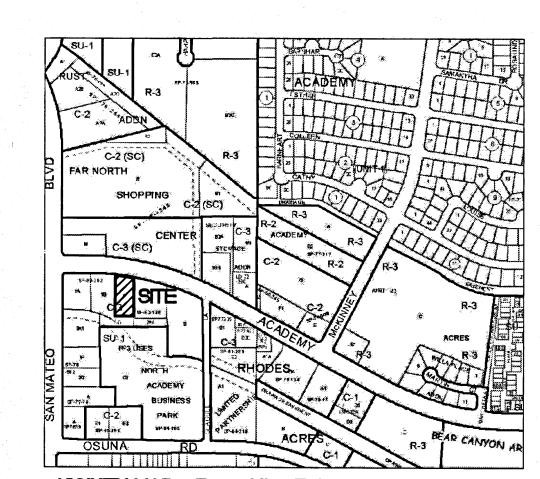

VICINITY MAP - Zone Atlas E-18 Legal Description: Tract A, N Academy Business Park

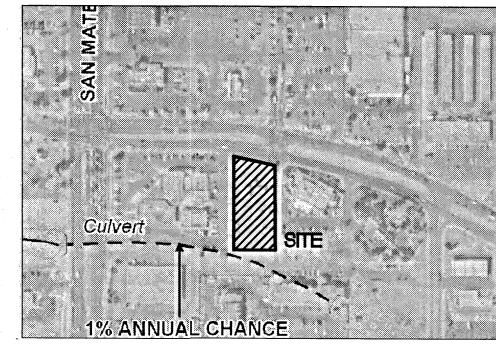

FIRM MAP 35001C0139G

Per FIRM Map 35001C0139G, dated September 26, 2008, the site is not located in the Floodplain and determined to be outside the 0.2% chance

NOTICE TO CONTRACTORS

1. AN EXCAVATION/CONSTRUCTION PERMIT WILL BE REQUIRED BEFORE BEGINNING ANY WORK WITHIN CITY RIGHT-OF-WAY.

2. ALL WORK DETAILED ON THESE PLANS TO BE PERFORMED, EXCEPT AS OTHERWISE STATED OR PROVIDED HEREON, SHALL BE CONSTRUCTED IN ACCORDANCE WITH CITY OF ALBUQUERQUE INTERIM STANDARD SPECIFICATIONS FOR PUBLIC WORKS CONSTRUCTION, 1986 UPDATE NO. 8.

3. TWO WORKING DAYS PRIOR TO ANY EXCAVATION, CONTRACTOR MUST CONTACT NM ONE CALL FOR LOCATION OF EXISTING UTILITIES. (NM ONE CALL = '811')

PRIOR TO CONSTRUCTION, THE CONTRACTOR SHALL EXCAVATE AND VERIFY THE HORIZONTAL AND VERTICAL LOCATIONS OF ALL CONSTRUCTIONS. SHOULD A CONFLICT EXIST, THE CONTRACTOR SHALL NOTIFY THE ENGINEER SO THAT THE

5. BACKFILL COMPACTION SHALL BE ACCORDING TO TRAFFIC/STREET USE. 6. MAINTENANCE OF THESE FACILITIES SHALL BE THE RESPONSIBILITY OF THE OWNER OF THE PROPERTY SERVED.

CONFLICT CAN BE RESOLVED WITH A MINIMUM AMOUNT OF DELAY.

7. WORK ON ARTERIAL STREETS SHALL BE PERFORMED ON A 24-HOUR BASIS.

GRADING NOTES

. EXCEPT AS PROVIDED HEREIN, GRADING SHALL BE PERFORMED AT THE ELEVATIONS AND IN ACCORDANCE WITH THE DETAILS SHOWN ON THIS PLAN. 2. THE COST FOR REQUIRED CONSTRUCTION DUST AND EROSION CONTROL

MEASURES SHALL BE INCIDENTAL TO THE PROJECT COST. . ALL WORK RELATIVE TO FOUNDATION CONSTRUCTION, SITE PREPARATION, AND PAVEMENT INSTALLATION, AS SHOWN ON THIS PLAN, SHALL BE CONSTRUCTED IN ACCORDANCE WITH THE "GEOTECHNICAL INVESTIGATION," AS PROVIDED BY THE ARCHITECT OR OWNER. ALL OTHER WORK SHALL, UNLESS OTHERWISE STATED OR PROVIDED FOR HEREON, BE CONSTRUCTED IN ACCORDANCE WITH THE PROJECT. (FIRST PRIORITY) SPECIFICATIONS, AND/OR THE CITY OF ALBUQUERQUE (COA)

4. EARTH SLOPES SHALL NOT EXCEED 3 HORIZONTAL TO 1 VERTICAL UNLESS SHOWN OTHERWISE.

STANDARD SPECIFICATIONS FOR PUBLIC WORKS (SECOND PRIORITY).

5. IT IS THE INTENT OF THESE PLANS THAT THIS CONTRACTOR SHALL NOT PERFORM ANY WORK OUTSIDE OF THE PROPERTY BOUNDARIES EXCEPT AS REQUIRED

6. THE CONTRACTOR IS TO ENSURE THAT NO SOIL ERODES FROM THE SITE ONTO ADJACENT PROPERTY OR PUBLIC RIGHT-OF-WAY. THIS SHOULD BE ACHIEVED BY CONSTRUCTING TEMPORARY BERMS OR SILT FENCE AT THE PROPERTY LINES AND WETTING THE SOIL TO PROTECT IT FROM WIND EROSION.

7. A DISPOSAL SITE FOR ANY & ALL EXCESS EXCAVATION MATERIAL, AND UNSUITABLE MATERIAL AND/OR A BORROW SITE CONTAINING ACCEPTABLE FILL MATERIAL SHALL BE OBTAINED BY THE CONTRACTOR IN COMPLIANCE WITH APPLICABLE ENVIRONMENTAL REGULATIONS AND APPROVED BY THE OBSERVER. ALL COSTS INCURRED IN OBTAINING A DISPOSAL OR BORROW SITE AND HAUL TO OR FROM SHALL BE CONSIDERED INCIDENTAL TO THE PROJECT AND NO SEPARATE MEASUREMENT OR PAYMENT SHALL BE MADE.

8. PAVING AND ROADWAY GRADES SHALL BE +/- 0.05' FROM PLAN ELEVATIONS. PAD ELEVATION SHALL BE +/- 0.05' FROM BUILDING PLAN ELEVATION. 9. ALL PROPOSED CONTOURS AND SPOT ELEVATIONS REFLECT TOP OF PAVEMENT

MEDIANS, AND ISLANDS. 10. VERIFY ALL ELEVATIONS SHOWN ON PLAN FROM BASIS OF ELEVATION CONTROL STATION (IF APPLICABLE) PRIOR TO BEGINNING CONSTRUCTION.

ELEVATIONS IN THE PARKING AREA AND MUST BE ADJUSTED FOR PAVEMENT,


11. THE CONTRACTOR SHALL PROVIDE THE SWPPP DOCUMENT (IF NECESSARY) AND SHALL ABIDE BY ALL LOCAL, STATE, AND FEDERAL LAWS, RULES AND REGULÁTIONS WHICH APPLY TO THE CONSTRUCTION OF THESE IMPROVEMENTS, INCLUDING EPA REQUIREMENTS WITH RESPECT TO STORM WATER DISCHARGE.

> 1368 Reynosa Loop SE Rio Rancho, NM 87124

> > Ph: 505.980.3560

Darren Sowell ARCHITECTS

4700 Lincoln N.E., Suite 111 Albuquerque, N.M. 87109 Phone: (505) 342-6200 Fax: (505) 342-6201

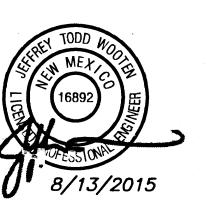

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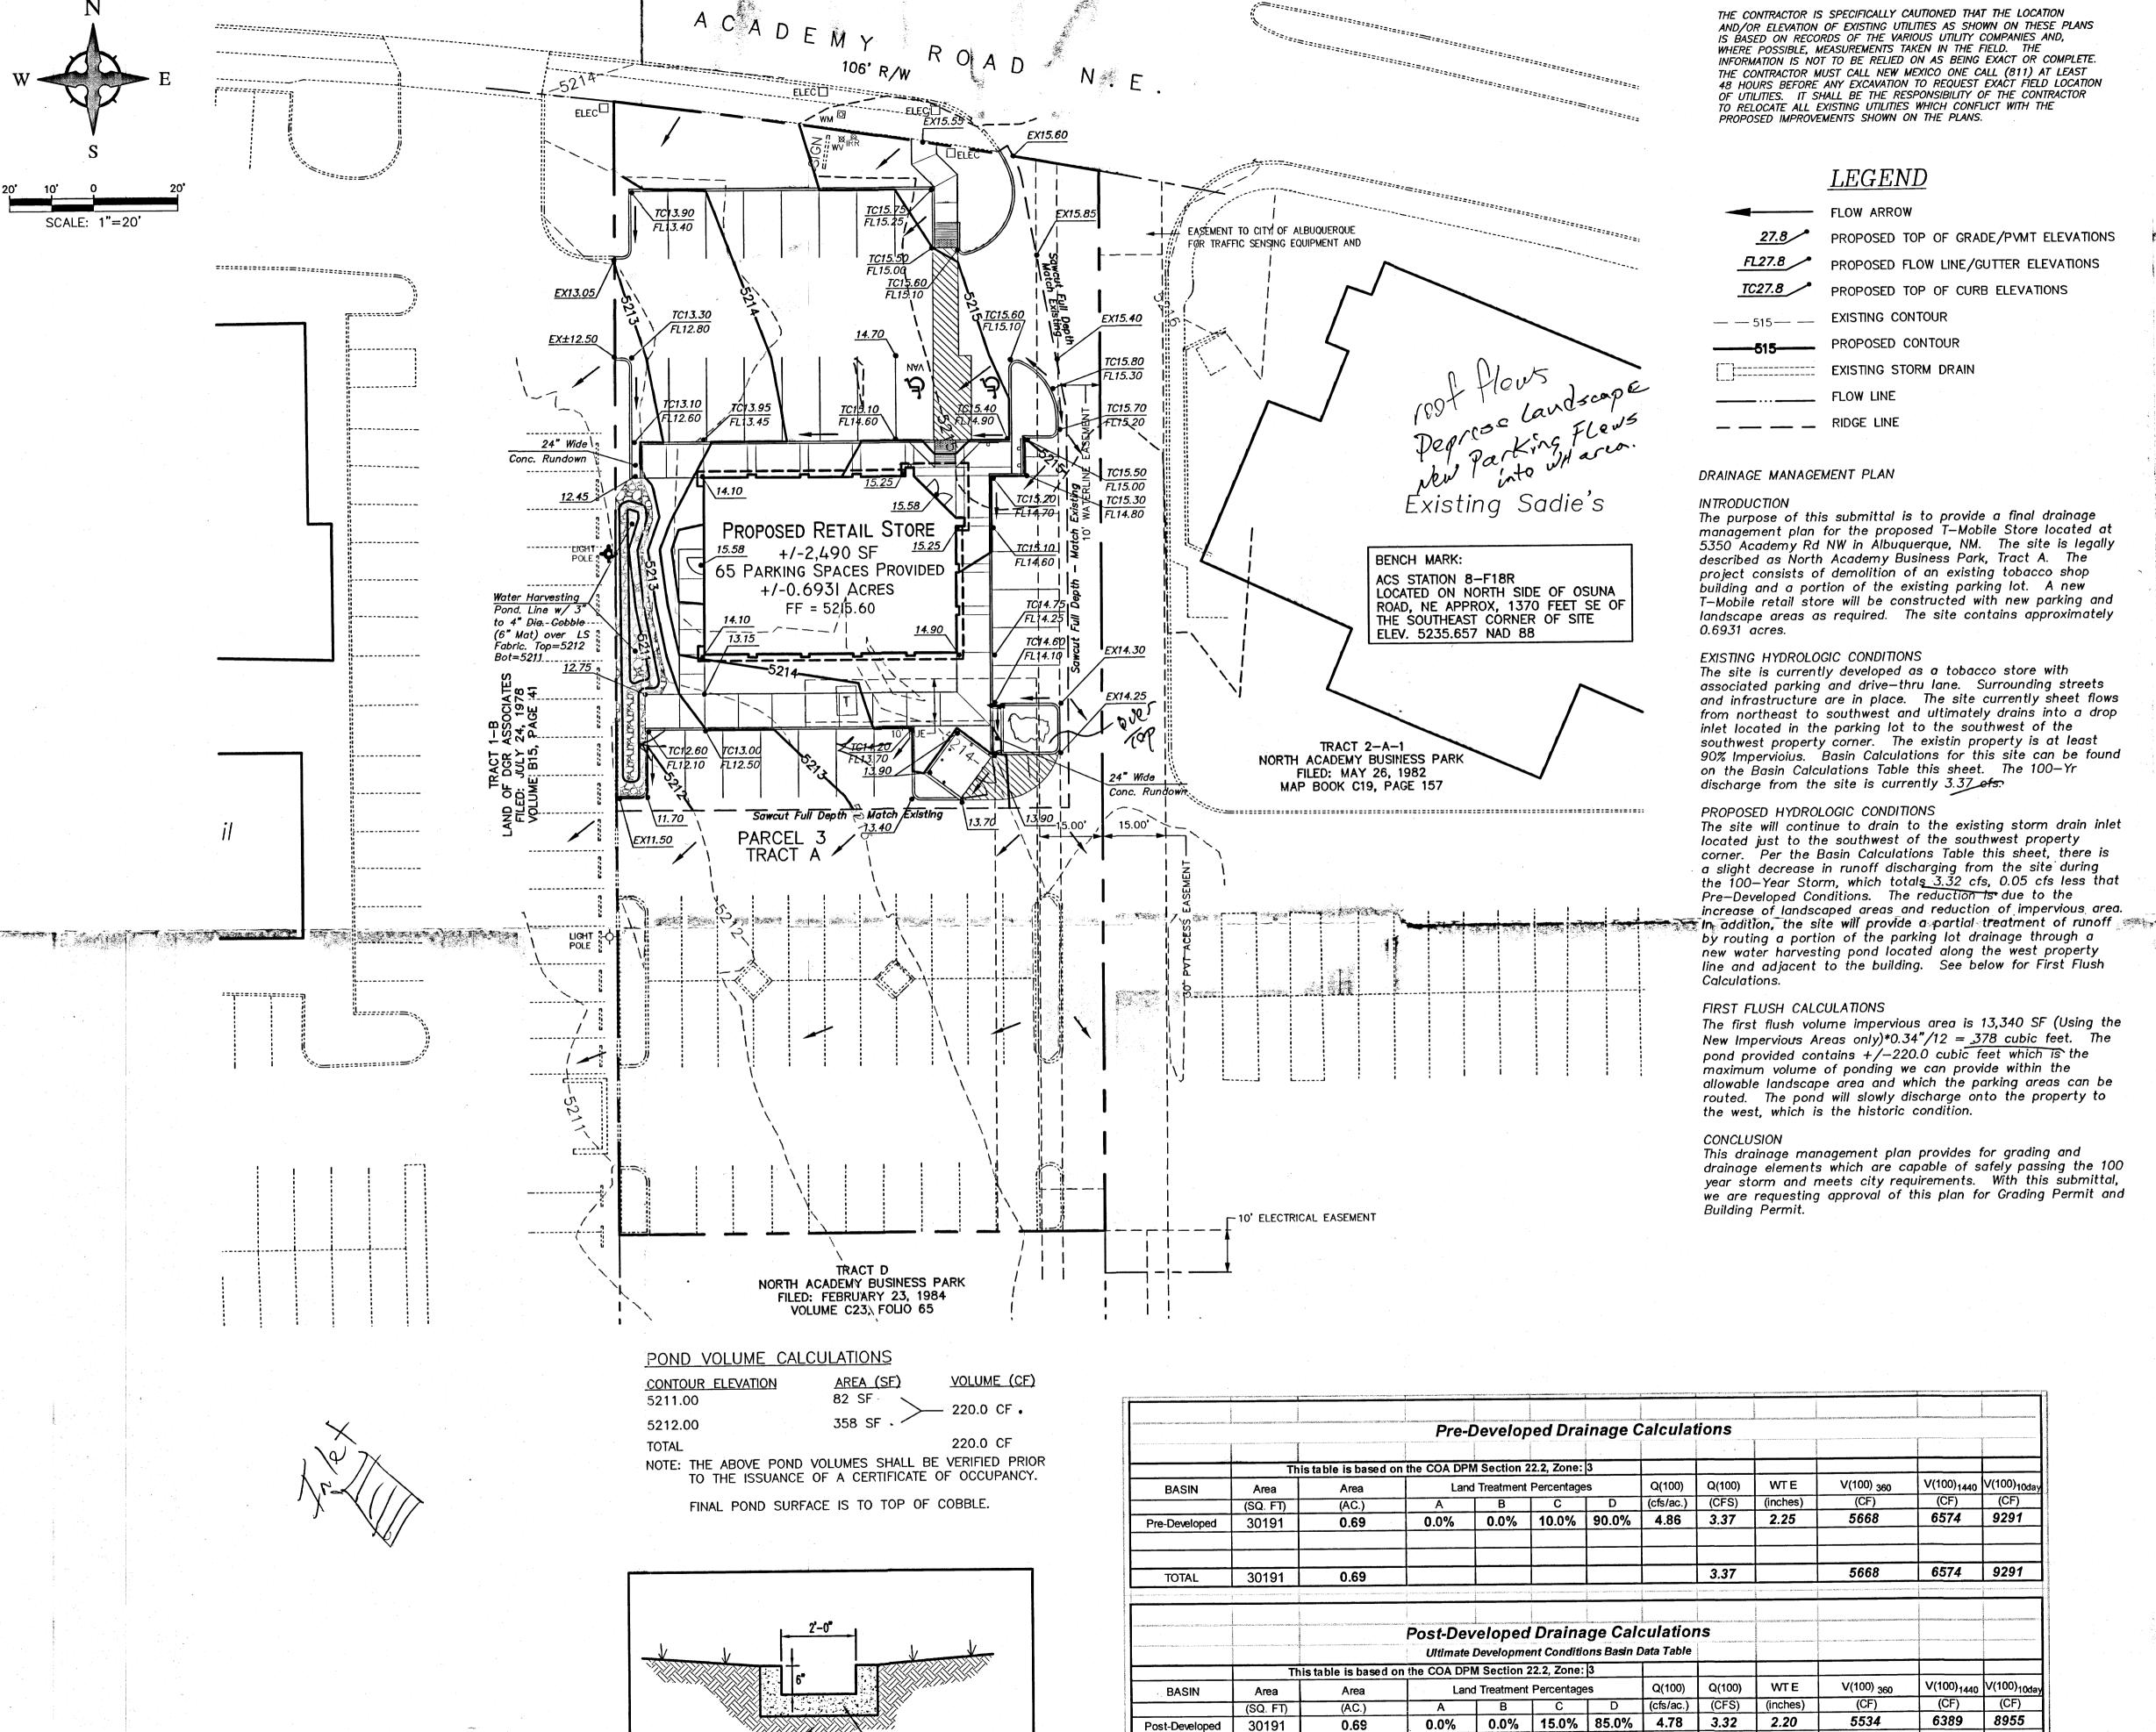
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LAND DEVELOPMENT SECTION

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Issue Date August 13, 2015


Grading Plan



Backfill Compacted to 95% -Modified Proctor Density

per ASTM D-1557

Concrete Rundown Detail

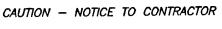


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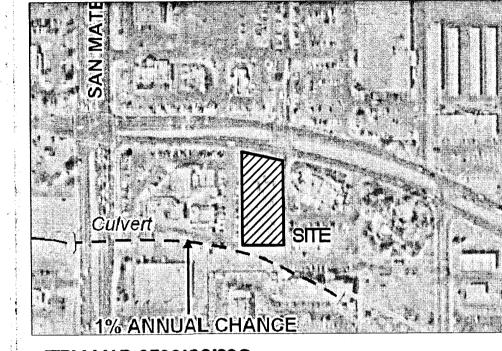
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30191

6389 8955



VICINITY MAP - Zone Atlas E-18 Legal Description: Tract A, N Academy Business Park

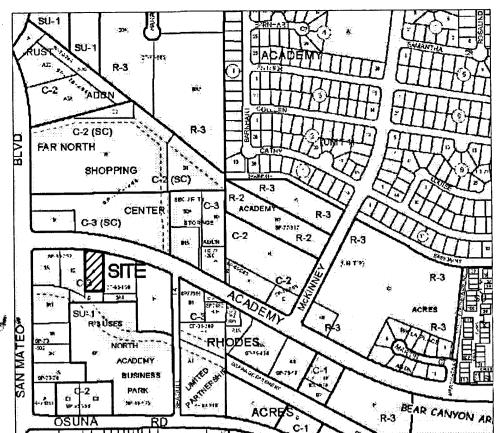

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Coten
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Ph: 505.980.3560

Darren Sowell

ARCHITECTS

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Albuquerque, N.M. 87109

Phone: (505) 342-6200

Fax: (505) 342-6201



JUN 3 0 2015

LAND DEVELOPMENT SECTION

I-Mobile Store #288

5([e]

Project Number 20140

Drawn By

Issue Date May 20, 2015

Grading Plan

C1

DEC 2 1 2015


and

Darren Sowell ARCHITECTS

4700 Lincoln N.E., Suite 111 Albuquerque, N.M. 87109 Phone: (505) 342-6200

Fax: (505) 342-6201

UGARTE-SHELTON

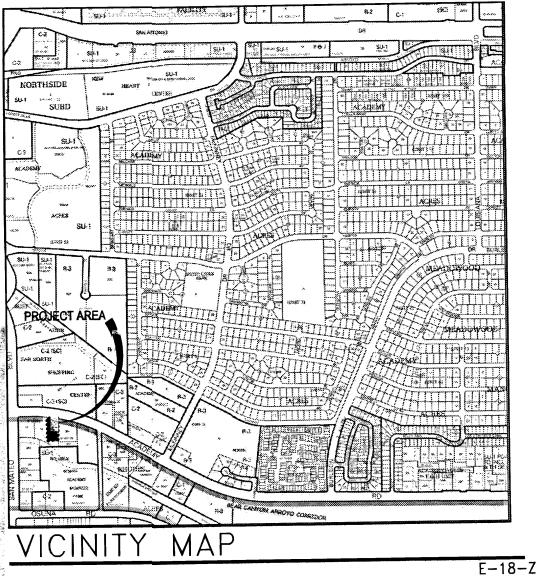

PROPERTY AREA: 0.6931 ACRES

CURRENT ZONING: C-3

BUILDING AREA: T-MOBILE RETAIL BUILDING = 2,490 SF

2. LANDSCAPE AREA, SEE LANDSCAPE PLAN LS-101.

3. 6" HIGH CONCRETE CURB.

4. ACCESSIBLE CURB RAM.

ACCESSIBLE PARKING SYMBOL PAVEMENT MARKING.

8. CONCRETE SIDEWALK.

9. 4" WIDE PAVEMENT STRIPING.

11. MOTORCYCLE PARKING SIGN.

WHICH SHALL BE 12" HIGH AND 2" WIDE MINIMUM.

14. 6' WIDE INCREASING TO 9' WIDE ADA ACCESSIBLE PEDESTRIAN PATHWAY FROM PUBLIC SIDEWALK.

16. EXISTING TRAFFIC SIGNAL ARM & ASSOCIATED EQUIPMENT TO REMAIN.

17. EXISTING WATER & IRRIGATION METERS TO REMAIN.

18. EXISTING SIDEWALK TO REMAIN.

20. EXISTING FULL ACCESS INTERSECTION TO REMAIN.

21. EXISTING ACCESSIBLE CURB RAMP TO REMAIN.

22. NOT USED.

24. EXISTING 30' PRIVATE COMMON ACCESS EASEMENT; BOOK C19, FOLIO 42, BOOK C19, FOLIO 157, BOOK C20, FOLIO 168 & BOOK C23,


C20, FOLIO 168 & BOOK C23, FOLIO 65.

26. EXISTING 10' PUBLIC UTILITY EASEMENT; BOOK MISC. 255A, PAGE

27. EXISTING FRONT YARD BUILDING SETBACK LINE; BOOK C19, FOLIO

32. EXISTING CURB AND LANDSCAPING TO REMAIN.

33. 6" DIA x 36" AFF BOLLARD AT 5'-0" ± OC, BURY 18" IN 12" DIA

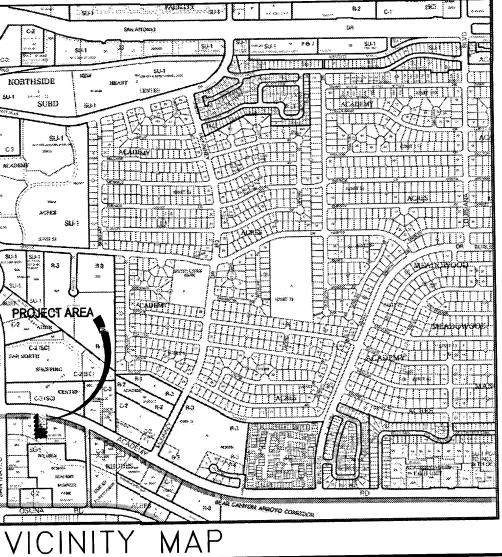

SITE DATA:

LEGAL DESCRIPTION: TRACT "A", NORTH ACADEMY BUSINESS PARK

UPC: 101806204807730121

ADDRESS: 5350 ACADEMY RD NE

KEYED NOTES:

1. REFUSE ENCLOSURE.

10. ASPHALT PAVEMENT.

12. "NO PARKING" PAVEMENT MARKING IN CAPITAL LETTERS, EACH OF

13. 6' WIDE CONCRETE PEDESTRIAN CONNECTION.

15. 2-BIKE CAPACITY HOOP RACK.

19. EXISTING PATIO WALL ON ADJACENT PROPERTY.

23. EXISTING FREE-STANDING SIGN TO RECEIVE NEW SIGN FACE UNDER A SEPARATE BUILDING PERMIT.

25. EXISTING 10' WATERLINE EASEMENT; BOOK C19, FOLIO 157, BOOK

28. BUILDING ENTRANCE/EXIT DOOR.

30. EXTERIOR LOT LIGHTING ON BUILDING.

31. EXISTING LIGHT POLE TO REMAIN.

PARCEL 3

.....

 $\sqrt{32}$ 0.6931 Existing parking to remain

EXISTING PARKING TO REMAIN

EXISTING PARKING TO REMAIN

IN LIEU OF 6' LANDSCAPE BUFFER

N 89°56'00" W

TRACT D NORTH ACADEMY BUSINESS PARK

FILED: FEBRUARY 23, 1984 VOLUME C23, FOLIO 65

CURVE DATA

03°48'43" N 81°29'33" W 1757.05 116.90

NUMBER DELTA ANGLE CHORD DIRECTION RADIUS ARC LENGTH CHORD LENGTH

26

AQD

A C A D E M Y

106' R/W

A C A D

ARCHITECTURAL SITE PLAN

EXISTING SADIE'S

NORTH ACADEMY BO

FILED: MAY 26, 198 MAP BOOK C19, PAGE

ADDITIONAL PARKING REQUIREMENTS:

1 MOTORCYCLE SPACE REQUIRED AND 2 PROVIDED

2 BICYCLE SPACES REQUIRED AND 2 PROVIDED

N/A T-MOBILE RETAIL STORE 2,495 SF N/A TOTAL AREA PROVIDED PARKING REQUIREMENTS: REQUIRED *53 SPACES 13 SPACES T-MOBILE RETAIL STORE 1/200 SF 1 SPACE STD ACCESSIBLE PARKING REQUIRED FOR 13 SPACES 1 SPACE 1 SPACE 1 SPACE VAN ACCESSIBLE PARKING REQUIRED FOR 13 SPACE COMPACT PARKING ALLOWED FOR 61 SPACES = 15 6 SPACES

SEATS

AREA (SQUARE FEET)

2,490 SF

13 SPACES *61 SPACES

 33 EXISTING STANDARD SPACES TO REMAIN + 26 NEW STANDARD AND COMPACT SPACES PROVIDED + 2 NEW ACCESSIBLE SPACES PROVIDED = 61 PARKING SPACES PROVIDED

LEGEND:

BUILDING AREA:

SIDEWALK JOINTS

AREA, SEE LS-101

CURB RAMP

EXISTING CONCRETE CURB/PAVING

---- EXISTING EASEMENT LINE

PROPERTY LINE

EXISTING PROPERTY LINE


ON-SITE LANDSCAPE

CONCRETE CURB/PAVING


EXISTING FRONT YARD SETBACK LINE

BUILDING & PARKING DATA


Project Number Drawn By Checked Dec 21, 2015 Issue Date ARCHITECTURAL SITE PLAN

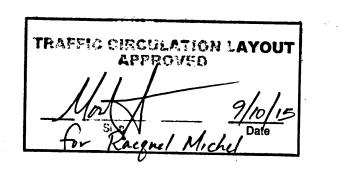

ALL WHEELCHAIR RAMPS LOCATED WITHIN THE PUBLIC RIGHT OF WAY MUST HAVE TRUNCATED DOMES.

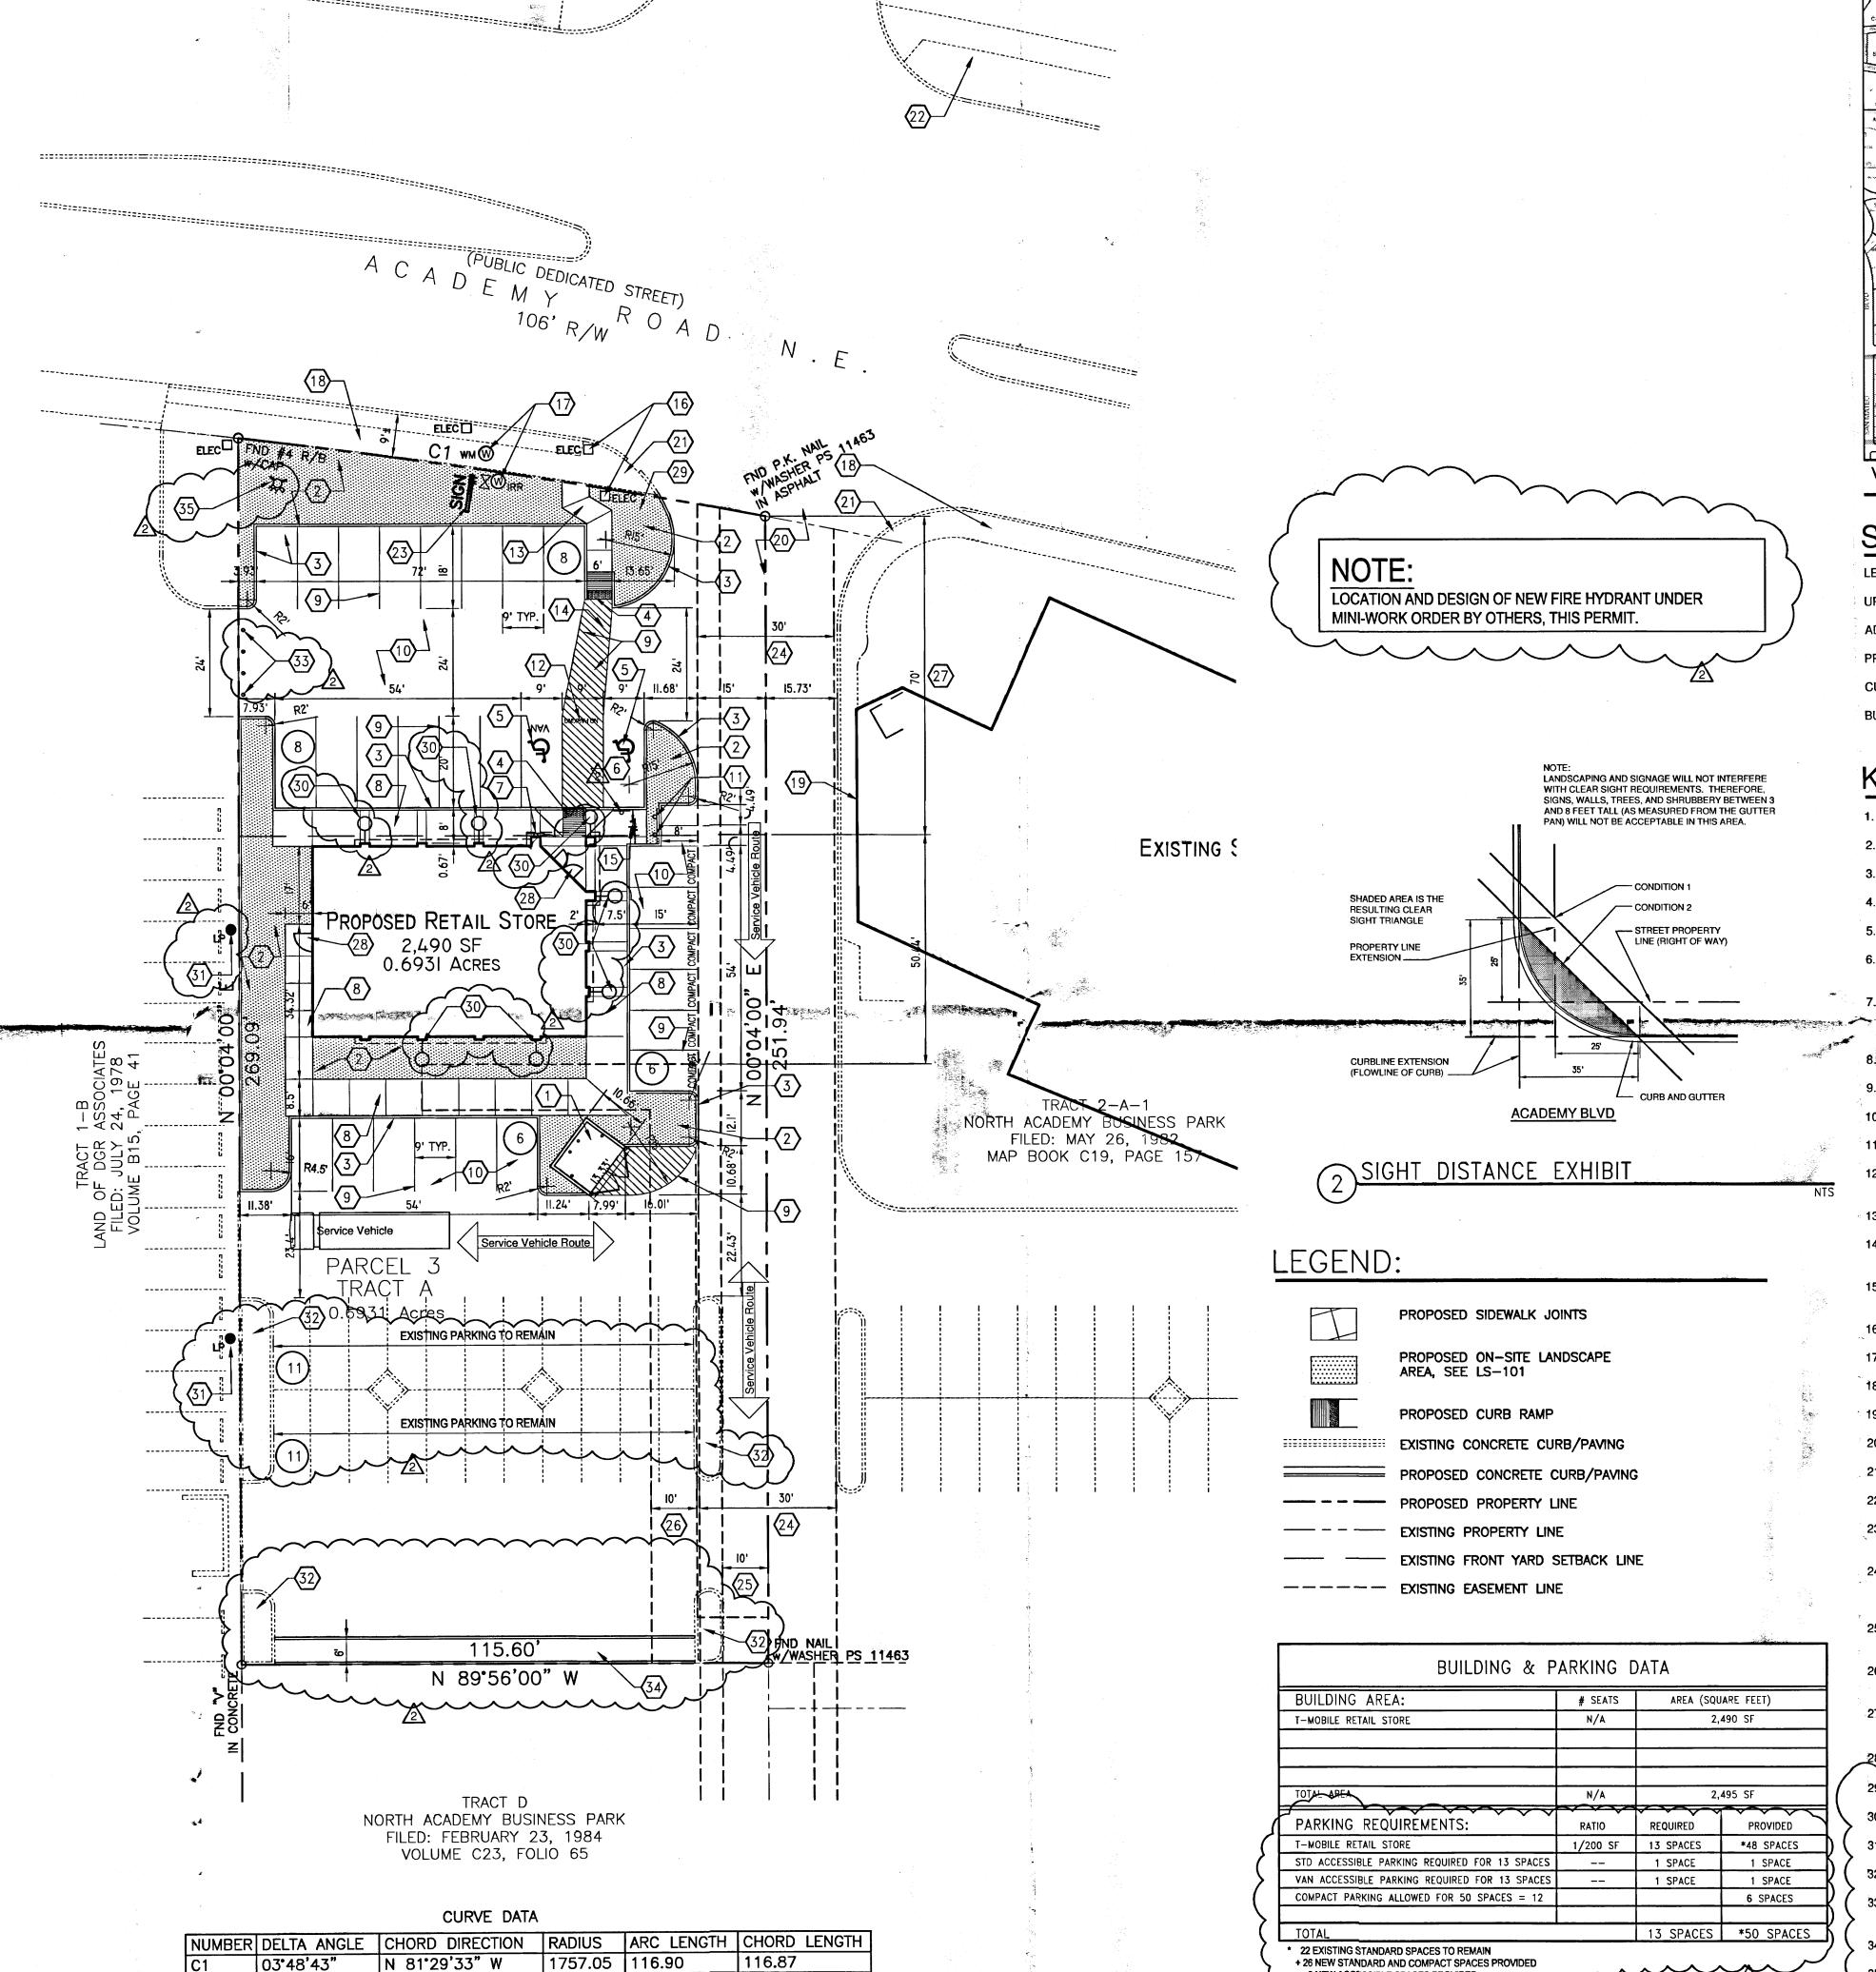

ARCHITECTURAL SITE PLAN / TCL

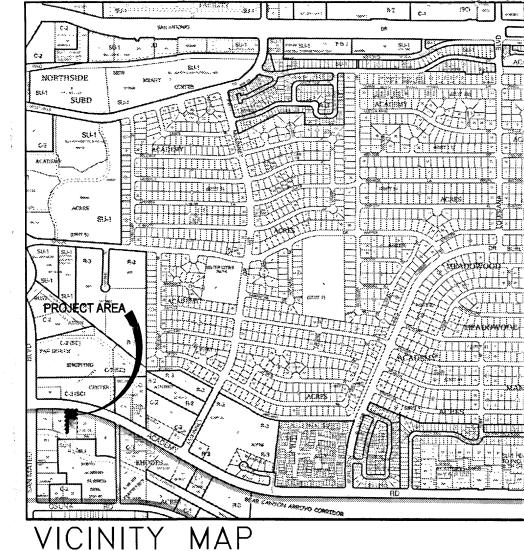

SITE DATA:

LEGAL DESCRIPTION: TRACT "A", NORTH ACADEMY BUSINESS PARK

UPC: 101806204807730121

ADDRESS: 5350 ACADEMY RD NE

PROPERTY AREA: 0.6931 ACRES

CURRENT ZONING: C-3

BUILDING AREA: PROPOSED T-MOBILE RETAIL BUILDING = 2,490 SF

KEYED NOTES:

- 1. PROPOSED REFUSE ENCLOSURE, SEE 1/AS-102.
- 2. PROPOSED LANDSCAPE AREA, SEE LANDSCAPE PLAN LS-101.
- 3. PROPOSED 6" HIGH CONCRETE CURB.
- 4. PROPOSED ACCESSIBLE CURB RAMP, SEE AS-102.
- 6. PROPOSED ACCESSIBLE PARKING SIGN POST MOUNTED, SEE
- PROPOSED VAN ACCESSIBLE PARKING SIGN TO INCLUDE "VIOLATORS"
- *ARE SUBJECT TO A FINE AND/OR TOWING" WALL MOUNTED SEE
- 8. PROPOSED CONCRETE SIDEWALK.
- 9. PROPOSED 4" WIDE PAVEMENT STRIPING.
- 10. PROPOSED ASPHALT PAVEMENT.
- 11. PROPOSED MOTORCYCLE PARKING SIGN.
- 12. PROPOSED "NO PARKING" PAVEMENT MARKING IN CAPITAL LETTERS, EACH OF WHICH SHALL BE 12" HIGH AND 2" WIDE MINIMUM.
- 13. PROPOSED 6' WIDE CONCRETE PEDESTRIAN CONNECTION.
- 14. 6' WIDE INCREASING TO 9' WIDE ADA ACCESSIBLE PEDESTRIAN PATHWAY FROM PUBLIC SIDEWALK.
- 15. PROPOSED 2-BIKE CAPACITY HOOP RACK BY DERCO OR APPROVED
- 16. EXISTING TRAFFIC SIGNAL ARM & ASSOCIATED EQUIPMENT TO REMAIN.
- 17. EXISTING WATER & IRRIGATION METERS TO REMAIN.
- 18. EXISTING SIDEWALK TO REMAIN.
- 19. EXISTING PATIO WALL ON ADJACENT PROPERTY.
- 20. EXISTING FULL ACCESS INTERSECTION TO REMAIN.
- 21. EXISTING ACCESSIBLE CURB RAMP TO REMAIN.
- 22. EXISTING FIRE HYDRANT TO REMAIN.
- 23. EXISTING FREE-STANDING SIGN TO RECEIVE NEW SIGN FACE UNDER A SEPARATE BUILDING PERMIT.
- 24. EXISTING 30' PRIVATE COMMON ACCESS EASEMENT; BOOK C19, FOLIO 42, BOOK C19, FOLIO 157, BOOK C20, FOLIO 168 & BOOK C23, FOLIO 65.
- 25. EXISTING 10' WATERLINE EASEMENT; BOOK C19, FOLIO 157, BOOK C20, FOLIO 168 & BOOK C23, FOLIO 65.
- 26. EXISTING 10' PUBLIC UTILITY EASEMENT; BOOK MISC. 255A, PAGE
- 27. EXISTING FRONT YARD BUILDING SETBACK LINE; BOOK C19, FOLIO

28. BUILDING ENTRANCE/EXIT DOOR.
29. PROVIDE LINE SIGHT DISTANCE, SEE DETAIL 2/AS-101.

30. EXTERIOR LOT LIGHTING ON BUILDING, SEE E-1.1.

31. EXISTING LIGHT POLE TO REMAIN.

32. EXISTING CURB AND LANDSCAPING TO REMAIN.

33. 6" DIA x 36" AFF BOLLARD AT 5'-0" ± OC, BURY 18" IN 12" DIA

34. 6' LANDSCAPE BUFFER, SEE LS101.

ADDITIONAL PARKING REQUIREMENTS:

1 MOTORCYCLE SPACE REQUIRED AND 2 PROVIDED 2 BICYCLE SPACES REQUIRED AND 2 PROVIDED

35. NEW FIRE HYDRANT UNDER SEPARATE MINI-WORK ORDER, THIS

Ibuq

Darren Sowell ARCHITECTS

4700 Lincoln N.E., Suite 111

Albuquerque, N.M. 87109 Phone: (505) 342-6200 Fax: (505) 342-6201

UGARTE-SHELTOI

E-18-Z

MOVED BUILDING WEST 5' FOR ACCESS EASEMENT 2 CABQ COMMENT REVISIONS Sept 9, 2015 Issue Date ARCHITECTURAL

SITE PLAN / TCL

TRAFFIC CIRCULATION LAYOUT APPROVED

Sign d

Sign d

Date

CURVE DATA

03'48'43"

ARCHITECTURAL SITE PLAN / TCL


NUMBER DELTA ANGLE CHORD DIRECTION RADIUS ARC LENGTH CHORD LENGTH


N 81°29'33" W 1757.05 116.90

Public Infrastructure shown on these plans for information only and not part of approval. Separate DRC/Permit approval and Work Order required.

ALL WHEELCHAIR RAMPS LOCATED WITHIN THE PUBLIC RIGHT OF WAY MUST HAVE TRUNCATED DOMES.

The state of the s

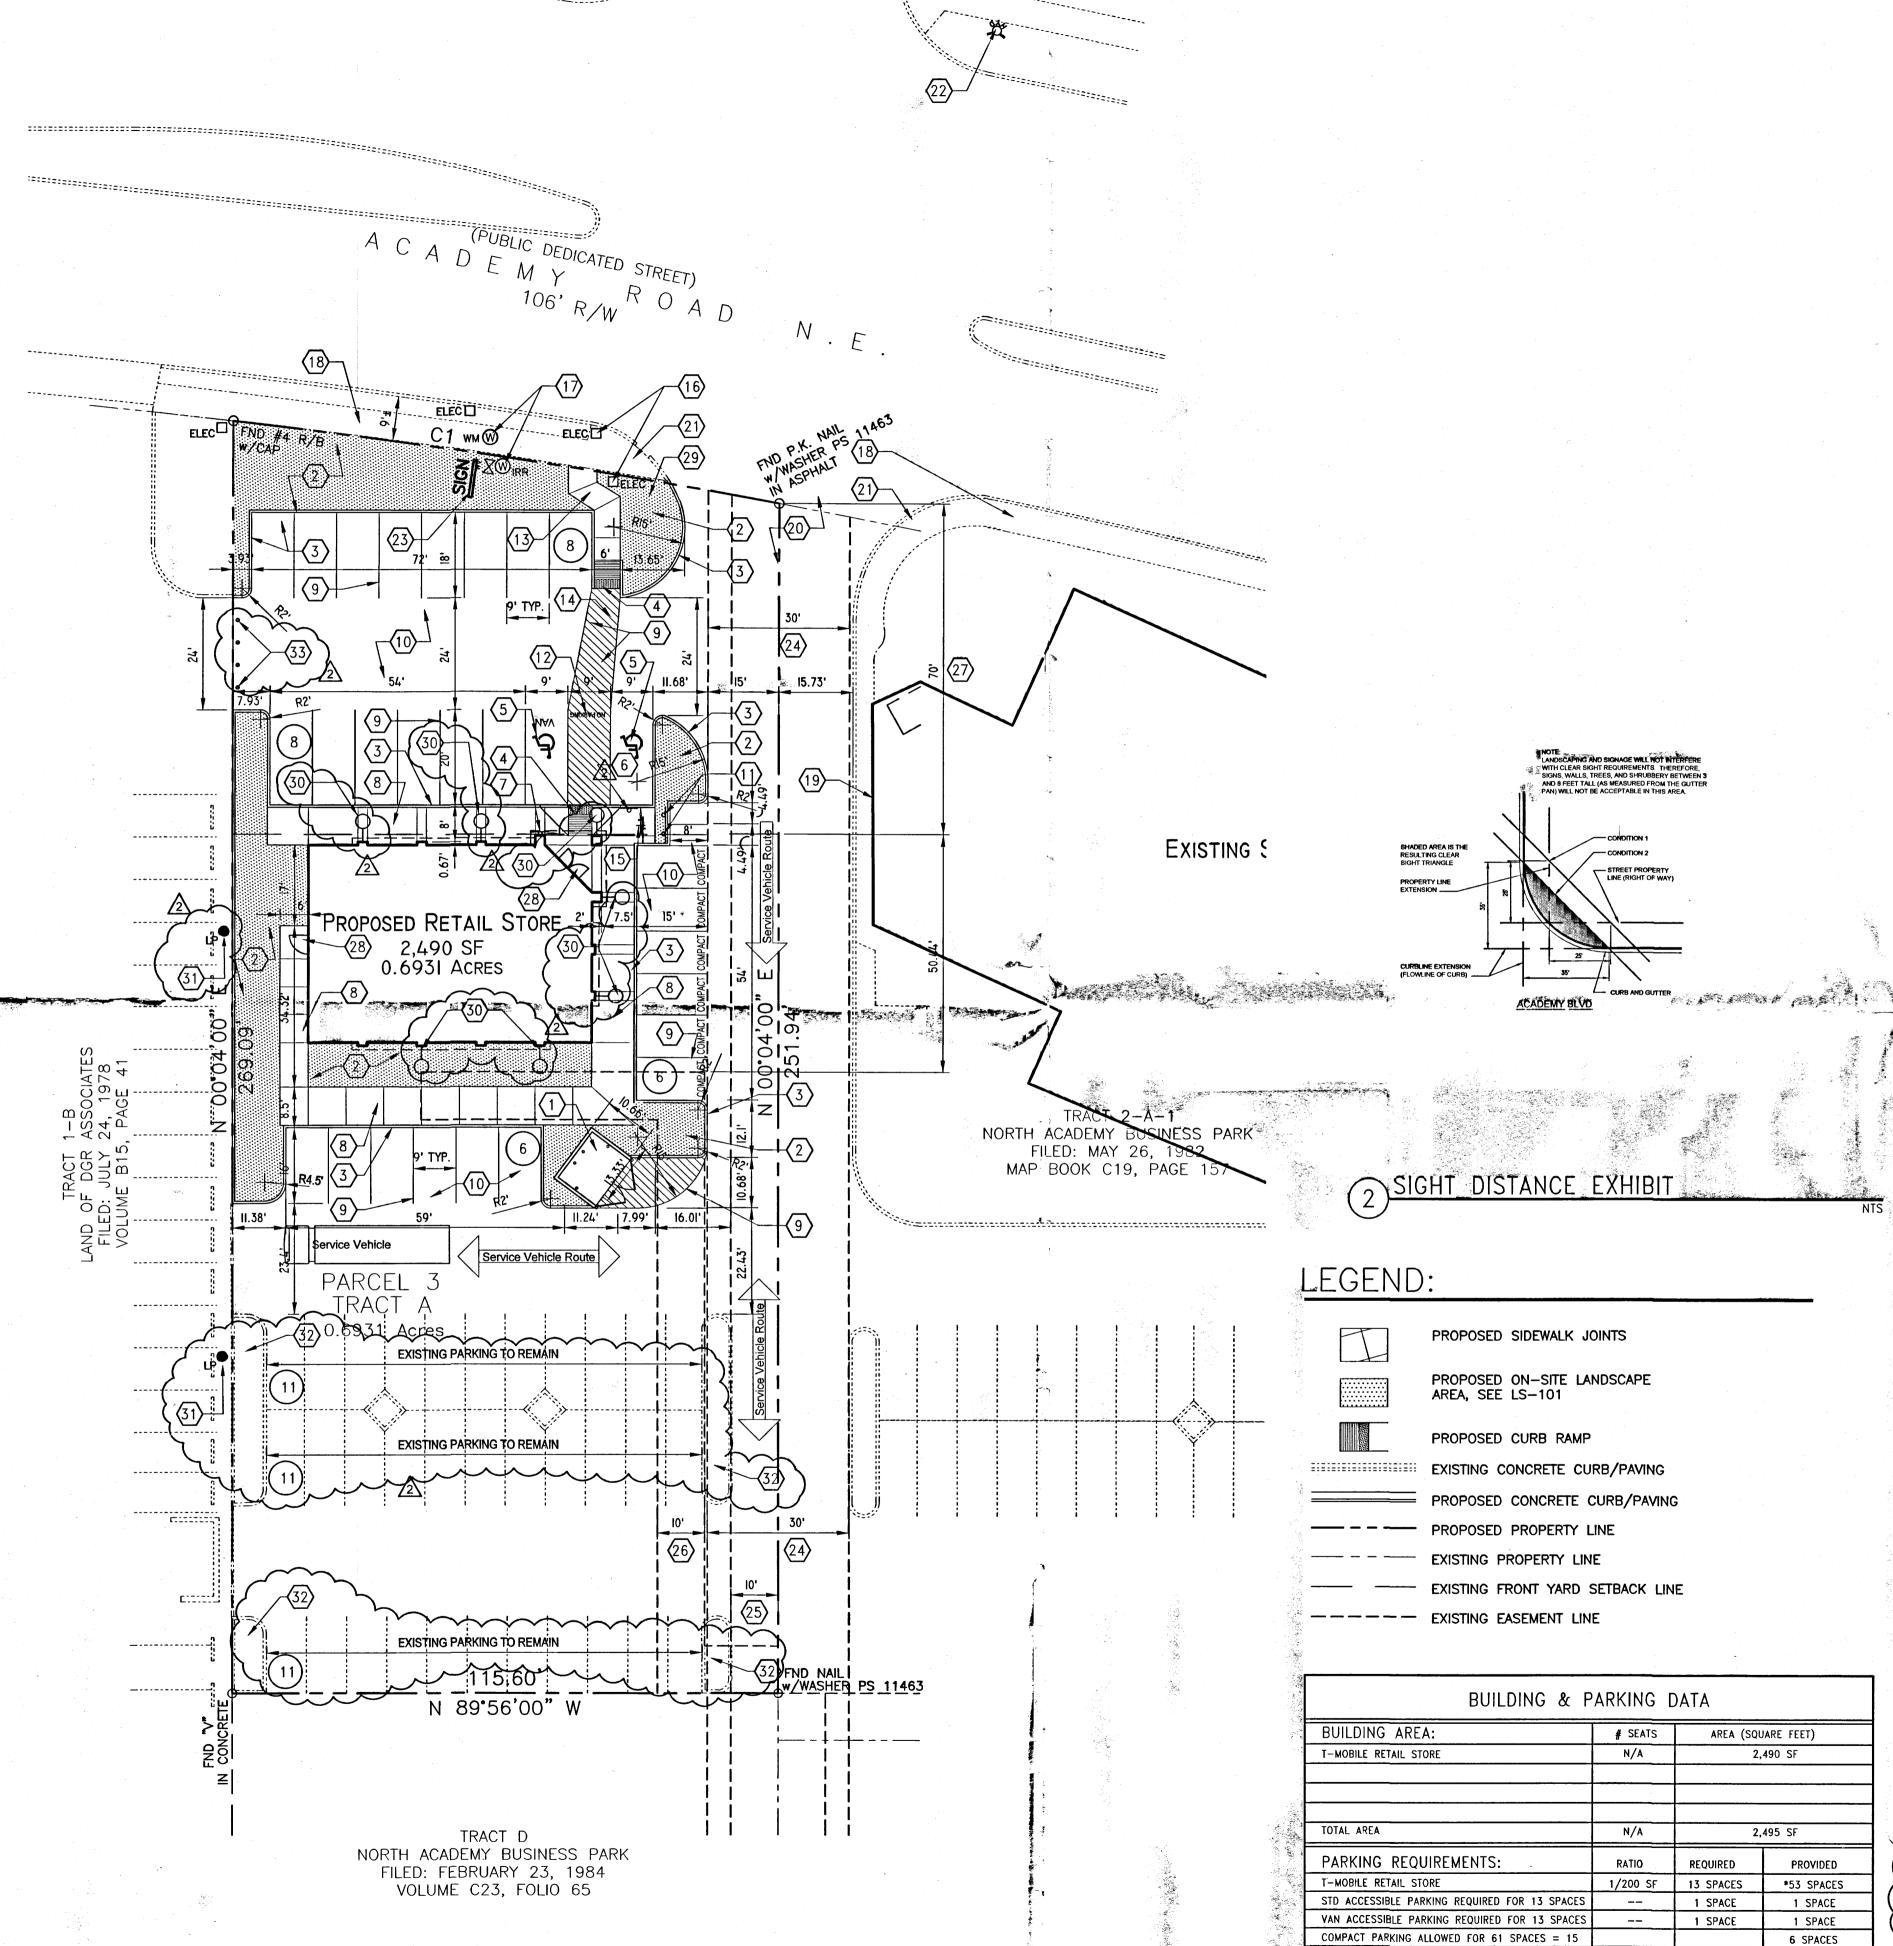

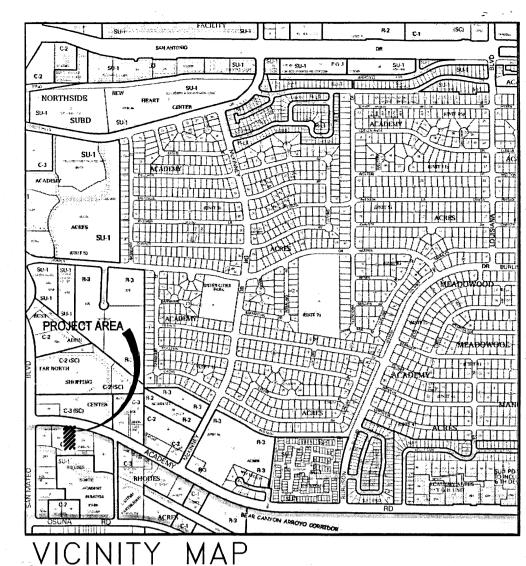

SITE DATA:

LEGAL DESCRIPTION: TRACT "A", NORTH ACADEMY BUSINESS PARK

UPC: 101806204807730121

ADDRESS: 5350 ACADEMY RD NE

PROPERTY AREA: 0.6931 ACRES

CURRENT ZONING: C-3

BUILDING AREA:
PROPOSED T-MOBILE RETAIL BUILDING = 2,490 SF

KEYED NOTES:

- 1. PROPOSED REFUSE ENCLOSURE, SEE 1/AS-102.
- 2. PROPOSED LANDSCAPE AREA, SEE LANDSCAPE PLAN LS-101.
- 3. PROPOSED 6" HIGH CONCRETE CURB.
- 4. PROPOSED ACCESSIBLE CURB RAMP, SEE AS-102.
- PROPOSED ACCESSIBLE PARKING SYMBOL PAVEMENT MARKING.
- 6. PROPOSED ACCESSIBLE PARKING SIGN POST MOUNTED, SEE
- PROPOSED VAN ACCESSIBLE PARKING SIGN TO INCLUDE "VIOLATORS ARE SUBJECT TO A FINE AND/OR TOWING" WALL MOUNTED SEE
- 8. PROPOSED CONCRETE SIDEWALK.
- 9. PROPOSED 4" WIDE PAVEMENT STRIPING.
- 10. PROPOSED ASPHALT PAVEMENT.
- 11. PROPOSED MOTORCYCLE PARKING SIGN.
- ▶12. PROPOSED "NO PARKING" PAVEMENT MARKING IN CAPITAL LETTERS, EACH OF WHICH SHALL BE 12" HIGH AND 2" WIDE MINIMUM.
- 13. PROPOSED 6' WIDE CONCRETE PEDESTRIAN CONNECTION.
- 14. 6' WIDE INCREASING TO 9' WIDE ADA ACCESSIBLE PEDESTRIAN
- PATHWAY FROM PUBLIC SIDEWALK.

 15. PROPOSED 2-BIKE CAPACITY HOOP RACK BY DERCO OR APPROVED
- EQUAL.
- 16. EXISTING TRAFFIC SIGNAL ARM & ASSOCIATED EQUIPMENT TO REMAIN.
- 17. EXISTING WATER & IRRIGATION METERS TO REMAIN.
- 18. EXISTING SIDEWALK TO REMAIN.
- 19. EXISTING PATIO WALL ON ADJACENT PROPERTY
- 20. EXISTING FULL ACCESS INTERSECTION TO REMAIN.
- 21 EXISTING ACCESSIBLE CURB RAMP TO REMAIN
- 22. EXISTING FIRE HYDRANT TO REMAIN.
- 23. EXISTING FREE-STANDING SIGN TO RECEIVE NEW SIGN FACE UNDER A SEPARATE BUILDING PERMIT.
- 24. EXISTING 30' PRIVATE COMMON ACCESS EASEMENT; BOOK C19, FOLIO 42, BOOK C19, FOLIO 157, BOOK C20, FOLIO 168 & BOOK C23, FOLIO 65
- 25. EXISTING 10' WATERLINE EASEMENT; BOOK C19, FOLIO 157, BOOK C20, FOLIO 168 & BOOK C23, FOLIO 65.
- 26. EXISTING 10' PUBLIC UTILITY EASEMENT; BOOK MISC. 255A, PAGE
- 27. EXISTING FRONT YARD BUILDING SETBACK LINE; BOOK C19, FOLIO
- **157.**
- 29. PROVIDE LINE SIGHT DISTANCE, SEE DETAIL 2/AS-101.
- 30. EXTERIOR LOT LIGHTING ON BUILDING, SEE E-1.1.

13 SPACES *61 SPACES

* 33 EXISTING STANDARD SPACES TO REMAIN + 26 NEW STANDARD AND COMPACT SPACES PROVIDED

ADDITIONAL PARKING REQUIREMENTS:

1 MOTORCYCLE SPACE REQUIRED AND 2 PROVIDED

2 BICYCLE SPACES REQUIRED AND 2 PROVIDED

+ 2 NEW ACCESSIBLE SPACES PROVIDED = 61 PARKING SPACES PROVIDED 28. BUILDING ENTRANCE/EXIT DOOR.

- 31. EXISTING LIGHT POLE TO REMAIN.
- 32. EXISTING CURB AND LANDSCAPING TO REMAIN.33. 6" DIA x 36" AFF BOLLARD AT 5'-0" ± OC. BURY 18" IN 12" I

33. 6" DIA x 36" AFF BOLLARD AT 5'-0" ± OC, BURY 18" IN 12" DIA CONC.

T-Mobile Store #2

Darren Sowell

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Fax: (505) 342-6201

UGARTE-SHELTO

AUG 2 1 2015

LAND DEVELOPMENT SECTION

7				
S F				
	MOVED BUIL	DING W	EST 5	 5' F
t F	ACCESS EAS	SEMENT		
t. 4	2 CABQ COMM	ENT RE	VISIO	ONS
i.	Project Number			1
	Drawn By			
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	Issue Date	Aug	17,	20
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ARCHITECTURAL
SITE PLAN / TCL


Scale: AS SHOWN

AS-101

Public Infrastructure shown on these plans for information only and not part of approval. Separate DRC/Permit approva and Work Order required.


ALL WHEELCHAIR RAMPS LOCATED WITHIN THE PUBLIC RIGHT OF WAY MUST HAVE TRUNCATED DOMES.

CONTRACTOR OF THE PARTY OF THE

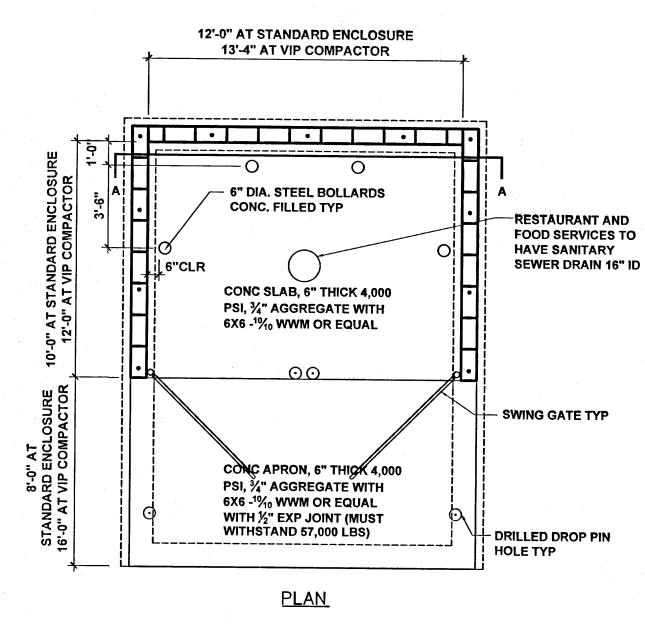

- 2-#5 CONT **SWING GATE** DROP PIN, TYP ---- 6" OD CONC FILLED STEEL PIPE **EMBEDDED IN 12"** DIA CONC, TYP -1-#5 AT 4' OC IN FULLY GROUTED CELLS

SINGLE DUMPSTER ENCLOSURE

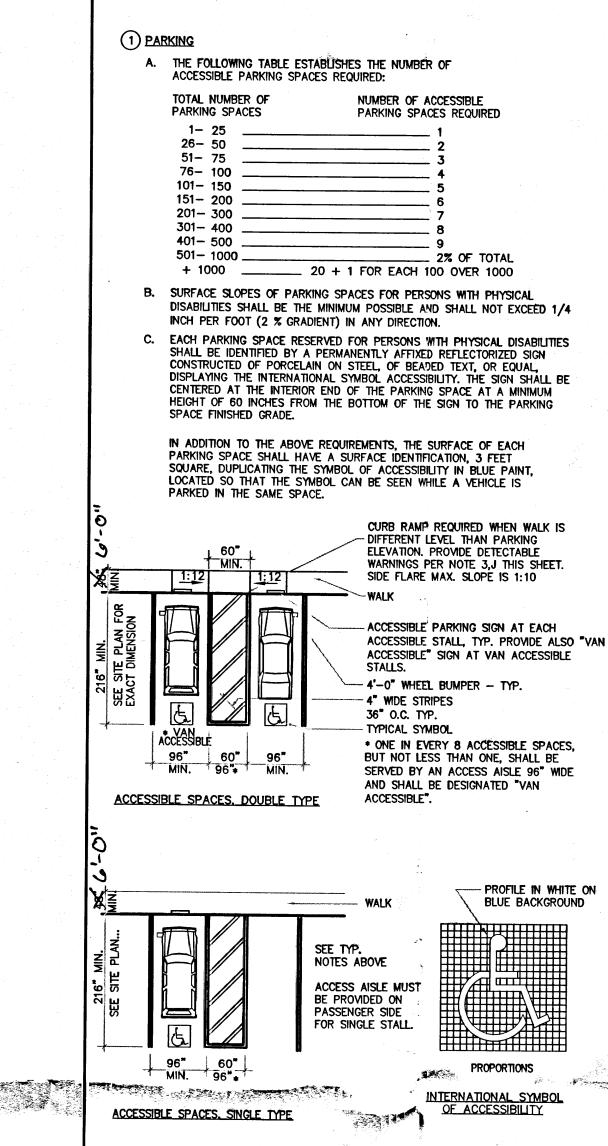

ACCESSIBLE SPACES, DOUBLE DIAGONAL TYPE

WITHIN SUCH CROSSWALKS.

A. CURB RAMPS SHALL BE CONSTRUCTED AT EACH CORNER OF STREET

INTERSECTIONS AND WHERE A PEDESTRIAN WAY CROSSES A CURB. THE

PREFERRED AND RECOMMENDED LOCATION FOR CURB RAMPS IS IN THE

RETURN AND THE STREET SURFACES ARE MARKED TO IDENTIFY PEDESTRIAN

CROSSWALKS, THE LOWER END OF THE CURB RAMPS SHALL TERMINATE

CENTER OF THE CROSSWALK OF EACH STREET CORNER, WHERE IT IS

NECESSARY TO LOCATE A CURB RAMP IN THE CENTER OF THE CURB

B. CURB RAMPS SHALL BE A MINIMUM OF 3 FEET IN WIDTH AND SHALL LIE,

C. BUILT-UP CURB RAMPS SHALL BE LOCATED SO THAT THEY DO NOT

E. THE SLOPE OF CURB RAMPS SHALL NOT EXCEED 1 VERTICAL TO 12

CURB RAMP SHALL NOT EXCEED 1 VERTICAL TO 12 HORIZONTAL.

G. THE LOWER END OF EACH CURB RAMP SHALL BE FLUSH WITH ADJACENT

H. THE SURFACE OF EACH CURB RAMP AND ITS FLARED SIDES SHALL BE STABLE, FIRM AND SLIP RESISTANT AND SHALL BE OF A CONTRASTING

CURB RAMPS SHALL BE LOCATED OR PROTECTED TO PREVENT THEIR

J. IF DIAGONAL CURB RAMPS HAVE RETURNED CURBS OR OTHER WELL-DEFINED

MINIMUM CLEAR SPACE. IF DIAGONAL CURB RAMPS ARE PROVIDED AT

MARKED CROSSINGS, THE 48 INCH CLEAR SPACE SHALL BE WITHIN THE

ALSO HAVE AT LEAST A 24 INCH LONG SEGMENT OF STRAIGHT CURB LOCATED ON EACH SIDE OF THE CURB RAMP AND WITHIN THE MARKED

MARKINGS. IF DIAGONAL CURB RAMPS HAVE FLARED SIDES, THEY SHALL

EDGES, SUCH EDGES SHALL BE PARALLEL TO THE DIRECTION OF PEDESTRIAN FLOW.. THE BOTTOM OF DIAGONAL CURB RAMPS SHALL HAVE 48 INCHES

PROJECT INTO VEHICULAR TRAFFIC LANES.

THE MARKINGS EXCLUDING ANY FLARED SIDES.

FINISH FROM THAT OF THE ADJACENT SIDEWALK

OBSTRUCTION BY PARKED CARS.

SHALL NOT EXCEED 1 VERTICAL TO 10 HORIZONTAL.

GENERALLY, IN A SINGLE SLOPED PLANE WITH A MINIMUM OF SURFACE

D. CURB RAMPS AT MARKED CROSSINGS SHALL BE WHOLLY CONTAINED WITHIN

F. A LEVEL LANDING 4 FEET DEEP SHALL BE PROVIDED AT THE UPPER END OF EACH CURB RAMP OVER ITS FULL WIDTH TO PERMIT SAFE EGRESS FROM THE RAMP SURFACE, OR THE SLOPE OF THE FANNED OR FLARED SIDES OF THE

HORIZONTAL. THE SLOPE OF THE FANNED OR FLARED SIDES OF CURB RAMPS

(2) CURB RAMPS

ACCESSIBLE PARKING SIGN AT EACH

- PROFILE IN WHITE ON


BLUE BACKGROUND

PROPORTIONS

INTERNATIONAL SYMBOL

CURB, FENCE, ETC.

INTERNATIONAL SYMBOL

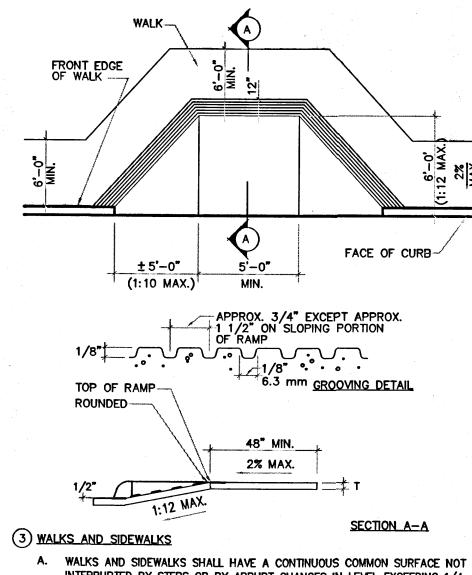

- INTERRUPTED BY STEPS OR BY ABRUPT CHANGES IN LEVEL EXCEEDING 1/4 INCH, AND SHALL BE A MINIMUM OF 4 FEET IN WIDTH.
- SURFACES WITH A SLOPE OF LESS THAN 6 PERCENT GRADIENT SHALL BE AT LEAST AS SLIP RESISTANT AS THAT DESCRIBED AS A MEDIUM SALTED FINISH.
- C. SURFACES WITH A SLOPE OF 6 PERCENT GRADIENT OR GREATER SHALL BE SLIP-RESISTANT.

TRAVEL, AND A MAXIMUM OF 1/2" IN SIZE.


D. SURFACE CROSS SLOPES SHALL NOT EXCEED 1/4 INCH PER FOOT. WALKS, SIDEWALKS AND PEDESTRIAN WAYS SHALL BE FREE OF GRATING WHENEVER POSSIBLE. FOR GRATINGS LOCATED IN THE SURFACE OF ANY OF THESE AREAS, GRID OPENINGS IN GRATINGS


SHALL BE PERPENDICULAR TO THE PROMINENT DIRECTION OF

- WHEN THE SLOPE IN THE DIRECTION OF TRAVEL OF ANY WALK EXCEEDS 1 VERTICAL TO 20 HORIZONTAL IT SHALL COMPLY WITH THE PROVISIONS FOR PEDESTRIAN RAMPS.
- ABRUPT CHANGES IN LEVEL ALONG ANY ACCESSIBLE ROUTE SHALL NOT EXCEED 1/2 INCH. WHEN CHANGES IN LEVEL DO OCCUR, THEY SHALL BE BEVELED WITH A SLOPE NO GREATER THAN 1:2 EXCEPT THAT LEVEL CHANGES NOT EXCEEDING 1/4 INCH MAY BE VERTICAL. WHEN CHANGES IN LEVEL GREATER THAN 1/2 INCH ARE NECESSARY COMPLY WITH THE REQUIREMENTS FOR CURB RAMPS.
- WALKS SHALL BE PROVIDED WITH A LEVEL AREA NOT LESS THAN 60 INCHES BY 60 INCHES AT A DOOR OR GATE THAT SWINGS TOWARD THE WALK, AND NOT LESS THAN 48 INCHES WIDE BY 44 INCHES DEEP THAT A DOOR OR GATE THAT SWINGS AWAY FROM THE WALK. SUCH WALKS SHALL EXTEND 24 INCHES TO THE SIDE OF THE STRIKE EDGE OF A DOOR OR GATE THAT SWINGS TOWARD
- I. ALL WALKS WITH CONTINUOUS GRADIENTS SHALL HAVE LEVEL AREAS OF AT LEAST 5 FEET IN LENGTH AT INTERVALS OF AT LEAST EVERY
 - J. IF A WALK CROSSES OR ADJOINS A VEHICULAR WAY, AND THE WALKING SURFACES ARE NOT SEPARATED BY CURBS, RAILINGS OR OTHER ELEMENTS BETWEEN THE PEDESTRIAN AREAS AND VEHICULAR CONTINUOUS DETECTABLE WARNING WHICH IS 36 INCHES WIDE. SEE DETECTABLE WARNING TEXTURE DETAIL.

(4) TACTILE SIGNAGE

- SITE, OR WHEN SIGNS DIRECT OR GIVE INFORMATION ABOUT A PERMANENT ROOM OR SPACE OF A BUILDING OR SITE, CORRESPONDING TACTILE SIGNAGE
- THE HEIGHT OF VISUAL CHARACTERS SHALL BE A MINIMUM 5/8" PLUS 1/8" PER FOOT OF VIEWING DISTANCE OVER SIX FEET, CHARACTER WIDTH SHALL BE 55% MINIMUM AND 110% MAXIMUM OF THE HEIGHT OF THE CHARACTER. CHARACTER STROKE WIDTH OF VISUAL ONLY CHARACTERS SHALL BE A MINIMUM OF 10% OF THE CHARACTER HEIGHT, AND A MAXIMUM OF 30%. TACTILE SIGNAGE DUPLICATING THE INFORMATION SHALL BE PROVIDED, EITHER AS PART OF THE VISUAL SIGN OR A SEPARATE TACTILE SIGN
- D. TACTILE CHARACTERS SHALL BE UPPERCASE, STANDARD SANS SERIF FONT, RAISED 1/32" OFF THE BACKGROUND. THE HEIGHT OF TACTILE CHARACTERS SHALL BE BETWEEN 5/8" AND 2". CHARACTER WIDTH SHALL BE 55% MINIMUM AND 110% MAXIMUM OF THE HEIGHT OF THE CHARACTER. CHARACTER STROKE WIDTH SHALL BE A MINIMUM OF 10% OF THE CHARACTER HEIGHT, AND A MAXIMUM OF 15%. CHARACTERS SHALL BE
- GRADE 2 BRAILLE SHALL HAVE DOMED OR ROUNDED DOTS RAISED 1/40" BETWEEN CELLS. (OR SPACED PER ANSI TABLE 703.5)
- F. TACTILE SIGNS SHALL BE MOUNTED 48" MINIMUM, AND 60" MAXIMUM ABOVE THE FLOOR TO THE CENTERLINE OF THE SIGN. AN 18" X 18" CLEAR SPACE IS REQUIRED IN FRONT OF THE TACTILE SIGN, BEYOND THE ARC OF ANY DOOR SWING. WHERE SIGNS ARE MOUNTED AT DOORS, THE SIGN SHALL BE ON THE LATCH SIDE OF THE DOOR. WHERE SIGNS ARE MOUNTED AT DOUBLE DOORS, OR WHERE THERE IS NO WALL SPACE, THE SIGN SHALL BE MOUNTED
- CHARACTERS, SYMBOLS AND BACKGROUNDS SHALL HAVE A NON-GLARE

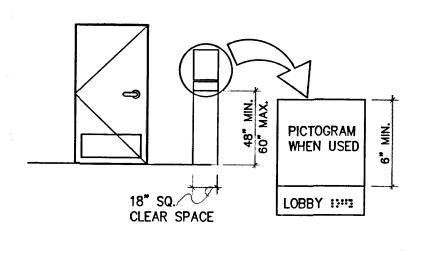

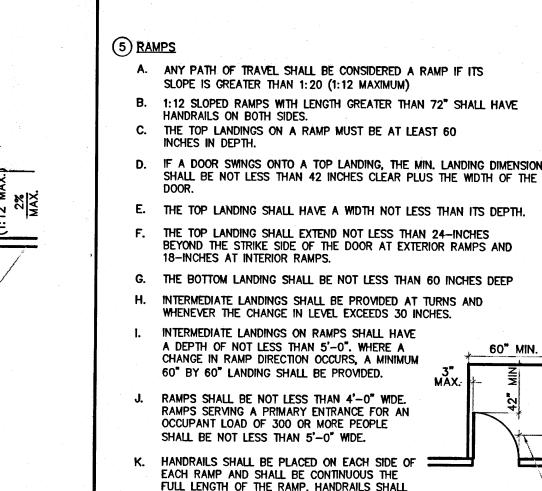

L SURFACES OF RAMPS SHALL BE SLIP-RESISTANT. M. RAMPS & LANDINGS WITH DROP OFFS SHALL HAVE CURBS, WALLS, RAILING OR PROJECTING SURFACES THAT PREVENT PEOPLE FROM SLIPPING OFF THE RAMP. CURB SHALL BE A MIN. 2" IN HEIGHT

BE 34 TO 38 INCHES ABOVE THE RAMP SURFACE AND EXTEND A MINIMUM OF 1 FOOT BEYOND THE

TOP AND BOTTOM OF THE RAMP.

MAXIMUM ELEVATION CHANGE BETWEEN LANDINGS IS 30" (1:12) 30 FEET (1:16) 40 FEET INTERVAL MAX. (1:20) 50 FEET PLATFORM INTERMEDIATE LEVEL 48" MIN. SEE NOTE J PLATFORM ** WHEN DOOR SWINGS ONTO LANDING, 42 INCHES MIN. STRAIGHT RAMP RUN

24" EXTERIOR

LANDING AT RAMP

** WHEN DOOR SWINGS

42 INCHES MIN.

PLUS DOOR WIDTH.

ONTO LANDING,


60" MIN.

MAXIMUM ELEVATION CHANGE BETWEEN LANDINGS IS 30"

INTERMEDIATE -TURNING PLATFORM


AREAS, THE BOUNDARY BETWEEN THE AREAS SHALL BE DEFINED BY A

- A. WHEN SIGNS IDENTIFY A PERMANENT ROOM OR SPACE OF A BUILDING OR
- B. WHEN SIGNS IDENTIFY, OR GIVE INFORMATION ABOUT ACCESSIBLE ELEMENTS AND FEATURE OF A BUILDING OR SITE, THEY SHALL INCLUDE THE APPROPRIATE SYMBOL OF ACCESSIBILITY OR PICTOGRAM, WITH THE EQUIVALENT VISUAL AND TACTILE DESCRIPTION PLACED DIRECTLY BELOW THE PICTOGRAM. THE OUTSIDE BORDER OF THE PICTOGRAM SHALL BE MINIMUM 6"
- C. VISUAL CHARACTERS SHALL BE UPPERCASE, STANDARD SANS SERIF FONT.
- ACCOMPANIED BY GRADE 2 BRAILLE.
- OFF THE BACKGROUND, WITH DOTS SPACED 1/10" WITH-IN CELLS, AND 1/4"
- ON THE NEAREST ADJACENT WALL, PREFERABLY THE RIGHT SIDE.
- G. CHARACTERS AND SYMBOLS SHALL CONTRAST WITH THEIR BACKGROUND.

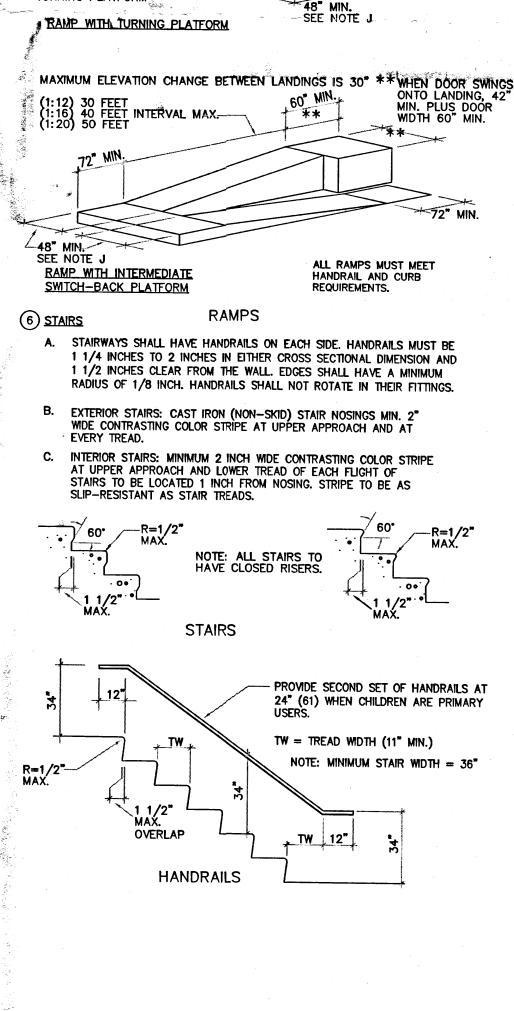



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LAND DEVELOPMENT SECTION
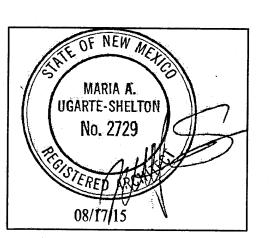
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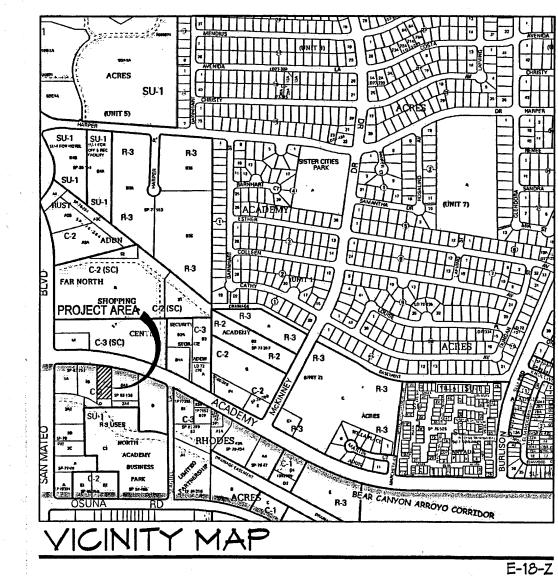
5. Ibuq

Project Number Drawn By Checked Issue Date ____Aug 17, 2015 TYPICAL SITE **ACCESSIBILITY** STANDARDS & DETAILS

NUMBER DELTA ANGLE CHORD DIRECTION RADIUS ARC LENGTH CHORD LENGTH

03°48'43" | N 81°29'33" W | 1757.05 | 116.90

ARCHITECTURAL SITE PLAN / TCL



SITE DATA:

LEGAL DESCRIPTION: TRACT "A", NORTH ACADEMY BUSINESS PARK

UPC: 101806204807730121

ADDRESS: 5350 ACADEMY RD NE

PROPERTY AREA: 0.6931 ACRES

CURRENT ZONING: C-3

JUN 3 0 2015 LAND DEVELOPMENT SECTION PROPOSED T-MOBILE RETAIL BUILDING = 2,490 SF

KEYED NOTES:

- PROPOSED REFUSE ENCLOSURE, SEE SITE DETAIL SHEET
- 2. PROPOSED LANDSCAPE AREA, SEE LANDSCAPE PLAN.
- 3. PROPOSED 6" HIGH CONCRETE CURB.

- PROPOSED ACCESSIBLE PARKING SIGN POST MOUNTED
- PROPOSED CONCRETE SIDEWALK.
- 9. PROPOSED 4" WIDE PAVEMENT STRIPING.
- 10 PROPOSED ASPHALT PAVEMENT.
- 11. PROPOSED MOTORCYCLE PARKING SIGN
- 12. PROPOSED "NO PARKING" PAVEMENT MARKING IN CAPITAL LETTERS, EACH OF MHICH SHALL BE 12" HIGH AND 2" MIDE MINIMUM.
- 13. PROPOSED 6' WIDE CONCRETE PEDESTRIAN CONNECTION.
- 14. NOT USED.

13 SPACES *63 SPACES

* 33 EXISTING STANDARD SPACES TO REMAIN

ADDITIONAL PARKING REQUIREMENTS:

1 MOTORCYCLE SPACE REQUIRED AND 2 PROVIDED 2 BICYCLE SPACES REQUIRED AND 2 PROVIDED

+ 28 NEW STANDARD SPACES PROVIDED + 2 NEW ACCESSIBLE SPACES PROVIDED = 63 PARKING SPACES PROVIDED

- 15. PROPOSED 2-BIKE CAPACITY HOOP RACK BY DERCO OR APPROVED EQUAL.
- 16. EXISTING TRAFFIC SIGNAL ARM & ASSOCIATED EQUIPMENT TO REMAIN.
- 17. EXISTING WATER & IRRIGATION METERS TO REMAIN.
- 18. EXISTING SIDEWALK TO REMAIN.
- 19. EXISTING PATIO WALL ON ADJACENT PROPERTY.
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- 24. EXISTING 30' PRIVATE COMMON ACCESS EASEMENT; BOOK C19, FOLIO 42, BOOK C19, FOLIO 157, BOOK C20, FOLIO 168 & BOOK C23, FOLIO
- 25. EXISTING 10' WATERLINE EASEMENT; BOOK C19, FOLIO 157, BOOK C20, FOLIO 168 \$ BOOK C23, FOLIO 65.
- 26. EXISTING 10' PUBLIC UTILITY EASEMENT; BOOK MISC. 255A, PAGE 794.

27.	EXISTING	FRONT	YARD	BUILDING	SETBACK	LINE;	BOOK	C19, FOLIO	157

Project Number May 12, 2015 Issue Date ARCHITECTURAL SITE PLAN / TCL

Darren Sowell ARCHITECTS

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UGARTE-SHELTON