


SCHEDULE/SEQUENCING OF CONSTRUCTION

- POST PERMITS
- 2. INSTALL REQUIRED BMPs 2.a. PERIMETER CONTROLS
 - 2.b. STABILIZED CONSTRUCTION ENTRANCE 2.c. CONCRETE WASHOUT AREA
- 3. CLEAR/GRUB
- TEMP POND
- 5. EARTHWORK AND GRADING 6. UTILITY INSTALLATION
- 7. PAVEMENT STRUCTURES
- 8. VERTICAL STRUCTURES
- 9. LANDSCPING 10. PUNCHLIST

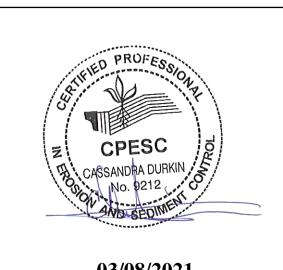

03/08/2021 **CPESC Stamp** RECEIVING WATERS: ABQ MS4 SOUTH PINO ARROYO TO SOUTH PINO ARROYO SEDIMENTATION POND

CRITICAL HABITAT: CRITERION "A"; NO CRITICAL HABITATS WITHN THE PROJECT AREA

GPS LOCATION: 35.1579, -106.5799

PHS HEALTHPLEX POOL ADDITION

PROJECT TITLE

ALBUQUERQUE, BERNALILLO COUNTY, NM CITY, COUNTY, STATE

03/08/2021

C. DURKIN DRAWN BY




INLET PROTECTION









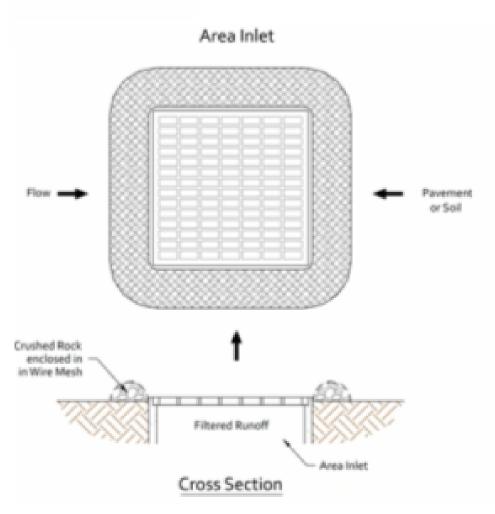

BMP Objectives

- **Sediment Control**
- Sheet Flow Runoff Control

SILT FENCE



BMP Objectives

- Sediment Control
- Sheet Flow Runoff Control
- Wind Erosion Control

SEDIMENT TRACK OUT CONTROL



BMP Objectives

Sediment Control

MULCH SOCK/STRAW WATTLE



BMP Objectives

- Sediment Control
- Reduce Runoff Velocity
- Inlet Protection

BERMS AND SWALES



BMP Objectives

- Runoff Control
- Run-on Diversion

EROSION CONTOL NOTES ESC Plan Standard Notes (2020-06-03)

1.All Erosion and Sediment Control (ESC) work on these plans, except as otherwise stated or provided hereon shall be permitted, constructed, inspected, and maintained in accordance with:

a.The City Ordinance § 14-5-2-11, the ESC Ordinance,


b.The EPA's 2017 Construction General Permit (CGP), and

c.The City Of Albuquerque Construction BMP Manual.

2.All BMP's must be installed prior to beginning any earth moving activities except as specified hereon in the Phasing Plan. Construction of earthen BMP's such as sediment traps, sediment basins, and diversion berms shall be completed and inspected prior to any other construction or earthwork. Self-inspection is required after installation of the BMPs and prior to beginning construction.

3.Self-inspections - At a minimum a routine compliance self-inspection is required to review the project for compliance with the Construction General Permit once every 14 days and after any precipitation event of 1/4 inch or greater until the site construction has been completed and the site determined as stabilized by the city. Reports of these inspections shall be kept by the person or entity authorized to direct the construction activities on the site.

4.BMPs shall be inspected and maintained until all disturbed areas are stabilized in accordance with the Final Stabilization Criteria (CGP 2.2.14.b). Generally, all disturbed areas, other than structures, must have uniform perennial vegetation that provides 70 percent or more of the cover provided by native vegetation or seed the disturbed area and provide non-vegetative mulch that provides cover for at least three years without active maintenance. Final stabilization must be documented on prior to removal of BMPs and discontinuation of inspections.

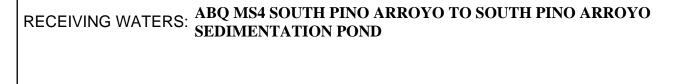

. CRITERION "A"; NO CRITICAL HABITATS WITHN THE

GPS LOCATION: 35.1579, -106.5799



CPESC Stamp

ALBUQUERQUE, BERNALILLO COUNTY, NM


DRAWN BY

PHS HEALTHPLEX POOL ADDITION

CITY, COUNTY, STATE

PROJECT TITLE

03/08/2021 C. DURKIN INSPECTIONS PLUS

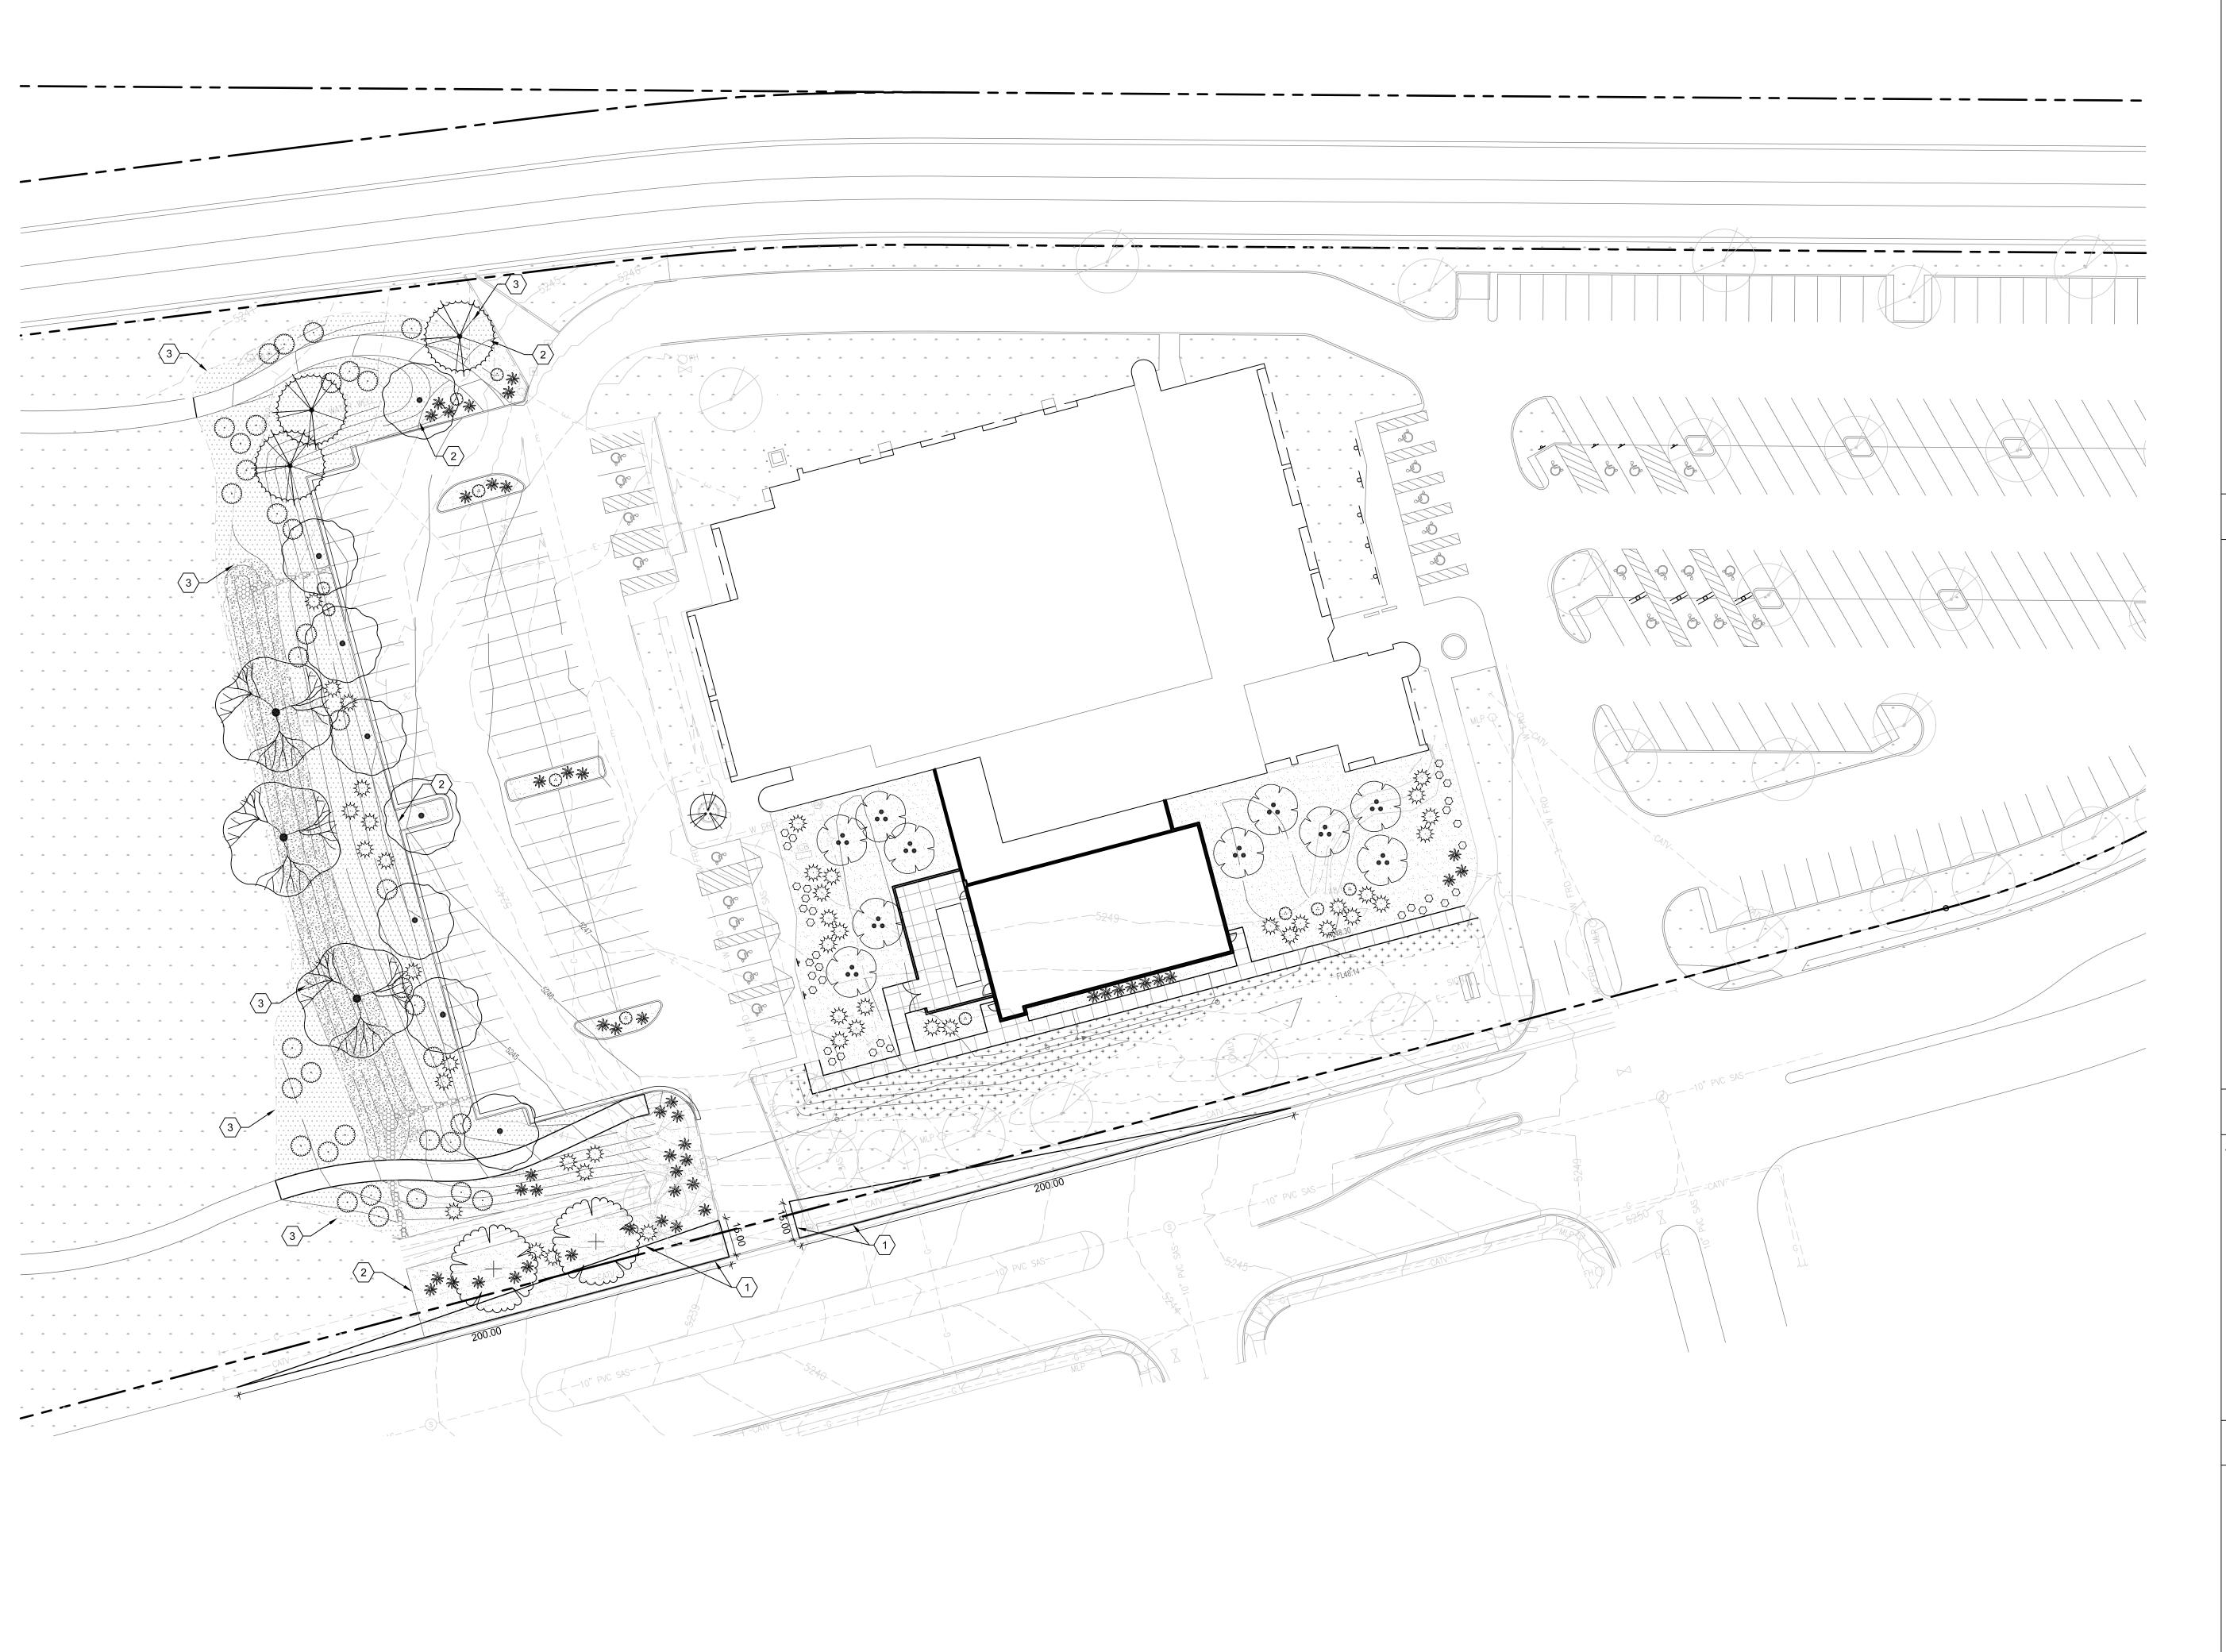


GENERAL SHEET NOTES

- A. RESPONSIBILITY FOR MAINTENANCE: THE CONTRACTOR WILL BE RESPONSIBLE FOR MAINTENANCE OF THE LANDSCAPE DURING CONSTRUCTION AND DURING A 90 DAY-MAINTENANCE PERIOD FOLLOWING SUBSTANTIAL COMPLETION. THE OWNER WILL BE RESPONSIBLE FOR MAINTENANCE FOLLOWING THE 90-DAY MAINTENANCE PERIOD.
- B. STATEMENT OF COMPLIANCE WITH CITY OF ALBUQUERQUE: THE LANDSCAPE DESIGN WILL COMPLY WITH THE CITY OF ALBUQUERQUE'S LANDSCAPING, BUFFERING, AND SCREENING REGULATIONS (14-16-5-6), WATER CONSERVATION ORDINANCE AND POLLEN ORDINANCE.
 C. TIMING OF LANDSCAPE INSTALLATION: INSTALLATION OF THE LANDSCAPING SHALL BE COMPLETE WITHIN 60 DAYS OF THE RELATED BUILDING'S OCCUPANCY.
- D. SURFACE TREATMENT: DISTURBED LANDSCAPE AREAS ARE OR SHALL BE COVERED WITH TURF, OR VEGETATION AND MULCH. ORGANIC MULCH IS REQUIRED AT EACH NEW TREE ROOTBALL AREA/DRIPLINE.
 E. LANDSCAPE AND SIGNAGE WILL NOT INTERFERE WITH CLEAR SIGHT REQUIREMENTS. THEREFORE SIGNS, WALLS, TREES AND SHRUBS BETWEEN 3 AND 7 FEET TALL (AS MEASURED FROM THE GUTTER PAN) WILL NOT BE PERMITTED IN THE CLEAR SIGHT TRIANGLE.
 F. MINIMUM PLANT SIZES ARE AS PER CITY OF ALBUQUERQUE STANDARDS PER TABLE 5-6-1 OF THE IDO.
- G. LANDSCAPE AREAS THAT AREA DISTURBED DURING CONSTRUCTION WILL BE REPAIRED TO THEIR ORIGINAL CONDITION.
 H. VEGETATIVE SCREENING SURROUNDING GROUND-MOUNTED TRANSFORMERS AND UTILITY PADS SHALL ALLOW 10' OF CLEARANCE MINIMUM IN FRONT OF THE EQUIPMENT DOOR AND 5' OF CLEARANCE MINIMUM ON THE REMAINING SIDES FOR SAFE OPERATION AND MAINTENANCE.
- I. EXISTING PLANT MATERIAL TO BE PRESERVED ON THE PROPERTY IS SHOWN AND QUANTIFIED IN THE LANDSCAPE CALCULATIONS.
 J. SEE SITE PLAN FOR IMPERVIOUS AREAS AND EASEMENTS.

DEKKER PERICH SABATINI

ARCHITECTURE DESIGN INSPIRATION

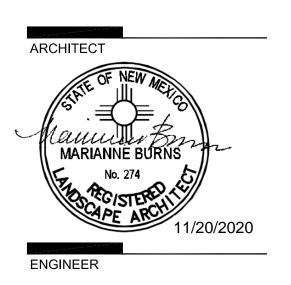

PROJECT

GENERAL SHEET NOTES

TREES

COMMON NAME

SKYLINE THORNLESS HONEY LOCUST

TUSCARORA CRAPE MYRTLE

AUSTRIAN BLACK PINE

RIO GRANDE COTTONLESS COTTONWOOD

FRONTIER ELM

SHRUBS

COMMON NAME

BLONDE AMBITION BLUE GRAMA

DESERT WILLOW

APACHE PLUME

RED YUCCA

BEARGRASS

LOS LUNAS SACATON

LEGEND

PROPERTY LINE

EXISTING TREE TO REMAIN AND BE PROTECTED DURING CONSTRUCTION

'NATIVE MULCH' SHREDDED BARK MULCH AT 2" DEPTH OVER WEED BARRIER FABRIC

7/8"Ø SANTA FE BROWN ROCK MULCH AT 2" DEPTH OVER WEED BARRIER FABRIC

TURF GRASS SEEDING REPAIR OF EXISTING LAWN AREA

2" CRUSHED GRAY ROCK MULCH AT 3" DEPTH OVER OVER WEED BARRIER FABRIC

RIPRAP RUNDOWNS, SEE CIVIL

EXISTING VEGETATION TO REMAIN

○ SHEET KEYED NOTES


SYMBOL	DESCRIPTION
1	CLEAR SIGHT TRIANGLE, NO PLANT MATERIAL WITH A MATURE HEIGHT GREATER THAN 3`-0" TO BE WITHIN THIS AREA
2	COMMERCIAL GRADE STEEL EDGE, SEE D1/LP501
$\langle 3 \rangle$	NATURAL EDGE BETWEEN MULCH AND EXISTING VEGETATION

DRAWN BY	CD
REVIEWED BY	MB
DATE	11.20.2020
PROJECT NO.	20-0006.001
DRAWING NAME	

LANDSCAPE PLAN


SHEET NO.

LP101

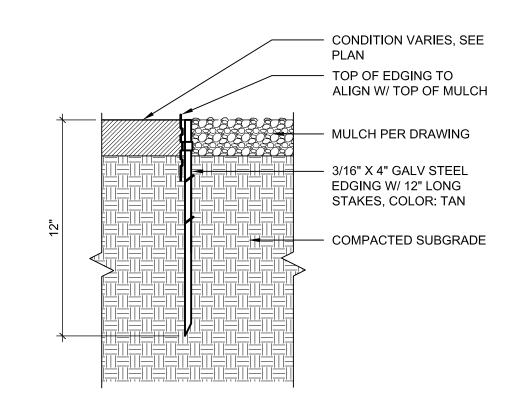


STEEL EDGING

VINYL TREE TIES TO BE CINCH-TIE 32" OR APPROVED EQUAL, AVAILABLE FROM V.I.T. PRODUCTS - 800-729-1314
 STAKING TO BE REMOVED AT THE END OF WARRANTY PERIOD

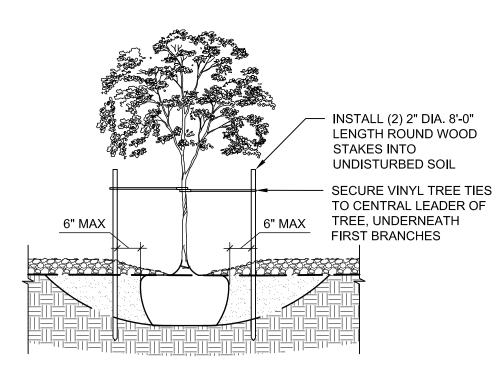


TREE STAKING

PRIOR TO BACKFILLING, MATERIAL SUCH AS CONTAINERS, WIRE, BURLAP AND ROPE SHALL BE COMPLETELY REMOVED.
 SLOPE SHOULD PASS THROUGH THE POINT WHERE THE TRUNK BASE MEETS SUBSTRATE/SOIL.

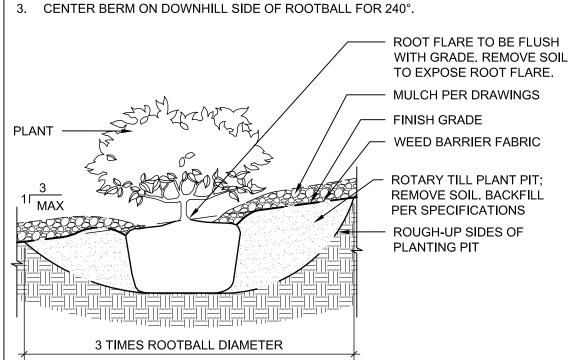

SHRUB ON SLOP

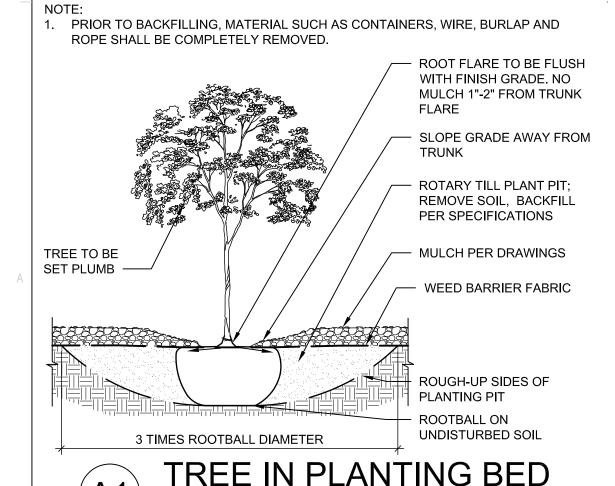

NOTES:
1. PRIOR TO BACKFILLING, MATERIAL SUCH AS CONTAINERS, WIRE, BURLAP

1. STAKING TO BE REMOVED AT THE END OF

- INSTALL (2) 2" Ø x 8'-0"


STAKES INTO UNDISTURBED SOIL

6" MAX TREE

LENGTH ROUND WOOD

TO CENTRAL LEADER OF


WARRANTY PERIOD

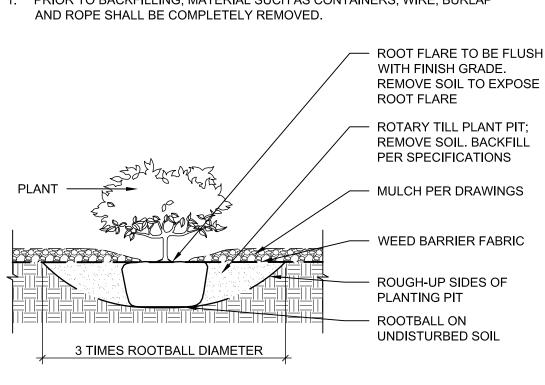

A2 SHRUB IN BED

3/4" = 1'-0"

0 1'

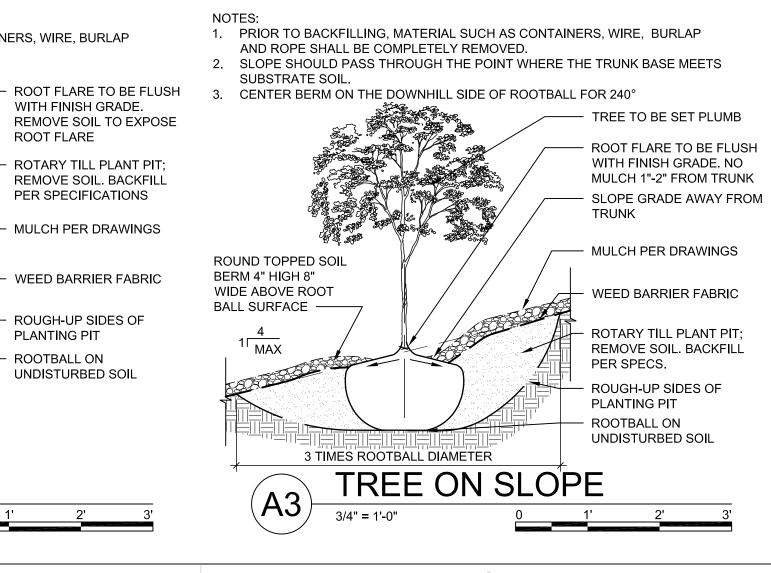


TREES QTY BOTANICAL NAME SEE A1, A3, C1, AND C2/LP501 SIZE/COND. MAT. HT. MAT. DIA. COMMON NAME GLEDITSIA TRIACANTHOS INERMIS `SKYCOLE` TM SKYLINE THORNLESS HONEY LOCUST 2" CAL. 45.00 35.00 LAGERSTROEMIA INDICA 'TUSCARORA' TUSCARORA CRAPE MYRTLE 24" BOX 15.00 15.00 PINUS NIGRA AUSTRIAN BLACK PINE 60.00 40.00 POPULUS WIZLIZENI RIO GRANDE COTTONLESS COTTONWOOD 3" CAL B&B 50.00 50.00 ULMUS X `FRONTIER` FRONTIER ELM 2" CAL 35.00 30.00 **BOTANICAL NAME COMMON NAME** MAT. HT. MAT. DIA. SIZE/COND. 34 BOUTELOUA 'BLONDE AMIBITION' BLONDE AMBITION BLUE GRAMA 1 GAL 3.00 3.00 CHILOPSIS LINEARIS 'ARTS SEEDLESS' **DESERT WILLOW** 24" BOX 25.00 25.00 11 FALLUGIA PARADOXA APACHE PLUME 5 GAL 5.00 6.00 48 HESPERALOE PARVIFLORA RED YUCCA 5 GAL 5.00 5.00 43 NOLINA MICROCARPA BEARGRASS 5 GAL 6.00 7.00 36 SPOROBOLUS WRIGHTII 'WINDBREAKER' LOS LUNAS SACATON 1 GAL 8.00 8.00 **LEGEND** AVAILABLE FROM SUPPLIER: EST. QTY:. SYMBOL: — — — PROPERTY LINE EXISTING TREE TO REMAIN AND BE PROTECTED DURING CONSTRUCTION 'NATIVE MULCH' SHREDDED BARK MULCH AT 2" DEPTH OVER WEED BARRIER FABRIC SOILUTIONS, ALBUQUERQUE, NM 505/877-0220 14,812 SQFT BUILDOLOGY, ALBUQUERQUE, NM 20,881 SQFT 7/8"Ø SANTA FE BROWN ROCK MULCH AT 2" DEPTH OVER WEED BARRIER FABRIC 505/344-6626 TURF GRASS SEEDING REPAIR OF EXISTING LAWN AREA, CURTIS AND CURTIS SEED, CLOVIS, NM 3,896 SQFT PARK BLEND, INCL. KENTUCKY BLUEGRASS, PERENNIAL 877/907-1806 RYEGRASS AND TALL FESCUE, 8#/1000 SQFT 2"Ø CRUSHED GRAY ROCK MULCH AT 3" DEPTH OVER RESTORATION GROUP INC., ALBUQUERQUE, NM 4,694 SF OVER WEED BARRIER FABRIC 505/294-1470 RIPRAP RUNDOWNS, SEE CIVIL

EXISTING VEGETATION TO REMAIN

PLANT SCHEDULE

DEKKER PERICH SABATINI

ARCHITECTURE DESIGN INSPIRATION

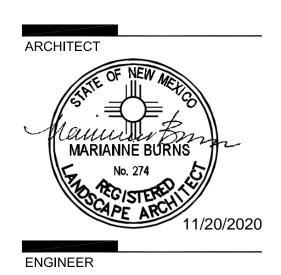

PROJECT

PHS HEALTHPL
POOL ADDITIO
6301 FOREST HILLS DR.
ALBUQUERQUE, NM

DRAWN BY	CD
REVIEWED BY	MB
DATE	11.20.2020
PROJECT NO.	20-0006.001
DRAWING NAME	

LANDSCAPE DETAILS

