
CITY OF ALBUQUERQUE

Planning Department Alan Varela, Director

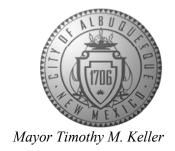

August 31, 2023

Scott McGee, P.E. 9700 Sand Verbena Trail NE Albuquerque, NM 87122

RE: Human Bean Coffee Shop 7301 San Antonio Drive NE Grading & Drainage Plan Engineer's Stamp Date: 08/07/23 Hydrology File: E19D025B2

Dear Mr. McGee:

Based upon the information provided in your submittal received 08/14/2023, the Grading & Drainage Plan is approved for Building Permit and Grading Permit. Please attach a copy of this approved plan in the construction sets for Building Permit processing along with a copy of this letter.

PO Box 1293

PRIOR TO CERTIFICATE OF OCCUPANCY:

Albuquerque

1. Engineer's Certification, per the DPM Part 6-14 (F): *Engineer's Certification Checklist For Non-Subdivision* is required.

NM 87103

2. Please provide the executed paper Drainage Covenant (latest revision) printed on one-side only with Exhibit A and a check for \$25.00 made out to "Bernalillo County" for the stormwater quality pond per Article 6-15(C) of the DPM to Hydrology for review at Plaza de Sol.

www.cabq.gov

As a reminder, if the project total area of disturbance (including the staging area and any work within the adjacent Right-of-Way) is 1 acre or more, then an Erosion and Sediment Control (ESC) Plan and Owner's certified Notice of Intent (NOI) is required to be submitted to the Stormwater Quality Engineer (Doug Hughes, PE, jhughes@cabq.gov, 924-3420) 14 days prior to any earth disturbance.

If you have any questions, please contact me at 924-3995 or rbrissette@cabq.gov.

Sincerely,

Renée C. Brissette, P.E. CFM Senior Engineer, Hydrology Planning Department

Renée C. Brissette



City of Albuquerque


Planning Department


Development & Building Services Division

DRAINAGE AND TRANSPORTATION INFORMATION SHEET (REV 10/2018)

Project Title:	Building	Permit #:	Hydrol	Hydrology File #:	
DRB#:	EPC#:		Work Order#:		
Legal Description:					
City Address:					
Applicant:			Contact		
Address:Phone#:					
Other Contact:					
Address:				_	
Phone#:					
TYPE OF DEVELOPMENT:	PLAT (# of lots)	RESIDENCE _	DRB SITE	ADMIN SITE	
IS THIS A RESUBMITTAL? Y					
DEPARTMENT: TRAFFIC/TI		HYDROLOG	Y/DRAINAGE		
Check all that Apply: TYPE OF SUBMITTAL: ENGINEER/ARCHITECT CERTIFICATION PAD CERTIFICATION CONCEPTUAL G & D PLAN GRADING PLAN DRAINAGE MASTER PLAN DRAINAGE REPORT FLOODPLAIN DEVELOPMENT PERMIT APPLIC ELEVATION CERTIFICATE CLOMR/LOMR TRAFFIC CIRCULATION LAYOUT (TCL) TRAFFIC IMPACT STUDY (TIS) OTHER (SPECIFY) PRE-DESIGN MEETING?		TYPE OF APPROVAL/ACCEPTANCE SOUGHT: BUILDING PERMIT APPROVAL CERTIFICATE OF OCCUPANCY PRELIMINARY PLAT APPROVAL SITE PLAN FOR SUB'D APPROVAL SITE PLAN FOR BLDG. PERMIT APPROVAL FINAL PLAT APPROVAL SIA/ RELEASE OF FINANCIAL GUARANTEE FOUNDATION PERMIT APPROVAL GRADING PERMIT APPROVAL SO-19 APPROVAL PAVING PERMIT APPROVAL GRADING/ PAD CERTIFICATION WORK ORDER APPROVAL CLOMR/LOMR FLOODPLAIN DEVELOPMENT PERMIT OTHER (SPECIFY)			
					DATE SUBMITTED:

FEE PAID:___

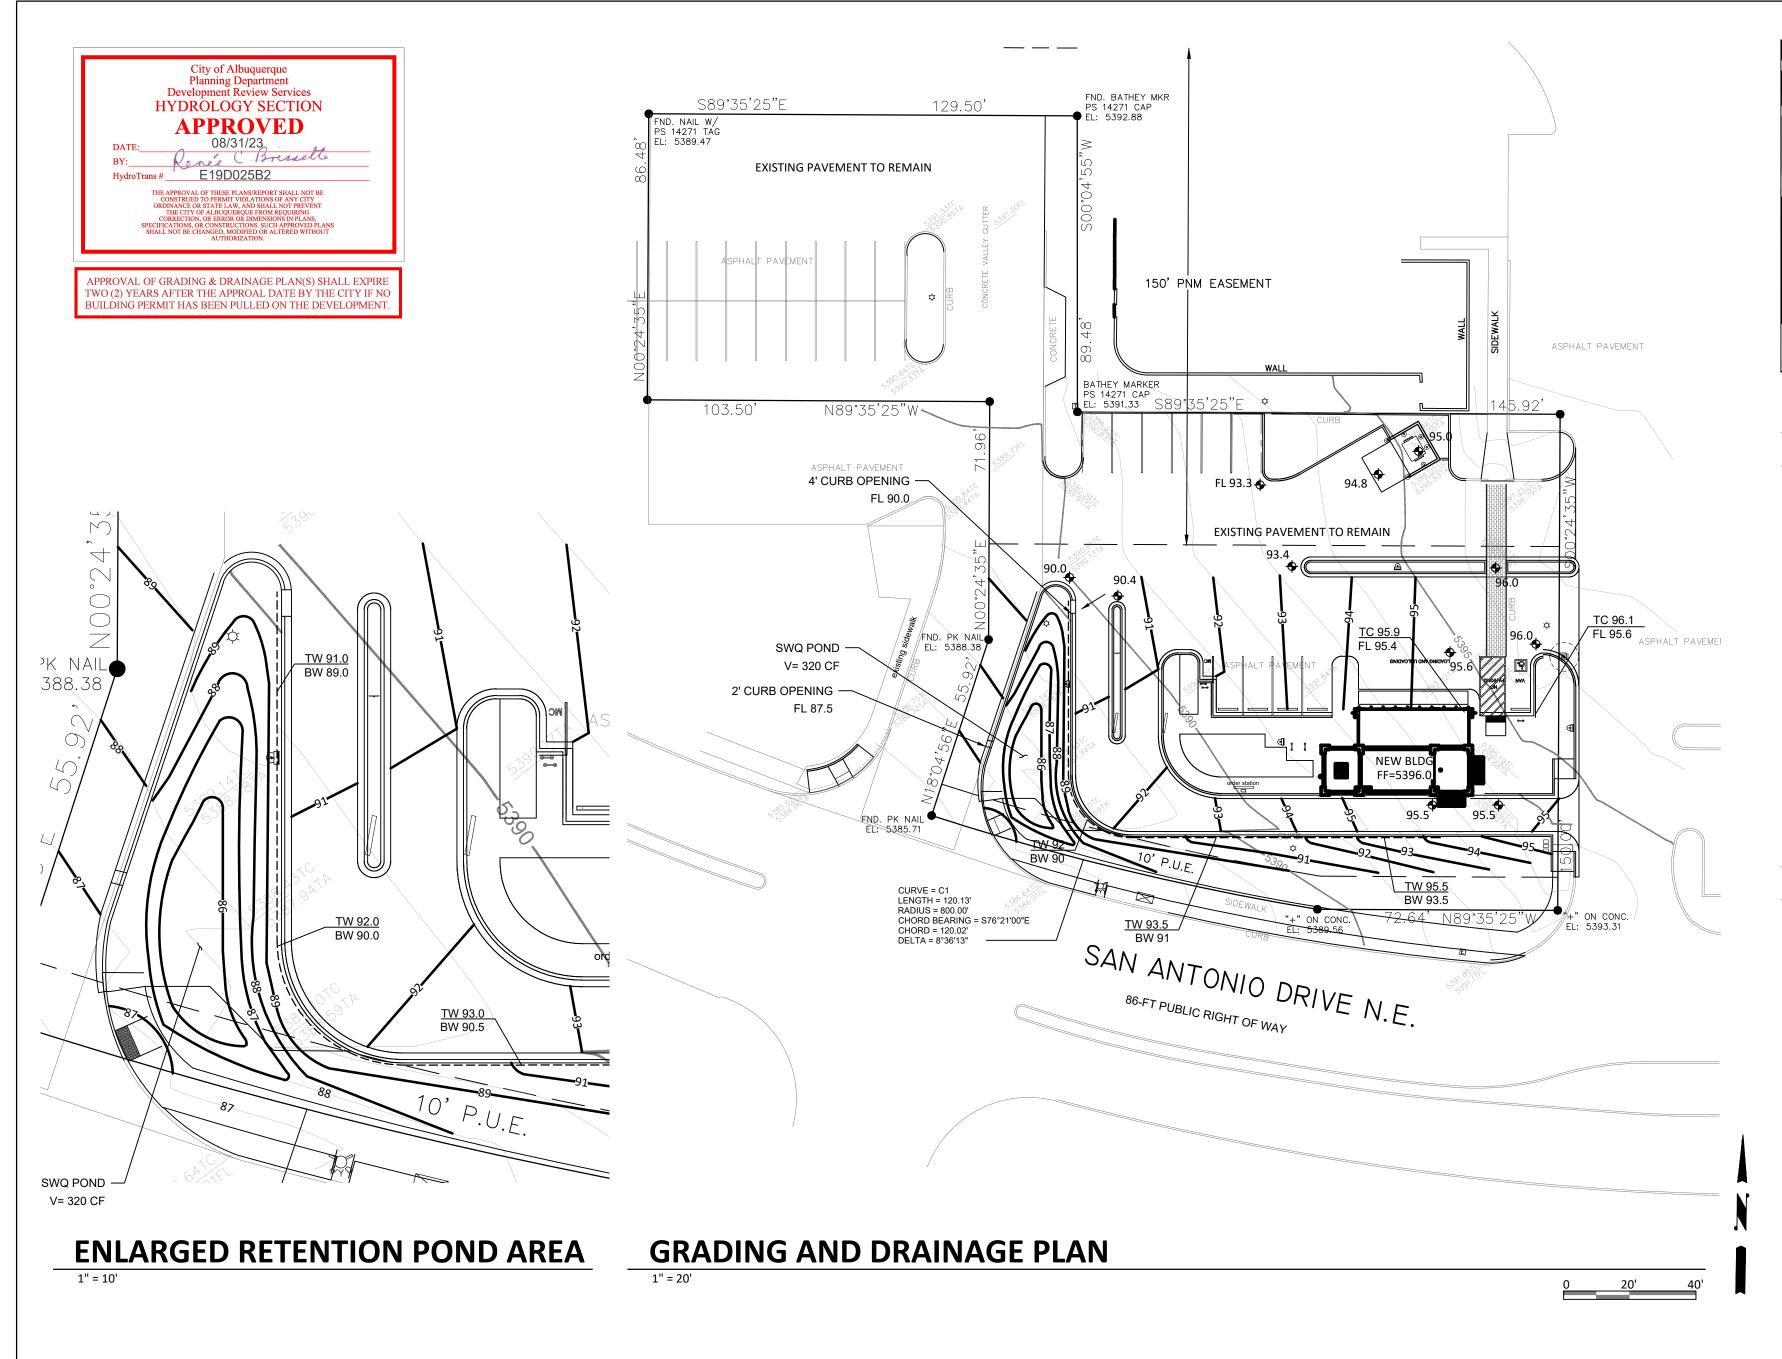

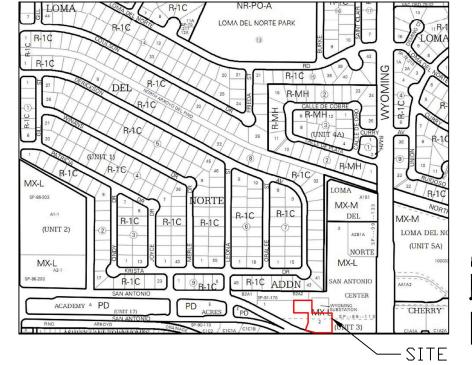

VICINITY MAP

D-19-Z

LEGEND

	EXISTING CONSTRUCTION	
	NEW CONTOUR	
FF=5396.0	PROPOSED BUILDING FINISHED FLOOR	
• 65.5	NEW SPOT ELEVATION	
	NEW CONSTRUCTION	
→ RD	ROOF DRAIN	
TC	TOP OF CURB	
FL	FLOWLINE	
	NEW RETAINING WALL	
/		
<u>TW 94</u>	TOP OF WALL ELEVATION	

BOTTOM OF WALL ELEVATION

DRAINAGE NARRATIVE

ADDRESS: 7301 San Antonio Drive NE

LEGAL DESCRIPTION: LOT 2, SAN ANTONIO CENTER

SITE AREA: 0.84 AC PROJECT AREA: 18,420 SF (0.42 AC)

BENCHMARK: City of Albuquerque Station '25-E18' being a brass cap.

ELEV= 5339.186 (NAVD 1988)

SURVEYOR: Alpha Pro Surveying LLC dated February 2023

FLOOD HAZARD: From FEMA Map 35001C0141G (9/26/2008), this site is identified as being within Zone 'X' which is determined to be outside the 0.2% annual chance floodplain.

OFFSITE FLOW: The site does accept minor offsite flow from existing adjacent paved parking areas to the north and east. The proposed development will continue to accept this minor runoff.

EXISTING CONDITIONS: The site is currently developed with existing paved access and parking, and landscaped areas. The site slopes down to the southwest at 6 - 7 % and discharges to San Antonio Drive NE.

PROPOSED IMPROVEMENTS: The proposed improvements include a 640 SF building, drive through lane, concrete sidewalks, and landscaping. This building will be located where existing asphalt paving was previously.

DRAINAGE APPROACH: The site drainage pattern will direct developed flow from the new impervious surfaces to the onsite SWQ retention pond. Existing land treatment: 8% C and 92% D PRECIPITATION ZONE: 3 Q= [(0.13)(3.17)+(.87)(4.49)](0.42)=1.8 CFS Proposed land treatment: 21% C and 79% D Q= [(0.21)(3.17)+(0.79)(4.49)](0.42)=1.8 CFS Redevelopment SWQ V= (14,100)(0.26/12)=305 CF

This flow will discharge to an onsite retention ponding area located at the SW corner of the site. The SWQ volume of 320 CF shall be retained in the onsite

bottom and the site discharge will remain unchanged.



OWNER: KEITH GRIEGO

HUMAN BEAN - SAN ANTONIO & WYOMING

GRADING AND DRAINAGE

Project Number	Project Number
Date	06-29-2023
Drawn By	Author
Checked By	Checker

GD0

1" = 20'-0"



or er 0"