CITY OF ALBUQUERQUE

Planning Department Alan Varela, Director



December 13, 2024

Scott McGee, PE SMM PE LLC PO BOX 1273 Elephant Butte, NM 87935

RE: Human Bean Coffee Shop

7301 San Antonio Drive NE

Permenant Certificate of Occupancy - Accepted

Engineer's Certification Date: 12/9/24 Engineer's Stamp Date: 08/07/23 Hydrology File: E19D025B2

Dear Mr. McGee:

Based on the Engineer's Partial Grading and Drainage Certification received 12/10/2024 and site visit on 12/12/2024, this letter serves as a "Green Tag" from Hydrology Section for a Permanent

Certificate of Occupancy for the Human Bean Coffee Shop located at 7301 San Antonio Drive

NE to be issued by the Building and Safety Division.

Albuquerque If you have any questions, please contact me at 505-924-3314 or amontoya@cabq.gov.

NM 87103 Sincerely,

www.cabq.gov Anthony Montoya, Jr., P.E.

Senior Engineer, Hydrology

anth Mars

Planning Department, Development Review Services



City of Albuquerque


Planning Department

Development & Building Services Division

DRAINAGE AND TRANSPORTATION INFORMATION SHEET (REV 10/2018)

Project Title:	Building	Permit #:	Hydrology File #:	
DRB#:	EPC#:		Work Order#:	
Legal Description:				
City Address:				
Applicant:			Contact	
Address:Phone#:				
Other Contact:				
Address:				_
Phone#:				
TYPE OF DEVELOPMENT:	PLAT (# of lots)	RESIDENCE _	DRB SITE	ADMIN SITE
IS THIS A RESUBMITTAL? Y				
DEPARTMENT: TRAFFIC/TI		HYDROLOG	Y/DRAINAGE	
Check all that Apply:		TYPE OF APPROVAL/ACCEPTANCE SOUGHT:		
TYPE OF SUBMITTAL: ENGINEER/ARCHITECT CERTIFICATION PAD CERTIFICATION CONCEPTUAL G & D PLAN GRADING PLAN DRAINAGE MASTER PLAN DRAINAGE REPORT FLOODPLAIN DEVELOPMENT PERMIT APPLIC ELEVATION CERTIFICATE CLOMR/LOMR TRAFFIC CIRCULATION LAYOUT (TCL) TRAFFIC IMPACT STUDY (TIS) OTHER (SPECIFY) PRE-DESIGN MEETING?		BUILDING PERMIT APPROVAL CERTIFICATE OF OCCUPANCY PRELIMINARY PLAT APPROVAL SITE PLAN FOR SUB'D APPROVAL SITE PLAN FOR BLDG. PERMIT APPROVA FINAL PLAT APPROVAL SIA/ RELEASE OF FINANCIAL GUARANTE FOUNDATION PERMIT APPROVAL GRADING PERMIT APPROVAL SO-19 APPROVAL PAVING PERMIT APPROVAL GRADING/ PAD CERTIFICATION WORK ORDER APPROVAL CLOMR/LOMR FLOODPLAIN DEVELOPMENT PERMIT OTHER (SPECIFY)		
DATE SUBMITTED:	By:			

FEE PAID:___

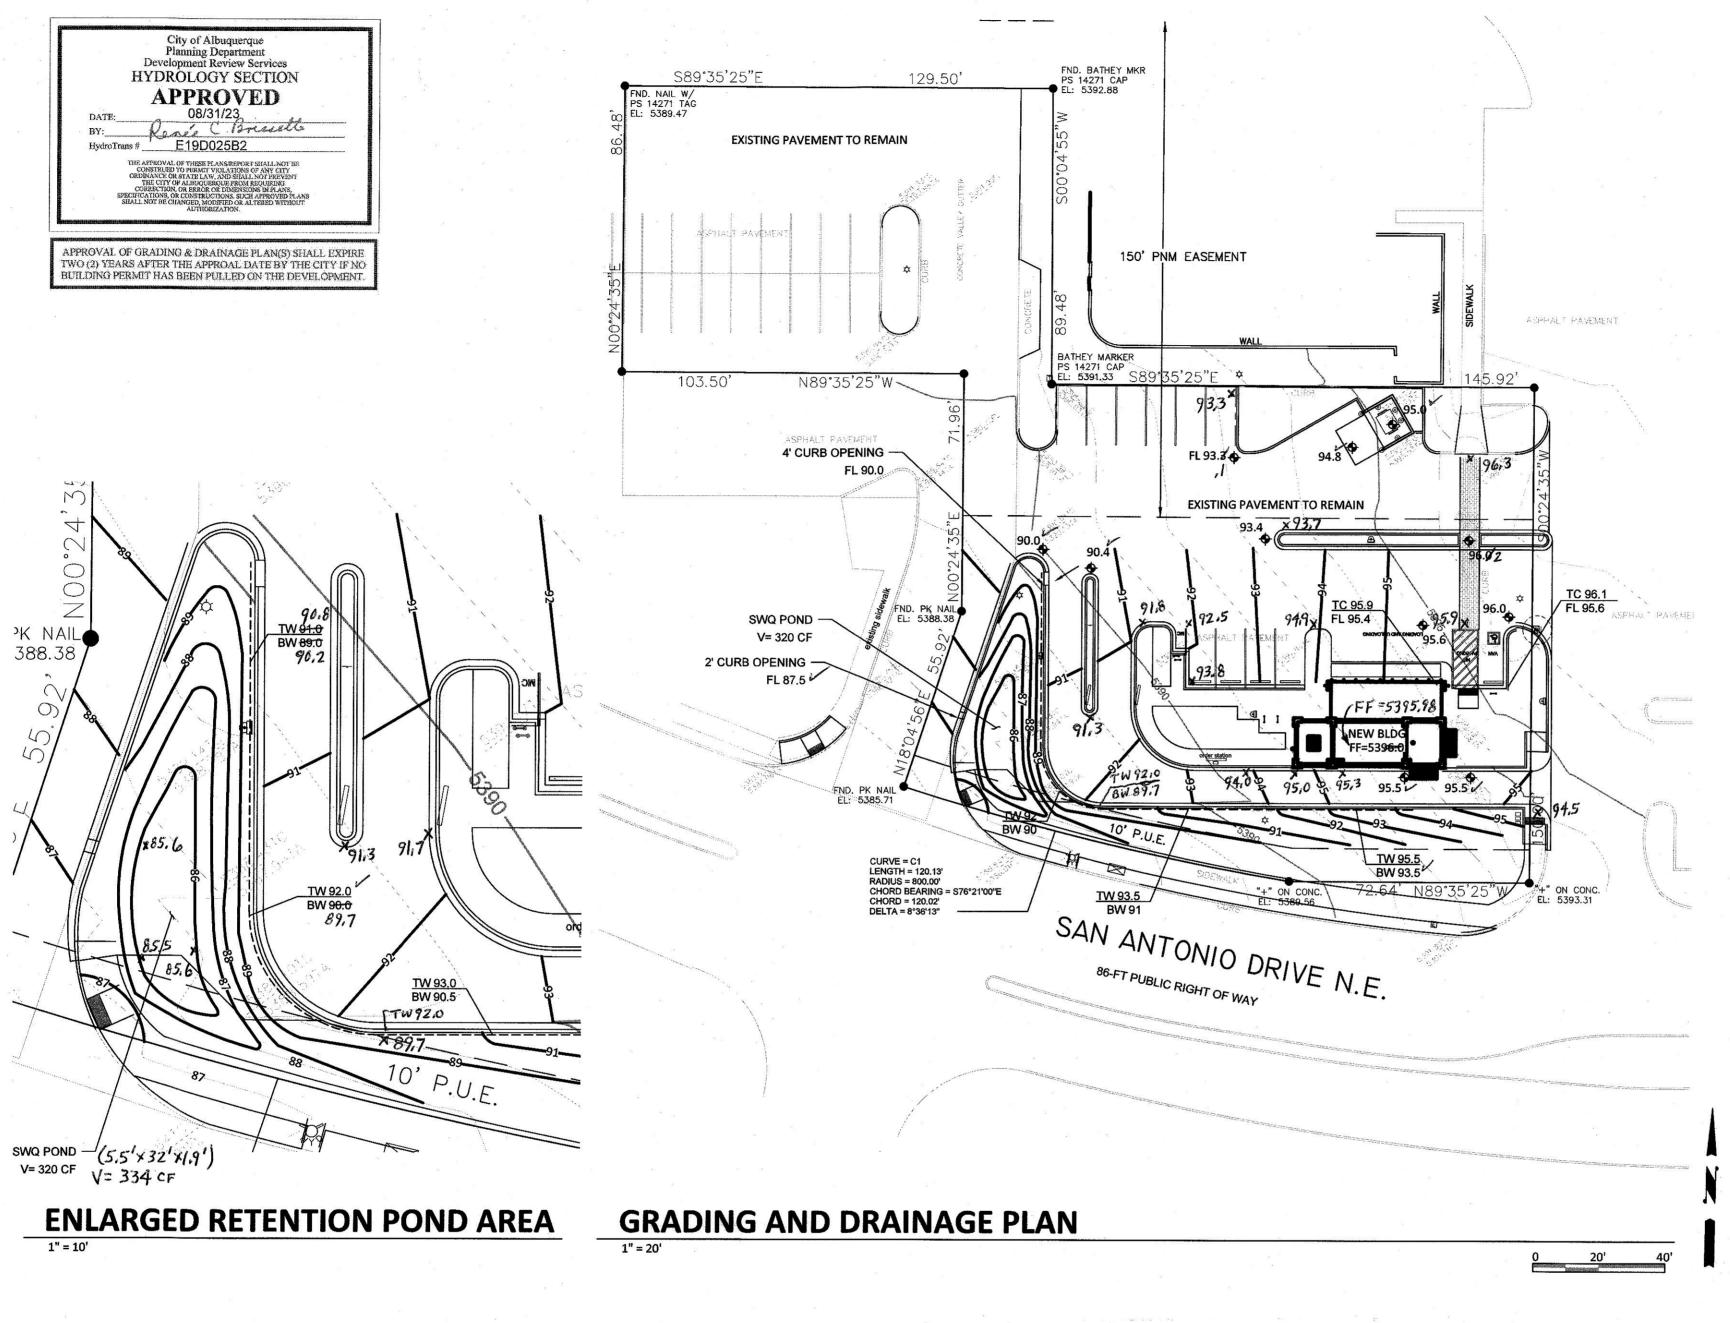

TOP OF WALL ELEVATION BOTTOM OF WALL ELEVATION AS-BUILT ELEVATION

DRAINAGE NARRATIVE

ADDRESS: 7301 San Antonio Drive NE

SITE AREA: 0.84 AC PROJECT AREA: 18,420 SF (0.42 AC)

BENCHMARK: City of Albuquerque Station '25-E18' being a brass cap.

ELEV= 5339.186 (NAVD 1988)


FLOOD HAZARD: From FEMA Map 35001C0141G (9/26/2008), this site is identified as being within Zone 'X' which is determined to be outside the 0.2% annual chance floodplain.

OFFSITE FLOW: The site does accept minor offsite flow from existing adjacent paved parking areas to the north and east. The proposed development will continue to accept this minor runoff.

access and parking, and landscaped areas. The site slopes down to the southwest at 6 - 7 % and discharges to San Antonio Drive NE.

building, drive through lane, concrete sidewalks, and landscaping. This building will be located where existing asphalt paving was previously.

the new impervious surfaces to the onsite SWQ retention pond. Existing land treatment: 8% C and 92% D PRECIPITATION ZONE: 3 Q= [(0.13)(3.17)+(.87)(4.49)](0.42)= 1.8 CFS Proposed land treatment: 21% C and 79% D Q= [(0.21)(3.17)+(0.79)(4.49)](0.42)= 1.8 CFS Redevelopment SWQ V= (14,100)(0.26/12)= 305 CF This flow will discharge to an onsite retention ponding area located at the SW corner of the site. The SWQ volume of 320 CF shall be retained in the onsite bottom and the site discharge will remain unchanged.

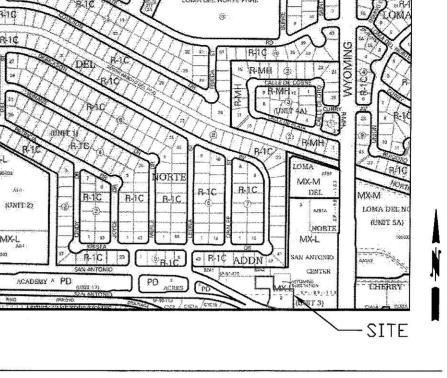

VICINITY MAP

D-19-Z

LEGEND

EXISTING CONSTRUCTION PROPOSED BUILDING FINISHED FLOOP **NEW SPOT ELEVATION** TOP OF CURB **NEW RETAINING WALL**


LEGAL DESCRIPTION: LOT 2, SAN ANTONIO CENTER

SURVEYOR: Alpha Pro Surveying LLC dated February 2023

EXISTING CONDITIONS: The site is currently developed with existing paved

PROPOSED IMPROVEMENTS: The proposed improvements include a 640 SF

DRAINAGE APPROACH: The site drainage pattern will direct developed flow from

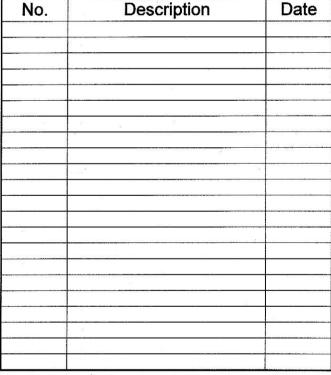

OWNER: KEITH GRIEGO

HUMAN BEAN - SAN **ANTONIO & WYOMING**

> **GRADING AND** DRAINAGE

Project Number **Project Number** 06-29-2023 Drawn By Author Checked By Checker

GD0

J. MARTINEZ, NA
PROJECT SITE O
HEREON IS REPR
KNOWLEDGE AN

DRAINAGE CERTIFICATION

DRAINAGE CERTIFICATION FOR TEMPORARY CERTIFICATE OF OCCUPANCY

BE MADE FOR A PERMANENT CERTIFICATE OF OCCUPANCY.

I, SCOTT M MCGEE, NMPE 10519, OF THE FIRM SCOTT M MCGEE PE, LLC, HEREBY REQUEST A

TEMPORARY CERTIFICATE OF OCCUPANCY BE ISSUED FOR THIS. A SUBSEQUENT CERTIFICATION WILL

ANY RECORD INFORMATION SHOWN HEREON IS NOT NECESSARILY COMPLETE AND IS ONLY INTENDED

TO VERIFY SUBSTANTIAL COMPLIANCE OF THE GRADING/ DRAINAGE ASPECTS OF THIS PROJECT.

THOSE RELYING ON THIS RECORD DOCUMENT ARE ADVISED TO OBTAIN INDEPENDENT ACCURACY

I, SCOTT M MCGEE, NMPE 10519, OF THE FIRM SCOTT M MCGEE PE, LLC, HEREBY CERTIFY THAT THIS SITE HAS BEEN GRADED AND WILL DRAIN IN SUBSTANTIAL COMPLIANCE WITH THE DESIGN INTENT OF THE APPROVED PLAN DATED 8/7/2023. THE RECORD INFORMATION EDITED ONTO THE ORIGINAL PLAN WAS PROVIDED BY BRIAN MPLS # 18374, OF CARTESIAN SURVEYING. I ALSO CERTIFY THAT I PERSONALLY VISITED THE ON 9/17/24 AND HAVE DETERMINED BY VISUAL INSPECTION THAT THE SURVEY DATA SHOWN RESENTATIVE OF ACTUAL SITE CONDITIONS AND IS TRUE AND CORRECT TO THE BEST OF MY ND BELIEF. THIS CERTIFICATION IS SUBMITTED IN SUPPORT OF A REQUEST FOR A PERMANENT CERTIFICATE OF OCCUPANCY.

THE RECORD INFORMATION SHOWN HEREON IS NOT NECESSARILY COMPLETE AND IS ONLY INTENDED TO VERIFY SUBSTANTIAL COMPLIANCE OF THE GRADING AND DRAINAGE ASPECTS OF THIS PROJECT. THOSE RELYING ON THIS RECORD DOCUMENT ARE ADVISED TO STAIN INDEPENDENT ACCURACY VERIFICATION

BEFORE USING IT FOR ANY PURPOSE.

1" = 20'-0"