

August 20,1998

Larry Read Larry Read & Associates P.O. Box 90233 Albuquerque, New Mexico 87199

RE: REVISED DRAINAGE PLAN FOR WESTERN-WIRELESS ACT BUILDING (E21-D31) REVISION DATED 8/14/98

Dear Mr. Read:

Based on the information provided on your August 14,1998 resubmittal, the above referenced site is approved for Building Permit.

Please attach a copy of this approved plan to the construction sets prior to sign-off by Hydrology.

Also, a separate permit is required for construction within City R/W. A copy of this approval letter must be on hand when applying for the excavation permit.

Prior to Certificate of Occupancy release, Engineer Certification per the DPM checklist will be required.

If I can be of further assistance, please feel free to contact me at 924-3986.

C: Andrew Garcia
Arlene Portillo
File

Sincerely

Bernie J. Montoya ČE Associate Engineer

Donne Mataga



DRAINAGE INFORMATION SHEET

PROJECT TITLE: WESTERN WIRELESS - ACT BUILDING	ZONE ATLAS/DRNG. FILE: <u>E-21-Z</u>
LEGAL DESCRIPTION: LOT A1-1, MEADOWS SUBDIVISI	ON
CITY ADDRESS: SOUTHEAST CORNER OF EUBANK AND	D JUAN TABO NE
ENGINEERING FIRM: LARRY READ & ASSOCIATES	CONTACT: LARRY READ
ADDRESS: P. O. BOX 90233 ALB, NM 87199	PHONE: 858-3165
OWNER: WESTERN WIRELESS	CONTACT: CHAWN KUTSCHDACH
ADDRESS: 4830 PAN AMERICAN	PHONE: 480-0100
ARCHITECT: ROHDE MAY KELLER McNAMARA	CONTACT: JIM McNAMARA
ADDRESS: 400 GOLD SW #1100	PHONE: 243-5454
SURVEYOR:	CONTACT:
ADDRESS:	PHONE:
CONTRACTOR:	CONTACT:
ADDRESS:	PHONE:
PREDESIGN MEETING: YES NO AUG 1 4 1998 COPY OF CONFERENCE RECAPSHIBETOTION PROVIDED	DRB NO EPC NO PROJECT NO
TYPE OF TRANSMITTAL:	CHECK TYPE OF APPROVAL SOUGHT:
DRAINAGE REPORT	SKETCH PLAT APPROVAL
X_ DRAINAGE PLAN	PRELIMINARY PLAT APPROVAL
PRELIMINARY GRADING AND DRAINAGE	SITE DEVELOPMENT PLAN APPROVAL
X GRADING PLAN	FINAL PLAT APPROVAL
EROSION CONTROL PLAN	X BUILDING PERMIT APPROVAL
ENGINEER'S CERTIFICATION	FOUNDATION PERMIT APPROVAL
	CERTIFICATE OF OCCUPANCY APPROVAL
	ROUGH GRADING PERMIT APPROVAL
DATE SUBMITTED: AUGUST 14, 1998	GRADING/PAVING PERMIT APPROVAL
BY: LARRY READ	X OTHER SO-19 (SPECIFY)



July 21,1998

Larry Read & Associates
P.O. Box 90233
Albuquerque, New Mexico 87199

RE: DRAINAGE PLAN FOR WESTERN-WIRELESS ACT BUILDING (E21-D31) ENGINEER'S STAMP DATED 6/30/98

Dear Mr. Read:

Based on the information provided on your July 14,1998 submittal, listed are some concerns that will need to be addressed prior to final approval:


- 1. SO19 format on the plan drawing (six notes and sign-off block) extra copy with the resubmittal.
- 2. Top of curb and flowline elevations on Eubank & Academy NE.
- 3. Inverts for the all the pipes thru the sidewalk.

If I can be of further assistance, please feel free to contact me at 924-3986.

C; Andrew Garcia File Sincerely

Bernie J. Montoya CE Associate Engineer



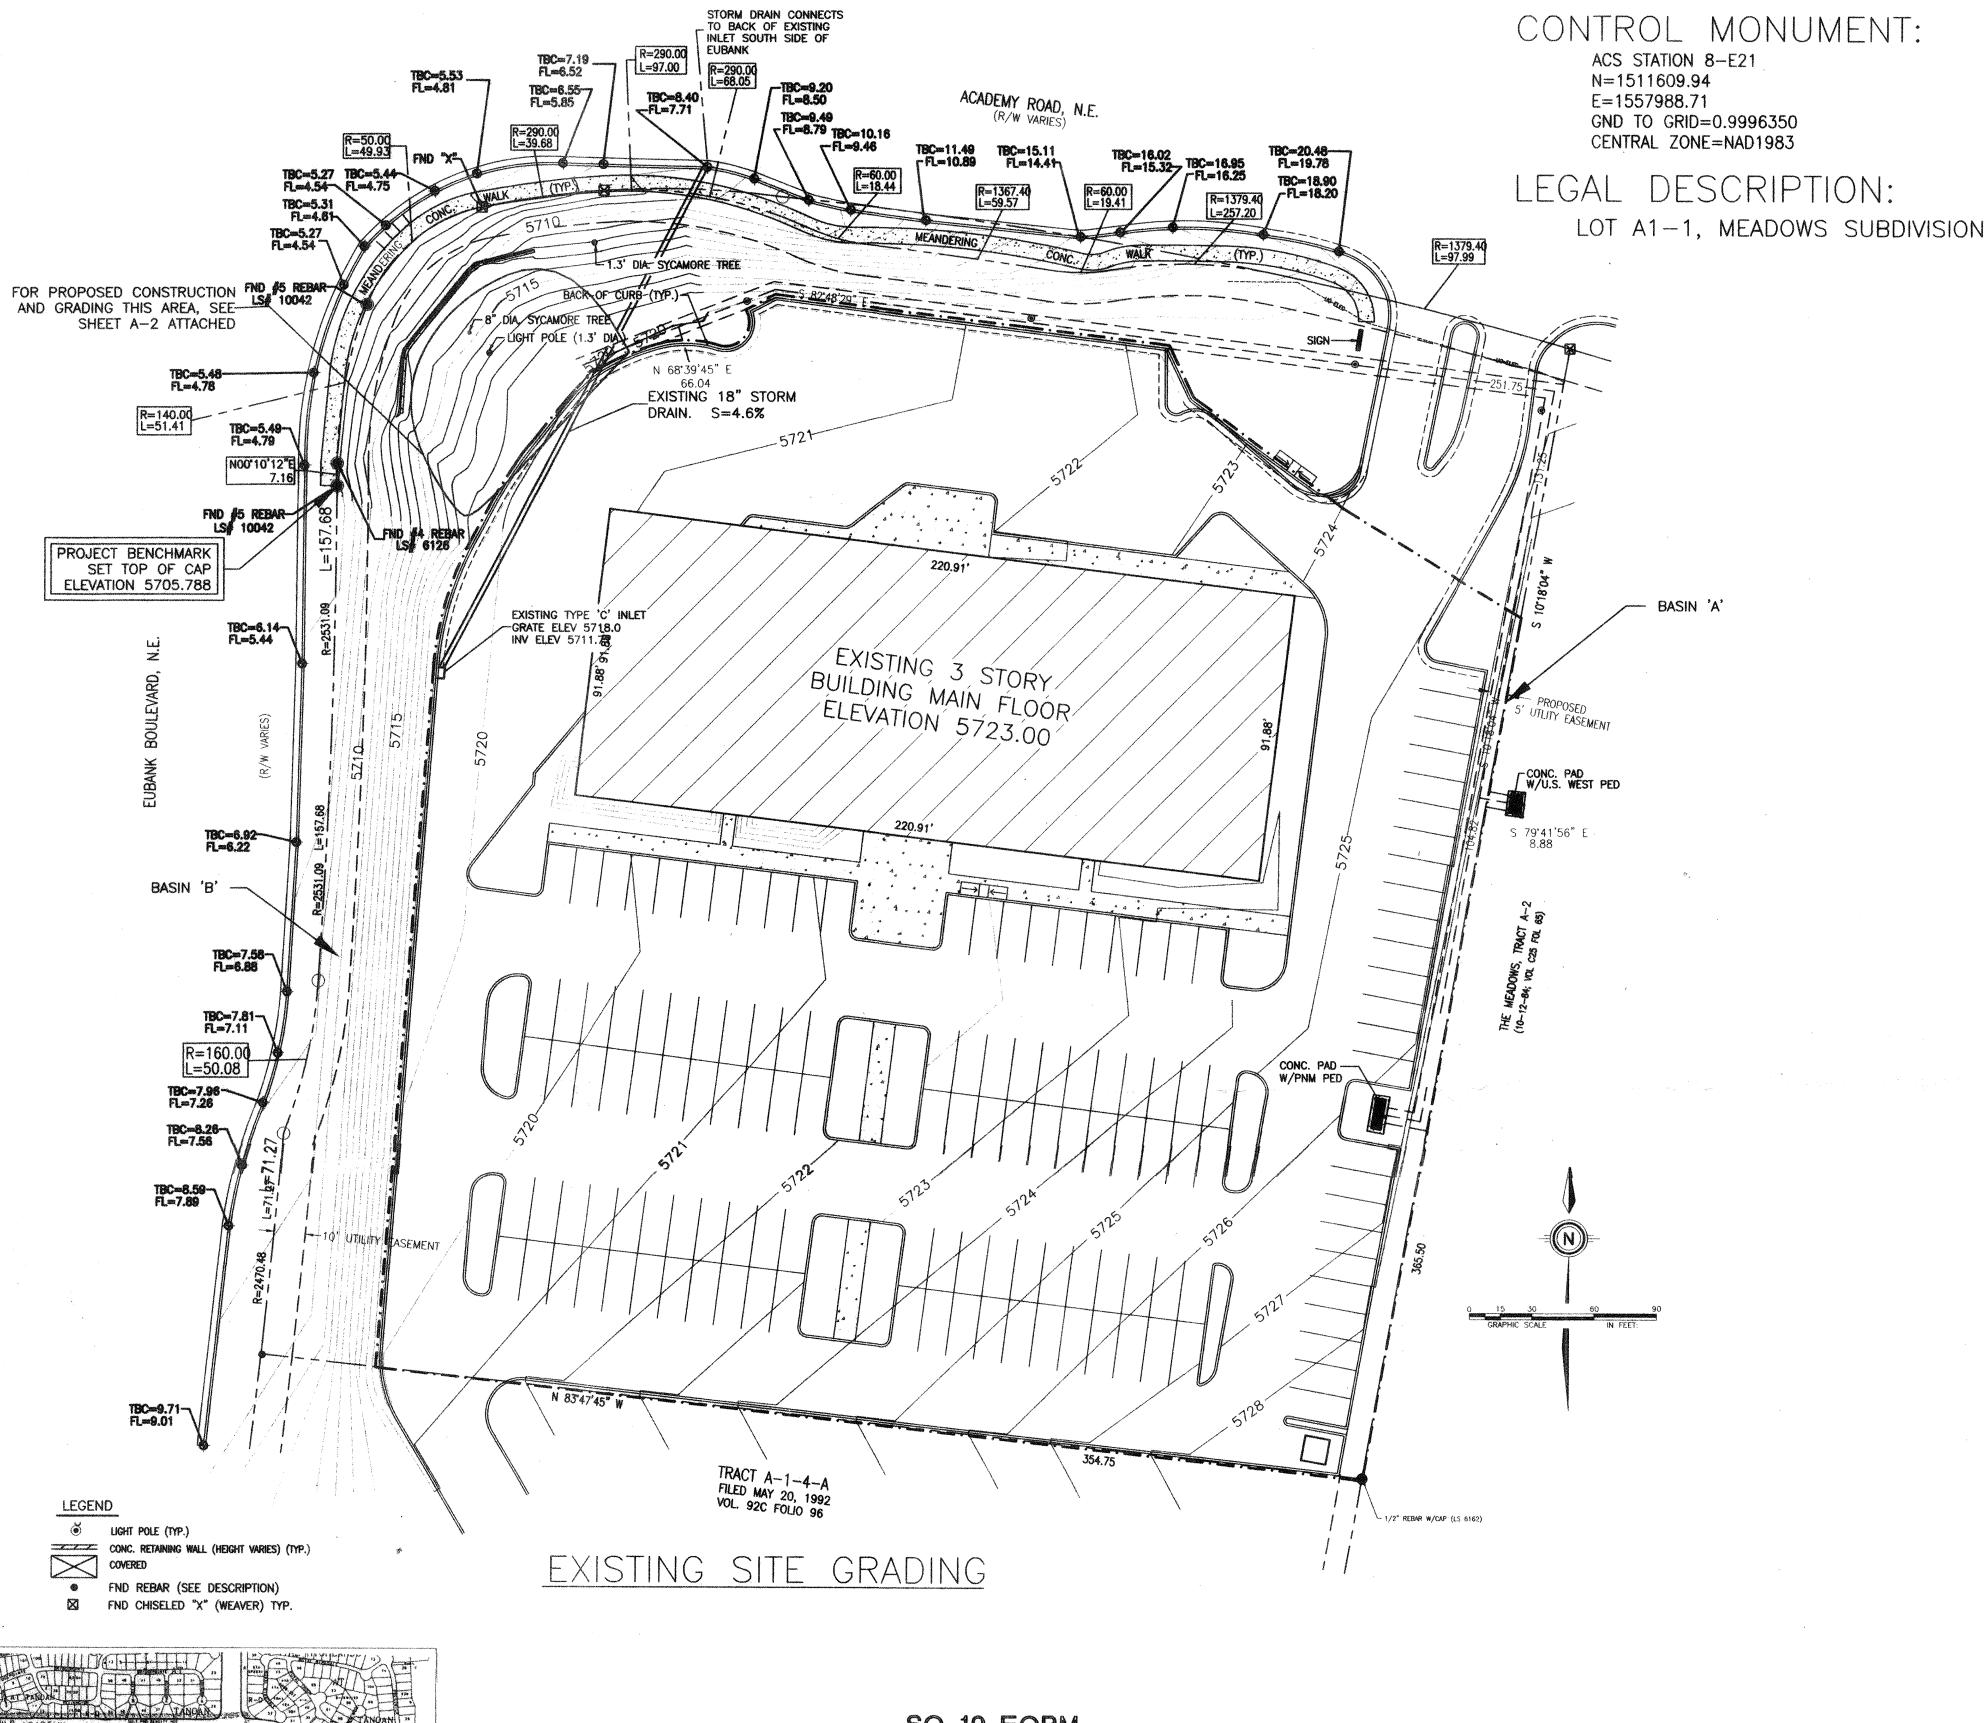

SO-19 FORM

NOTICE TO CONTRACTOR

- AN EXCAVATION/CONSTRUCTION PERMIT WILL BE REQUIRED BEFORE BEGINNING ANY WORK WITHIN THE CITY RIGHT-OF-WAY. AN APPROVED COPY OF THESE PLANS MUST BE SUBMITTED AT THE TIME OF APPLICATION FOR THIS PERMIT.
- ALL WORK DETAILED ON THESE PLANS TO BE PERFORMED WITHIN THE CITY RIGHT-OF-WAY SHALL, EXCEPT AS OTHERWISE STATED OR PROVIDED FOR HEREON, BE CONSTRUCTED IN ACCORDANCE WITH C.O.A. STANDARD SPECIFICATIONS FOR PUBLIC WORKS CONSTRUCTION 1986.
- TWO (2) WORKING DAYS PRIOR TO ANY EXCAVATION, THE CONTRACTOR MUST CONTACT LINE LOCATING SERVICE 260-1990, FOR LOCATION OF
- PRIOR TO CONSTRUCTION, THE CONTRACTOR SHALL EXCAVATE AND VERIFY THE HORIZONTAL AND VERTICAL LOCATIONS OF ALL OBSTRUCTIONS, SHOULD A CONFLICT EXIST, THE CONTRACTOR SHALL NOTIFY THE ENGINEER OR SURVEYOR SO THAT THE CONFLICT CAN BE RESOLVED WITH MINIMUM AMOUNT OF DELAY.
- BACKFILL COMP ACTION SHALL BE ACCORDING TO ARTERIAL STREET USE.

VICINITY MAP
ZONE ATLAS MAP E-21-Z

MAINTENANCE OF THESE FACILITIES SHALL BE THE RESPONSIBILITY OF THE

- THE FOLLOWING NOTES ALSO APPLY WHEN CHECKED O ALL UTILITIES AND UTILITY SERVICE LINES SHALL BE INSTALLED PRIOR TO
- Ø BACKFILL COMP ACTION SHALL BE ACCORDING TO ARTERIAL STREET USE. TACK COAT REQUIREMENTS SHALL BE DETERMINED BY THE CITY ENGINEER. SIDEWALKS AND WHEELCHAIR RAMPS WITHIN THE CURB RETURNS SHALL BE CONSTRUCTED WHEREVER A NEW CURB RETURN IS CONSTRUCTED.
- O IF CURB IS DEPRESSED FOR A DRIVEPAD OR A HANDICAP RAMP, THE DRIVEPAD OR RAMP SHALL BE CONSTRUCTED PRIOR TO ACCEPTANCE OF THE CURB AND GUTTER.
- ALL STORM DRAINAGE FACILITIES SHALL BE COMPLETED, INSPECTED AND APPROVED PRIOR TO FINAL ACCEPTANCE.

APPROVALS	ENGINEERS	DATE	ľ
A.C.E./DESIGN	8 Montage	812498	
INSPECTOR	(
A.C.E./FIELD			

GENERAL DISCUSSION

THE EXISTING SITE IS DEVELOPED AS WITH A MULTI STORY 20,300 SF, 3 STORY BUILDING. WITH THE EXCEPTION OF THE PARKING INSLANDS NARROW STRIP OF AROUND THE BUILDING, AND THE SLOPES TO ACADEMY AND EUBANK, THE SITE IS ENTIRELY IMPERVIOUS. WESTERN WIRELESS IS PROPOSING TO CONSTRUCT A SMALL 10' X 20' DEPRESSED CONCRETE EQUIPMENT AREA IN THE SLOPE AT THE NORTHEAST CORNER OF THE SITE. ACCESS WILL BE PROVIDED VIA STEPS FROM THE PARKING LOT FOR MAINTENANCE PERSONNEL. RETAINING WALLS HAVE BEE AT THE SLAB TO MINIMIZE REGRADING OF THE EXISTING SLOPE.

PREPIOUS DRAINAGE STUDIES

PWD FILE NO. D21-28C DATED 7/31/85 WAS USED AS THE BASIS FOR EXISTING CONDITIONS.

EXISTING CONDITIONS

THE SITE PARKING AND BUILDING AREAS OF THE SITE CURRENTLY DRAIN TO AN EXISTING TYPE 'C' INLET NEAR THE NORTHEAST CORNER OF THE PARKING LOT. RUNOFF FROM THE INLET IS CONVEYED VIA A 18" STORM DRAIN TOWARD THE NORTH WHERE IT CONNECTS INTO THE BACK OF AN EXISTING INLET ON ACADEMY. THE FROM THE PARKING LOT TO BOTH ACADEMY AND EUBANK ARE STEEP TURFED SLOPES AVERAGING ABOUT 2:1.

PROPOSED CONDITIONS

AS DISCUSSED ABOVE, THE ONLY PROPOSED CHANGE IS ADDING THE CONCRETE EQUIPMENT PAD IN THE TURFED SLOPE AREA AT THE NORTHEAST CORNER OF THE PARKING LOT. THE ONLY DIVERSION OF RUNOFF FROM EXISTING CONDITIONS IS THAT DIRECT RAINFALL ON THE EQUIPMENT PAD WILL BE CONVEYED TO EUBANK VIA TWO 4" DRAIN LINES FROM AN INLET ON THE SLAB TO A SIDEWALK DRAIN THROUGH THE CURB ON EUBANK.

OFFSITE DRAINAGE

THE MAJOR CHANGE FROM THE AUGUST 1985 DRAINAGE PLAN IS THAT THE LAND EAST OF THIS SITE HAS BEEN DEVELOPED AND THE RUNOFF DIRECTED TO ACADEMY AND THE SITE TO THE SOUTH HAS DEVELOPED DIRECTION THE RUNOFF TO EUBANK. THESE TWO DEVELOPMENTS ELIMINATED THE OFFSITE RUNOFF ADDRESSED IN THE PREVIOUS DRAINAGE REPORT.

FLOOD PLAIN STATUS

AS SHOWN ON FEMA PANEL 35001C0144 D, DATED SEPT. 20, 1996 NO PORTION OF THIS SITE IS IN OR ADJACENT TO A DESIGNATED FLOODPLAIN.

DRAINAGE CALCULATIONS

THE FOLLOWING CALCULATIONS ARE BASED ON PROCEDURES DETAILED IN THE CITY OF ALBUQUERQUE DEVELOPMENT PROCESS MANUAL, SECTION 22.2, REVISED JANUARY 1993. THIS SITE IS IN ZONE 3 AS SHOWN ON FIGURE A-1.

EXISTING CONDITIONS:

ON-SITE BASIN 'A' - TO ON-SITE STORM INLET

TREATMENT TYPE	AREA (acres)	UNIT RUNOFF (cfs/ac)	MAX. Q (cfs)	UNIT VOL. (in/ac)	TOTAL VOL.
A	0.000	1.87	0.00	0.66	0
В	0.148	2.60	0.38	0.92	494
C	0.000	3.45	0.00	1.29	0
D	2.324	5.02	11.67	2.36	19,909
TOTAL AREA	2.472 ac	Q(100) =	12.05 cf	s V(100)	= 20,403 cf

 $Q(10) = 0.667 \times 12.05 = 8.03 \text{ cfs}$ $V(10) = 0.667 \times 20,403 = 13,602 \text{ cf}$

ON-SITE BASIN 'B' - TO ACADEMY STORM INLETS

TREATMENT TYPE	AREA (acres)	UNIT RUNOFF (cfs/ac)	MAX. Q (cfs)	UNIT VOL. (in/ac)	TOTAL VOL.
Α	0.000	1.87	0.00	0.66	a
В	0.000	2.60	0.00	0.92	Ö
С	0.702	3.45	2.42	1.29	3287
D	0.000	5.02	0.00	2.36	· C

TOTAL AREA 0.702 ac Q(100) = 2.42 cfs V(100) = 3287 cf $Q(10) = 0.667 \times 2.42 = 1.61 \text{ cfs}$ $V(10) = 0.667 \times 3287 = 2191 \text{ cf}$

PROPOSED CONDITIONS

ON-SITE BASIN 'A' - NO CHAANGE FROM EXISTING

ON-SITE BASIN 'B' - TO ACADEMY STORM INLETS

TREATMENT TYPE	AREA (acres)	UNIT RUNOFF (cfs/ac)	MAX. Q (cfs)	UNIT VOL. (in/ac)	TOTAL VOL.	CECETVE D
Α	0.000	1.87	0.00	0.66	[10]	AUG 1 4 1998 D
В	0.000	2.60	0.00	0.92	\ \	Z ACTION
С	0.693	3.45	2.39	1.29	3245) OGY SL
D	0.009	5.02	0.05	2.36	7/2	AUG 1 SECTION HYDROLOGY SECTION
TOTAL AREA $Q(10) = 0$	0.702 ac .667 X 2.4	Q(100) = 4 = 1.63 cfs	2.44 cfs	s V(100)	= 3322 cf	

$V(10) = 0.667 \times 3322 = 2215 \text{ cf}$

ALL WORK DETAILED ON THESE PLANS TO BE PERFORMED UNDER CONTRACT SHALL, EXCEPT AS OTHERWISE STATED OR PROVIDED FOR HEREON, BE CONSTRUCTED IN ACCORDANCE WITH THE CITY OF ALBUQUERQUE STANDARD SPECIFICATIONS FOR PUBLIC WORKS CONSTRUCTION 1986 EDITION AS

- PRIOR TO CONSTRUCTION, THE CONTRACTOR SHALL EXCAVATE AND VERIFY THE HORIZONTAL AND VERTICAL LOCATIONS OF ALL OBSTRUCTIONS. SHOULD A CONFLICT EXIST, THE CONTRACTOR SHALL NOTIFY THE ENGINEER SO THAT THE CONFLICT CAN BE RESOLVED WITH MINIMUM DELAY.
- TWO (2) WORKING DAYS PRIOR TO ANY EXCAVATION, CONTRACTOR MUST CONTACT LINE LOCATING SERVICE @ 260-1990 FOR LOCATION OF EXISTING UTILITIES.

AMENDED WITH UPDATE NO. 6.

- THE CONTRACTOR IS RESPONSIBLE FOR PROTECTING AND MAINTAINING ALL EXISTING MONUMENTATION CONTROLS. IN THE EVENT OF INADVERTENT DESTRUCTION OR ALTERATION THE CONTRACTOR MUST IMMEDIATELY NOTIFY THE CITY CHIEF SURVEYOR.
- THE CONTRACTOR SHALL PROMPTLY CLEAN UP ANY MATERIAL EXCAVATED WITHIN THE PUBLIC RIGHT-OF-WAY SO THAT THE EXCAVATED MATERIAL IS NOT SUSCEPTIBLE TO BEING WASHED OR BLOWN INTO THE STREET.
- NOTICE THE ENGINEER HAS UNDERTAKEN NO VERIFICATION OF THE EXISTENCE, LOCATION, SIZE, DEPTH, OR TYPE OF UNDERGROUND UTILITY WITHIN THE CONSTRUCTION AREA AND MAKES NO REPRESENTATION PERTAINING TO THESE UTILITIES. THE UTILITIES THAT HAVE BEEN SHOWN ARE BASED ON AVAILABLE INFORMATION FROM THE OWNER, UTILITY COMPANIES, GOVERNING AGENCY, OR OTHERS. THIS INFORMATION MAY BE INCOMPLETE, INACCURATE, OR OBSOLETE. THE CONTRACTOR SHALL CONTACT THE LINE LOCATION SERVICE AT 260-1990 AT LEAST TWO (2) FULL WORKING DAYS PRIOR TO START OF CONSTRUCTION TO HAVE THE UTILITIES SPOTTED. THE CONTRACTOR SHALL BE SOLELY RESPONSIBLE FOR MAINTAINING THE EXISTING UTILITIES THROUGHOUT THE CONSTRUCTION AND REPAIR OR REPLACEMENT OF ANY UTILITIES DAMAGED DURING CONSTRUCTION, TO THE SATISFACTION OF THE GOVERNING AUTHORITIES HAVING JURISDICTION OF THIS PROJECT.
- ALL NEW PIPE FOR CONSTRUCTION OF THE STORM DRAIN SHALL BE DUCTILE IRON WITH ELASTOMERIC GASKETED PUSH ON BELL AND SPIGOT ENDS. ALL FITTINGS SHALL BE CAST IRON.



WESTERN WIRELESS 4425 JUAN TABO N. E. SUITE 120 ALBUQUERQUE, NEW MEXICO 87111

PHONE: 505.237.8474 FAX: 505.237.8479

ACT BUILDING

DATE	
DATE	
Maria de la companya	

IRUHUE MAY KELLER MCNAMARA

SIMMS TOWER - STUDIO 1100 400 GOLD AVENUE SW ... ALBUQUERQUE NM 87102 TELE. (505)243-5454 FAX (505)243-5858 THIS DRAWING IS COPYRIGHTED AND IS

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SITE NAME

ACT BUILDING

SITE NUMBER

NM 1117-A


SITE ADDRESS

EUBANK + ACADEMY

SHEET TITLE

DRAINAGE REPORT

SHEET NUMBER

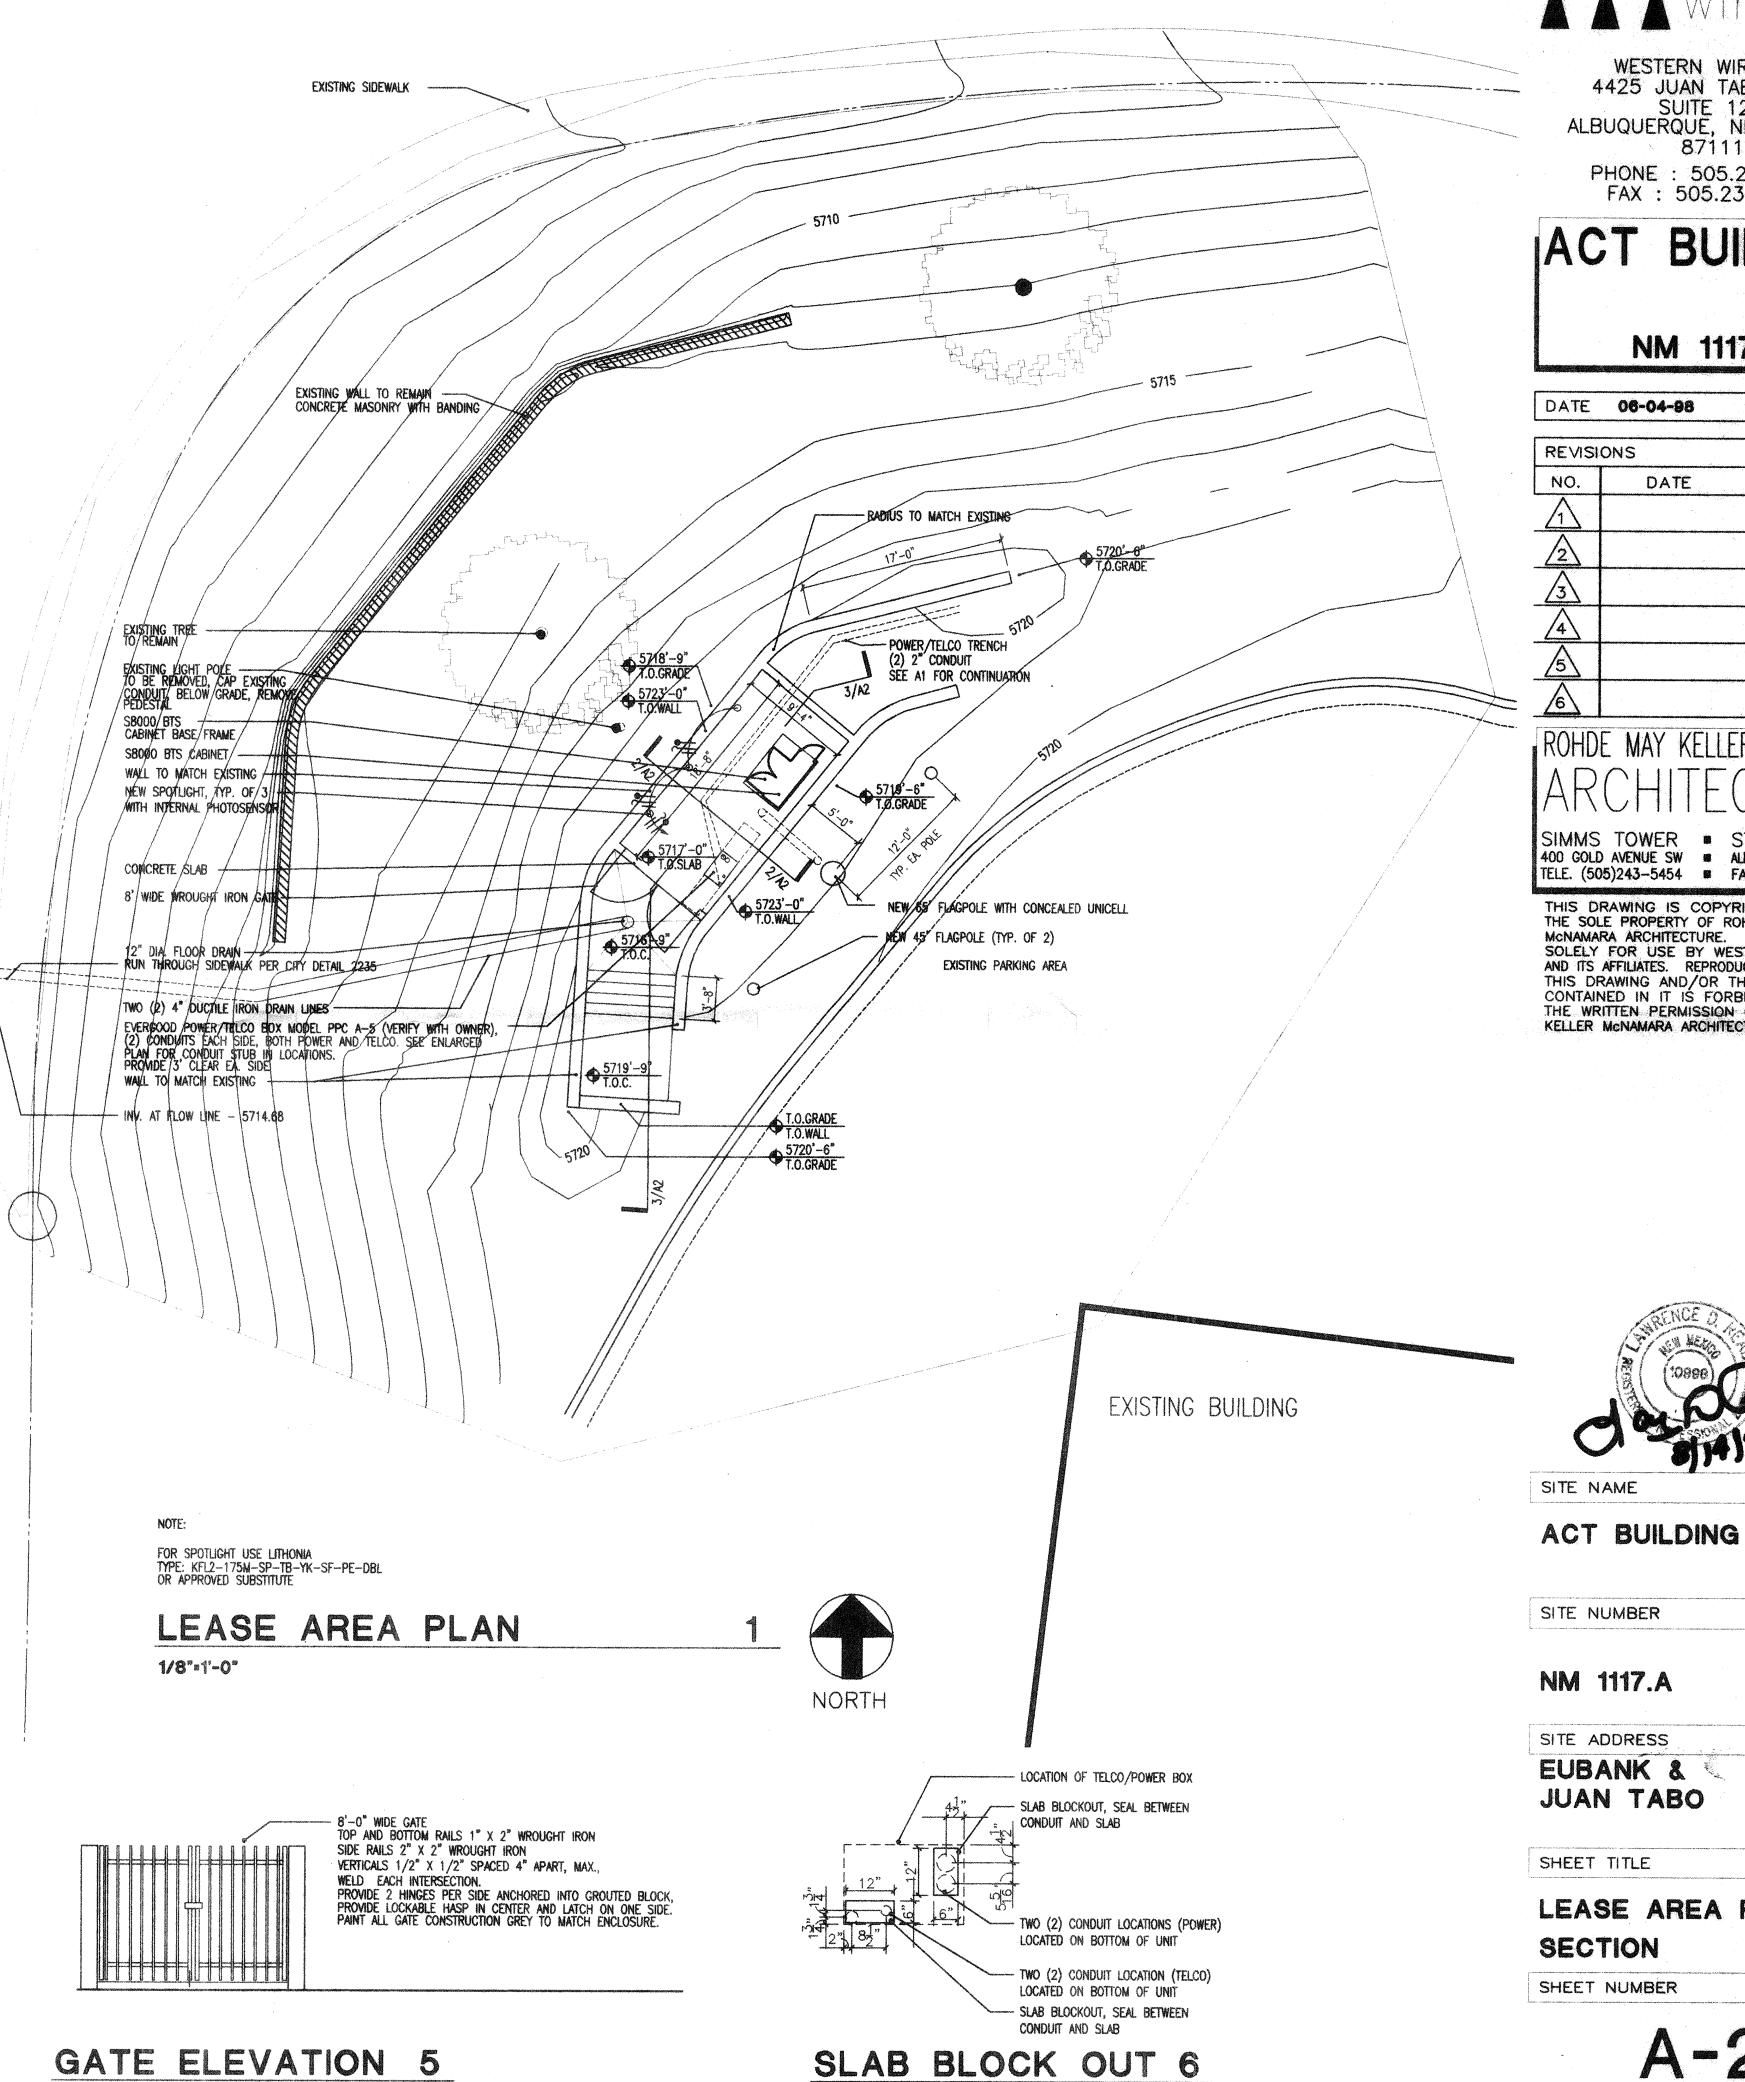

1/4"=1'-0"

WESTERN WIRELESS
4425 JUAN TABO N. E.
SUITE 120
ALBUQUERQUE, NEW MEXICO
87111

PHONE: 505.237.8474 FAX: 505.237.8479

ACT BUILDING

NM 1117.A

DATE	06-04-98		
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ROHDE MAY KELLER MCNAMARA

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LEASE AREA PLAN/

EUBANK

1/4"=1'-0"

WROUGHT IRON GATE -CONCRETE RETAINING —— WALL , FINISH TO MATCH EXISTING (SEE STRUCTURAL FOR FOOTINGS) ◆ 5723' T.O.WALL 4 TR. 0 11"EA 5719'-6" T.O.GRADE 5719'-6" FIN. GRADE CONCRETE CURB

DIRECTIONAL ANTENNA CONCEALED ON INTERIOR OF POLE AZIMUTH ORIENTATION (0°, 120°, 240° TN) VERIFY WITH RF ENGINEER PRIOR TO INSTALLATION

NEW 65' FLAGPOLE WITH INTEGRAL UNICELL TYPE ANTENNA

SITE SECTION

NEW RETAINING WALL TO MATCH - EXISTING

NEW ENCLOSURE WALL TO MATCH

8" PVC WITH COAX CABLES -

S8000 BTS CABINET 8" PVC WITH CAP DESIGNED FOR COAX

1/8"=1'-0"

6" CONCRETE SLAB, SLOPE TO

◆ 5784⁴ T.O.POLE

◆ 5720' T.O.GRADE

2

