CITY OF ALBUQUERQUE

Planning Department
Brennon Williams, Director



June 30, 2021

David Soule, P.E. Rio Grande Engineering P.O. Box 93924 Albuquerque, NM 87199

RE: 11906 San Antonio Dr. NE

Grading & Drainage Plan

Engineer's Stamp Date: 06/10/21 Hydrology File: E22D007H2

Dear Mr. Soule:

PO Box 1293


Based upon the information provided in your submittal received 06/10/2021, the Grading & Drainage Plan **is not** approved for Grading Permit. The following comments need to be addressed for approval of the above referenced project:

Albuquerque

1. Please provide the existing 65 feet PNM Easement in the front of the property. Also please show the existing overhead power lines. (See Below)

NM 87103

www.cabq.gov

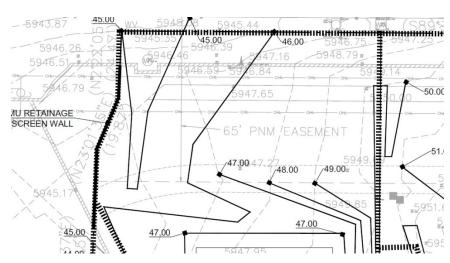


2. The house needs to be relocated out of the existing 65 feet PNM Easement. (See Below)

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Mayor Timothy M. Keller



- 3. Per the approval letter for Prichard Subdivision dated December 17, 2018 (Attached), Hydrology will need written permission from PNM for any grading within their 65 feet Easement.
- 4. Also according the approved Conceptual Grading & Drainage Plan for Prichard Subdivision (E22D007H), a retention pond is required to hold the 100yr-6hr storm. (See Below) Therefore this lot needs a retention pond volume of 657 CF.


Albuquerque

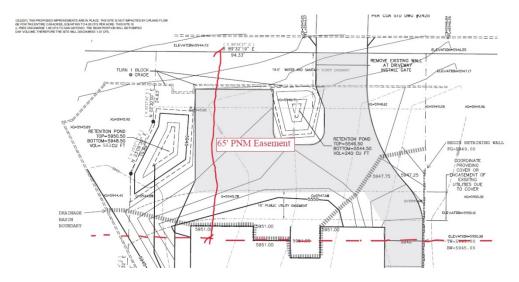PO Box 1293

NM 87103

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DRAINAGE NARRATIVE
THIS SITE IS A PREVIOUSLY APPROVED SUBDIVISION. THE PROPOSED IMPROVEMENTS ARE LESS INTENSE THAT THE PREVIOUSLY APPROVED PLAN
BASED UPON DISCUSSION WITH CITY HYDROLOGY THE SITE SHALL DIRECT ALL BUILDING ROOF DRAINAGE AND FRON AND SIDE YARDS TO SAN ANTONIO. THE REAR YARD
SHALL RETAIN THE ENTIRE 100-YEAR, 6-HOUR VOLUME GENERATED. DUE TO THE NATURE OF THE LOTS EACH LOT WILL SUBMIT A SITE SPECIFIC GRADING PLAN AT TIME O
DEVELOPMENT. EACH INDIVIDUAL PLAN SHALL CONFORM TO THIS PLAN.

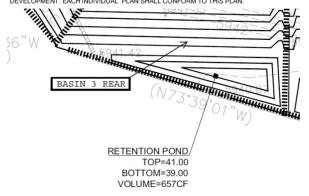


5. The proposed drainage narrative provided violated this previous approved Conceptual Grading & Drainage Plan for Prichard Subdivision. (See Below) Therefore this will have to conform with this plan.

DRAINAGE MARRATIVE
THIS SITE IS THE LAST THIS SITE IS A PREVIOUSLY APPROVED SUBDIVISION (E22D7). THE PROPOSED IMPROVEMENTS ARE IN PLACE. THE SITE IS NOT IMPACTED BY UPLAND FLOW
BY BHI (E22-D007G), THE APPROVED REPORT PROPOSDE 11.47 CFS DISCHAGE FOR THE ENTIRE 2.69 ACRES, EQUATING TO 4.26 CFS PER ACRE. THIS SITE IS
.340 ACRES THEREFORE CAN DISCHARGE 1.44 CFS. THE DEVELOPMENT WILL FREE DISCHARGE 1.69 CFS TO SAN ANTONIO. THE REAR PORTION WILL BE PUMPED
TO A POND IN THE FRONT. THE POND IS SIZED TO RETAIN THE 100-YEAR 10 DAY VOLUME, THEREFORE THE SITE WILL DISCHARGE 1.07 CFS.

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Standard review fee of \$75 will be required at the time of resubmittal.

If you have any questions, please contact me at 924-3995 or rbrissette@cabq.gov.

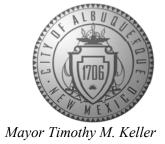Sincerely,

Renée C. Brissette, P.E. CFM Senior Engineer, Hydrology Planning Department

Renée C. Brissette

PO Box 1293

Albuquerque

NM 87103

www.cabq.gov




City of Albuquerque

Planning Department

Development & Building Services Division

DRAINAGE AND TRANSPORTATION INFORMATION SHEET (REV 6/2018)


Project Title: 11906 SAN ANTONIO	Building Permit #:	Hydrology File #:
DRB#:	EPC#:	Work Order#:
DRB#:LOT C-2-A-1 SAU	JVIGNON SUBDIVISION	
City Address: 11906 SAN ANTONIO		
Applicant: MR. BARNSLEY		Contact:
Address:		
Phone#:	_ Fax#:	_E-mail:
Other Contact: RIO GRANDE ENGINE Address: PO BOX 93924 ALB NM		_Contact: _DAVID SOULE
Phone#: 505.321.9099	Fax#: ^{505.872.0999}	E-mail: david@riograndeengineering.com
TYPE OF DEVELOPMENT: PLAT		
Check all that Apply:		
DEPARTMENT: X HYDROLOGY/ DRAINAGE TRAFFIC/ TRANSPORTATION	TYPE OF APPROV. <u>×</u> BUILDING PER CERTIFICATE	
TYPE OF SUBMITTAL: ENGINEER/ARCHITECT CERTIFICATION PAD CERTIFICATION CONCEPTUAL G & D PLAN GRADING PLAN DRAINAGE REPORT DRAINAGE MASTER PLAN FLOODPLAIN DEVELOPMENT PERMIT A ELEVATION CERTIFICATE CLOMR/LOMR TRAFFIC CIRCULATION LAYOUT (TCL) TRAFFIC IMPACT STUDY (TIS)	SITE PLAN FO SITE PLAN FO SITE PLAN FO FINAL PLAT A SIA/ RELEASE APPLIC FOUNDATION GRADING PER SO-19 APPROV PAVING PERM	OF FINANCIAL GUARANTEE PERMIT APPROVAL RMIT APPROVAL VAL
STREET LIGHT LAYOUT OTHER (SPECIFY) PRE-DESIGN MEETING? IS THIS A RESUBMITTAL?: YesX _ N	WORK ORDER A CLOMR/LOMR FLOODPLAIN I OTHER (SPECI	APPROVAL
DATE SUBMITTED:		
COA STAFF:	ELECTRONIC SUBMITTAL RECEIVED:	

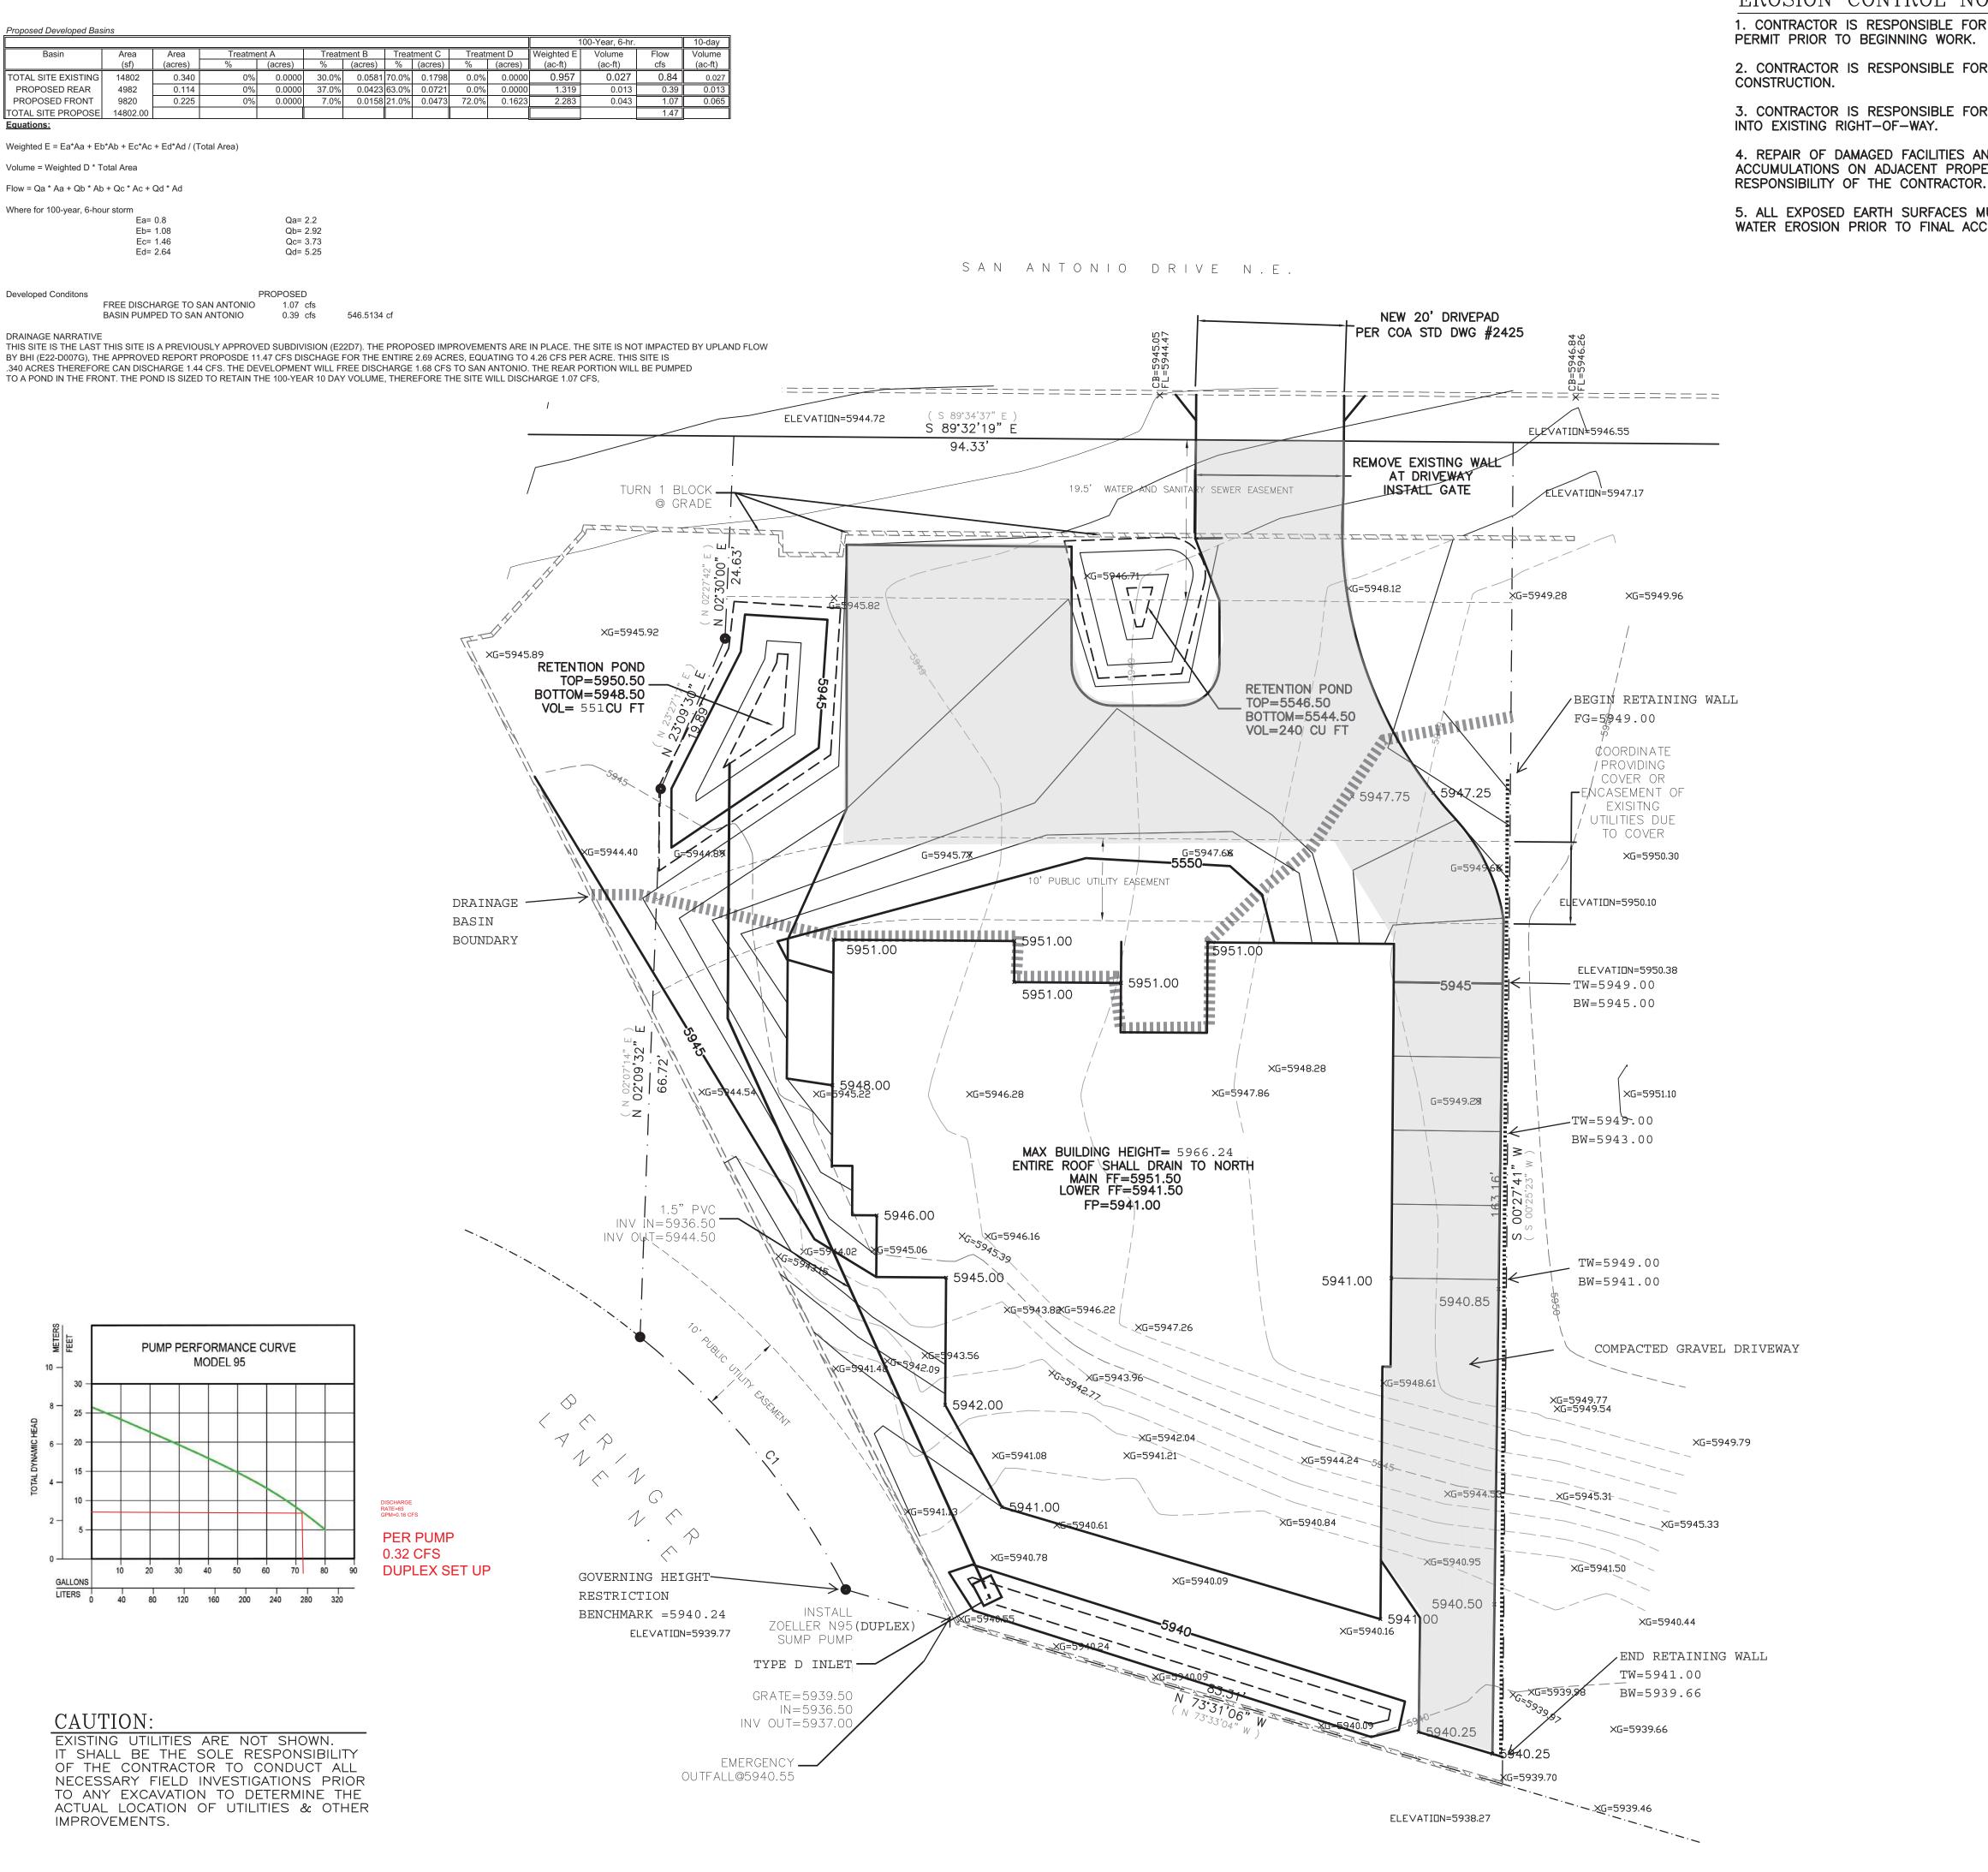

Weighted E Method

EROSION CONTROL NOTES:

- 1. CONTRACTOR IS RESPONSIBLE FOR OBTAINING A TOPSOIL DISTURBANCE PERMIT PRIOR TO BEGINNING WORK.
- 2. CONTRACTOR IS RESPONSIBLE FOR MAINTAINING RUN-OFF ON SITE DURING
- 3. CONTRACTOR IS RESPONSIBLE FOR CLEANING ALL SEDIMENT THAT GETS
- 4. REPAIR OF DAMAGED FACILITIES AND CLEANUP OF SEDIMENT ACCUMULATIONS ON ADJACENT PROPERTIES AND IN PUBLIC FACILITIES IS THE
- 5. ALL EXPOSED EARTH SURFACES MUST BE PROTECTED FROM WIND AND WATER EROSION PRIOR TO FINAL ACCEPTANCE OF ANY PROJECT.

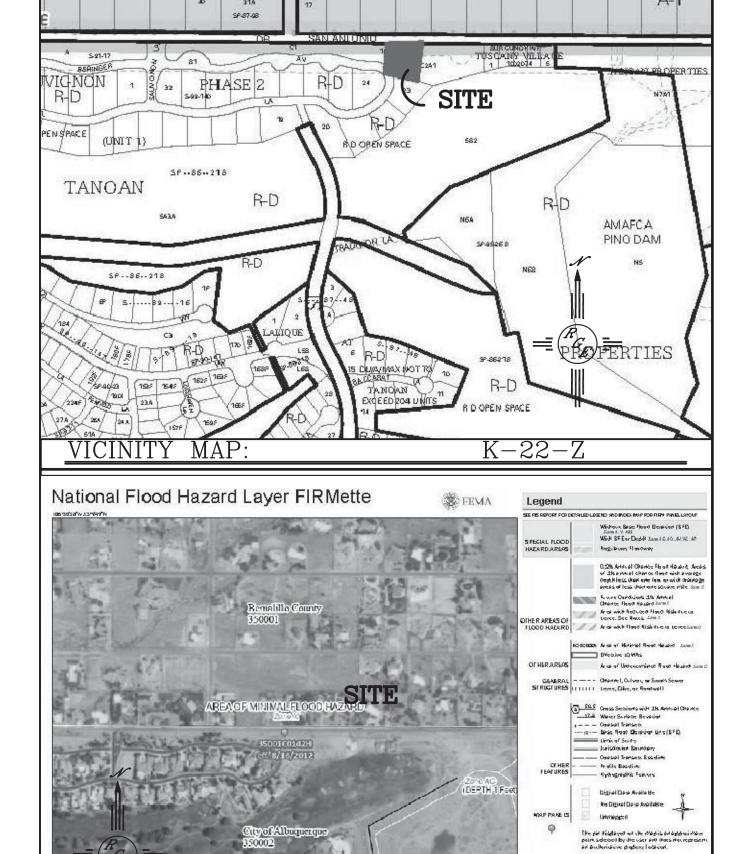

LEGAL DESCRIPTION:

TRACT C-2-A-1-A, SAUVIGNON SUBDIVISION

FIRM MAP:

1. ALL SPOT ELEVATIONS REPRESENT FLOWLINE ELEVATION UNLESS OTHERWISE

2,000 Easemap: USGS National Map: Ortholmagery: Data refreshed October, 2020


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2. ALL SLOPES SHALL BE 3:1 MAX. AND GRAVEL OR NATIVE SEEDING PRIOR TO CO.

LEGEND

	EXISTING CONTOUR
	EXISTING INDEX CONTOUR
XXXX	PROPOSED CONTOUR
	PROPOSED INDEX CONTOUR
—	SLOPE TIE
× XXXX	EXISTING SPOT ELEVATION
* XXXX	PROPOSED SPOT ELEVATION
	LOT LINE
	CENTERLINE
	RIGHT-OF-WAY
	PROPOSED 4" PVC SD
	GRAVEL LINED SWALE
==========	EXISTING CURB AND GUTTER



TRACT C-2-A-1-A	DRAWN BY _{WCWJ}
SAUVIGNON SUBDIVISION	DATE 5-21-21
GRADING AND DRAINAGE PLAN	210210054—LAYOUT—
Rio Grande	SHEET #

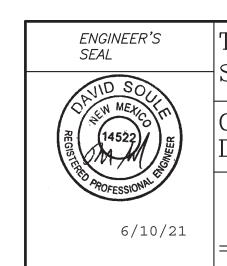Lingineering 1606 CENTRAL AVENUE SE JOB # ALBUQUERQUE, NM 87106 (505) 872-0999 21021054

DAVID SOULE P.E. #14522

SCALE: 1"=10'