
CITY OF ALBUQUERQUE

Planning Department Alan Varela, Director

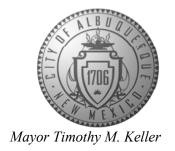

June 29, 2023

Fred C. Arfman, P.E. Isaacson & Arfman, P.A. 128 Monroe St. N.E Albuquerque, NM 87108

RE: 13600 Quaking Aspen Pl NE

Grading & Drainage Plans Engineer's Stamp Date: 06/08/23 Hydrology File: E23D003C2

Dear Mr. Arfman:

PO Box 1293

Based upon the information provided in your submittal received 06/09/2023, the Grading and Drainage Plan is approved for Building Permit and Grading Permit. Since this site has stim walls, a pad certification is not needed for this project. Please attach a copy of this approved plan in the construction sets for Building Permit processing along with a copy of this letter.

Albuquerque

PRIOR TO CERTIFICATE OF OCCUPANCY:

NM 87103

1. Engineer's Certification, per the DPM Part 6-14 (F): Engineer's Certification Checklist For Non-Subdivision is required.

If you have any questions, please contact me at 924-3995 or rbrissette@cabq.gov.

www.cabq.gov

Sincerely,

Renée C. Brissette, P.E. CFM Senior Engineer, Hydrology Planning Department

Renée C. Brissette




City of Albuquerque

Planning Department

Development & Building Services Division

DRAINAGE AND TRANSPORTATION INFORMATION SHEET

13600 Quaking Aspen PI NE Project Title: Lot 38, Desert Highlands Building	Permit # Hydrology File # E23 & 24	
DRB#	EPC#	
	City Address OR Parcel <u>1024062037398203</u> 03	
Applicant/Agent: Isaacson & Arfman, Inc.	Contact: Fred C. Arfman & Bryan J. Brobrick	
Address: 128 Monroe Street NE	Phone: (505) 268-8828	
Email: freda@iacivil.com or bryanb@iacivil.com		
Applicant/Owner:	Contact:	
Address:	Phone:	
Email:		
TYPE OF DEVELOPMENT:PLAT (#of lots)RE RE-SUBMITTAL:YESX_NO	SIDENCE XDRB SITE ADMIN SITE:	
DEPARTMENT: TRANSPORTATIONXCheck all that apply:	HYDROLOGY/DRAINAGE	
TYPE OF SUBMITTAL: TYPE	OF APPROVAL/ACCEPTANCE SOUGHT:	
ENGINEER/ARCHITECT CERTIFICATION	X BUILDING PERMIT APPROVAL	
PAD CERTIFICATION	CERTIFICATE OF OCCUPANCY	
CONCEPTUAL G&D PLAN	CONCEPTUAL TCL DRB APPROVAL	
X GRADING PLAN	PRELIMINARY PLAT APPROVAL	
DRAINAGE REPORT	SITE PLAN FOR SUB'D APPROVAL	
DRAINAGE MASTER PLAN	SITE PLAN FOR BLDG PERMIT APPROVAL	
FLOOD PLAN DEVELOPMENT PERMIT APP.	FINAL PLAT APPROVAL	
ELEVATION CERTIFICATE	SIA/RELEASE OF FINANCIAL GUARANTEE	
CLOMR/LOMR	FOUNDATION PERMIT APPROVAL	
TRAFFIC CIRCULATION LAYOUT (TCL)	GRADING PERMIT APPROVAL	
ADMINISTRATIVE	SO-19 APPROVAL	
TRAFFIC CIRCULATION LAYOUT FOR DRB	PAVING PERMIT APPROVAL	
APPROVAL	GRADING PAD CERTIFICATION	
TRAFFIC IMPACT STUDY (TIS)	WORK ORDER APPROVAL	
STREET LIGHT LAYOUT	CLOMR/LOMR	
OTHER (SPECIFY)	FLOOD PLAN DEVELOPMENT PERMIT	
PRE-DESIGN MEETING?	OTHER (SPECIFY)	
DATE SUBMITTED:June 8, 2023		

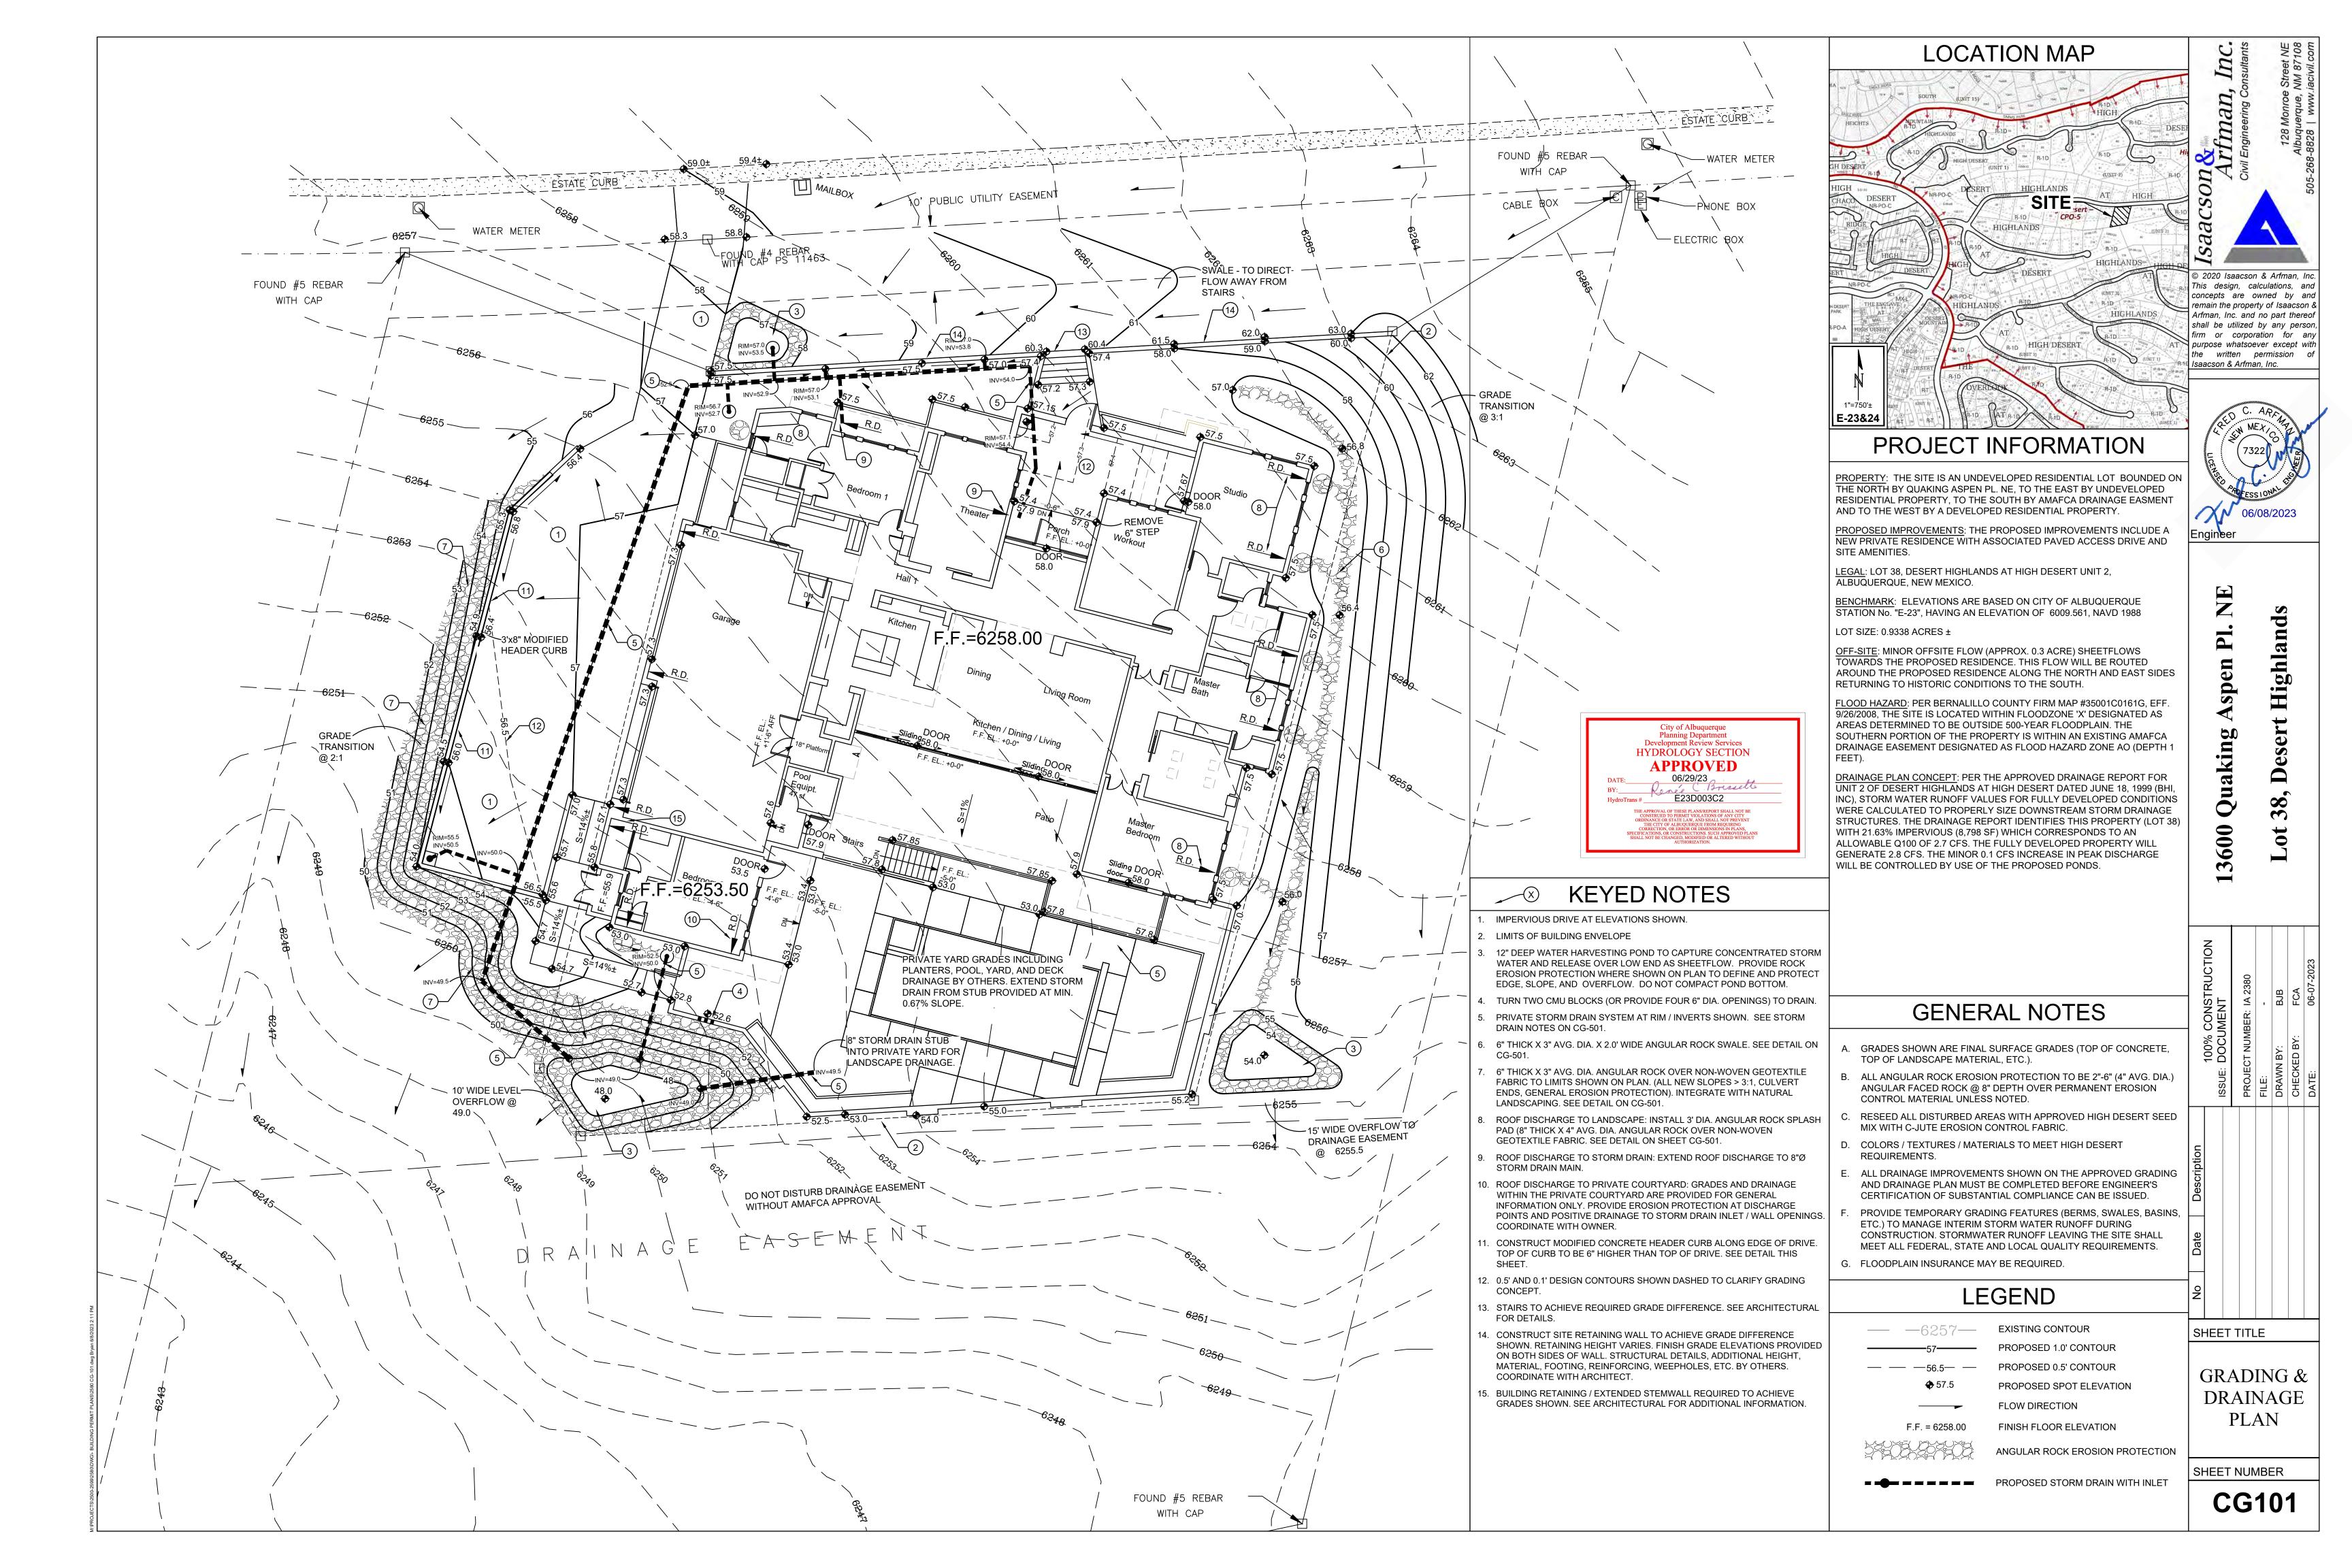

	Weighted E =	$\frac{E_AA_A + E_BA_B + E_CA_C + E_DA_D}{A_A + A_B + A_C + A_D}$
10.50		

1.51 in. Allowable E = 1.37 in. Developed E = On-Site Volume of Runoff: V360 = E*A / 12

4651 CF Developed V₃₆₀

2.7 CFS Developed Q_p

On-Site Peak Discharge Rate: $Qp = Q_{pA}A_A + Q_{pB}A_B + Q_{pC}A_C + Q_{pD}A_D / 43,560$

For Precipitation Zone 4

Allowable $V_{360} =$


Allowable Q_p =

 $Q_{pA} = 2.09$ $Q_{pC} = 3.41$ $Q_{pD} = 4.78$ $Q_{pB} = 2.73$

> Planning Department
> Development Review Services HYDROLOGY SECTION **APPROVED** DATE: 06/29/23
> BY: Briselle
> HydroTrans # E23D003C2

5103 CF

2.8 CFS

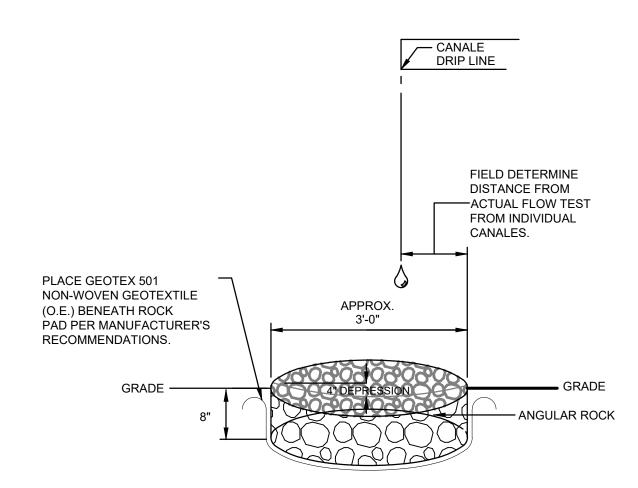

A. INSTALL ALL STORM DRAIN INLETS AND PIPE PER MANUFACTURER'S SPECIFICATIONS.


- B. EACH PROPOSED INLET TO CONSIST OF AN ADS NYLOPLAST INLINE DRAIN WITH 6" OUTLET. INLETS WITHIN LANDSCAPE TO HAVE 8" DIA. DOME GRATE. INLET IN PAVEMENT TO HAVE 12" SQUARE GRATE. EXTEND 6" ADS PIPE AND CONNECT TO PROPOSED STORM DRAIN MAIN LINE USING ADS N12WT (WT=WATERTIGHT) TEES AND BENDS OR ADS INSERTA-TEE.
- C. ALL STORM DRAIN LINES AND FITTINGS TO BE ADS N-12WT WATERTIGHT.
- D. MINIMUM SLOPE = 1.0% UNLESS NOTED.
- E. STORM DRAIN SYSTEM WILL REQUIRE REGULAR MAINTENANCE TO ENSURE PROPER FUNCTIONING DURING STORM EVENTS. ENGINEER RECOMMENDS THAT PROPERTY OWNER PUT IN PLACE INSPECTION AND MAINTENANCE CRITERIA SCHEDULED TO OCCUR MONTHLY AND AFTER EACH STORM EVENT.

STORM DRAIN NOTES

SCALE: N.T.S.

ANGULAR ROCK SPLASH PAD

SCALE: N.T.S.

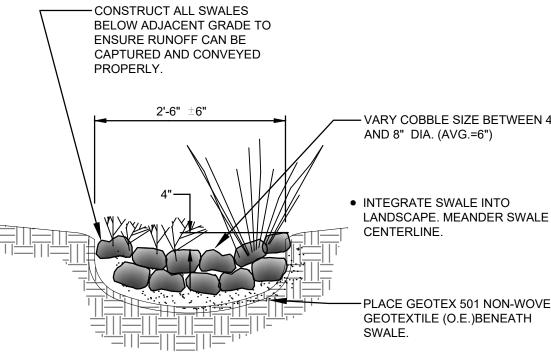


- VARY COBBLE SIZE BETWEEN 4" LANDSCAPE. MEANDER SWALE

PLACE GEOTEX 501 NON-WOVEN

ANGULAR ROCK SWALE


- 1. 4" AVERAGE DIAMETER ANGULAR ROCK (VARY BETWEEN 2" AND 6" DIAMETER
- 2. PLACE GEOTEX 501 NON-WOVEN GEOTEXTILE (O.E.) BENEATH ALL EROSION PROTECTION
- 3. INSTALL ALL EROSION PROTECTION FLUSH WITH ADJACENT GRADE TO ENSURE RUNOFF CAN BE CAPTURED AND CONVEYED PROPERLY.

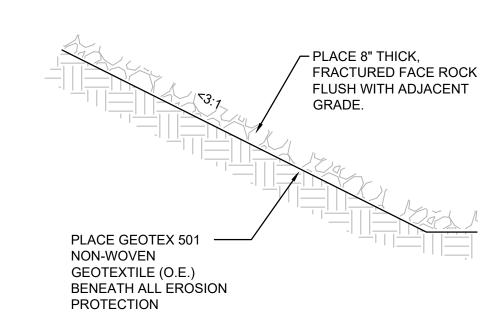

SLOPE EROSION PROTECTION

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Highlands 13600

esert

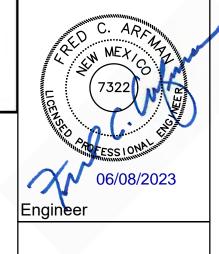Lot

SHEET TITLE

CIVIL **DETAILS**

SHEET NUMBER

CG501

MODIFIED HEADER CURB

TRANSITION TO EXISTING @ 2:1

WITH SLOPE ARMORING

COMPACTED SUBGRADE

SCALE: N.T.S.

SCALE: N.T.S.