CITY OF ALBUQUERQUE



Planning Department Transportation Development Services

October 8, 2015

Marie Holloway Cherry See Reames Architects 220 Gold Ave., SW Albuquerque, NM 87102

Re:

Chaparral Elementary School

6325 Milne Rd., NW

Certificate of Occupancy – Transportation Development Engineer's/Architect's Stamp dated 6-12-13 (F10-D005)

Certification dated 9-24-15

Dear Ms. Holloway,

PO Box 1293

Based upon the information provided in your submittal received 9-25-15, Transportation Development has no objection to the issuance of a <u>Permanent Certificate of Occupancy</u>. This letter serves as a "green tag" from Transportation Development for a <u>Permanent Certificate of Occupancy</u> to be issued by the Building and Safety Division.

Albuquerque

If you have any questions, please contact Gary Sandoval at (505) 924-3675 or me at (505) 924-3991.

New Mexico 87103

Sincerely,

www.cabq.gov

Racquel M. Michel, P.E.

Traffic Engineer, Planning Dept. Development Review Services

\gs

via: email

Č:

CO Clerk, File



City of Albuquerque

Planning Department

Development & Building Services Division

DRAINAGE AND TRANSPORTATION INFORMATION SHEET (REV 09/2015)

| DRB#: not applicable EPC#: not applicable | Building Permit #: 2014-92151 City Drainage #: FO D |
|--|--|
| Legal Description: Lot B - Chaparral Elementary School subdivision | |
| City Address: 6325 Milne Road NW; Albuquerque, NM 87120 | |
| Engineering Firm: | Contact: |
| Address: | Contact |
| Phone#: Fax#: | E-mail: |
| | _ |
| Owner: Albuquerque Public Schools | Contact: |
| Address: 915 Oak Street SE; Albuquerque NM 87106 | E-mail: ritchey_d@aps.edu |
| Phone#: 848-8876 Fax#: 246-9020 | E-mail: michey_u@aps.edu |
| Architect: Cherry See Reames Architects | Contact: Marie Holloway |
| Address: 220 Gold Avenue SW; Albuquerque NM 87102 | |
| Phone#: 842-1278 Fax#: 766-9269 | E-mail: msholloway@cherryseereames.com |
| Other Contact: Thompson Construction | Contact: Dennis Thompson |
| Address: 8200 Venice NE; Albuquerque NM 87122 | or Zach Thompson zach@tci-nm.com |
| Phone#: 823-1218 Fax#: 856-1375 | E-mail: dennis@tci-nm.com |
| | CHECK TYPE OF APPROVAL/ACCEPTANCE SOUGHT: BUILDING PERMIT APPROVAL CERTIFICATE OF OCCUPANCY |
| TRAFFIC/ TRANSPORTATION MS4/ EROSION & SEDIMENT CONTROL TYPE OF SUBMITTAL: | BUILDING PERMIT APPROVAL CERTIFICATE OF OCCUPANCY PRELIMINARY PLAT APPROVAL |
| DEPARTMENT: HYDROLOGY/ DRAINAGE TRAFFIC/ TRANSPORTATION MS4/ EROSION & SEDIMENT CONTROL TYPE OF SUBMITTAL: ENGINEER/ ARCHITECT CERTIFICATION CONCEPTUAL G & D PLAN GRADING PLAN DRAINAGE MASTER PLAN DRAINAGE REPORT | BUILDING PERMIT APPROVAL CERTIFICATE OF OCCUPANCY PRELIMINARY PLAT APPROVAL SITE PLAN FOR SUB'D APPROVAL SITE PLAN FOR BLDG. PERMIT APPROVAL FINAL PLAT APPROVAL SIA/ RELEASE OF FINANCIAL GUARANTEE FOUNDATION PERMIT APPROVAL GRADING PERMIT APPROVAL |
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| DEPARTMENT: HYDROLOGY/ DRAINAGE TRAFFIC/ TRANSPORTATION MS4/ EROSION & SEDIMENT CONTROL TYPE OF SUBMITTAL: ENGINEER/ ARCHITECT CERTIFICATION CONCEPTUAL G & D PLAN GRADING PLAN DRAINAGE MASTER PLAN DRAINAGE MASTER PLAN DRAINAGE REPORT CLOMR/LOMR TRAFFIC CIRCULATION LAYOUT (TEL) TRAFFIC IMPACT STUDY (TIS) EROSION & SEDIMENT CONTROL PLAN (ESC) | BUILDING PERMIT APPROVAL CERTIFICATE OF OCCUPANCY PRELIMINARY PLAT APPROVAL SITE PLAN FOR SUB'D APPROVAL SITE PLAN FOR BLDG. PERMIT APPROVAL FINAL PLAT APPROVAL SIA/ RELEASE OF FINANCIAL GUARANTEE FOUNDATION PERMIT APPROVAL GRADING PERMIT APPROVAL SO-19 APPROVAL PAVING PERMIT APPROVAL GRADING/ PAD CERTIFICATION WORK ORDER APPROVAL CLOMR/LOMR PRE-DESIGN MEETING |

TRAFFIC CERTIFICATION

I, TINA REAMES, NEW MEXICO REGISTERED ARCHITECT, OF THE FIRM CHERRY SEE REAMES ARCHITECTS P.C., HEREBY CERTIFY THAT THIS PROJECT IS IN SUBSTANTIAL COMPLIANCE WITH AND IN ACCORDANCE WITH THE DESIGN INTENT OF THE APPROVED PLAN DATED 6-12-2013. THE RECORD INFORMATION EDITED ONTO THE ORIGINAL DESIGN DOCUMENT HAS BEEN OBTAINED BY TINA REAMES OF THE FIRM CHERRY SEE REAMES ARCHITECTS P.C.

I FURTHER CERTIFY THAT I HAVE PERSONALLY VISITED THE PROJECT SITE ON SEPTEMBER 24, 2015 AND HAVE DETERMINED BY VISUAL INSPECTION THAT THE SURVEY DATA PROVIDED IS REPRESENTATIVE OF ACTUAL SITE CONDITIONS AND IS TRUE AND CORRECT TO THE BEST OF MY KNOWLEDGE AND BELIEF. THIS CERTIFICATION IS SUBMITTED IN SUPPORT OF A REQUEST FOR A CERTIFICATE OF OCCUPANCY.


<LIST EXCEPTIONS, IF ANY>

- NO STRIPING AT CAFETERIA DELIVERY.
- ASI#105 REV2 PLAYGROUND MODIFICATIONS

THE RECORD INFORMATION PRESENTED HEREON IS NOT NECESSARILY COMPLETE AND INTENDED ONLY TO VERIFY SUBSTANTIAL COMPLIANCE OF THE TRAFFIC ASPECTS OF THIS PROJECT. THOSE RELYING ON THE RECORD DOCUMENT ARE ADVISED TO OBTAIN INDEPENDENT VERIFICATION OF ITS ACCURACY BEFORE USING IT FOR ANY OTHER PURPOSE.

Signature of Engineer or Architect

Date

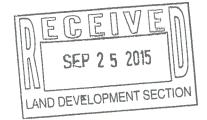



City of Albuquerque

Planning Department

Development & Building Services Division

DRAINAGE AND TRANSPORTATION INFORMATION SHEET (REV 09/2015)

| Project Title: | Building Permit #: City Drainage #: | | |
|--|---|----|--|
| DRB#: EPC#: | | | |
| Legal Description: | | | |
| City Address: | | | |
| Engineering Firm: | Contact: | | |
| Address: | | | |
| Phone#: Fax#: | E-mail: | | |
| Owner: | Contact: | | |
| Address: | | | |
| | E-mail: | | |
| Architect: | Contact: | | |
| Address: | | | |
| Phone#: Fax#: | E-mail: | | |
| Other Contact: | Contact: | | |
| Address: | | | |
| Phone#: Fax#: | E-mail: | | |
| DEPARTMENT: HYDROLOGY/ DRAINAGE TRAFFIC/ TRANSPORTATION MS4/ EROSION & SEDIMENT CONTROL | CHECK TYPE OF APPROVAL/ACCEPTANCE SOUGH BUILDING PERMIT APPROVAL CERTIFICATE OF OCCUPANCY | T: | |
| | | | |
| TYPE OF SUBMITTAL: ENGINEER/ ARCHITECT CERTIFICATION | PRELIMINARY PLAT APPROVAL | | |
| ENGINEER ARCHITECT CERTIFICATION | SITE PLAN FOR SUB'D APPROVAL | | |
| CONCEPTUAL G & D PLAN | SITE PLAN FOR BLDG. PERMIT APPROVAL | | |
| GRADING PLAN | FINAL PLAT APPROVAL SIA/ RELEASE OF FINANCIAL GUARANTEE | | |
| DRAINAGE MASTER PLAN | FOUNDATION PERMIT APPROVAL | | |
| DRAINAGE REPORT | GRADING PERMIT APPROVAL | | |
| CLOMR/LOMR | SO-19 APPROVAL | | |
| | PAVING PERMIT APPROVAL | | |
| TRAFFIC CIRCULATION LAYOUT (TCL) | GRADING/ PAD CERTIFICATION | | |
| TRAFFIC IMPACT STUDY (TIS) | WORK ORDER APPROVAL | | |
| EROSION & SEDIMENT CONTROL PLAN (ESC) | CLOMR/LOMR | | |
| OTHER (SPECIFY) | PRE-DESIGN MEETING | | |
| | OTHER (SPECIFY) | | |
| IS THIS A RESUBMITTAL?:YesNo | | | |
| DATE SUBMITTED:By: | | | |
| | | | |

COA STAFF: ELECTRONIC SUBMITTAL RECEIVED: ____

TRAFFIC CERTIFICATION

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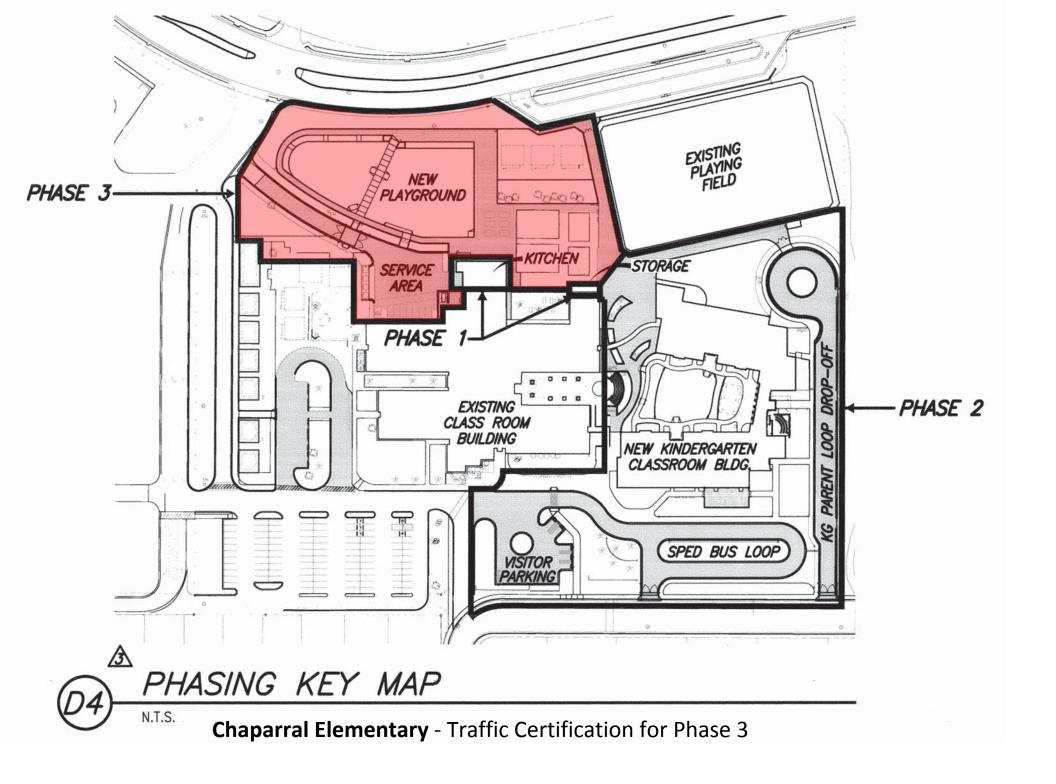
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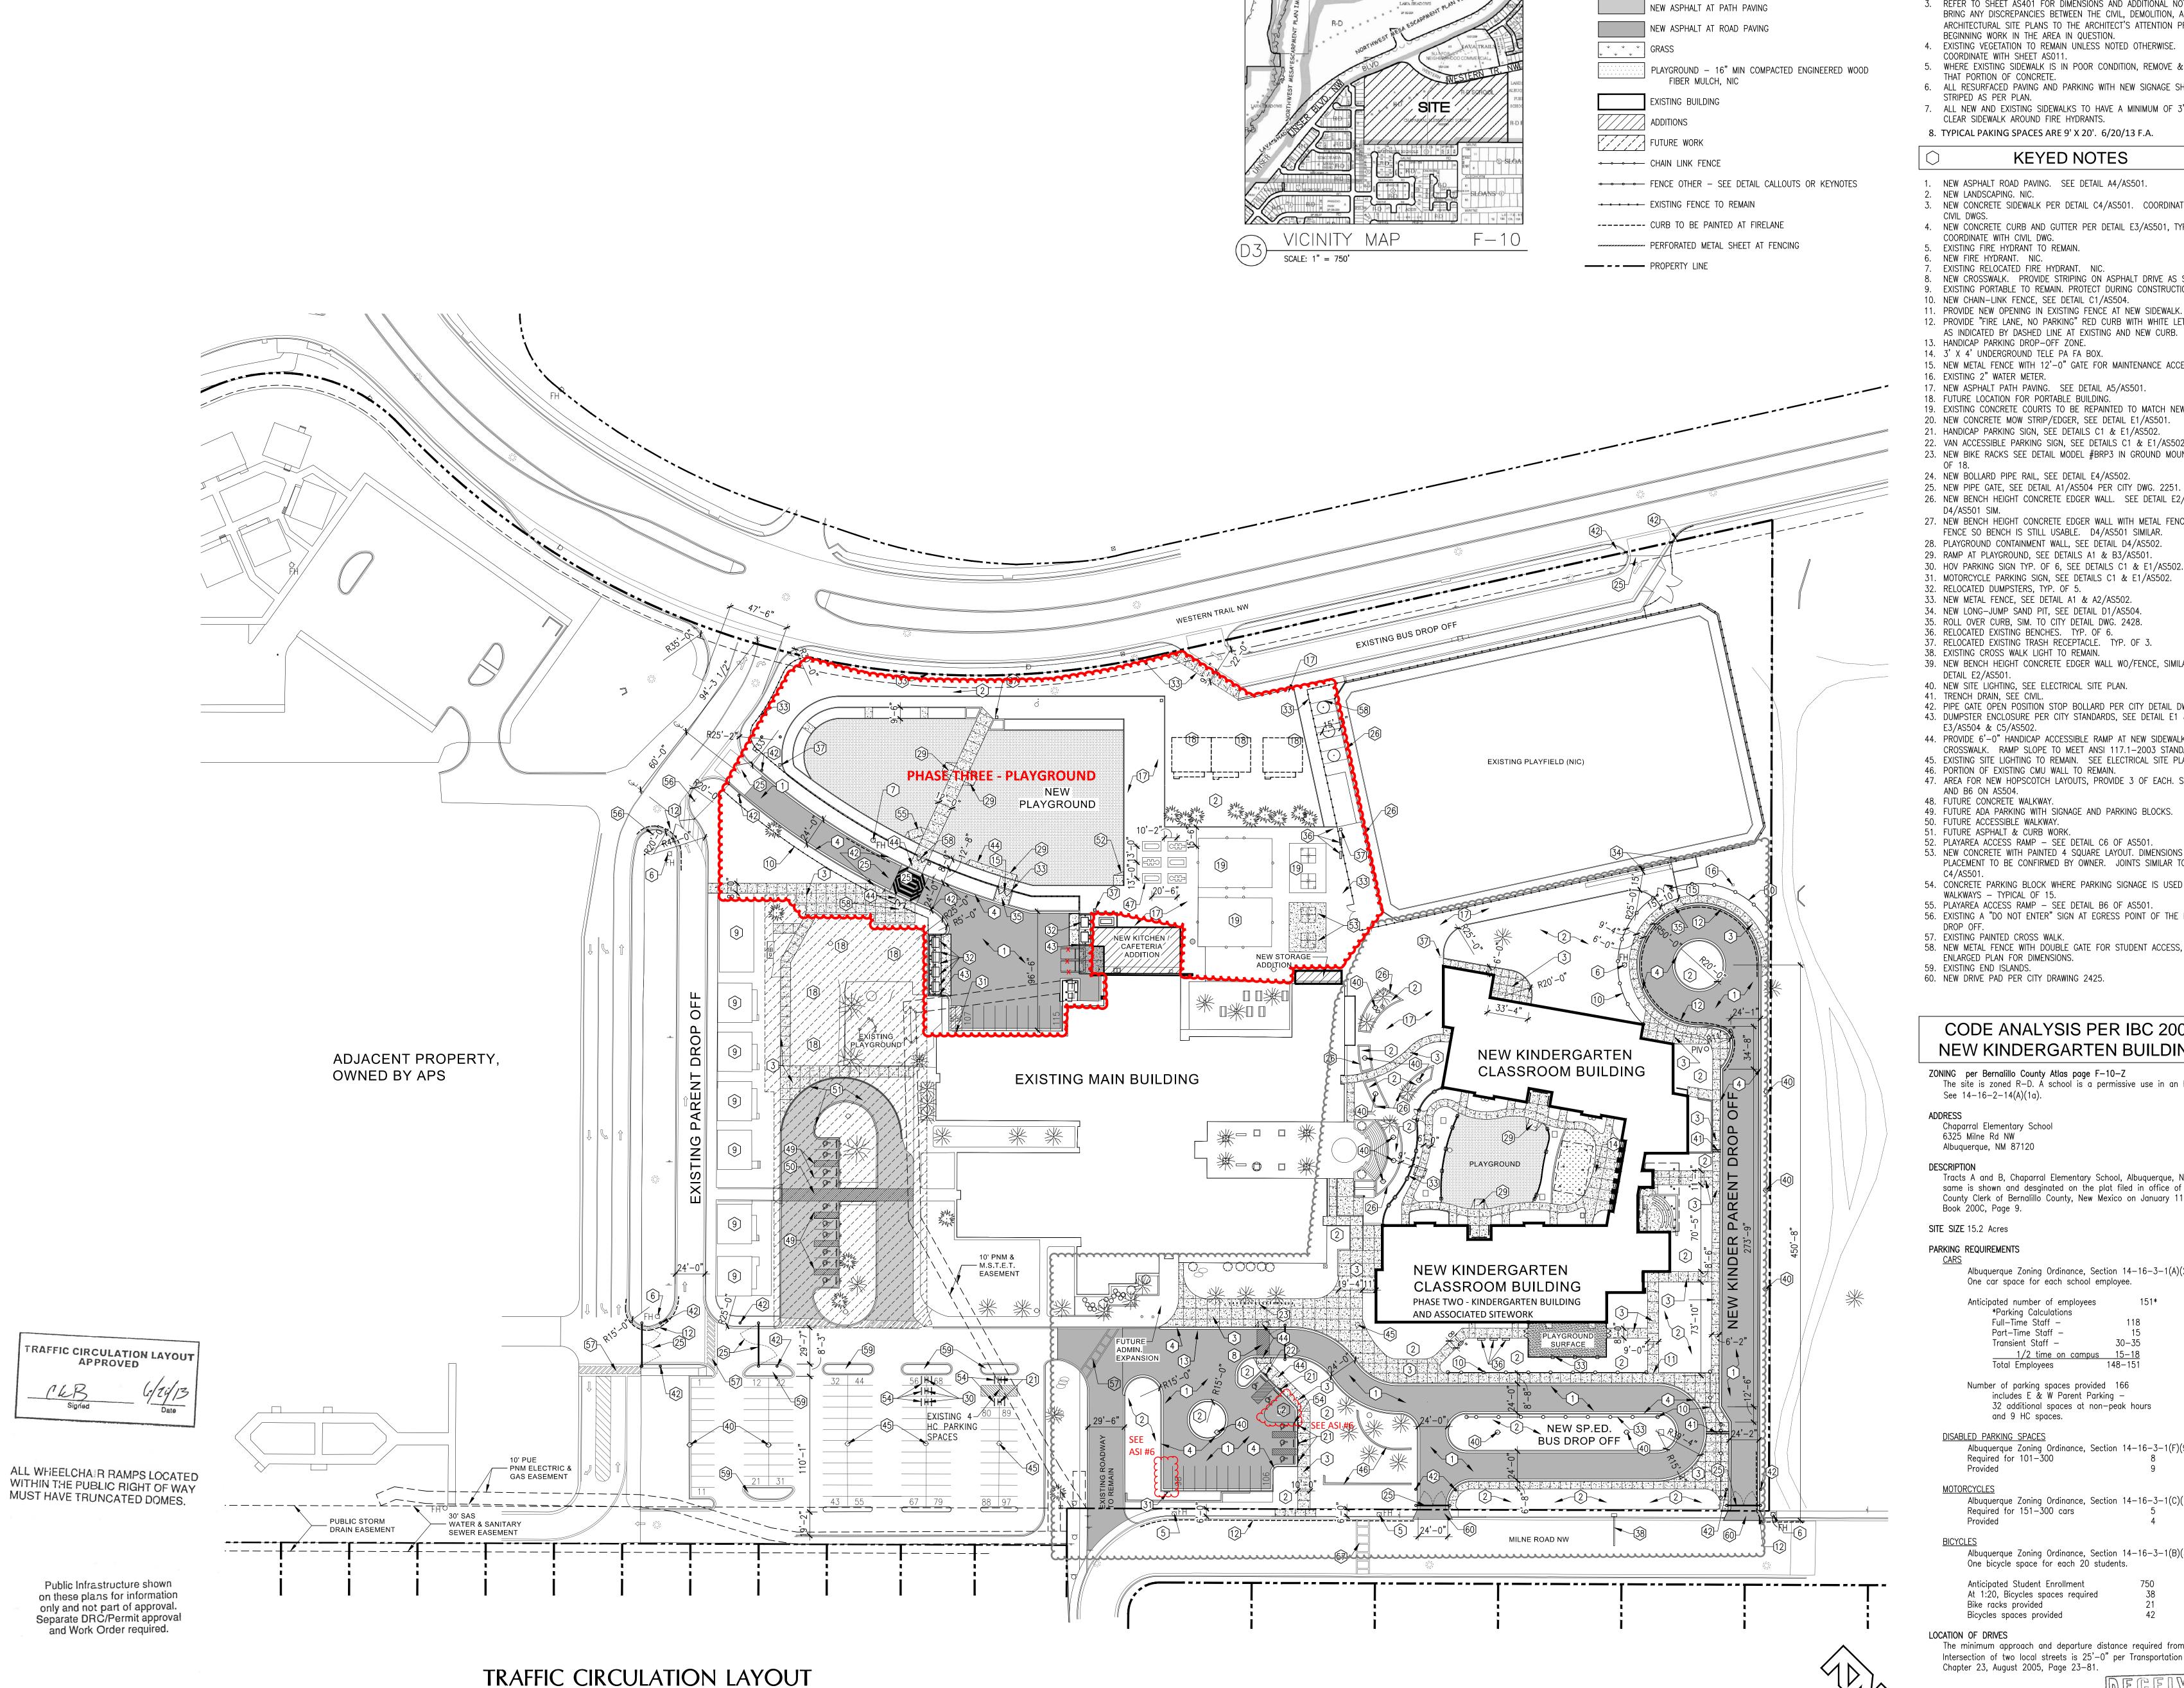
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Signature of Engineer or Architect

Date





APPROVED

WITHIN THE PUBLIC RIGHT OF WAY

Public Infrastructure shown

on these plans for information

only and not part of approval. Separate DRC/Permit approval

and Work Order required.

MUST HAVE TRUNCATED DOMES.

GENERAL SHEET NOTES

REFER TO SHEET A001 FOR GENERAL ARCHITECTURAL INFORMATION. REFER TO SHEET AS102 FOR SITE DIMENSIONS. REFER TO SHEET AS401 FOR DIMENSIONS AND ADDITIONAL NOTES. BRING ANY DISCREPANCIES BETWEEN THE CIVIL, DEMOLITION, AND ARCHITECTURAL SITE PLANS TO THE ARCHITECT'S ATTENTION PRIOR TO

BEGINNING WORK IN THE AREA IN QUESTION. 4. EXISTING VEGETATION TO REMAIN UNLESS NOTED OTHERWISE. COORDINATE WITH SHEET ASO11.

WHERE EXISTING SIDEWALK IS IN POOR CONDITION, REMOVE & REPLACE THAT PORTION OF CONCRETE. 6. ALL RESURFACED PAVING AND PARKING WITH NEW SIGNAGE SHALL BE STRIPED AS PER PLAN.

7. ALL NEW AND EXISTING SIDEWALKS TO HAVE A MINIMUM OF 3'-0" MIN CLEAR SIDEWALK AROUND FIRE HYDRANTS. 8. TYPICAL PAKING SPACES ARE 9' X 20'. 6/20/13 F.A.

KEYED NOTES

NEW ASPHALT ROAD PAVING. SEE DETAIL A4/AS501.

NEW LANDSCAPING. NIC. 3. NEW CONCRETE SIDEWALK PER DETAIL C4/AS501. COORDINATE WITH

CIVIL DWGS. 4. NEW CONCRETE CURB AND GUTTER PER DETAIL E3/AS501, TYP. COORDINATE WITH CIVIL DWG.

5. EXISTING FIRE HYDRANT TO REMAIN. NEW FIRE HYDRANT. NIC.

LEGEND

NEW CONCRETE

EXISTING RELOCATED FIRE HYDRANT. NIC. NEW CROSSWALK. PROVIDE STRIPING ON ASPHALT DRIVE AS SHOWN. 9. EXISTING PORTABLE TO REMAIN. PROTECT DURING CONSTRUCTION. 10. NEW CHAIN-LINK FENCE, SEE DETAIL C1/AS504.

12. PROVIDE "FIRE LANE, NO PARKING" RED CURB WITH WHITE LETTERING AS INDICATED BY DASHED LINE AT EXISTING AND NEW CURB. 13. HANDICAP PARKING DROP-OFF ZONE. 14. 3' X 4' UNDERGROUND TELE PA FA BOX.

15. NEW METAL FENCE WITH 12'-0" GATE FOR MAINTENANCE ACCESS. 16. EXISTING 2" WATER METER. 17. NEW ASPHALT PATH PAVING. SEE DETAIL A5/AS501.

18. FUTURE LOCATION FOR PORTABLE BUILDING. 19. EXISTING CONCRETE COURTS TO BE REPAINTED TO MATCH NEW. 20. NEW CONCRETE MOW STRIP/EDGER, SEE DETAIL E1/AS501.

21. HANDICAP PARKING SIGN, SEE DETAILS C1 & E1/AS502. 22. VAN ACCESSIBLE PARKING SIGN, SEE DETAILS C1 & E1/AS502. 23. NEW BIKE RACKS SEE DETAIL MODEL #BRP3 IN GROUND MOUNT TYP.

24. NEW BOLLARD PIPE RAIL, SEE DETAIL E4/AS502. 25. NEW PIPE GATE, SEE DETAIL A1/AS504 PER CITY DWG. 2251. 26. NEW BENCH HEIGHT CONCRETE EDGER WALL. SEE DETAIL E2/AS501 & D4/AS501 SIM.

27. NEW BENCH HEIGHT CONCRETE EDGER WALL WITH METAL FENCE, OFFSET FENCE SO BENCH IS STILL USABLE. D4/AS501 SIMILAR.

28. PLAYGROUND CONTAINMENT WALL, SEE DETAIL D4/AS502. 29. RAMP AT PLAYGROUND, SEE DETAILS A1 & B3/AS501. 30. HOV PARKING SIGN TYP. OF 6, SEE DETAILS C1 & E1/AS502.

31. MOTORCYCLE PARKING SIGN, SEE DETAILS C1 & E1/AS502. 32. RELOCATED DUMPSTERS, TYP. OF 5. 33. NEW METAL FENCE, SEE DETAIL A1 & A2/AS502. 34. NEW LONG-JUMP SAND PIT, SEE DETAIL D1/AS504. 35. ROLL OVER CURB, SIM. TO CITY DETAIL DWG. 2428.

37. RELOCATED EXISTING TRASH RECEPTACLE. TYP. OF 3. 38. EXISTING CROSS WALK LIGHT TO REMAIN. 39. NEW BENCH HEIGHT CONCRETE EDGER WALL WO/FENCE, SIMILAR TO DETAIL E2/AS501.

41. TRENCH DRAIN, SEE CIVIL. 42. PIPE GATE OPEN POSITION STOP BOLLARD PER CITY DETAIL DWG. 2251. 43. DUMPSTER ENCLOSURE PER CITY STANDARDS, SEE DETAIL E1 & E3/AS504 & C5/AS502. 44. PROVIDE 6'-0" HANDICAP ACCESSIBLE RAMP AT NEW SIDEWALK AND

CROSSWALK. RAMP SLOPE TO MEET ANSI 117.1-2003 STANDARDS. 45. EXISTING SITE LIGHTING TO REMAIN. SEE ELECTRICAL SITE PLAN. 46. PORTION OF EXISTING CMU WALL TO REMAIN. 47. AREA FOR NEW HOPSCOTCH LAYOUTS, PROVIDE 3 OF EACH. SEE A6

AND B6 ON AS504. 48. FUTURE CONCRETE WALKWAY. 49. FUTURE ADA PARKING WITH SIGNAGE AND PARKING BLOCKS. 50. FUTURE ACCESSIBLE WALKWAY.

51. FUTURE ASPHALT & CURB WORK. 52. PLAYAREA ACCESS RAMP - SEE DETAIL C6 OF AS501. 53. NEW CONCRETE WITH PAINTED 4 SQUARE LAYOUT. DIMENSIONS & PLACEMENT TO BE CONFIRMED BY OWNER. JOINTS SIMILAR TO DETAIL

54. CONCRETE PARKING BLOCK WHERE PARKING SIGNAGE IS USED AND AT WALKWAYS - TYPICAL OF 15. 55. PLAYAREA ACCESS RAMP - SEE DETAIL B6 OF AS501. 56. EXISTING A "DO NOT ENTER" SIGN AT EGRESS POINT OF THE PARENT

57. EXISTING PAINTED CROSS WALK. 58. NEW METAL FENCE WITH DOUBLE GATE FOR STUDENT ACCESS, SEE ENLARGED PLAN FOR DIMENSIONS.

59. EXISTING END ISLANDS. 60. NEW DRIVE PAD PER CITY DRAWING 2425.

CODE ANALYSIS PER IBC 2009 NEW KINDERGARTEN BUILDING

ZONING per Bernalillo County Atlas page F-10-Z The site is zoned R-D. A school is a permissive use in an R-D Zone: See 14-16-2-14(A)(1a).

Chaparral Elementary School 6325 Milne Rd NW Albuquerque, NM 87120

Tracts A and B, Chaparral Elementary School, Albuquerque, NM as the same is shown and desginated on the plat filed in office of the County Clerk of Bernalillo County, New Mexico on January 11, 2000,

SITE SIZE 15.2 Acres PARKING REQUIREMENTS

Albuquerque Zoning Ordinance, Section 14-16-3-1(A)(29): One car space for each school employee.

Anticipated number of employees *Parking Calculations Full—Time Staff — Part-Time Staff -Transient Staff -<u>1/2 time on campus</u> 15-18 Total Employees 148-151 Number of parking spaces provided 166

includes E & W Parent Parking -32 additional spaces at non-peak hours and 9 HC spaces. DISABLED PARKING SPACES

Albuquerque Zoning Ordinance, Section 14-16-3-1(F)(9)(a)Required for 101-300 Provided MOTORCYCLES

Albuquerque Zoning Ordinance, Section 14-16-3-1(C)(1)Required for 151-300 cars Provided

Albuquerque Zoning Ordinance, Section 14-16-3-1(B)(3b) One bicycle space for each 20 students. Anticipated Student Enrollment 750 At 1:20, Bicycles spaces required

Bike racks provided Bicycles spaces provided LOCATION OF DRIVES

SCALE: 1" = 50'-0"

The minimum approach and departure distance required from Intersection of two local streets is 25'-0" per Transportation Design, Chapter 23, August 2005, Page 23-81.



CHERRY/SEE/REAMES


ARCHITECTS, PC

220 gold avenue sw albuquerque, nm 87102

505 - 842 - 1278 fax 505 - 766 - 9269

Addition Rd NW Rd NW M 87120 Classroom ary School 46325 Milne Kindergarten / aparral Elementa



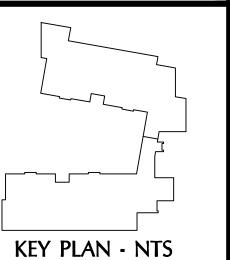

100% CD's 4/1/2013

MARK DATE DESCRIPTION

MANAGEMENT BLOCK **PROJECT NO: CHAPARRAL**

CAD DWG FILE: CHAP AS101.DWG

CHECKED BY: COPYRIGHT: Cherry/See/Reames PC, 201

TITLE OF SHEET


TRAFFIC CIRCULATION LAYOUT

SHEET NUMBER


TCL101 SHEET OF

cherry/see/reames architects PC

| ARCHITECT'S SUPPLEMEN | TAL INSTRUCTIONS | OWNER X ARCHITECT CONTRACTOR X FIELD COTHER |
|--|--|--|
| PROJECT: Chaparral Elementary School Additions - 6325 Milne Road Albuq., NM 87120 | | |
| OWNER: The Board of Education Albuquerque Public Schools 6400 Uptown Blvd. NE Albuq., NM 87110 | APS PROJ. NO.: 0234 | |
| TO: Shumate Constructors, Inc. 8200 Venice Avenue NE Albuq., NM 87122 | 220 Gc | / See / Reames Architects, PC old Avenue SW NM 87102 |
| CONTRACT FOR: CONSTRUCTION | ARCHITECT'S PROJE | CT CODE: CHAPARRAL |
| The Work shall be carried out in accordance the Contract Documents without change in C these instructions, indicate your acceptance the Contract Documents and return a copy to Description: | ontract Sum or Contract Time. Prior to proc of these instructions for minor change to the | ceeding in accordance with |
| Modify the Main Playground per the att Summary of changes: 1. Move the Playground six (6) feet no 2. Widen sidewalk on the south side of | orth to avoid the existing electrical pull | lbox. |
| Contractor to have their surveyor conficause the northernmost paving to end If it does, the Contractor needs to not that encroachment. | roach into the utility easement along \ | Western Trail. |
| Attachments: AS 402 REV2 Enlarged Site Plan (30") | x42") – Playground with dimension mo | odifications |
| ISSUED: | ACCEPTED: | |
| BY: Marie Shaver Holloway Project Manager | BY: Contractor | Date |

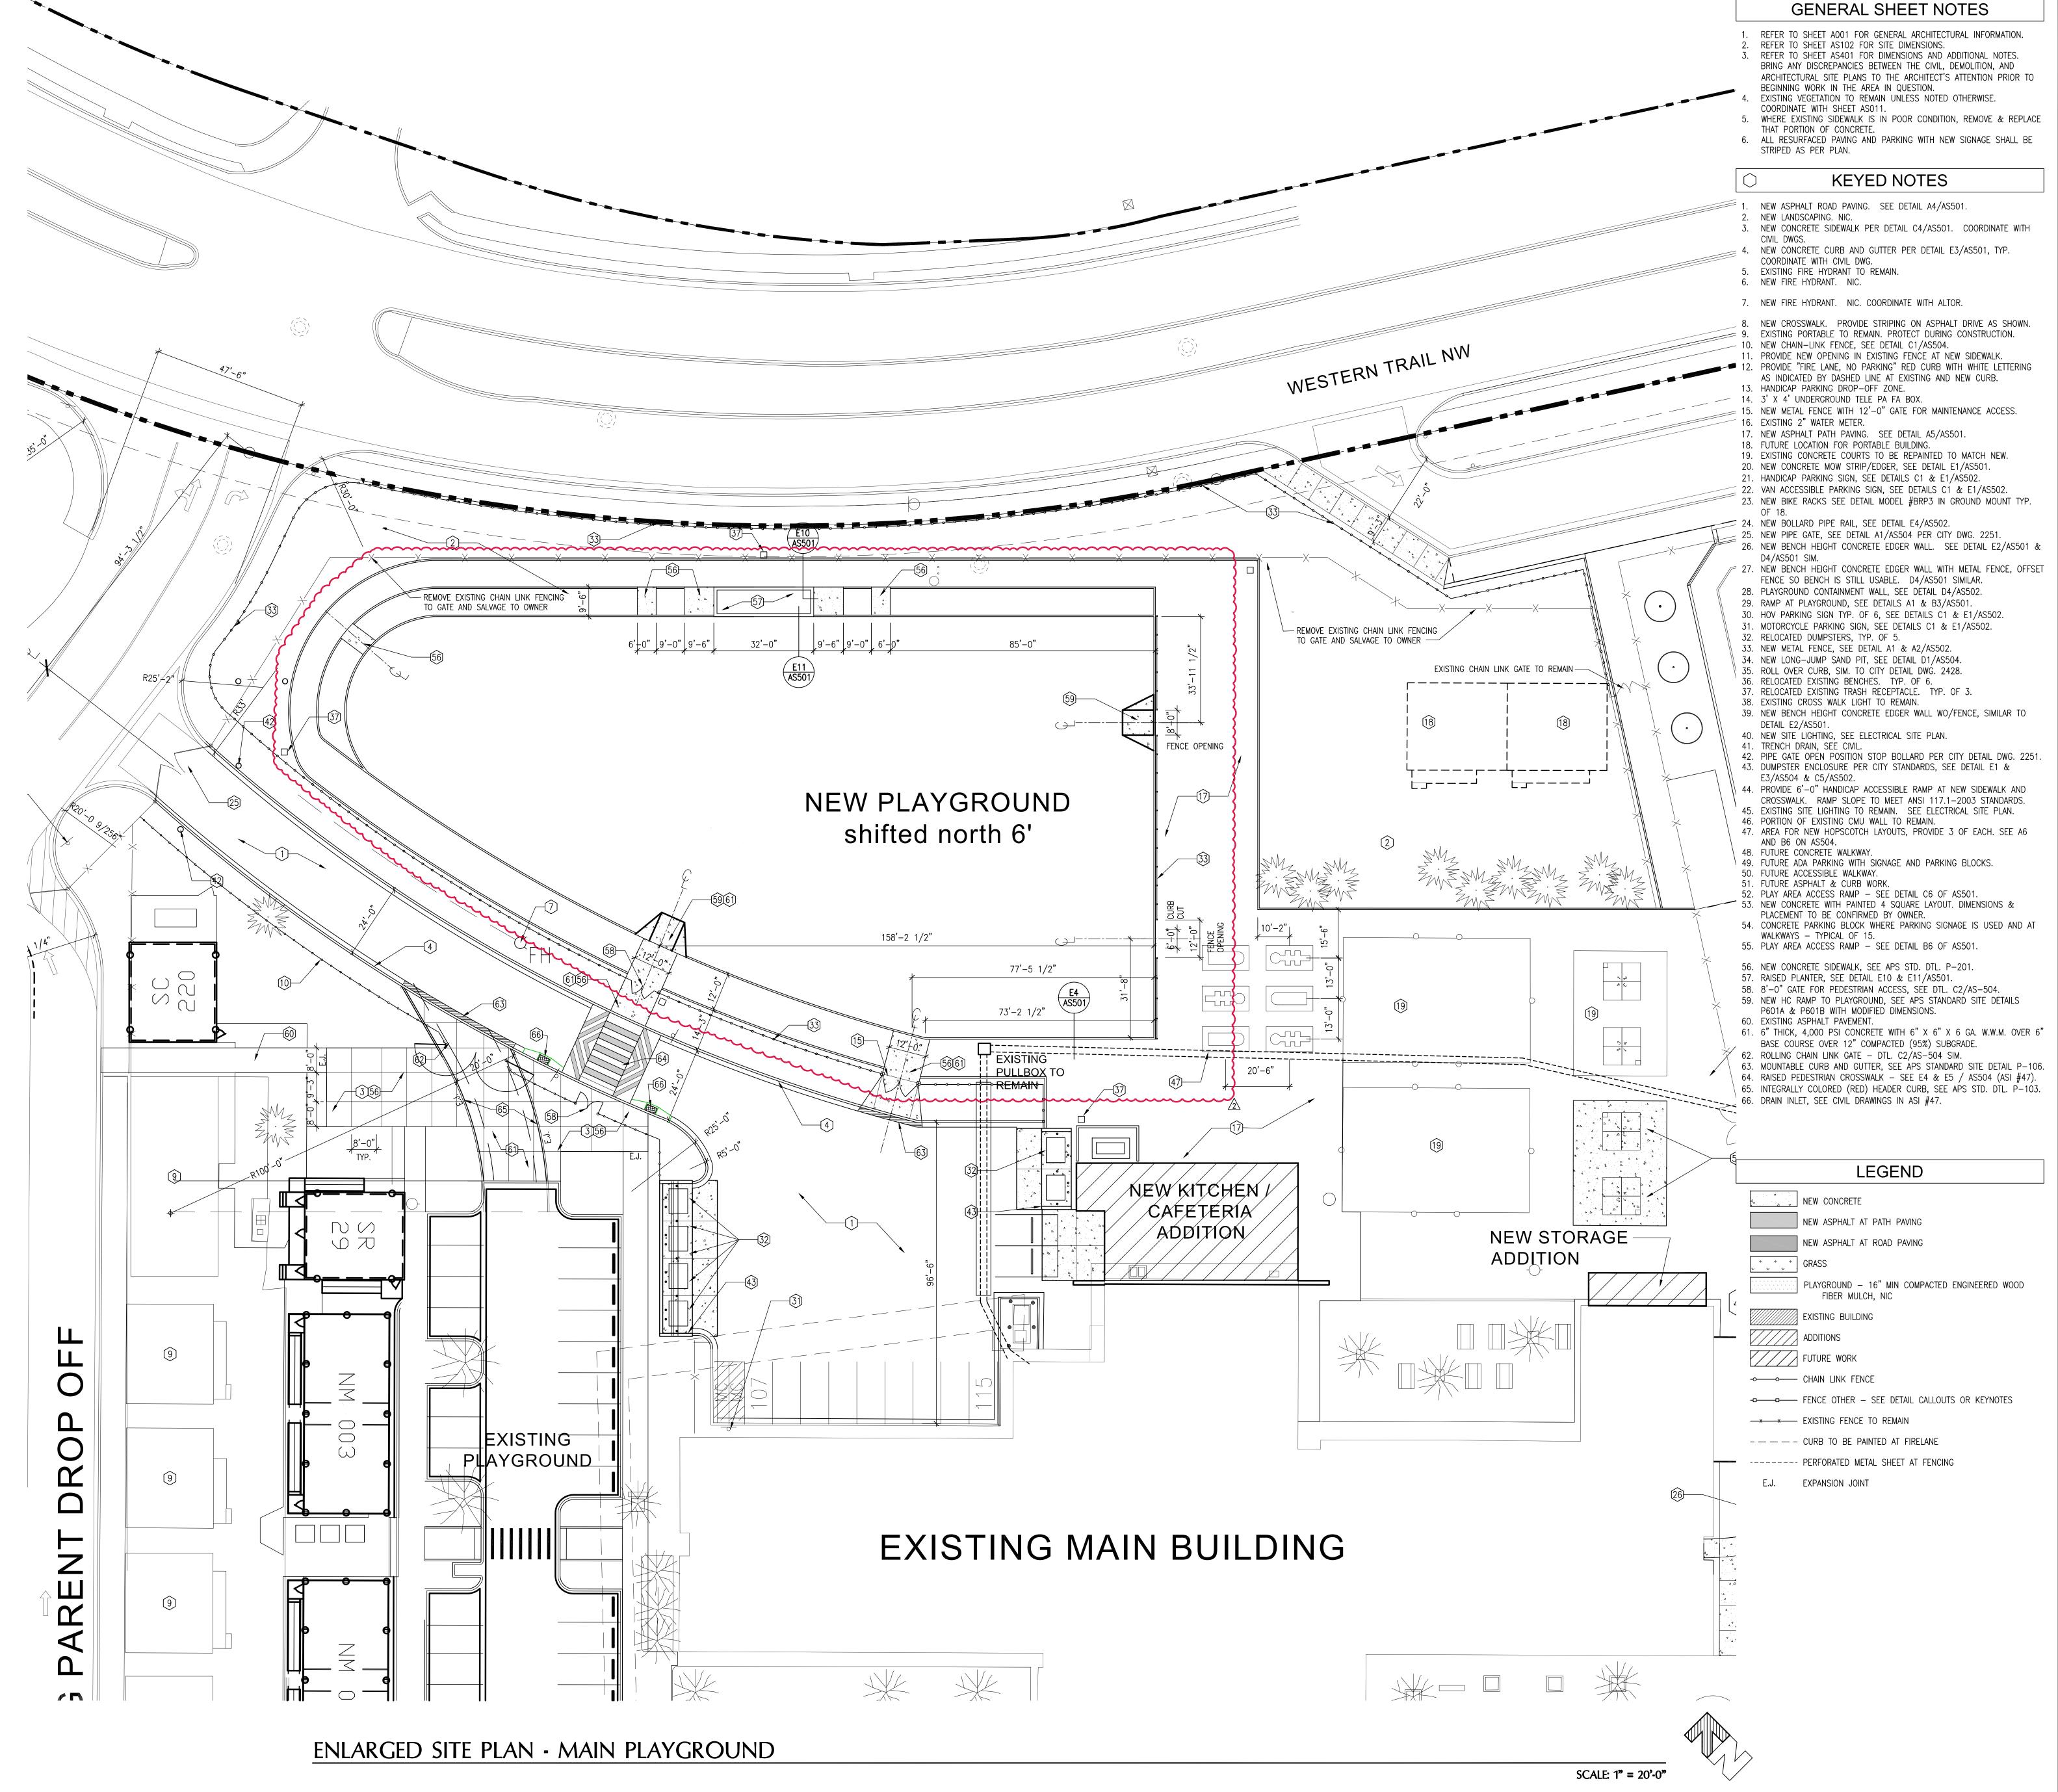

CHERRY/SEE/REAMES
ARCHITECTS, PC
220 gold avenue sw albuquerque, nm 87102
505 - 842 - 1278 fax 505 - 766 - 9269

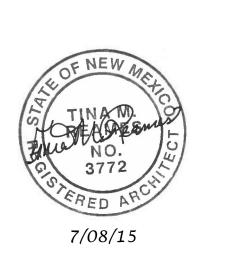

Chaparral Elementary School Addition 6325 Milne Rd NW Albuquerque, NM 87120



KEY PLAN NOT REQUIRED

7/8/2015 ASI #105 REV
5/14/2015 ASI #105
4/1/2013 100% CD SUBMITTAL
MARK DATE DESCRIPTION

MANAGEMENT BLOCK

PROJECT NO: CHAPARRAL

CAD DWG FILE: CHAP AS101.DWG

DRAWN BY: TMR

CHECKED BY:

COPYRIGHT: Cherry/See/Reames, PC 201

TITLE OF SHEET

ENLARGED SITE PLAN PLAYGROUND

SHEET NUMBER

AS402 SHEET OF