
CITY OF ALBUQUERQUE

Planning Department Alan Varela, Interim Director

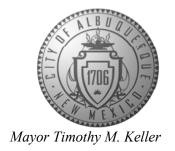

February 10, 2022

David Soule, P.E. Rio Grande Engineering P.O. Box 93924 Albuquerque, NM 87199

RE: 4800 Northern Trails NW Grading and Drainage Plan Engineer's Stamp Date: 01/21/22 Hydrology File: F11D017B

Dear Mr. Soule:

PO Box 1293

Based upon the information provided in your submittal received 01/21/2022, the Grading and Drainage Plan is approved for Building Permit and Grading Permit. Since this site is relatively flat, a pad certification is not needed for this project. Please attach a copy of this approved plan in the construction sets for Building Permit processing along with a copy of this letter.

Albuquerque

PRIOR TO CERTIFICATE OF OCCUPANCY:

NM 87103

1. Engineer's Certification, per the DPM Part 6-14 (F): Engineer's Certification Checklist For Non-Subdivision is required.

If you have any questions, please contact me at 924-3995 or rbrissette@cabq.gov.

www.cabq.gov

Sincerely,

Renée C. Brissette, P.E. CFM Senior Engineer, Hydrology Planning Department

Renée C. Brissette



City of Albuquerque

Planning Department

Development & Building Services Division

DRAINAGE AND TRANSPORTATION INFORMATION SHEET (REV 6/2018)

Project Title: 4800 NORTHERNTRAILS DRB#: LOT 17 QUAKER H Legal Description: 4800 NORTHERNTRAILS City Address: GUSTA Address: Phone#: Other Contact: RIO GRANDE ENGINER Address: PO BOX 93924 ALB NM 8 Phone#: 505.321.9099 TYPE OF DEVELOPMENT: PLAT	EPC#: IEIGHTS AVO MALDONADO Fax#: ERING 87199 Fax#: 505.872.0999	Work Order#: Contact: E-mail: Contact:DAVID SOULE E-mail: david@riograndeengineering.com
Check all that Apply:	RESIDENCE DRD	SHEADMIN SHE
DEPARTMENT: X HYDROLOGY/ DRAINAGE TRAFFIC/ TRANSPORTATION TYPE OF SUBMITTAL: ENGINEER/ARCHITECT CERTIFICATION PAD CERTIFICATION CONCEPTUAL G & D PLAN XX GRADING PLAN DRAINAGE REPORT DRAINAGE MASTER PLAN FLOODPLAIN DEVELOPMENT PERMIT AP ELEVATION CERTIFICATE CLOMR/LOMR TRAFFIC CIRCULATION LAYOUT (TCL) TRAFFIC IMPACT STUDY (TIS) STREET LIGHT LAYOUT OTHER (SPECIFY) PRE-DESIGN MEETING? IS THIS A RESUBMITTAL?: YesXX No	* BUILDING PER CERTIFICATE PRELIMINARY SITE PLAN FO SITE PLAN FO FINAL PLAT A SIA/ RELEASE PLIC FOUNDATION GRADING PER SO-19 APPROV PAVING PERM	OF OCCUPANCY PLAT APPROVAL R SUB'D APPROVAL R BLDG. PERMIT APPROVAL APPROVAL OF FINANCIAL GUARANTEE PERMIT APPROVAL MIT APPROVAL MIT APPROVAL OCCUPANCY D CERTIFICATION APPROVAL
DATE SUBMITTED:	-	
COA STAFF:	ELECTRONIC SUBMITTAL RECEIVED:	

Weighted E Method Weighted E Method Interval of the property of the propert

 Ec= 0.95
 Qc= 2.87

 Ed= 2.24
 Qd= 4.12

 Developed Conditons
 TOTAL VOLUME

 HISTORICAL DISCHARGE
 1261.47

Where for 100-year, 6-hour storm(zone1)


DEVELOPED DISCHARGE

PROVIDED STORMWATER STORAGE

This site is an development of an existing lot in a semi rural area. The down stream conveyance is uncertain therefore the site will conform to the valley flat area drainage scheme. flows are allowed to enter the site. The site will retain the 100-year 10-day volume. The ponds will overlow to the street in the event of a storm exceeding the 100-year event. The surrounding are is flat, minor offsite and pass thru to the right of way. The pad is 1' above lot outfall. The first flush volume is retained on site

EROSION CONTROL NOTES:

- 1. CONTRACTOR IS RESPONSIBLE FOR OBTAINING A TOPSOIL DISTURBANCE PERMIT PRIOR TO BEGINNING WORK.
- 2. CONTRACTOR IS RESPONSIBLE FOR MAINTAINING RUN-OFF ON SITE DURING CONSTRUCTION.
- 3. CONTRACTOR IS RESPONSIBLE FOR CLEANING ALL SEDIMENT THAT GETS INTO EXISTING RIGHT-OF-WAY.
- 4. REPAIR OF DAMAGED FACILITIES AND CLEANUP OF SEDIMENT ACCUMULATIONS ON ADJACENT PROPERTIES AND IN PUBLIC FACILITIES IS THE RESPONSIBILITY OF THE CONTRACTOR.
- 5. ALL EXPOSED EARTH SURFACES MUST BE PROTECTED FROM WIND AND WATER EROSION PRIOR TO FINAL ACCEPTANCE OF ANY PROJECT.

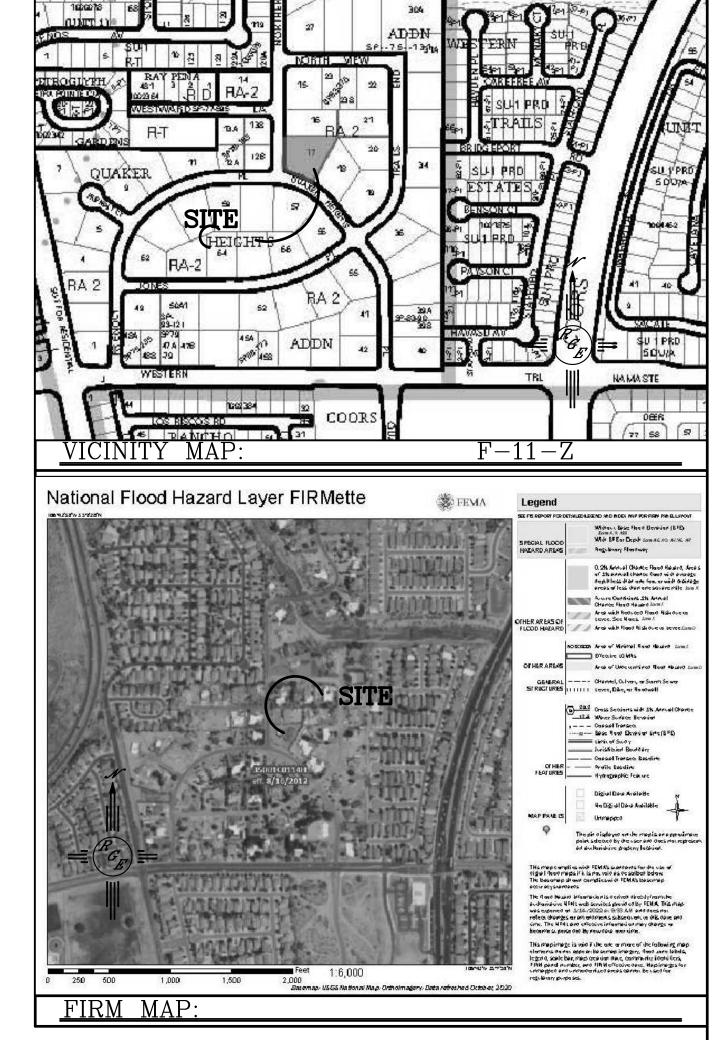

LEGAL DESCRIPTION: LOT 17, QUAKER HEIGHTS

MOTES

1. ALL SPOT ELEVATIONS REPRESENT FLOWLINE ELEVATION UNLESS OTHERWISE


2. ALL SLOPES SHALL BE 3:1 MAX. AND GRAVEL OR NATIVE SEEDING PRIOR TO CO.

3. NO PONDING WITHIN 10' OF STRUCTURE.


4. SURVEY INFORMATION PROVIDED BY CONSTRUCTION SURVEY TECHNOLOGY UTILIZING NAVD 1988 DATUM

LEGEND

SCALE: 1"=20'

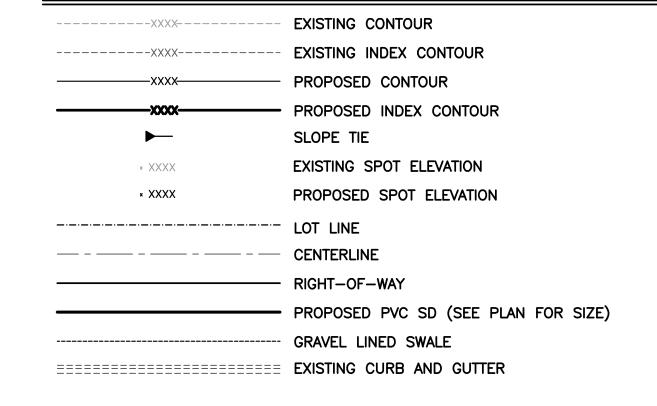

ENGINEER'S SEAL	4800 NORTHERN TRAILS		DRAWN BY WCWJ
NUD SOU			DATE 1-18-22
RECONSTRUCTION METOCOLONIA MET	GRADING AND DRAINAGE PLAN		2022002-LAYOUT-1-18-22
POFESSIONAL		Rio Grande	SHEET #
1/21/22		Ingineering 1606 CENTRAL AVENUE SE	
DAVID SOULE P.E. #14522		SUITE 201 ALBUQUERQUE, NM 87106 (505) 872—0999	JOB # 2022002

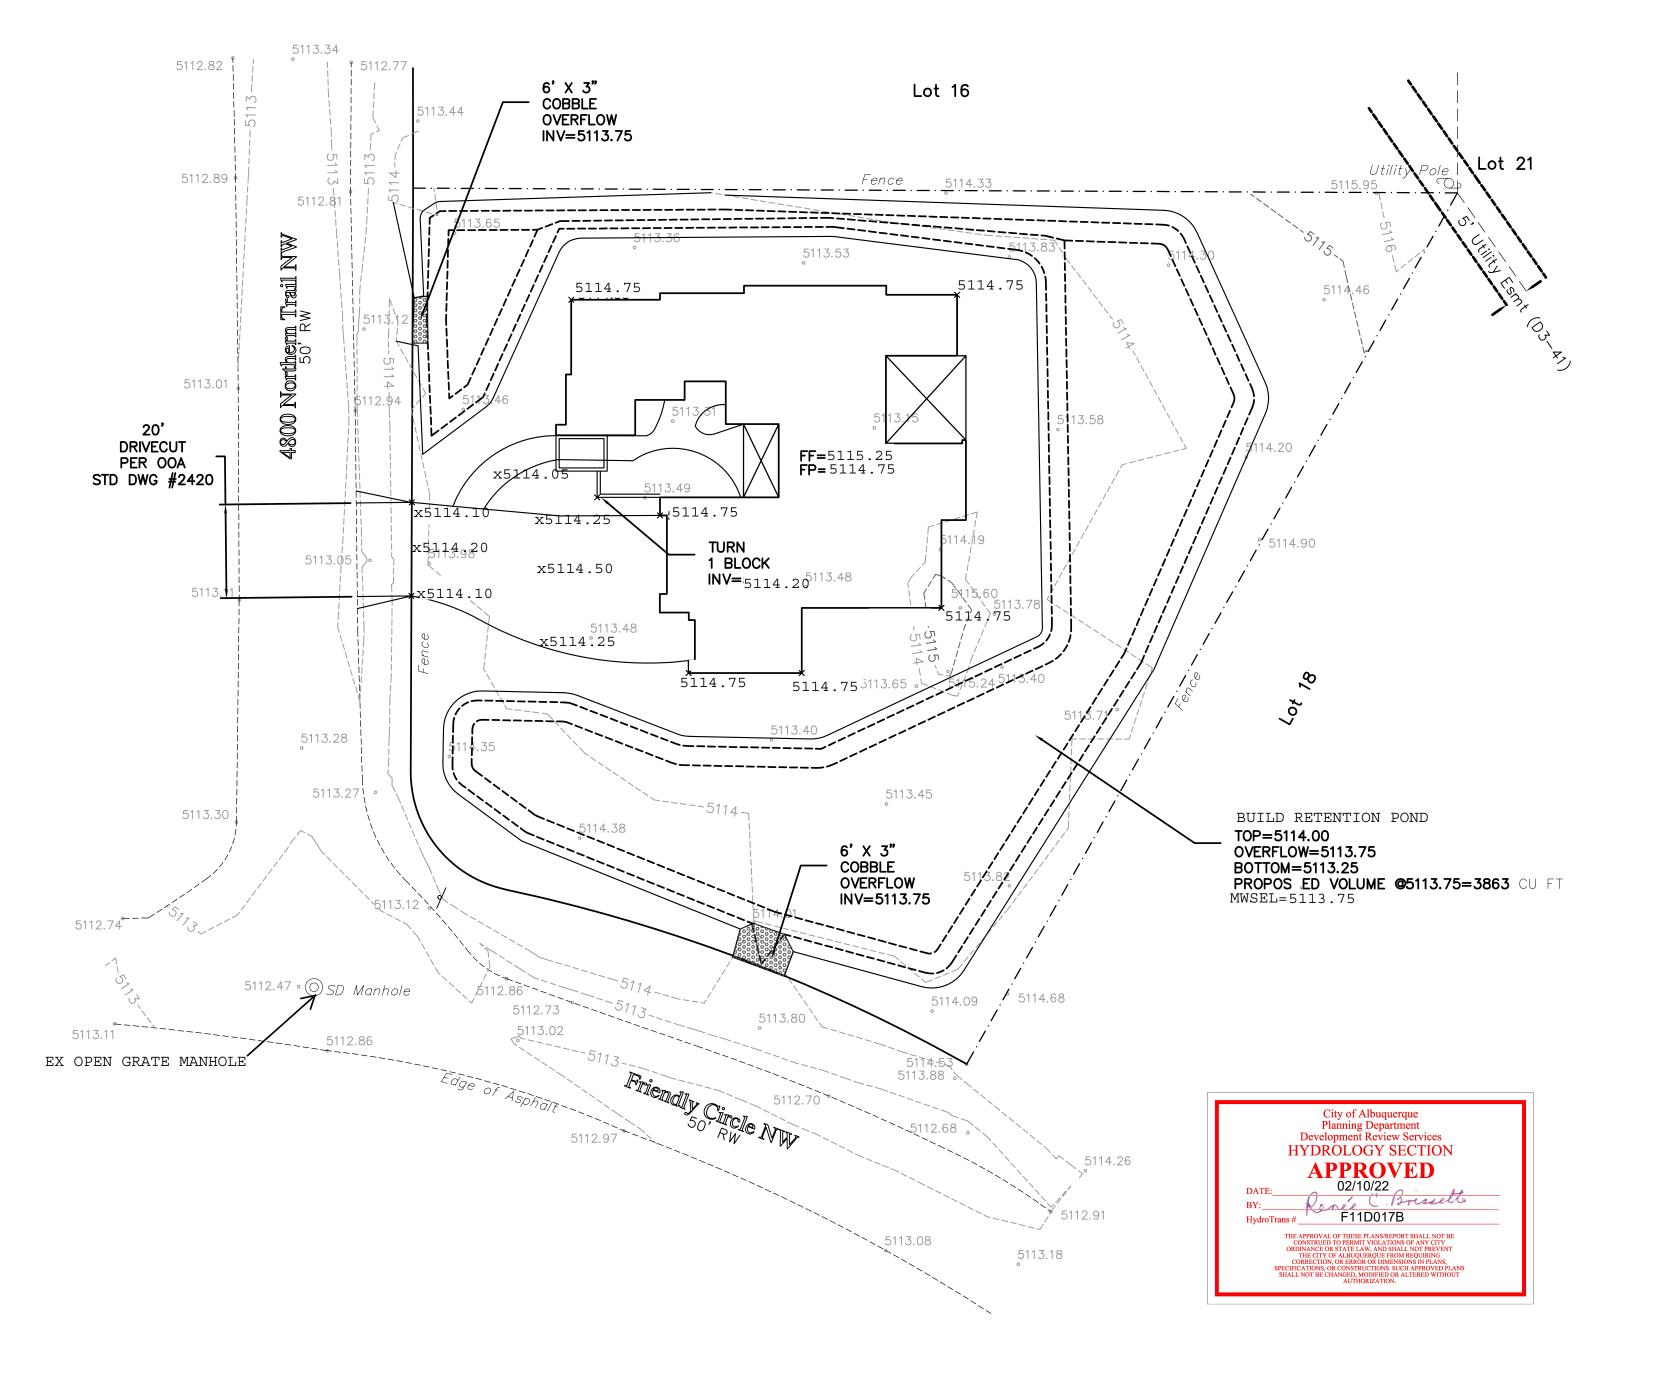

CAUTION:

EXISTING UTILITIES ARE NOT SHOWN.

IT SHALL BE THE SOLE RESPONSIBILITY

OF THE CONTRACTOR TO CONDUCT ALL

NECESSARY FIELD INVESTIGATIONS PRIOR

TO ANY EXCAVATION TO DETERMINE THE

ACTUAL LOCATION OF UTILITIES & OTHER

IMPROVEMENTS.