

CITY OF ALBUQUERQUE

Planning Department
Alan Varela, Director



Mayor Timothy M. Keller

June 22, 2023

Ron E. Henseley, P.E The Group
300 Branding Iron Rd. SE Rio
Rancho, NM 87124

Re: Quaker Heights Townhomes
99999 Quaker Heights Pl. NW
Traffic Circulation Layout
Engineer's Stamp 06-22-23 (F11-D020A)

Dear Mr. Henseley,

The TCL submittal received 05-22-2023 is approved for Building Permit by Transportation. A copy of the stamped and signed plan will be needed for each of the building permit plans. Please keep the original to be used for certification of the site for final C.O. for Transportation.

PO Box 1293

Albuquerque

NM 87103

www.cabq.gov

When the site construction is completed and an inspection for Certificate of Occupancy (C.O.) is requested, use the original City stamped approved TCL for certification. Redline any minor changes and adjustments that were made in the field. A NM registered architect or engineer must stamp, sign, and date the certification TCL along with indicating that the development was built in "substantial compliance" with the TCL. Submit this certification, the TCL, and a completed Drainage and Transportation Information Sheet to the PLNDRS@cabq.gov for log in and evaluation by Transportation.

Once verification of certification is completed and approved, notification will be made to Building Safety to issue Final C.O. To confirm that a final C.O. has been issued, call Building Safety at 924-3690.


Sincerely,

Ernest Armijo, P.E.
Principal Engineer, Planning Dept.
Development Review Services


C: CO Clerk, File

SITE DATA	
LOCATION	QUAKER HEIGHTS PL. N.W. ALBUQUERQUE, NM
LEGAL DESCRIPTION	TR 2-B FINAL PLAT TRACTS 2-A AND 2-B COORS VILLAGE
CURRENT ZONING	MX-T
LAND USE	LOW-DENSITY RESIDENTIAL
ZONE ATLAS PAGE	F-11
BUILDING CONSTRUCTION	2B
APPLICABLE CODE	2015 IBC / IFC
TOTAL LOT AREA	(3.45 AC) 150,099 SF
MAX. BUILDING HEIGHT ALLOWED	30 FEET
MAX. BUILDING HEIGHT	30 FEET
BUILDING FOOTPRINT AREA	47,844 SF
NET LOT AREA (LOT AREA - BUILDING AREA)	102,255 SF
NUMBER OF UNITS	52 SEMI-ATTACHED
LANDSCAPE AREA	38,933 SF
LANDSCAPE W/O TREES AND SHRUBS	6,733 SF
TOTAL LANDSCAPE % OF TOTAL LOT AREA	26%
PAVED, DRIVE AND PEDESTRIAN AREA	45,473 SF
REQUIRED PARKING	42*1 + 10*2=62 SPACES 1 SPACE / 2 BDR UNIT 2 SPACES / 3 BDR UNIT
PARKING PROVIDED*	81 SPACES 52 GARAGE SPACES 29 PARKING SPACES
REQUIRED ADA PARKING	1 SPACES (1 VAN)
PROVIDED ADA PARKING	1 GARAGE SPACE/UNIT + 1 VAN SPACE


* REQUIRED PARKING FOR MOTORCYCLES AND BICYCLES SHALL BE PROVIDED WITHIN GARAGE SPACE

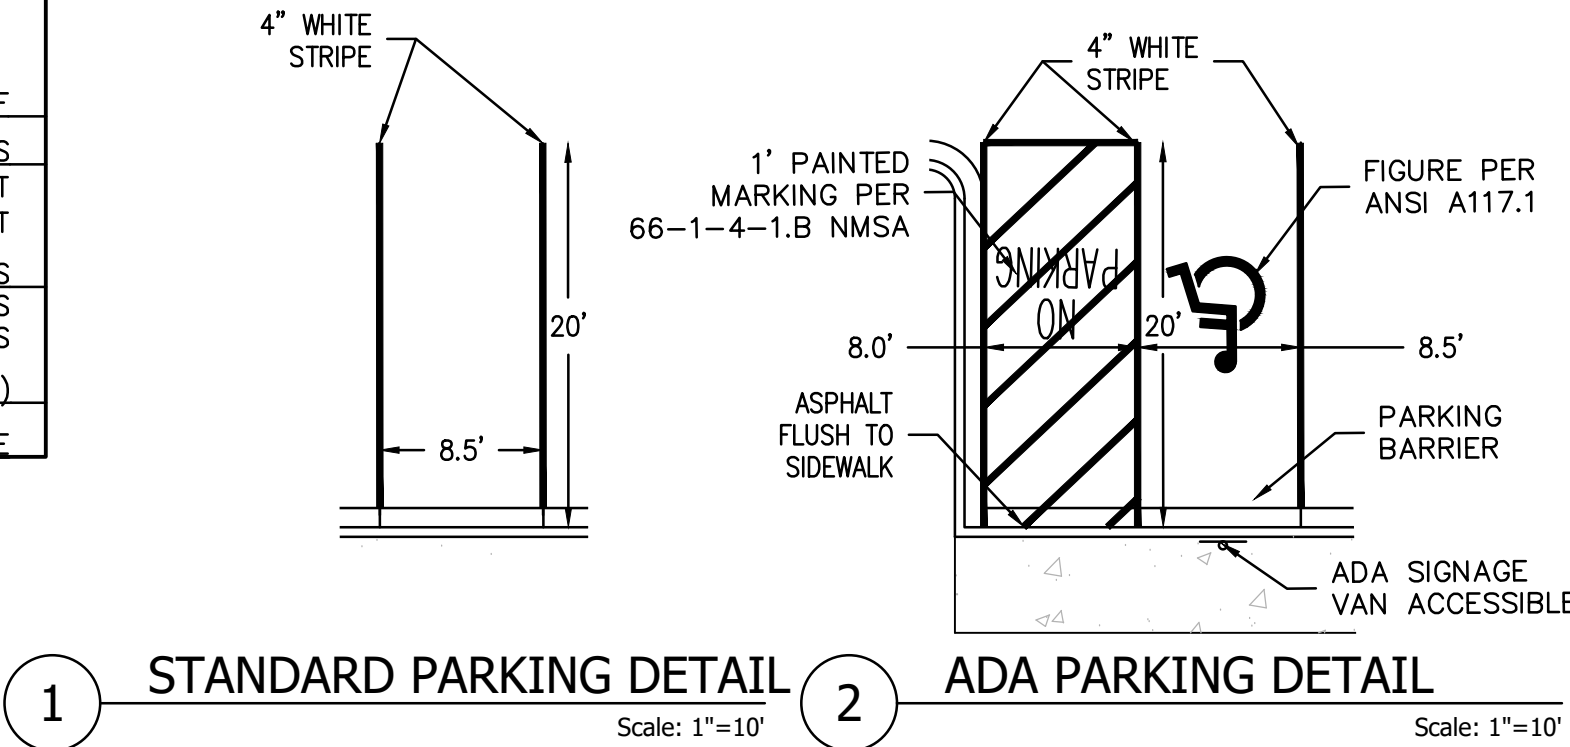

QUAKER HEIGHTS PL. N.W.
(56' R/W)

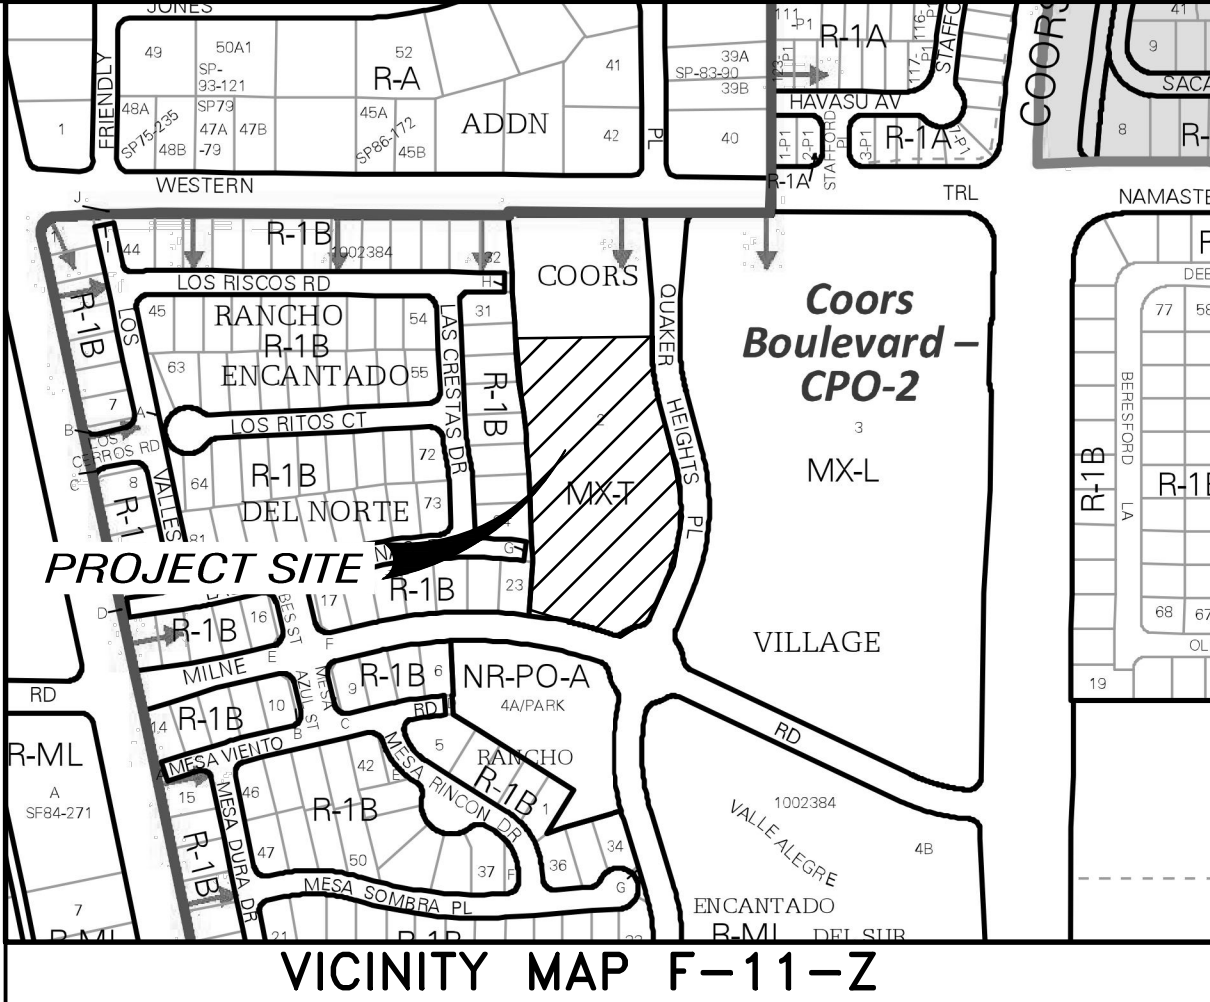

- GENERAL NOTES**
- CURB DIMENSIONS ARE TO FACE OF CURB U.N.O.
 - WORK WITHIN CITY ROW WILL REQUIRE CITY WORK ORDER
 - ALL BROKEN OR CRACKED CURB OR SIDEWALK MUST BE REPLACED WITH SIDEWALK AND CURB & GUTTER PER CITY STANDARD DETAIL 2415
 - SITE LIGHTING - LIGHTING PROVIDED ON BUILDING FACADES AND IN THE PARKING LOT TO BE CUT-OFF TYPE ANGLED TO BE NON-INTRUSIVE TO ADJACENT PROPERTIES AND RIGHT-OF-WAYS
 - SEE GEO-TECHNICAL REPORT FOR SUB-GRADE PREP REQUIREMENTS OF THE BUILDING AND PARKING LOT

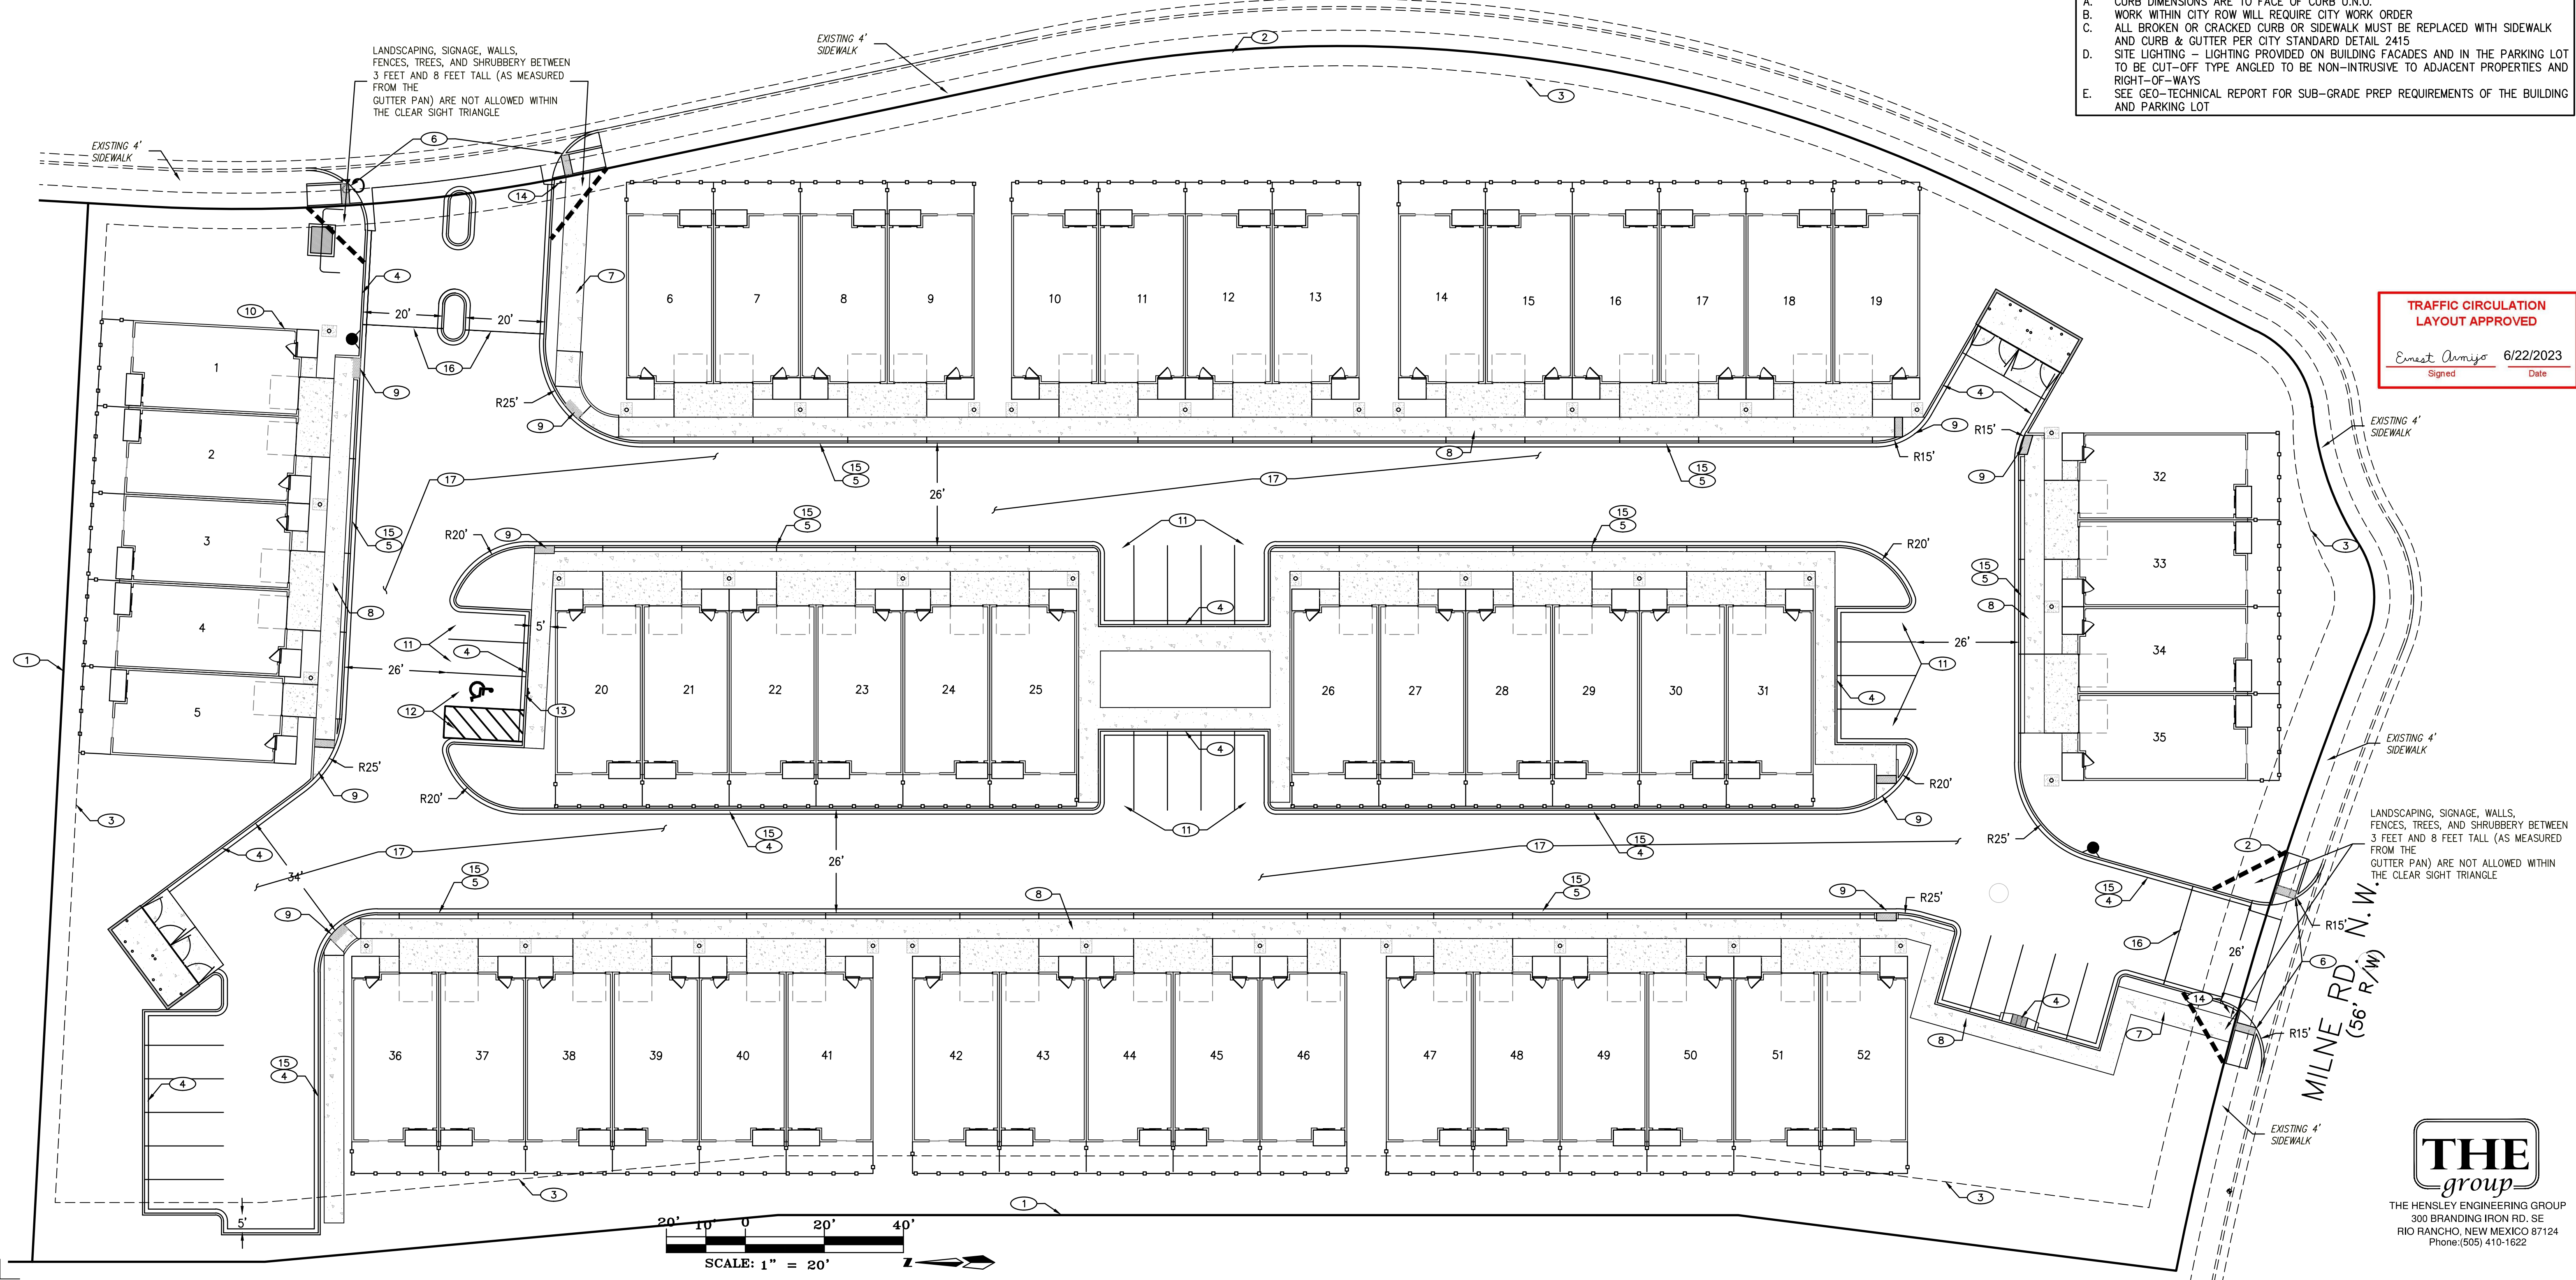

PROJECT ADDRESS: 9999 QUAKER HEIGHTS PL. N.W.
ALBUQUERQUE, NM

PROJECT NAME: QUAKER HEIGHTS TOWNHOMES

PROJECT NUMBER: _____

PROJECT PROGRESS: SITE PLAN

DRAWN BY: REH

CHECKED BY: REH / REH

DATE: NOV. 4, 2022

SCALE: AS NOTED

SHEET: _____

TCL

THE HENSLEY ENGINEERING GROUP
300 BRANDING IRON RD. SE
RIO RANCHO, NEW MEXICO 87124
Phone: (505) 410-1622



- A. CURB, GUTTER AND SIDEWALK WILL BE CONSTRUCTED OF PORTLAND CEMENT CONCRETE (PCC).
- B. SUBGRADE UNDER CURB, SIDEWALKS AND DRIVEPADS SHALL BE COMPACTED TO A DRY DENSITY GREATER THAN 95 PER CENT OF MAXIMUM DRY DENSITY IN A MOISTURE RANGE OF OPTIMUM MOISTURE $+/-2\%$ AS DETERMINED IN ACCORDANCE WITH ASTM D1557, UNLESS THE MATERIAL CONTAINS 35% OR MORE MATERIAL FINER THAN THE NO. 200 SIEVE. IF THE SUBGRADE MATERIALS CONTAINS 35% OR MORE MATERIAL FINER THAN THE NO. 200 SIEVE, THE SUBGRADE SHALL BE COMPACTED TO A DRY DENSITY GREATER THAN 95 PERCENT OF MAXIMUM DRY DENSITY IN A MOISTURE CONTENT RANGE OF AT LEAST OPTIMUM MOISTURE TO OPTIMUM MOISTURE $+4\%$, AS DETERMINED IN ACCORDANCE WITH ASTM D69.
- C. 1/4" EXPANSION JOINTS WHERE SIDEWALK ABUTS BUILDINGS, FENCES, WALLS OR OTHER IMMOVABLE OBJECTS. SPACING 12' MIN. - 22' MAX.
- D. FOR CURB ADJACENT TO ASPHALT CONCRETE (AC) PAVEMENT, PROVIDE CONTRACTION JOINTS AT 12' MAX. SPACING, CONTRACTION JOINTS SHALL BE EITHER SAWED OR TOOLED A MINIMUM OF 1" DEEP AT FINISHED FACES. 1/2" EXPANSION JOINTS TO BE INSTALLED AT CURB RETURNS.
- E. 1/4" EXPANSION JOINTS WHERE SIDEWALK ABUTS BUILDINGS, FENCES, WALLS OR OTHER IMMOVABLE OBJECTS. SPACING 12' MIN. - 22' MAX.
- F. 1/4" ISOLATION JOINT SHALL BE PLACED BETWEEN SIDEWALK AND CURB WHEN CAST ADJACENT TO EACH OTHER.
- G. ALL EDGES SHALL BE EDGED WITH A 3/8" RADIUS EDGING TOOL.
- H. ALL SIDEWALKS SHALL HAVE A MAXIMUM CROSS SLOPE OF 2%.



- A. THE SURFACE OF THE RAMP AND SIDES SHALL HAVE A TRANSVERSE BROOMED SURFACE TEXTURE ROUGHER THAN THE SURROUNDING SIDEWALK.
- B. CONSTRUCT PER A.D.A. STANDARDS

