

CURB & GUTTER BOUNDARY LINE CENTERLINE BUILDING SIDEWALK SCREEN WALL CONTOUR MAJOR 5011 CONTOUR MINOR x 5048.25 SPOT ELEVATION FLOW ARROW EXISTING CURB & GUTTER EXISTING BOUNDARY LINE EXISTING CONTOUR MAJOR ---- EXISTING CONTOUR MINOR EXISTING SPOT ELEVATION PROPOSED PAVEMENT EXISTING PAVEMENT TO REMAIN

---- PROPOSED DRAINAGE SWALE

EROSION CONTROL NOTES


- 1. CONTRACTOR IS RESPONSIBLE FOR OBTAINING A TOPSOIL DISTURBANCE PERMIT PRIOR TO BEGINNING WORK.
- 2. CONTRACTOR IS RESPONSIBLE FOR MAINTAINING RUN-OFF ON SITE DURING CONSTRUCTION.
- 3. CONTRACTOR IS RESPONSIBLE FOR CLEANING ALL SEDIMENT THAT GETS INTO EXISTING RIGHT-OF-WAY.
- 4. REPAIR OF DAMAGED FACILITIES AND CLEANUP OF SEDIMENT ACCUMULATIONS ON ADJACENT PROPERTIES AND IN PUBLIC FACILITIES IS THE RESPONSIBILITY OF THE CONTRACTOR.
- 5. ALL EXPOSED EARTH SURFACES MUST BE PROTECTED FROM WIND AND WATER EROSION PRIOR TO FINAL (CITY) ACCEPTANCE

ALL EXISTING UTILITIES SHOWN WERE OBTAINED FROM RESEARCH, AS-BUILTS, SURVEYS OR INFORMATION PROVIDED BY OTHERS. IT SHALL BE THE SOLE RESPONSIBILITY OF THE CONTRACTOR TO CONDUCT ALL NECESSARY FIELD INVESTIGATIONS PRIOR TO AND INCLUDING ANY EXCAVATION, TO DETERMINE THE ACTUAL LOCATION OF UTILITIES AND OTHER IMPROVEMENTS, PRIOR TO STARTING THE WORK. ANY CHANGES FROM THIS PLAN SHALL BE COORDINATED WITH AND APPROVED BY THE


- (A) DOWNSPOUT WITH SPLASH BLOCK (SEE DETAIL THIS SHEET)
- (B) SIDEWALK CULVERT, 12" PER COA STD DWG #2236

DOWNSPOUT DETAIL

(PLAN VIEW)

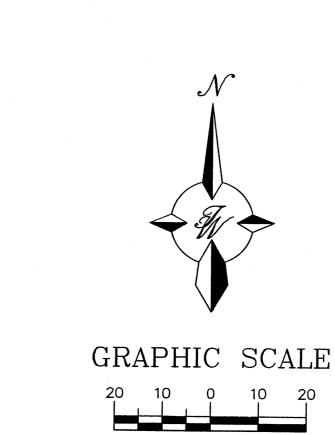

SCALE: 1"=20'

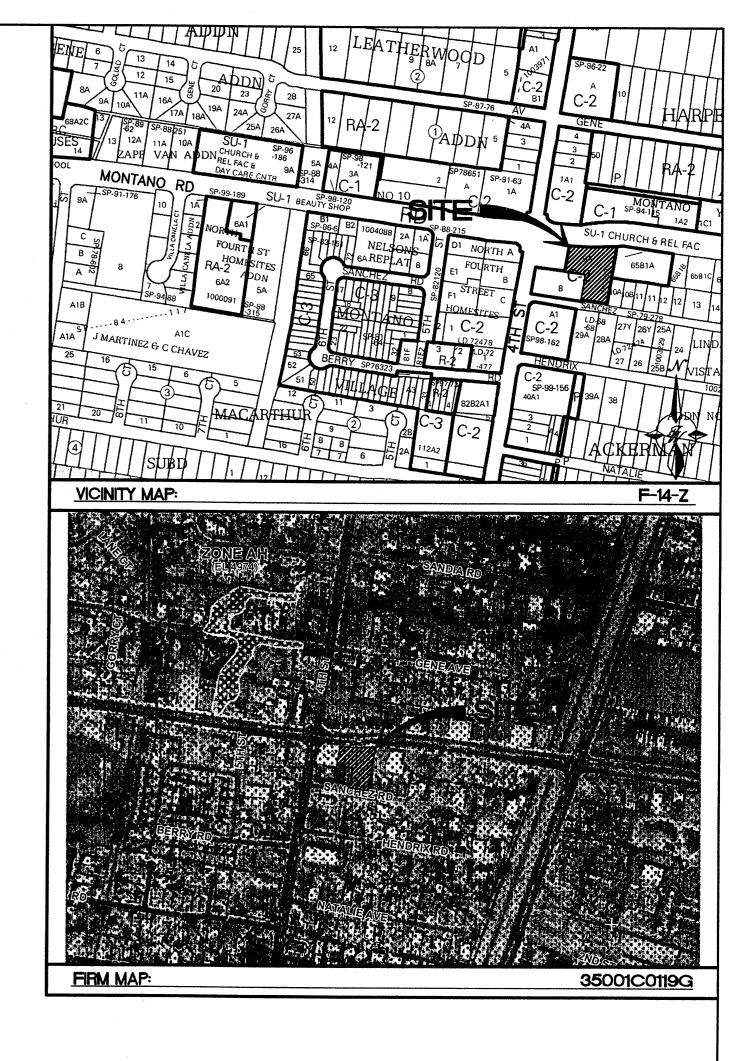


NOTICE TO CONTRACTORS


- 1. AN EXCAVATION/CONSTRUCTION PERMIT WILL BE REQUIRED BEFORE BEGINNING ANY WORK WITHIN CITY RIGHT-OF-WAY.
- 2. ALL WORK DETAILED ON THESE PLANS TO BE PERFORMED, EXCEPT AS OTHERWISE STATED OR PROVIDED HERON, SHALL BE CONSTRUCTED IN ACCORDANCE WITH CITY OF ALBUQUERQUE INTERIM STANDARD SPECIFICATIONS FOR PUBLIC WORKS CONSTRUCTION, 1985.
- 3. TWO WORKING DAYS PRIOR TO ANY EXCAVATION, CONTRACTOR MUST CONTACT LINE LOCATING SERVICE, 765-1234, FOR LOCATION OF EXISTING UTILITIES.
- 4. PRIOR TO CONSTRUCTION, THE CONTRACTOR SHALL EXCAVATE AND VERIFY THE HORIZONTAL AND VERTICAL LOCATIONS OF ALL CONNECTIONS. SHOULD A CONFLICT EXIST, THE CONTRACTOR SHALL NOTIFY THE ENGINEER SO THAT THE CONFLICT CAN BE RESOLVED WITH A MINIMUM AMOUNT OF DELAY.
- 5. BACKFILL COMPACTION SHALL BE ACCORDING TO TRAFFIC/STREET USE.
- 6. MAINTENANCE OF THESE FACILITIES SHALL BE THE RESPONSIBILITY OF THE OWNER OF THE PROPERTY SERVED. 7. WORK ON ARTERIAL STREETS SHALL BE PERFORMED ON A 24-HOUR BASIS.

THE OWNER OF THE PROPERTY SERVED. 7. WORK ON ARTERIAL STREETS SHALL BE PERFORMED ON A 24-HOUR BASIS.			LAND DEVELO	PMENT SECTION
APPROVAL	NAME	DATE		TECTION
INSPECTOR				

ROUGH GRADING APPROVAL

DATE

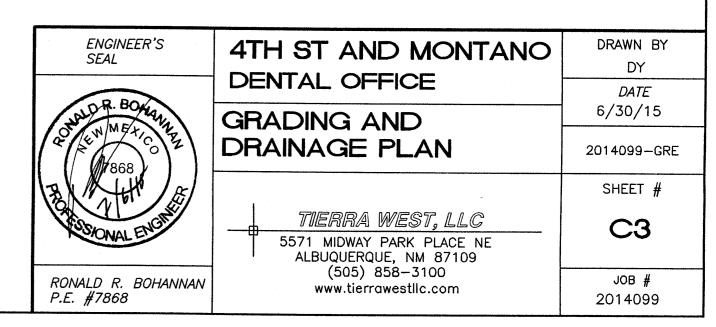

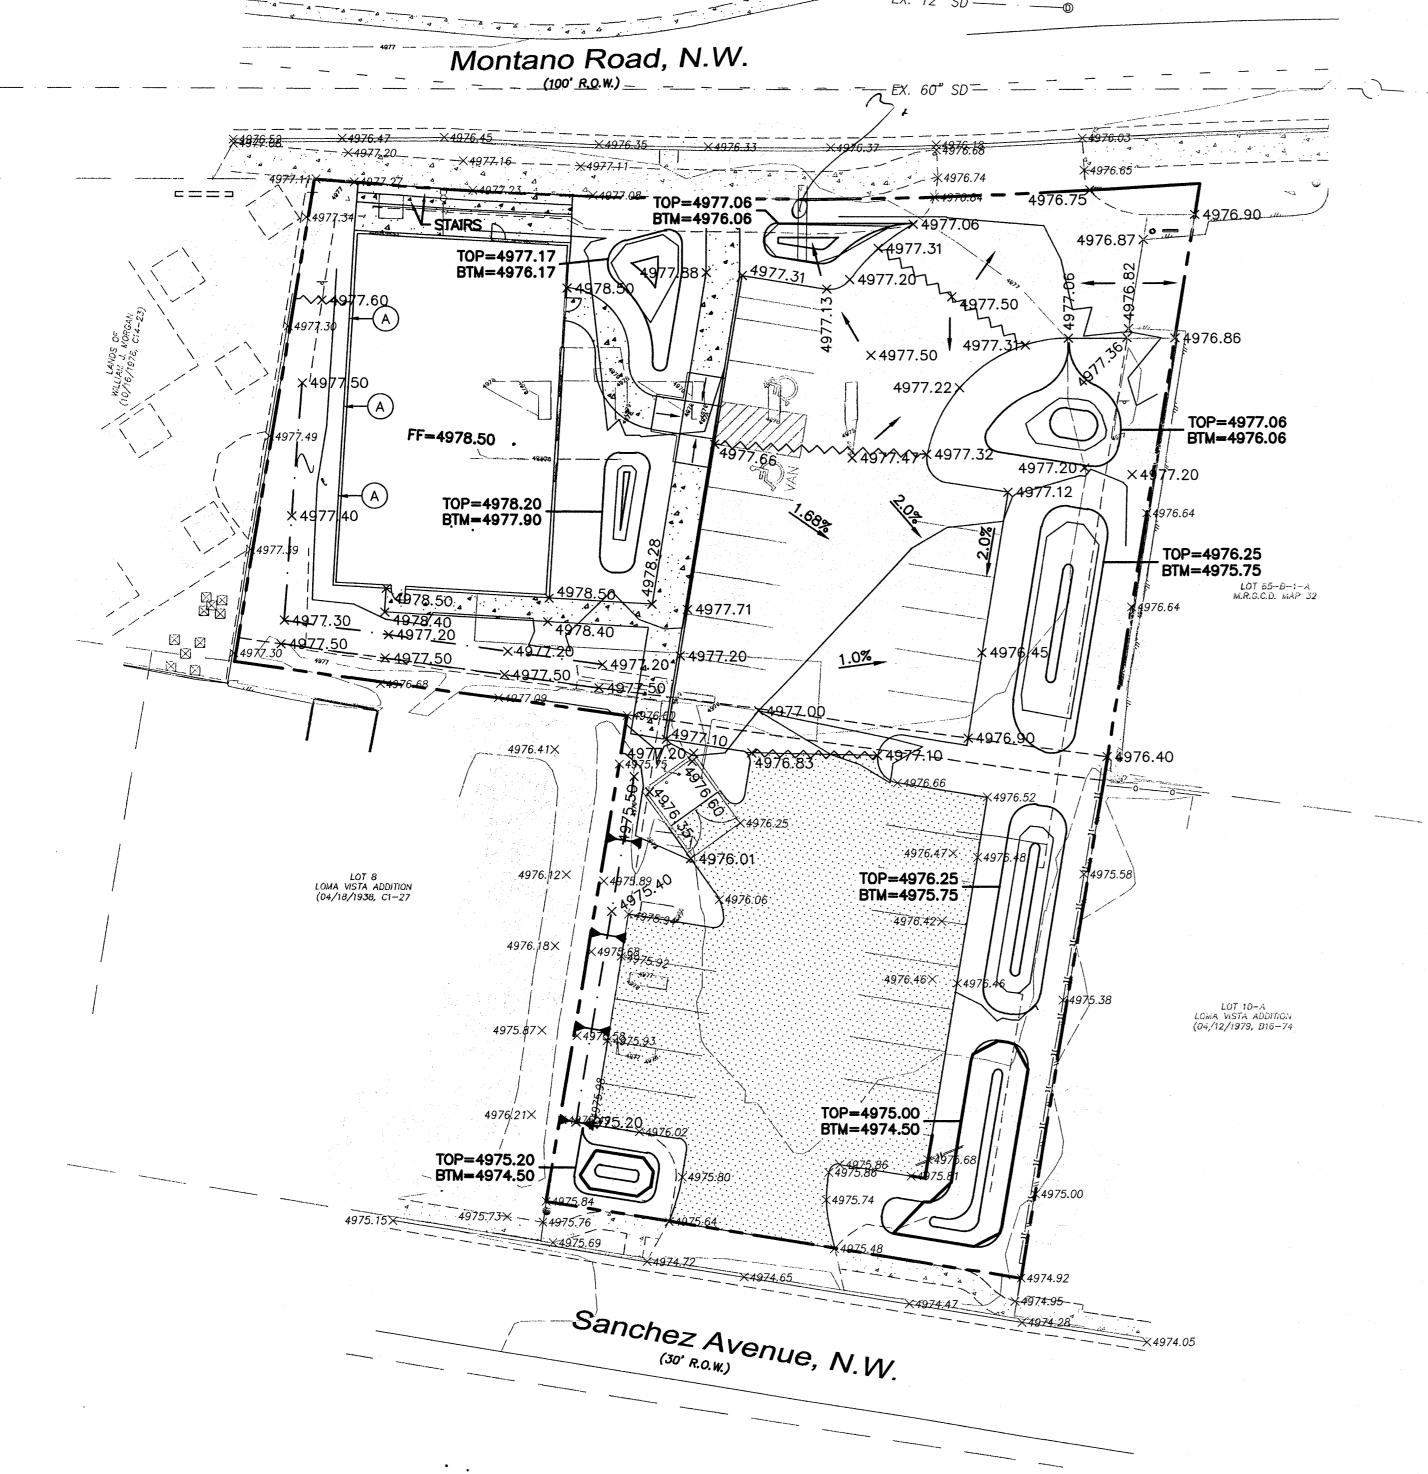

LEGEND CURB & GUTTER --- BOUNDARY LINE SIDEWALK SCREEN WALL ---- CONTOUR MAJOR --- CONTOUR MINOR SPOT ELEVATION FLOW ARROW - EXISTING CURB & GUTTER EXISTING BOUNDARY LINE EXISTING CONTOUR MAJOR ---- EXISTING CONTOUR MINOR EXISTING SPOT ELEVATION ☐ PROPOSED PAVEMENT

EXISTING PAVEMENT TO REMAIN

--- PROPOSED DRAINAGE SWALE

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KEYED NOTE:


A DOWNSPOUT

cross Let Drn. easement west et 21dq.?
South of 21dq.?



GRAPHIC SCALE

SCALE: 1"=20"

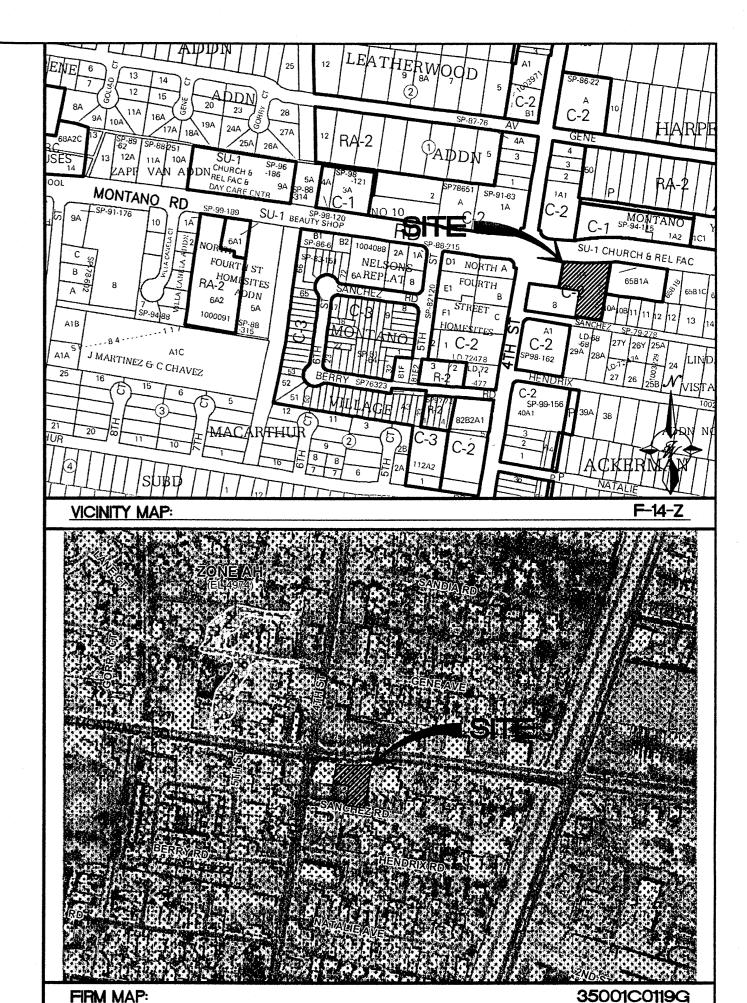

NOTICE TO CONTRACTORS

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APPROVAL	NAME	DATE	-
INSPECTOR			
MAY 15	20:5 MENT SECTION		


ROUGH GRADING APPROVAL


P.E. #16212


DRAWN BY 4TH ST AND MONTANO ENGINEER'S DY **DENTAL OFFICE** DATE 5/14/15 **GRADING AND** DRAINAGE PLAN 2014099-GRE SHEET # TIERRA WEST, LLC **C3** 5571 MIDWAY PARK PLACE NE ALBUQUERQUE, NM 87109 (505) 858-3100 JOB # VINCENT P. CARRICA www.tierrawestllc.com

DATE


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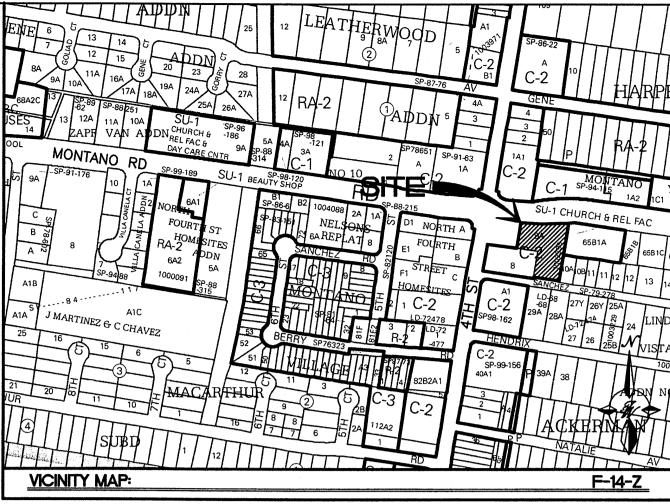

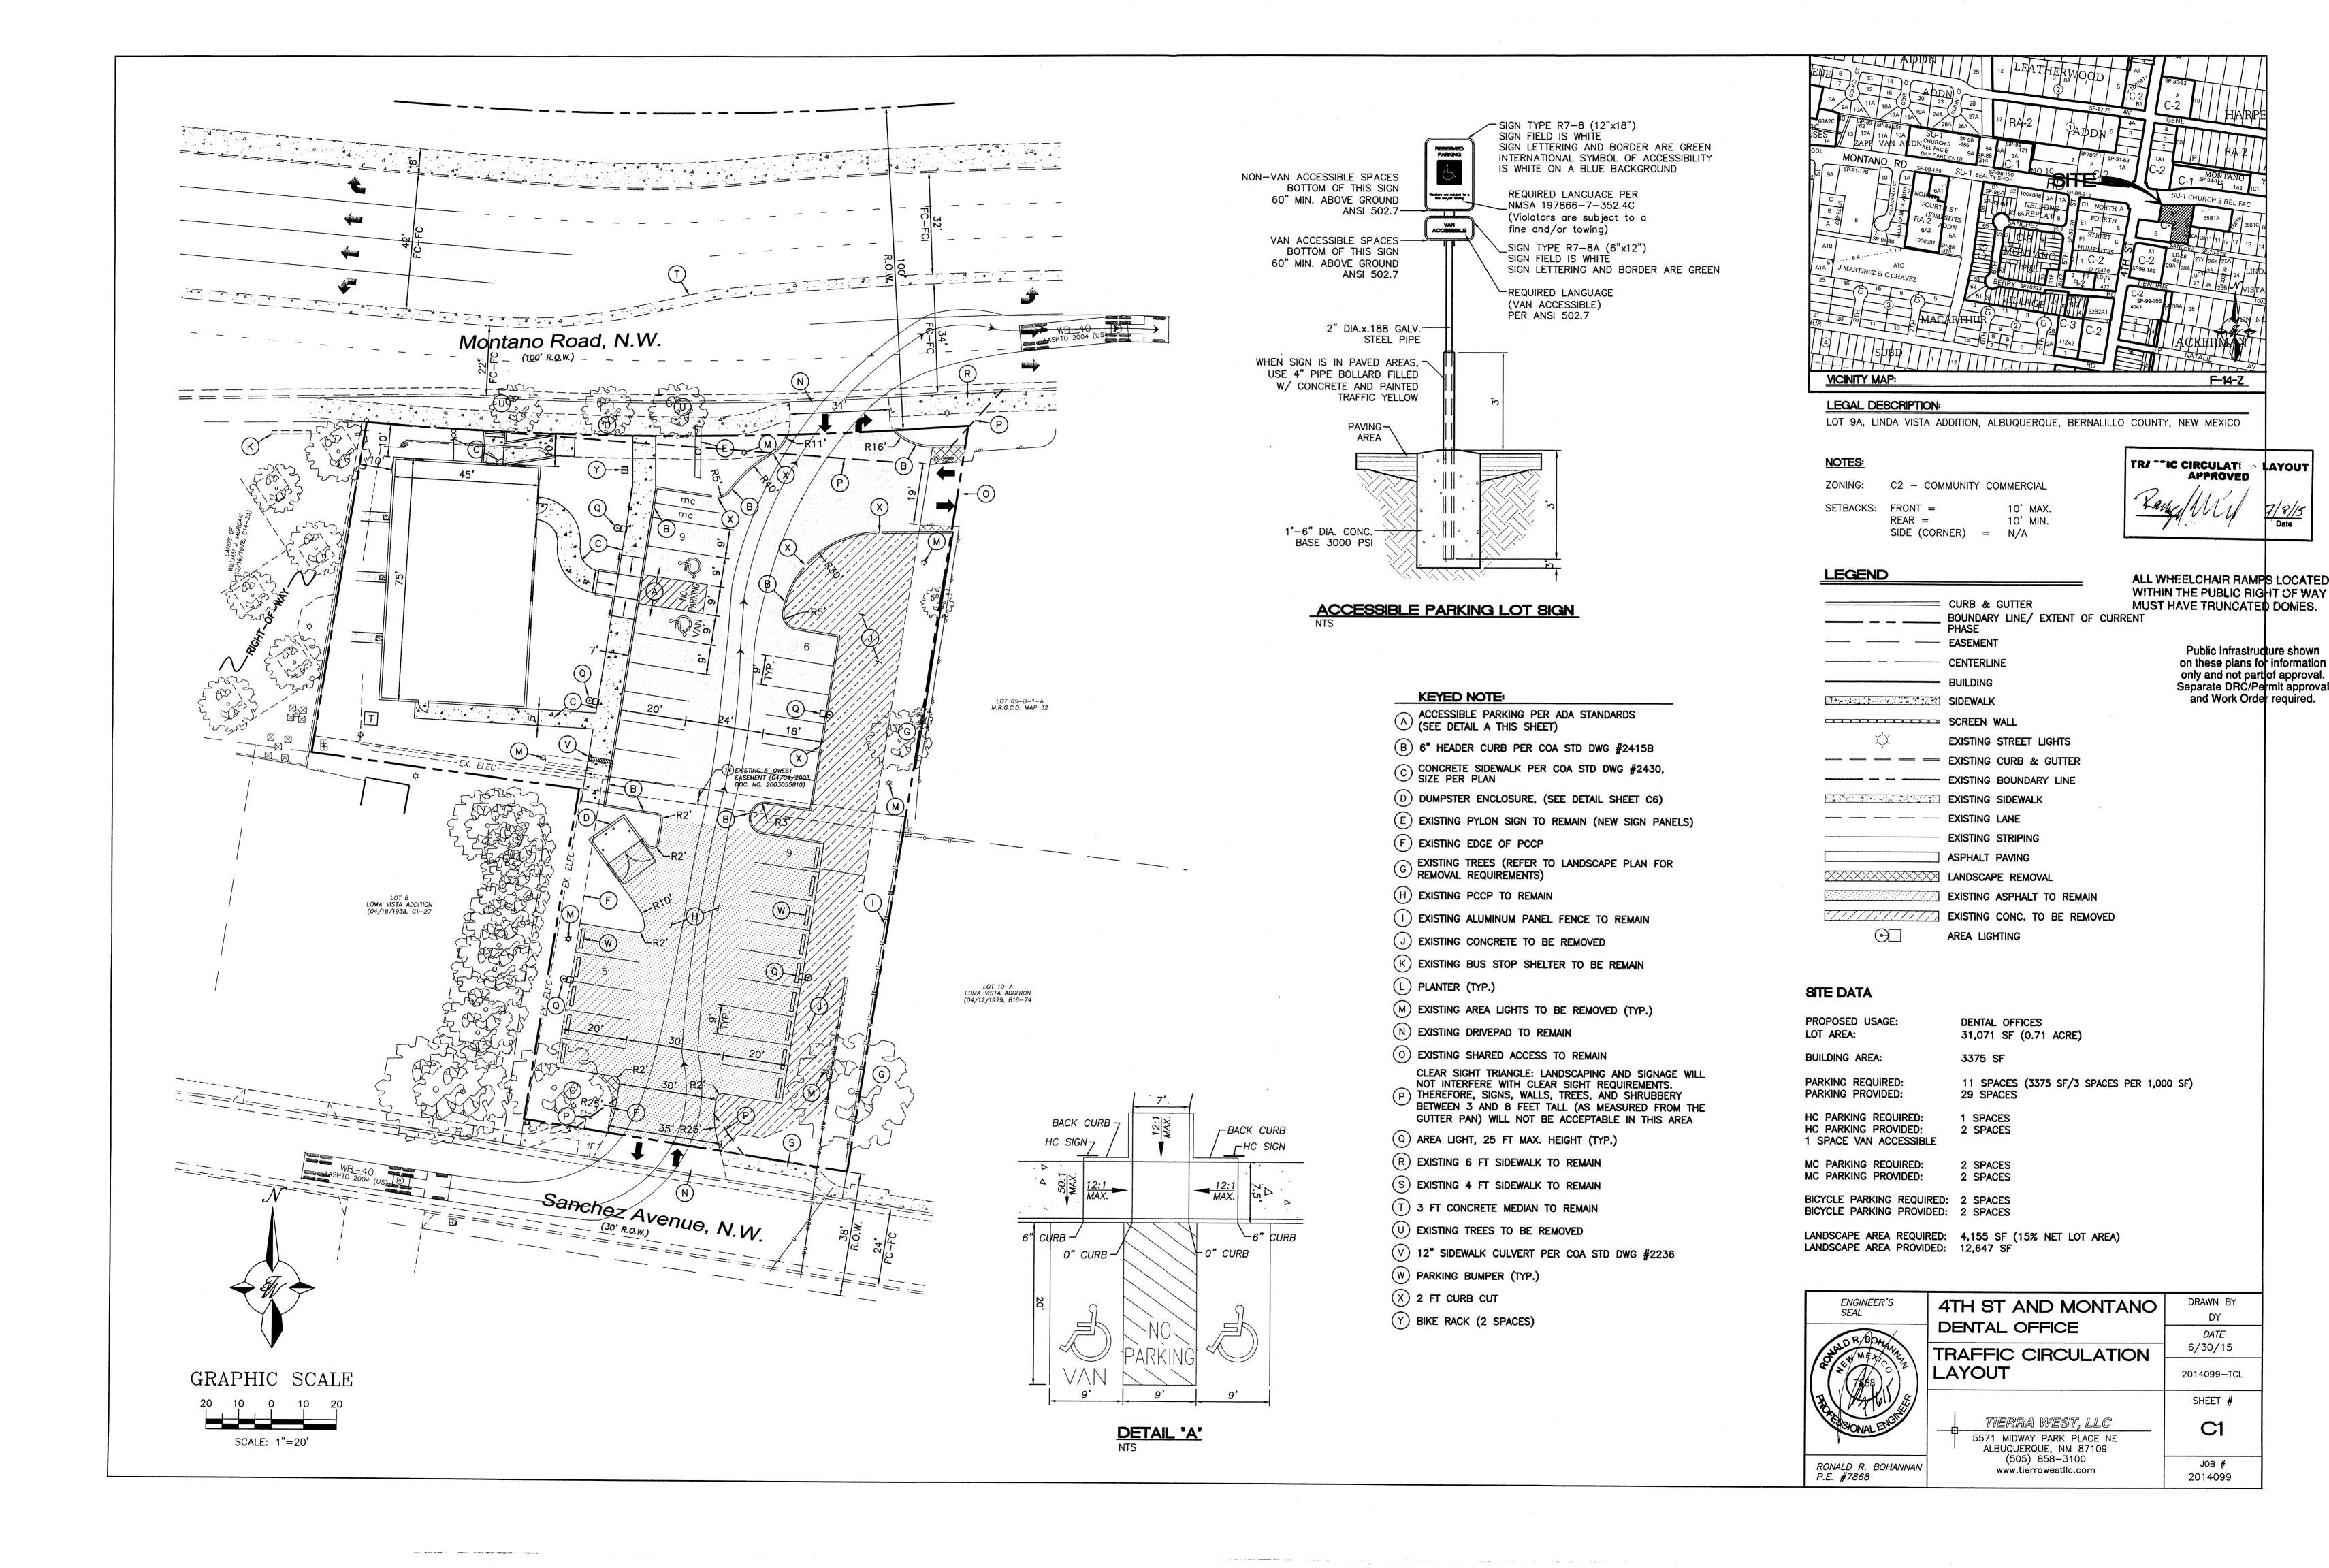
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KEYED NOTE:

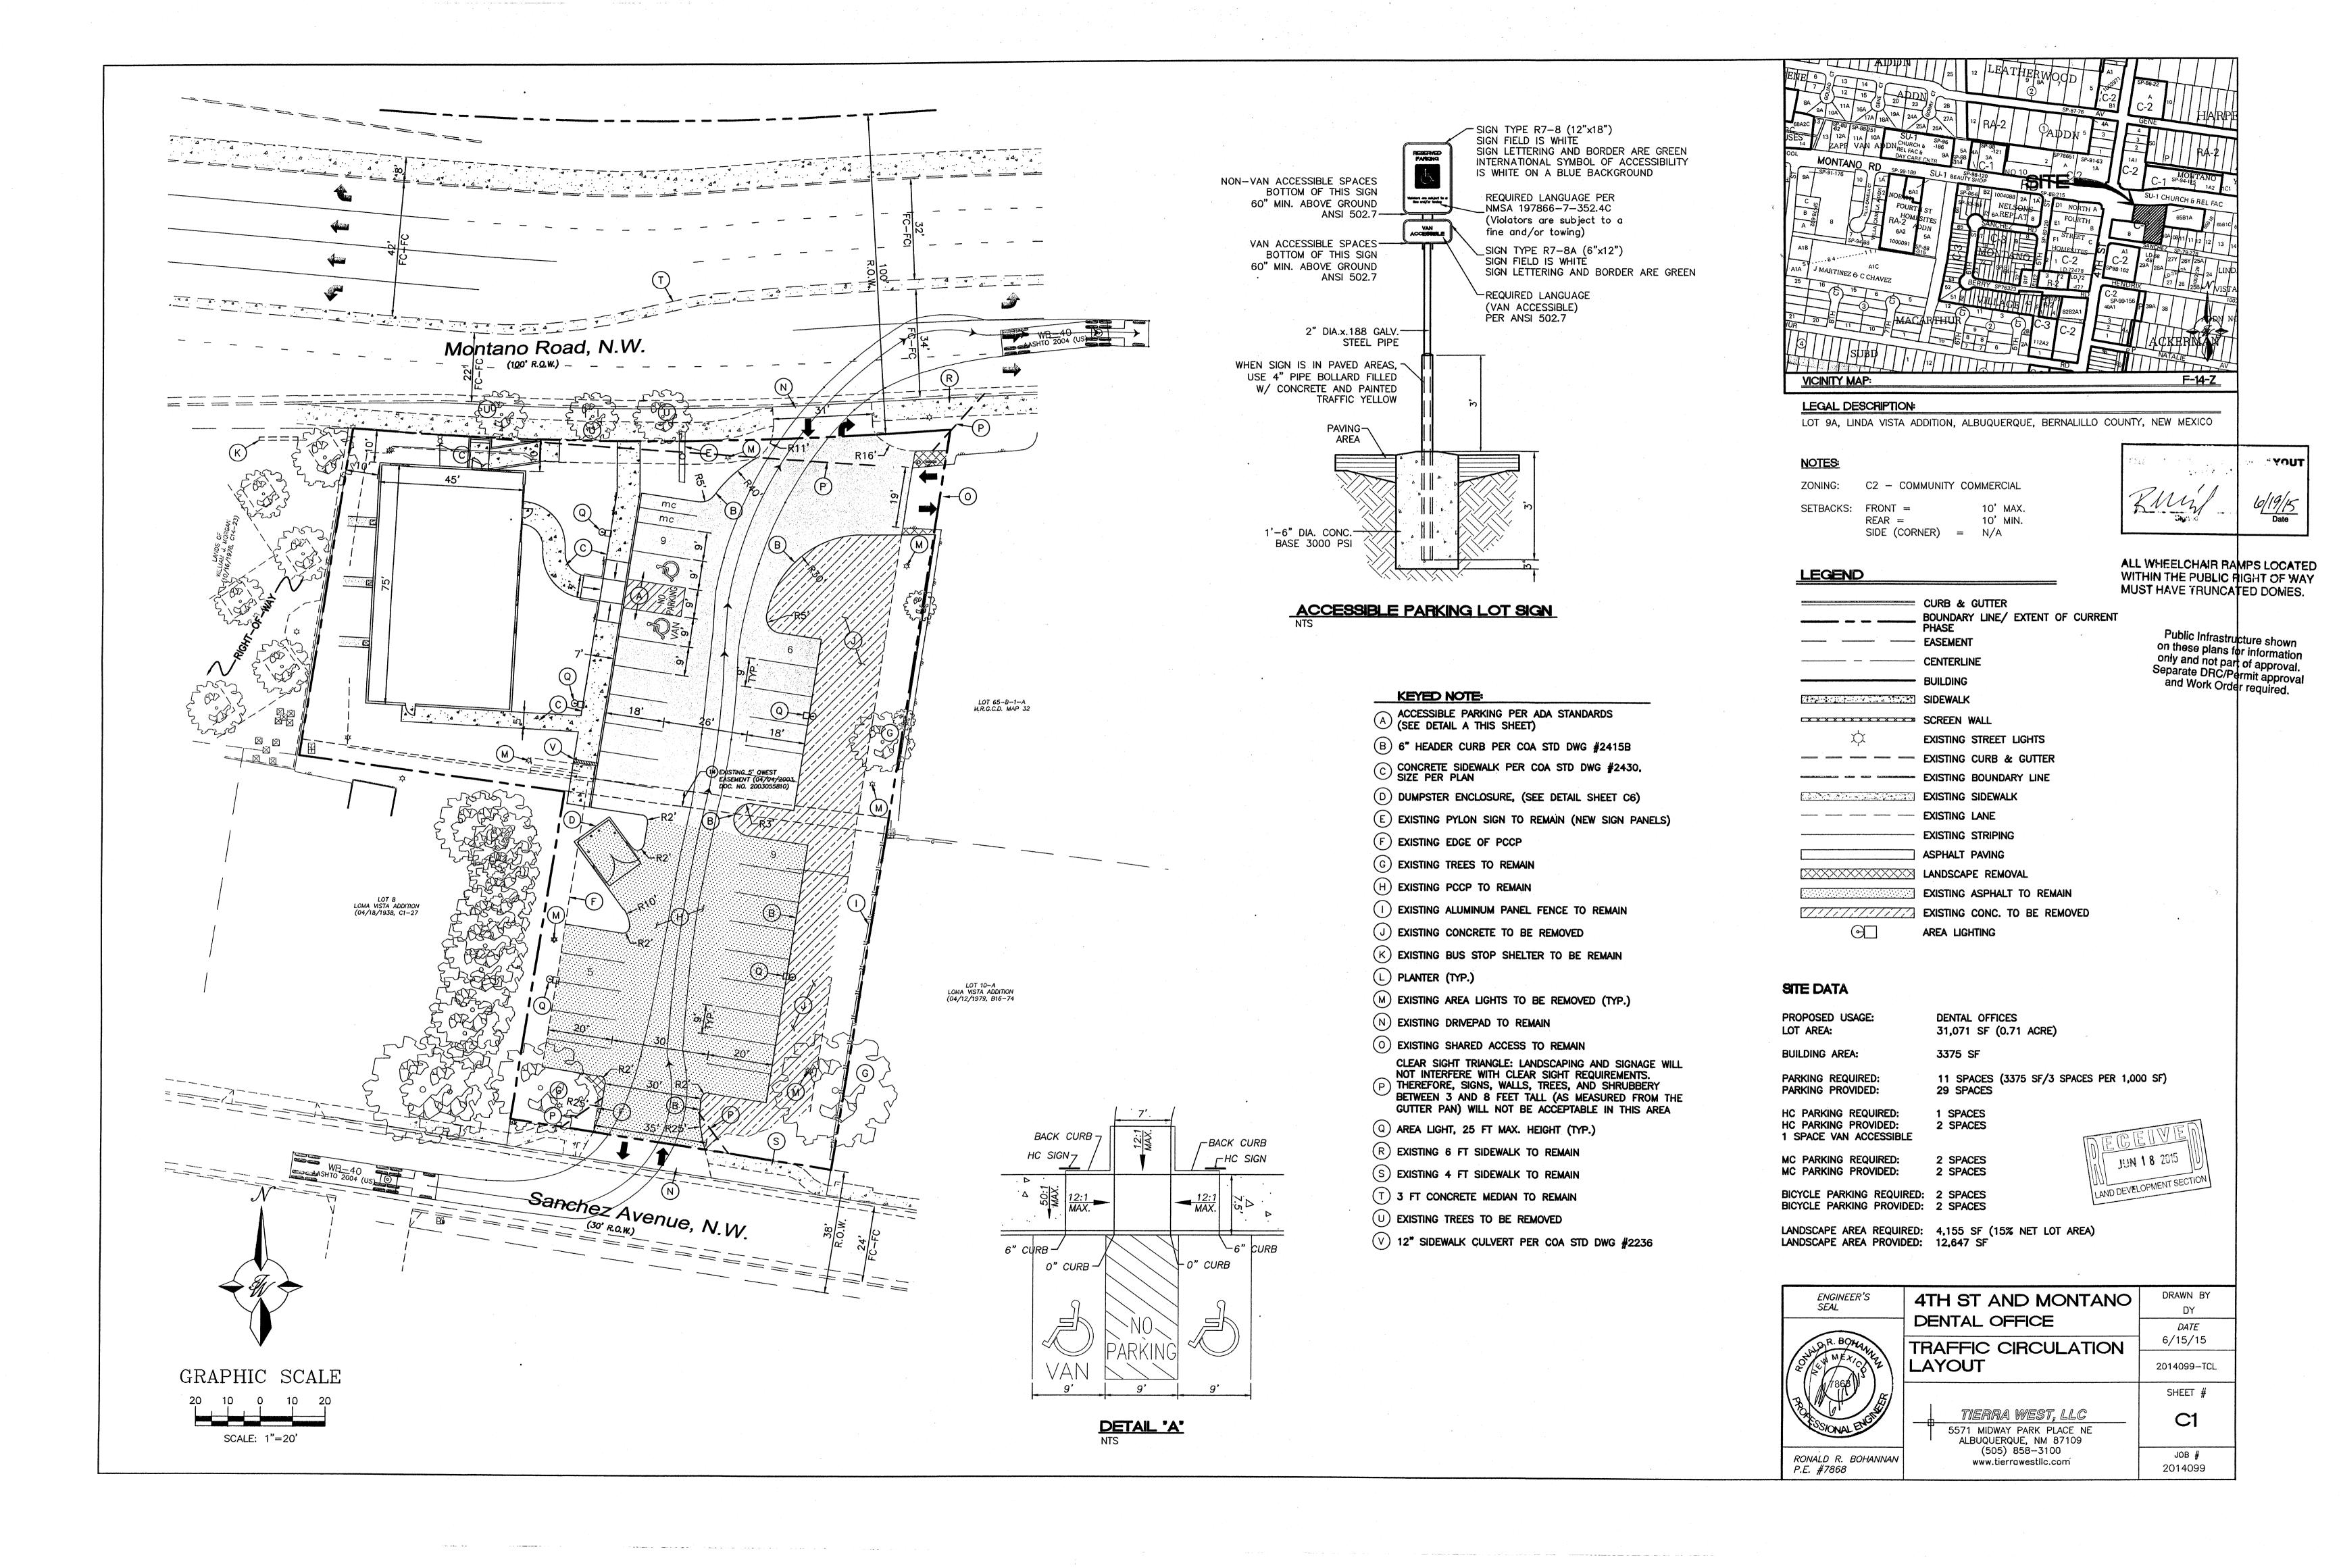- ACCESSIBLE PARKING PER ADA STANDARDS (SEE DETAIL A SHEET C6)
- (B) 6" HEADER CURB PER COA STD DWG #2415B
- C CONCRETE SIDEWALK PER COA STD DWG #2430, SIZE PER PLAN
- D DUMPSTER ENCLOSURE, (SEE DETAIL SHEET C6)
- E EXISTING PYLON SIGN TO REMAIN (NEW SIGN PANELS)
- F EXISTING EDGE OF PCCP
- G EXISTING TREES TO REMAIN
- (H) EXISTING PCCP TO REMAIN
- () EXISTING ALUMINUM PANEL FENCE TO REMAIN
- J EXISTING CONCRETE TO BE REMOVED
- (K) EXISTING BUS STOP SHELTER TO BE REMAIN
- L PLANTER (TYP.)
- M EXISTING AREA LIGHTS TO BE REMOVED (TYP.)
- DIMENSION N EXISTING DRIVEPAD TO REMAIN
 - EXISTING SHARED ACCESS TO REMAIN
 - P SIGHT TRIANGLE

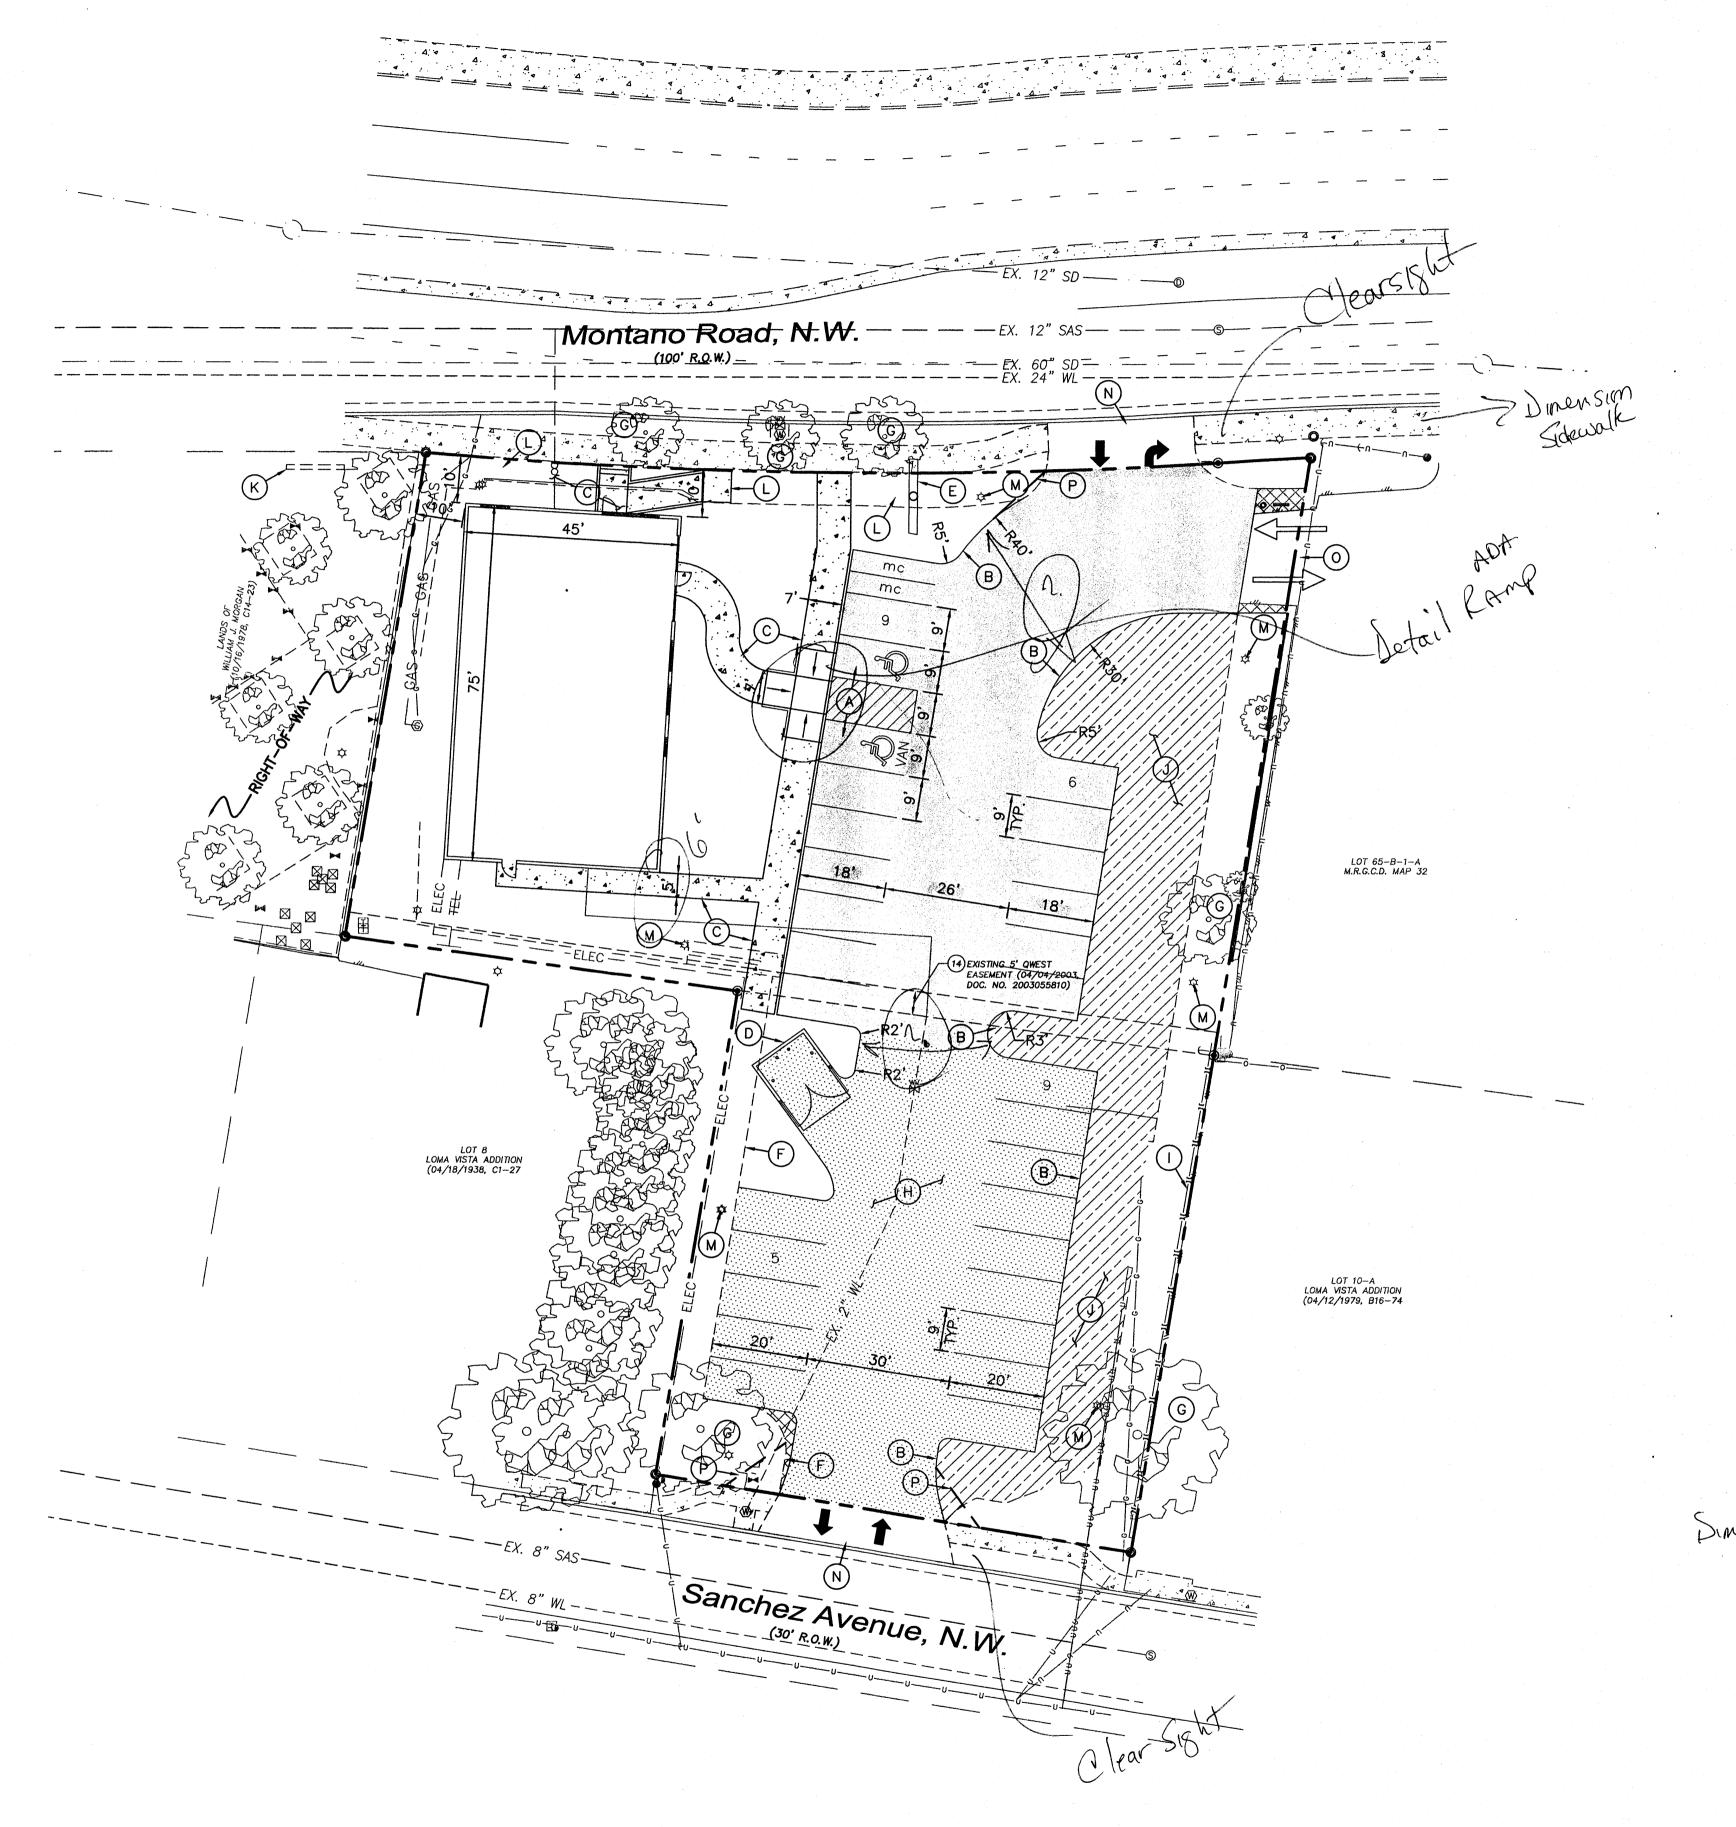

LEGAL DESCRIPTION:

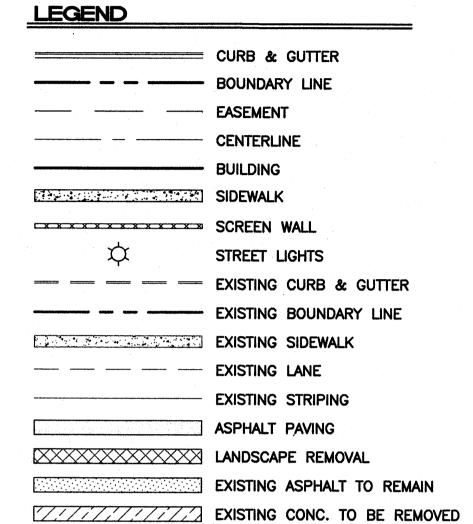LOT 9A, LINDA VISTA ADDITION, ALBUQUERQUE, BERNALILLO COUNTY, NEW MEXICO

C2 - COMMUNITY COMMERCIAL

SETBACKS: FRONT = 10' MAX.

10' MIN. SIDE (CORNER) = N/A

SITE DATA

PROPOSED USAGE: DENTAL OFFICES LOT AREA: 31,071 SF (0.71 ACRE)

BUILDING AREA: 3375 SF

PARKING REQUIRED: 11 SPACES (3375 SF/3 SPACES PER 1,000 SF) PARKING PROVIDED: 29 SPACES

1 SPACES


2 SPACES

HC PARKING REQUIRED: HC PARKING PROVIDED: 1 SPACE VAN ACCESSIBLE

MC PARKING REQUIRED: 2 SPACES MC PARKING PROVIDED:

BICYCLE PARKING REQUIRED: 2 SPACES
BICYCLE PARKING PROVIDED: 2 SPACES

LANDSCAPE AREA REQUIRED: 4,155 SF (15% NET LOT AREA)
LANDSCAPE AREA PROVIDED: 12,647 SF

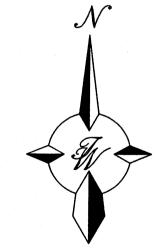

GRAPHIC SCALE


SCALE: 1"=20'

ENGINEER'S SEAL	4TH ST AND MON	
WE NE WELL	DENTAL OFFICE	
786	TRAFFIC CIRCULA LAYOUT	
SS NONAL ENGINE	_ TIERRA WEST, LL	
	ALBUQUERQUE, NM 8710	
RONALD R. BOHANNAN P.E. #7868	(505) 858-3100 www.tierrawestllc.com	

DRAWN BY AND MONTANO OFFICE DATE 5/22/15 CIRCULATION 2014099-TCL SHEET # RRA WEST, LLC DWAY PARK PLACE NE UERQUE, NM 87109 605) 858-3100

JOB #

2014099

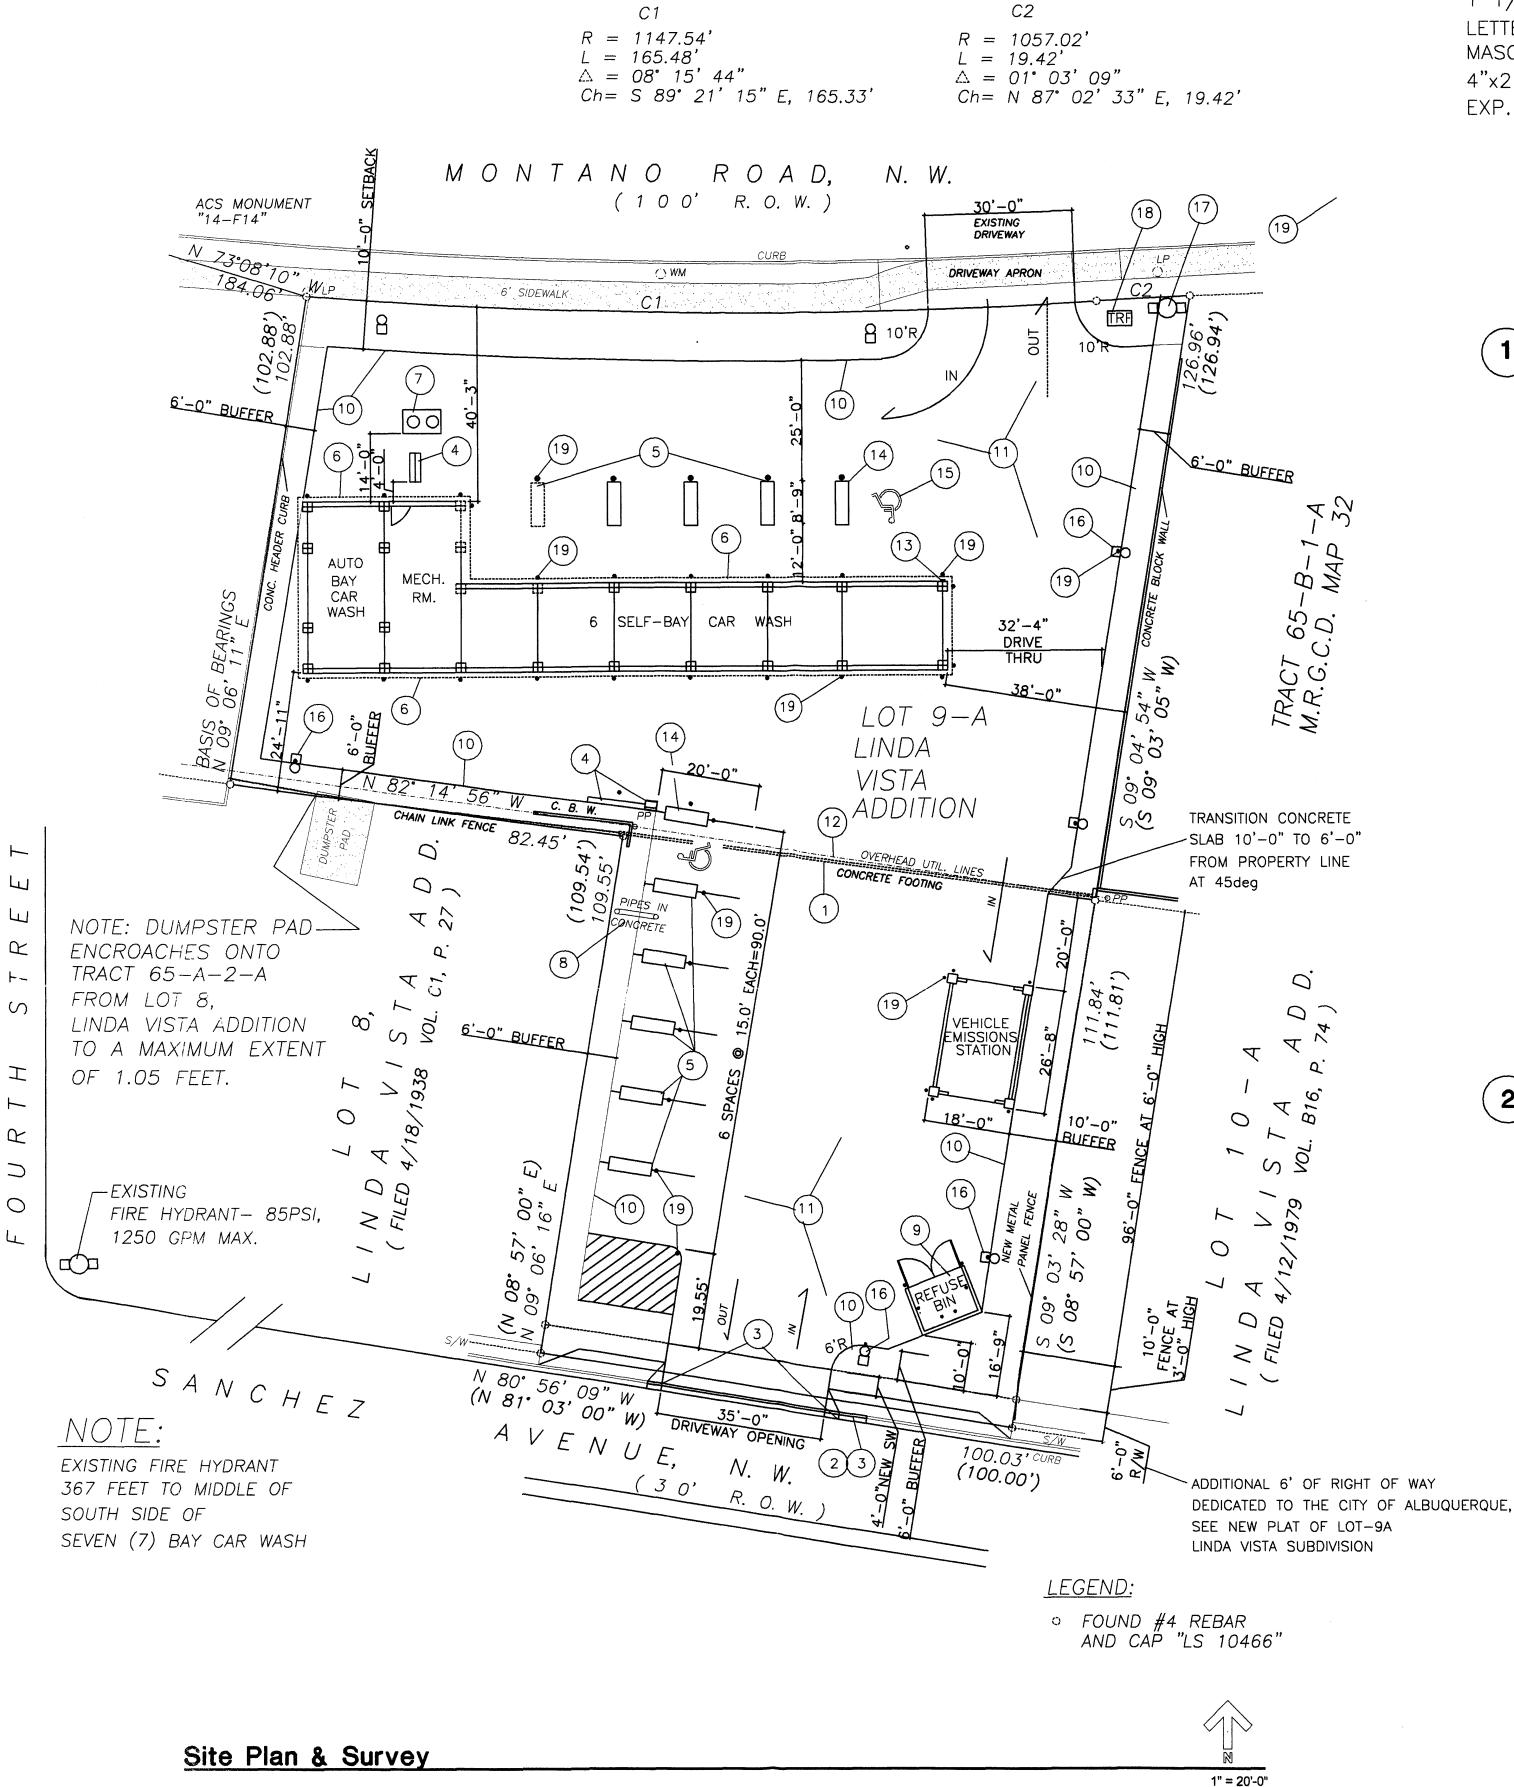

MONTANO ROAD NW HANDICAPPED 1 1/2" HELVETICA ~ VEHICLE LETTERS, SECURE TO LOCATION VAN ACCESSIBLE MASONRY WALL WITH 4"x2"x1/4"dia. EXP. ANCHOR BOLTS SANCHEZ ROAD FINISH GRADE Van Accessible Signage Vincity Map ZONE ATLAS PAGE: F-14-Z 1/2" = 1'-0" N.T.S.

95% COMPACTED

SUBGRADE

1/2" = 1'-0"

4" SQ. POST WIND RATED ← SHIELD AT 90 MPH-PROTECTED PAINT WHITE LENS - 4-3/4"dia.x 30" ANCHOR BOLT, WSHR., NUT -8-#5 REBAR VERTICAL -#4-REBAR @ 12"O.C. FINISH GRADE

Area Light

OKeyed Notes

- 1. REMOVE EXISTING CONCRETE BLOCK WALL/FOOTING
- 2. REMOVE CURB/ GUTTER/ SIDEWALK
- 3. INSTALL NEW CURB/ GUTTER/ SIDEWALK PER CITY OF ALBUQUERQUE STANDARDS
- 4. VENDING MACHINE BY OTHERS

3'-0"

- RINGER & SINK
- 5. VACUUM STATION
- 6. BUILDING FASCIA OVERHANG
- 7. SAND TRAP
- 8. REMOVE CONCRETE PIPES
- 9. REFUSE BIN- PER CITY OF ALBUQUERQUE WASTE DISPOSAL DEPARTMENT
- 10. EDGE OF CONCRETE PAVING
- 1 CONCRETE PAVING
- 12 CONTRACTOR TO CONTACT TELEPHONE COMPANY TO DIRECT BURY LINES
- 13. ACCESSIBLE SIGN- SEE DETAIL 1 THIS DRAWING C-1
- 14. ACCESSIBLE VACUUM STATION-SEE DRAWING A-2
- 15. ACCESSIBLE SIGNAGE PER ADA STANDARDS, TYPICAL OF 2, SEE DETAIL 1
- 15. AREA LIGHT- 7 TYPICAL, 18'-0" ABOVE GRADE, SHIELD PROTECTED LENS COVER, SEE DETAIL 2
- 17. NEW FIRE HYDRANT
- 18. NEW ELECTRICAL TRANSFORMER
- 19.6'dia. SCH. 80 PIPE BOLLARD, FILL WITH CONCRETE WITH CONCRETE DOME CAP, PAINT YELLOW

SEE DRAWING A-1, DETAIL 3

SUBSTANTIAL approved design drawings. COMPLIANCE 08 · 22 · 03 James W. Green Architect

Index to Drawings

- Site Plan / Project Data
- General Construction Notes/ Cals
- Grading & Drainage Plan C-2
- Landscape Plan
- Foundation Plan **S-1**
- Foundation Details/ General Notes
- Floor Plan
- A-2 Enlarged Plan/ Interior Elevations/ **Details/ Equipment Dimensions**
- Building Elevations/ Details
- **Building Sections/ Details**
- Reflected Ceiling Plan
- Roof Plan

MS-1 Mechanical Specifications

0

- US-1 Mechanical Site Utility Plan
- Plumming Floor Plan
- P-2 Partial Water & Gas Piping Plan / Partial Sewer & Vent Piping Plan
- P-3 Plumbing Details

Project Data

OWNER:

CONTRACTOR:

ARCHITECT:

ZONING:

(1)USEAGE:

OCCUPANCY:

AREA (USF)

PUMP ROOM

TOTAL

EXITS

(2)USEAGE:

OCCUPANCY:

AREA (USF)

(3)USEAGE:

OCCUPANCY:

AREA (USF)

CARPORT

TOTAL

GARAGE

TOTAL

SOAP DISPENSER/

Code Data

CONSTRUCTION TYPE: VN

CONSTRUCTION TYPE: VN

CONSTRUCTION TYPE: TYPE 2N

PROJECT DESCRIPTION: (1) NEW CAR WASH-ONE AUTO BAY CAR WASH,

LEGAL DESCRIPTION: LOT 9-A OF LINDA VISTA ADDITION UNIT 1

BMI CONSTRUCTION

141 VINEYARD NW

505- 865 -2909

505- 296-1456

340 MONTANO BLVD.

BUILDING ADDRESS: KRISP & KLEAN CAR WASH #2

C-2

7 WASH BAYS/ SALES = 2433 N/A OUTSIDE

CAR WASH

EXTERIOR USE

USF FACTOR

= 40 N/A

= 2873

EXTERIOR USE

= 480

EXTERIOR USE

USF FACTOR

= 1893 SF / 0

CANOPY

USF FACTOR

= 480 1/300

= 440 1/300

ZONE ATLAS PAGE: F-14-Z

548 PASEO DE BOSQUE

JOEL MARKS

& SIX SELF-BAY CAR WASH/

ALBUQUERQUE, NEW MEXICO 87107

ALBUQUERQUE, NEW MEXICO 87107

JAMES W. GREEN ARCHITECT, P.C.

ALBUQUERQUE, NEW MEXICO 87111

ALBUQUERQUE, NEW MEXICO 87107

1 EXIT REQUIRED, 1 PROVIDED

VEHICLE EMISSIONS STATION

OCCUPANT <u>LOAD</u>

OCCUPANT

<u>LOAD</u>

OCCUPANT

<u>LOAD</u>

0

10421 CAMINO DEL OSO NE


(2) VEHICLE EMISSIONS STATION/ (3) CANOPY

- M-1 HVAC Floor Plan
- M-2 HVAC Details & Equipmt. Schedule
- Electrical Notes & Legend
- **Electrical Site Plan**
- **Electrical Lighting Plan**
- E-4 **Electrical Power Plan**
- **Electrical One Line Diagrams** & Panel Schedules

CERTIFICATION for TRAFFIC CIRCULATION LAYOUT

21 August 2003

As Architect, I certify that Krisp & Klean Car Wash #2, has been built to

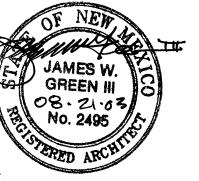

24 February 2003 © 2003 James W. Green, P.C.

> JAMES W. GREEN III 102.04-03

No. 2495


James W. Green Architect, P.C. ARCHITECTURE AND PLANNING

> 10421 CAMINO DEL OSO NE ALBUQUERQUE, NM 87111 V: 505.296.1456 C: 505.238.1397 F:505.881.9114

Krisp & Klean Car Wash #2 Marks/Hawkins, LLC 340 Montano Road NW

Albuquerque, NM

| C-1

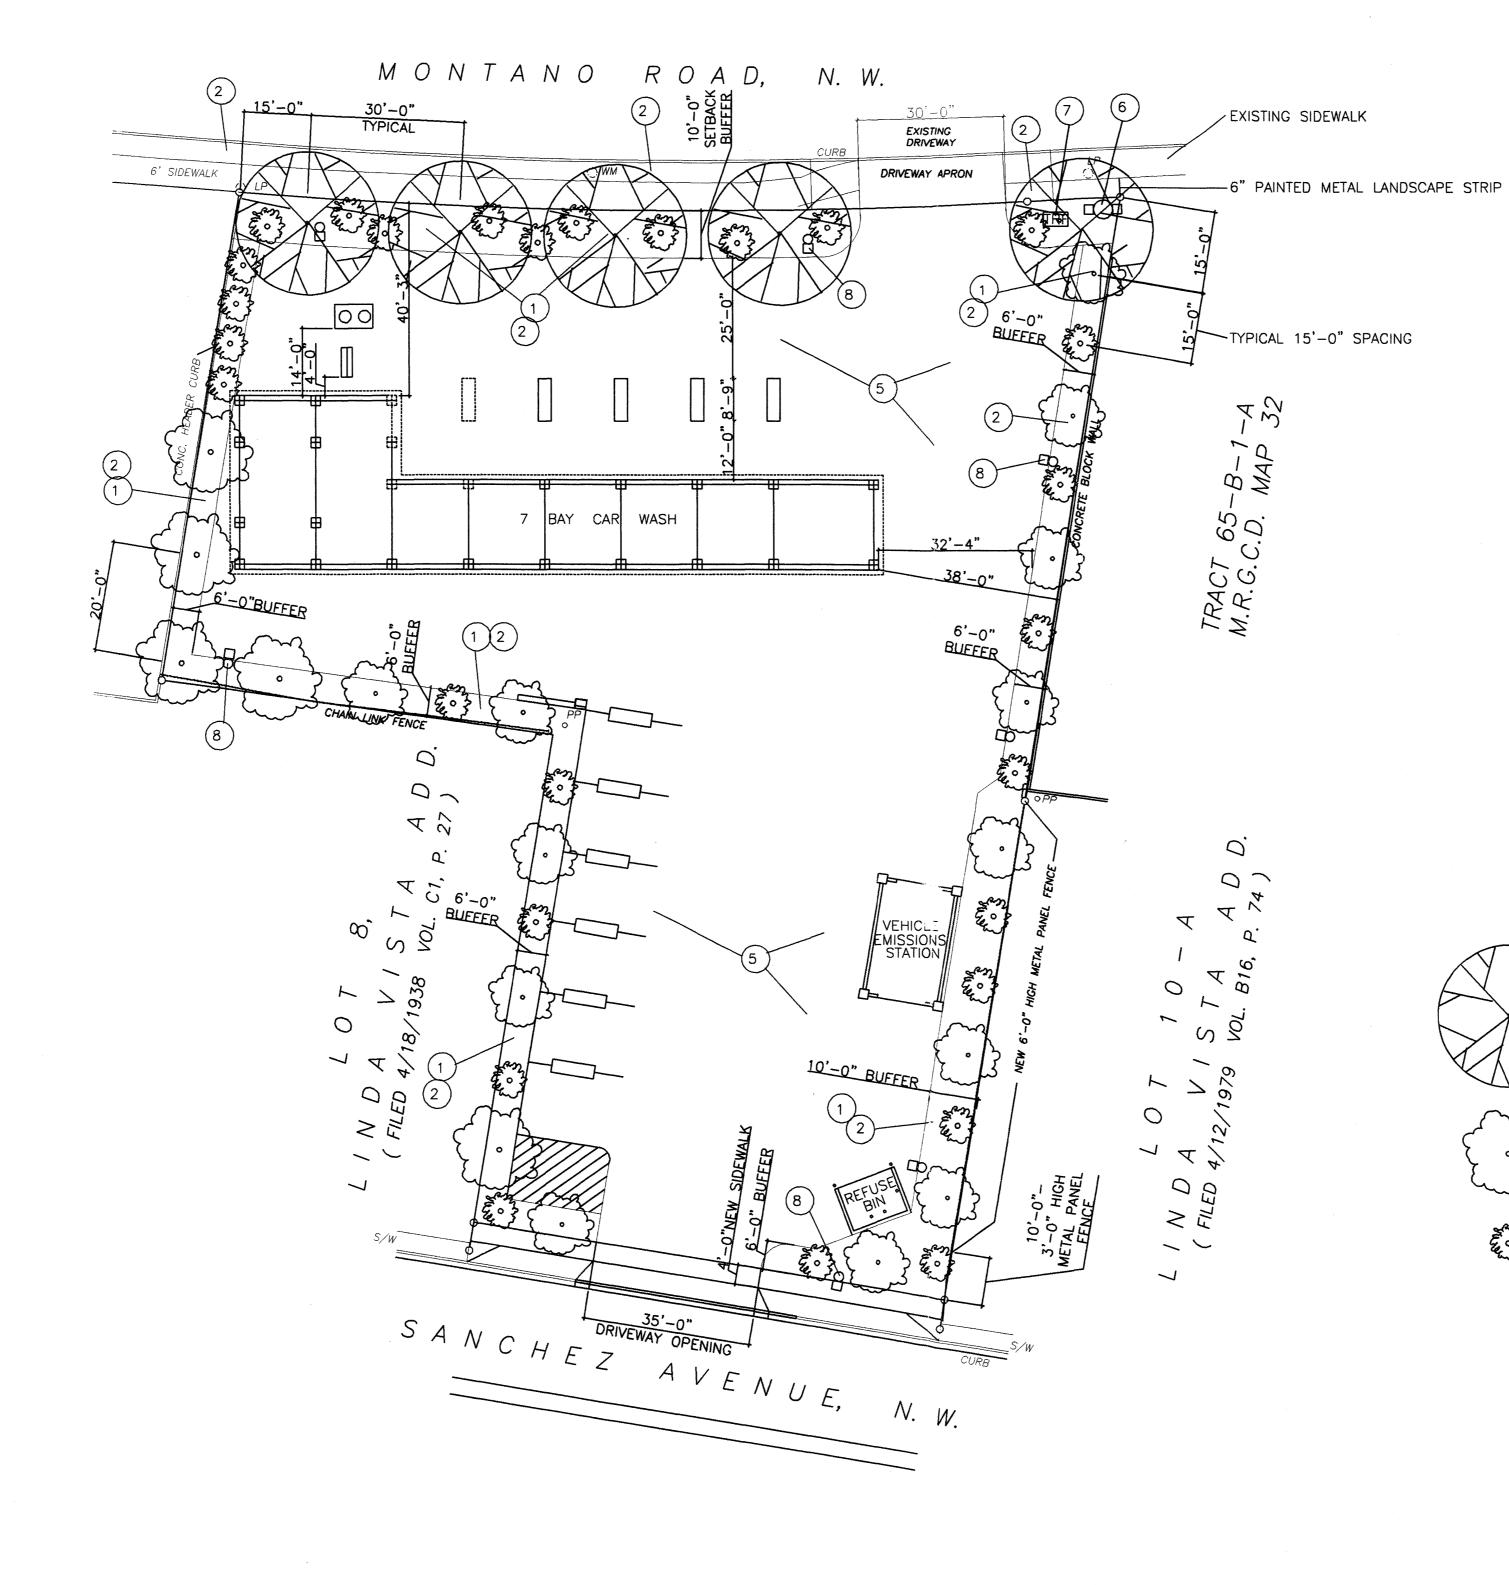


○Keyed Notes

- 1. ALL LANDSCAPING SHALL BE ON DRIP IRRIGATED SYSTEM BY AUTO TIMER AND MAINTAINED BY THE OWNER.
- 2. LANDSCAPING AREAS TO BE COVERED WITH EROSION CONTROL FABRIC AND SANTA FE 1/2' 10 3/4" GRAVEL.
- 3. STARTER TREES ARE 10 BE AT A MINIMUM OF 2" CALIPER AND 8'-0" TALL.
- 4. GRADING IN PLANTING AREAS TO BE 3inches BELOW FINISHED GRADE TO ALLOW THICKNESS OF GRAVEL.
- CONCRETE PAVING
- 6. FIRE HYDRANT
- 7. ELECTRIC TRANSFORMER
- 8. AREA LIGHT


Landscape Data

- 1. TOTAL LOT AREA: ~ 32,097 SF / 1 ACRE = 0.737 ACRES
- 2. BUILDING FOOTPRINT AREA: 7 BAY CAR WASH = 3110 SF EMISSION STATION = 480 SF TOTAL AREA = 3590 SF
- 3. REQUIRED LANDSCAPING AREA = 15% x 3590 SF = 538 SF
- 4. BUFFER LANDSCAPING AREAS AVAILABLE = 4867 SF 4867 SF > 538 SF
- 5. CONTRACTOR:
- FOR LANDSCAPING REQUIREMENTS AND MAINTENANCE SEE THE LATEST 'CITY OF ALBUQUERQUE ZONING, PLANNING AND BUILDING ORDINANCE', CHAPTER 14, ARTICLE 16.

Landscape Legend

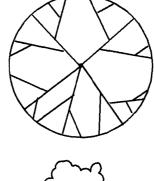

2" CALIPER MODESTO ASH AT 30'-0" SPACING

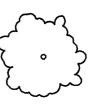

5 GAL. PAGODA AT 15'-0" TO 20'-0" SPACING



1 GAL. BLUE SAGE AT 15'-0" SPACING

NOTE:

ALL SHRUBS AND GROUNDCOVERS ARE SUFFICIENT IN NUMBER TO ACHIEVE 75% COVERAGE OF PLANTING AREAS AT MATURITY.


Landscape Plan


CERTIFICATION for TRAFFIC CIRCULATION LAYOUT

1" = 20'-0"


As Architect, I certify that Krisp & Klean Car Wash #2, has been built to SUBSTANTIAL COMPLANCE approved design drawings.

08.22.03
James W. Green Architect

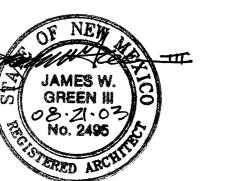

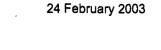

ARCHITECTURE AND PLANNING

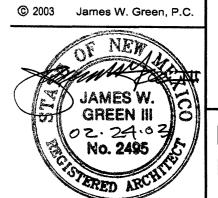


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James W. Green Architect, P.C.

Krisp & Klean Car Wash #2 Marks/Hawkins, LLC 340 Montano Road NW Albuquerque, NM



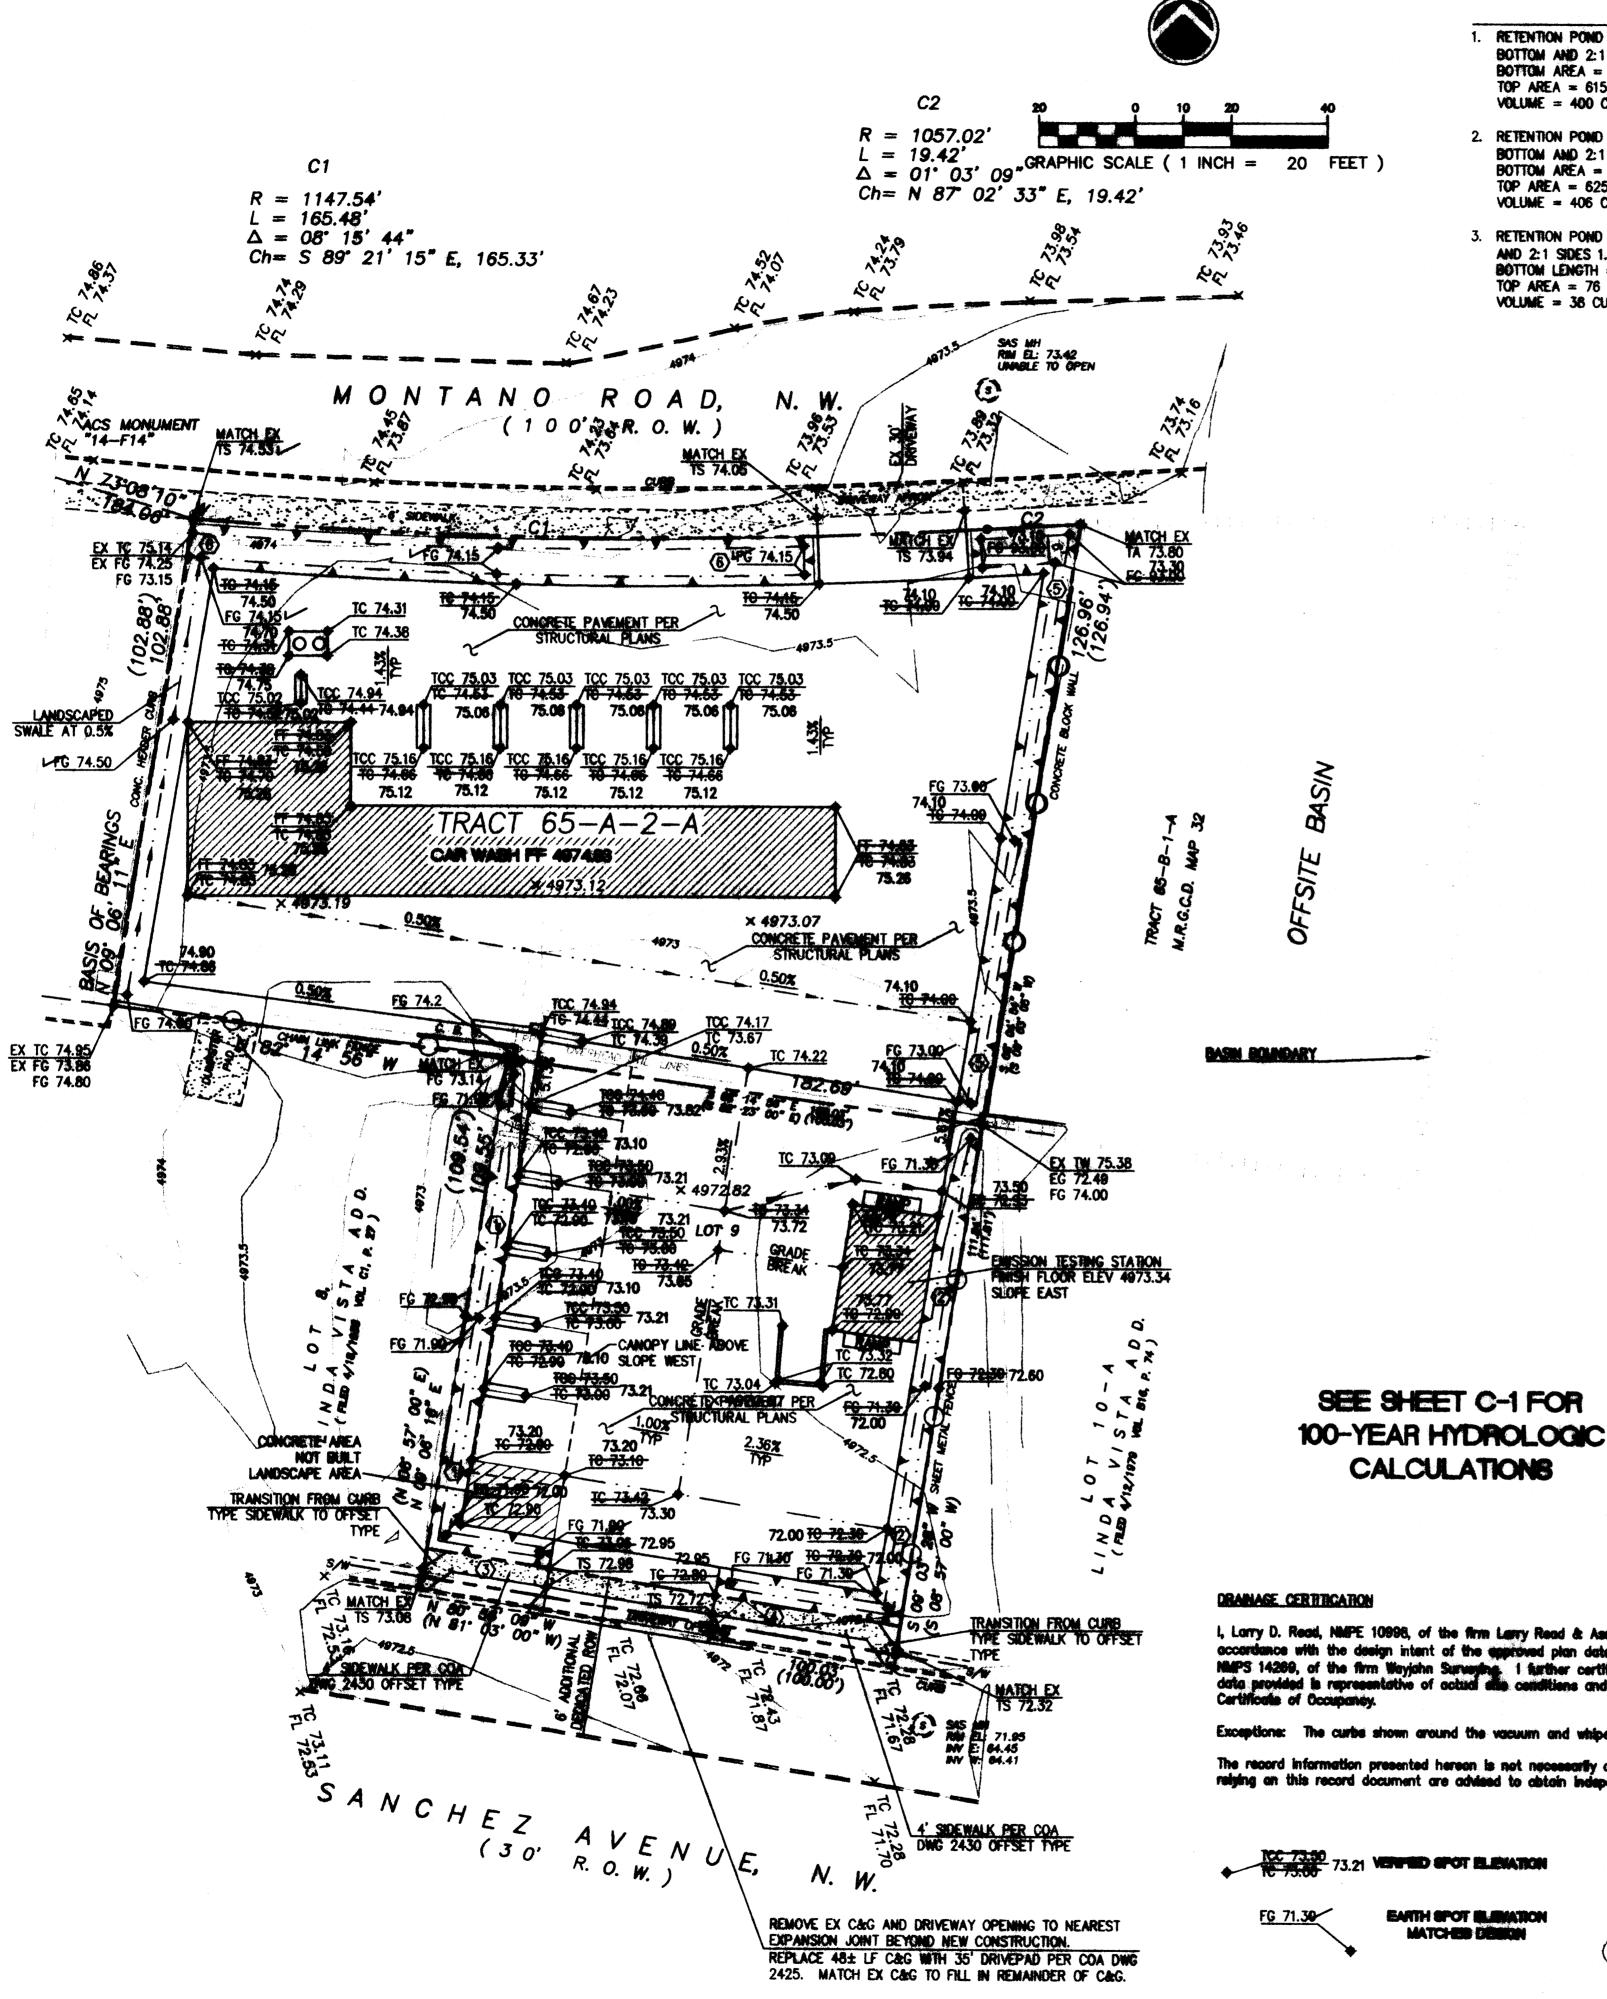

O GRADING KILY NOTE

RETENTION POND WITH 2' WIDE BOTTOM AND 2:1 SIDES 1.0' DEEP BOTTOM AREA = 185 SQ FT TOP AREA = 615 SQ FT VOLUME = 400 CU FT


2. RETENTION POND WITH 2' WIDE BOTTOM AND 2:1 SIDES 1.0' DEEP BOTTOM AREA = 187 SQ FT TOP AREA = 625 SQ FT VOLUME = 406 CU FT

3. RETENTION POND WITH "V" BOTTON WID 2:1 SIDES 1.0' DEEP BOTTOM LENGTH = 19 FT TOP AREA = 76 SQ FT VOLUME = 38 CU FT

RETENTION POND WITH "V" BOTTOM AND 2:1 SIDES 1.0' DEEP BOTTOM LENGTH = 32 FT TOP AREA = 128 SQ FT VOLUME = 64 CU FT

5. RETENTION POND WITH 2' WIDE BOTTOM AND 2:1 SIDES 1.0' DEEP BOTTOM AREA = 333 SQ FT TOP AREA = 902 SQ FT VOLUME = 617 CU FT

6. RETENTION POND WITH 5.5' AVERAGE WIDTH BOTTOM AND 2:1 SIDES 1.0' DEEP BOTTOM AREA = 693 SQ FT TOP AREA = 1224 SQ FT VOLUME = 958 CU FT

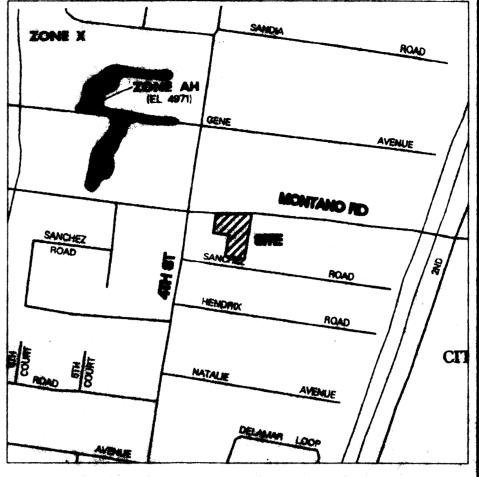

FIRM PANEL 119 (T - 500')

DRANAGE INFORMATION

THE PROPOSED SITE IS COMPRISED OF TWO (2) LOTS LOCATED AT THE SOUTHEAST CORNER OF 4TH STREET AND MONTANO ROAD, AS SHOWN ON THE VICINITY MAP ON THIS SHEET. IT IS CURRENTLY UNDEVELOPED BUT HAS BEEN GRADED USED EXTENSIVELY FOR PARKING. THEREFORE, IT IS HARD COMPACTED SOIL WITH NO VEGETATION.

THIS PROJECT, AS SHOWN ON FEMA'S FLOOD INSURANCE RATE MAP 35001C0119 D, DATED SEPTEMBER 20, 1996 IS NOT WITHIN ANY DESIGNATED 100-YEAR FLOODPLAIN. A PORTION OF THIS PANEL WITH THE SITE DESIGNATED ON IT IN INCLUDED ON THIS SHEET.

METHODOLOGY

THE HYDROLOGY FOR THIS PROJECT WAS ANALYZED USING THE QUICK CALCULATIONS OF THE JUNE 1997 RELEASE OF THE CITY OF ALBUQUERQUE DEVELOPMENT PROCESS MANUAL, SECTION 22.2.

PREPRIATOR

THE 100-YR, 6-HR AND 100-YR, 10 DAY DURATION STORM EVENTS WERE USED AS THE DESIGN STORMS FOR THIS ANALYSIS. THIS SITE IS WITHIN ZONE 2 AS IDENTIFIED IN THE CITY OF ALBUQUERQUE DEVELOPMENT PROCESS MANUAL, SECTION 22.2. TABLES WITHIN THIS SECTION WERE USED TO ESTABLISH THE 6-HOUR, 24-HOUR, AND 10-DAY PRECIPITATION VALUES, EXCESS PRECIPITATION, AND PEAK DISCHARGE.

THE SITE IS UNDEVELOPED AS DESCRIBED ABOVE IN "LOCATION AND DESCRIPTION." THERE IS A SMALL OFFSITE HE EAST SIDE OF TRACT 65-A-2-A. THIS OFFSITE BASIN WAS FIELD MEASURED. IT CONSISTS OF THE analyzed as 100% land theatment "d". This basin sheet flows onto tract 65-a-2-a. The property to the ANALYZED AS 1988 CAND THEATHERT D. THE BASIN SHEET FLOWS UNTO HRACT 65-A-2-A. THE PROPERTY BUTTLE HE WEST IS BUILT UP APPROXIMATELY GIVE FOOT (1") ABOVE TRACT 65-A-2-A WITH A HEADER CURB AND CONCRETE PAD THAT GRANDS TO MONTANO ROAD. LOT 19-A, TO THE EAST OF LOT 9, HAS BEEN DEVELOPED AND HAS A SHEET METAL FENCE THAT PREVENTS RUMBET FROM ENTERING LOT 9 AND LOT 8 IS DEVELOPED WITH A MINOR POND ABJACENT TO THIS PROPERTY. MONTANO ROAD AND SANGHEZ AVENUE ARE DEVELOPED ASPHALT STREETS WITH CURB AND GUTTER TO CONVEY THE PLANEST AWAY FROM THE SITE. THEREFORE, THERE ARE NO OTHER OFFSITE BASINS TO EVALUATE FOR THIS DEVELOPMENT. THE EDISTING GROUND ON TRACT 65-A-2-A IS BELOW THE SIDEWALK ELEVATION ON MONTAND WIND HAS A SLIGHT SLOPE ACROSS LOT 8 WHERE BOTH LOTS HAVE FREE DISCHARGE INTO SANCHEZ AVENUE

THE CASE CONTROL

ALTHOUGH BOTH LOTS ARE BEING DEVELOPED AS A SINGLE BUSINESS, THEY WILL NOT BE REPLATTED INTO A SINGLE LOT. THEREFORE, EACH LOT IS ANALYZED INDEPENDENTLY. TRACT 65-A-2-A WILL BE FILLED APPROXIMATELY 1.7' AT THE BUILDING IN CROSE TO PROVIDE ADEQUATE DRAINAGE TO RETENTION PONDS WITHIN THE LANDSCAPE AREAS ALONG MONTANO ROAD AND THE EAST PROPERTY LINE. SEE KEY NOTES 5 AND 6 FOR POND SIZES. THE COMPINED VOLUME OF THESE TWO (2) PONDS IS 1575 CUBIC FEET. THIS IS SLIGHTLY MORE THAN THE 1526 CUBIC FOOT INCREASE IN RUNOFF VOLUME FOR THIS TRACT (100-YEAR, 6-HOUR EVENT). ONCE THESE PONDS FILL THEY WILL OVERTOP THROUGH THE DRIVEWAY ONTO MONTANO ROAD. SIMILARLY, LOT 9 WILL BE GRADED DIVIDING THE LOT IN HALF WITH RUNOFF ENTERING RETENTION PONDS WITHIN THE LANDSCAPE AREAS. THE COMBINED VOLUME OF THE LOT 9 RETENTION PONDS IS 908 CUBIC FEET (KEYED NOTES 1 THROUGH 4). LIKEWISE THIS IS SLIGHTLY OVER THE 822 CUBIC FOOT INCREASE IN RUNOFF GENERATED BY THE 100-YEAR, 6-HOUR STORM EVENT. THESE PONDS WILL ALSO OVERTOP THE DRIVEWAY INTO SANCHEZ AVENUE IN THE LARGER STORM EVENTS.

THEREFORE, THIS SITE CAN BE DEVELOPED ACCORDING TO THIS GRADING AND DRAINAGE PLAN AND STILL ACCEPT THE OFFSITE RUNOFF. SMALL EVENT STORMS WILL BE CONTAINED ONSITE, AND THE LARGER ONES WILL DISCHARGE TO THE STREETS WITHOUT CREATING AN ADVERSE IMPACT ON DOWNSTREAM PROPERTIES. THE BUILDING WILL ALSO BE CONSTRUCTED ABOVE MONTANO DRIVE SO IT IS PROTECTED FROM THE 100-YEAR STORM EVENT.

I, Larry D. Read, NMPE 10998, of the firm Larry Read & Associates, Inc., hereby certify that this project has been graded and will drain in substantial compliance with and in accordance with the design intent of the approved plan dated 1/3/03. The recert information edited anto the editinal design document has been obtained by Thomas Johnston, NMPS 14269, of the firm Wayjohn Surveying. I further certify that I have persently visited the project alte on 8/18/2003 and have determined by itsued inspection that the survey data provided in representative of actual also conditions and is true and correct to the best of my thresholds. This certification is submitted in support of a request for Certificate of Occupancy.

shown around the vacuum and whipedown areas more not constructed. The equipment is set at top of concrete elevation.


ord information presented hereon is not necessarily complete and intended only to verify substantial compliance of the Grading and Drainage aspects of this project. Those on this record document are advised to obtain independent verification of its accuracy before using it for any other purpose.



EARTH SPOT ELEVATION MATCHES DESIGN

CALCULATIONS



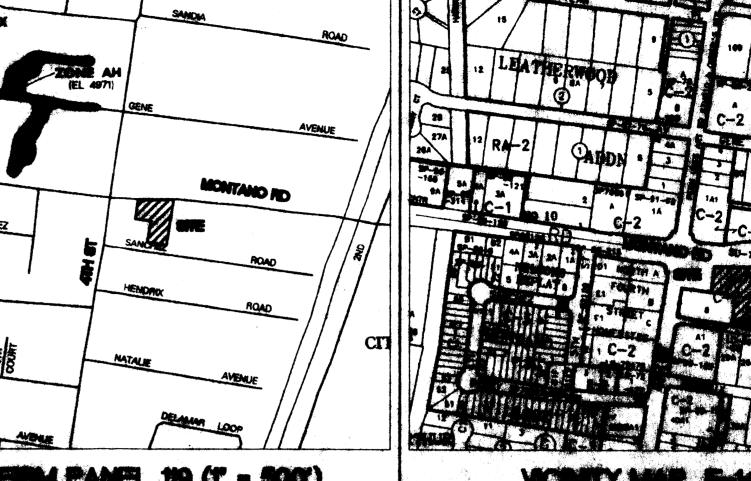

LEGAL DESIGNATION

TRACT 65-A-2-A, MRCCO MAP 32 AND LOT 9 LINDA VISTA AREFRED UNIT 1, AS SHOWN AND DESIGNATED ON THE PLAT OF SUB-SUBTRIBUTE. FILED IN THE OFFICE OF THE COUNTY CLERK OF BERNALILLO COUNTY. NEW MEDICO ON APRIL 18, 1938 IN PLAT BOOK C1, POLIO 27

ACS BENCHMARK

ACS MONUMENT "14-F14A", BEING AN ACS MONUMENT, WITH AN ELEVATION OF 4974.616 (SLD 1929).

TEMPORARY BENCHMARK

REBAR FOUND AR THE NORTHWEST PROPERTY CORNER WITH AN ELEVATION OF 4874.53.

SURVEY NOTES

WELD SURVEY BY: WAYJOHN SURVEYING IN SURVEY DATE: SEPT., 2002 FAN: (505) 256-2887

THE FACT THAT SOME UTILITIES MIGHT BE LIFT OUT. IT IS THE RESPONSIBILITY OF THE CONTRACTOR TO CONTACT BALE STATE AND ANY OTHER REVOLVED AGENCIES TO LOGATE ALL UTILITIES PRIOR TO

THIS IS NOT A BOUNDARY SURVEY AND SHOULD NOT BE USED BY THE CHINER AS SUCH.

PLOODPLAN

THE PROBERTY SHOWN HEREON DOES NOT LIE WITHIN ANY DESIGNATED PLOCENCIAN PER THE PASSED INSURANCE RATE MAY OF THE CITY OF ALBUQUERQUE, BERNALLLO COUNTY, NEW MEXICO, COMMUNITY-PANEL NO. 35001C0119 D; EFFECTIVE BATE SEPTEMBER 20, 1986 AS SHOWN ON THIS SHEET.

LARRY READ & ASSOCIATES Civil Engineers

4800-C Juan Tabo, NE Albuquerque, New Mexico 87111 (505) 237-8421

GRADING AND DRAINAGE PLAN

	Revisions	
Drawn by	Hom	
Checked by		

21 November 2002

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James W. Green Architect, P.C ARCHITECTURE AND PLANNING



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Kristov Klean Car Wash #2 Marks/Hawkins, LLC

Montano Road, NW Albuquerque, NM

C-2

SHEET NO