CITY OF ALBUQUERQUE



Richard J. Berry, Mayor

July 7, 2017

Scott McGee, P.E. 9700 Tanoan Drive NE Albuquerque, NM, 87111

RE: 12th Street NW Townhomes Grading and Drainage Plan Stamp Date: 6/28/17 Hydrology File: F14D074

Dear Mr. McGee:

PO Box 1293

Based upon the information provided in your submittal received 6/29/2017, the Grading Plan **is not** approved for Building Permit. The following comments need to be addressed for approval of the above referenced project:

Albuquerque

New Mexico 87103

www.cabq.gov


- 1. Under your drainage calculations, it appears that your estimate of the existing land treatment is off. As you stated there was once a house on the property, but this has been demolished with the existing foundation remaining. It appears to me that the majority of the property is not in its native state so it should be placed under treatment C. Please revise your existing drainage calculations.
- 2. Please provide the first flush pond volumes for the two interior ponds which are connected by a 4 in pipe.
- 3. Please provide a typical detail for the turned CMU block. This block needs to be at least four (4) inches above the proposed grade to avoid clogging.

If you have any questions, please contact me at 924-3995 or rbrissette@cabq.gov.


Sincerely,

Renée C. Brissetto

Reneé C. Brissette, P.E. Senior Engineer, Hydrology Planning Department

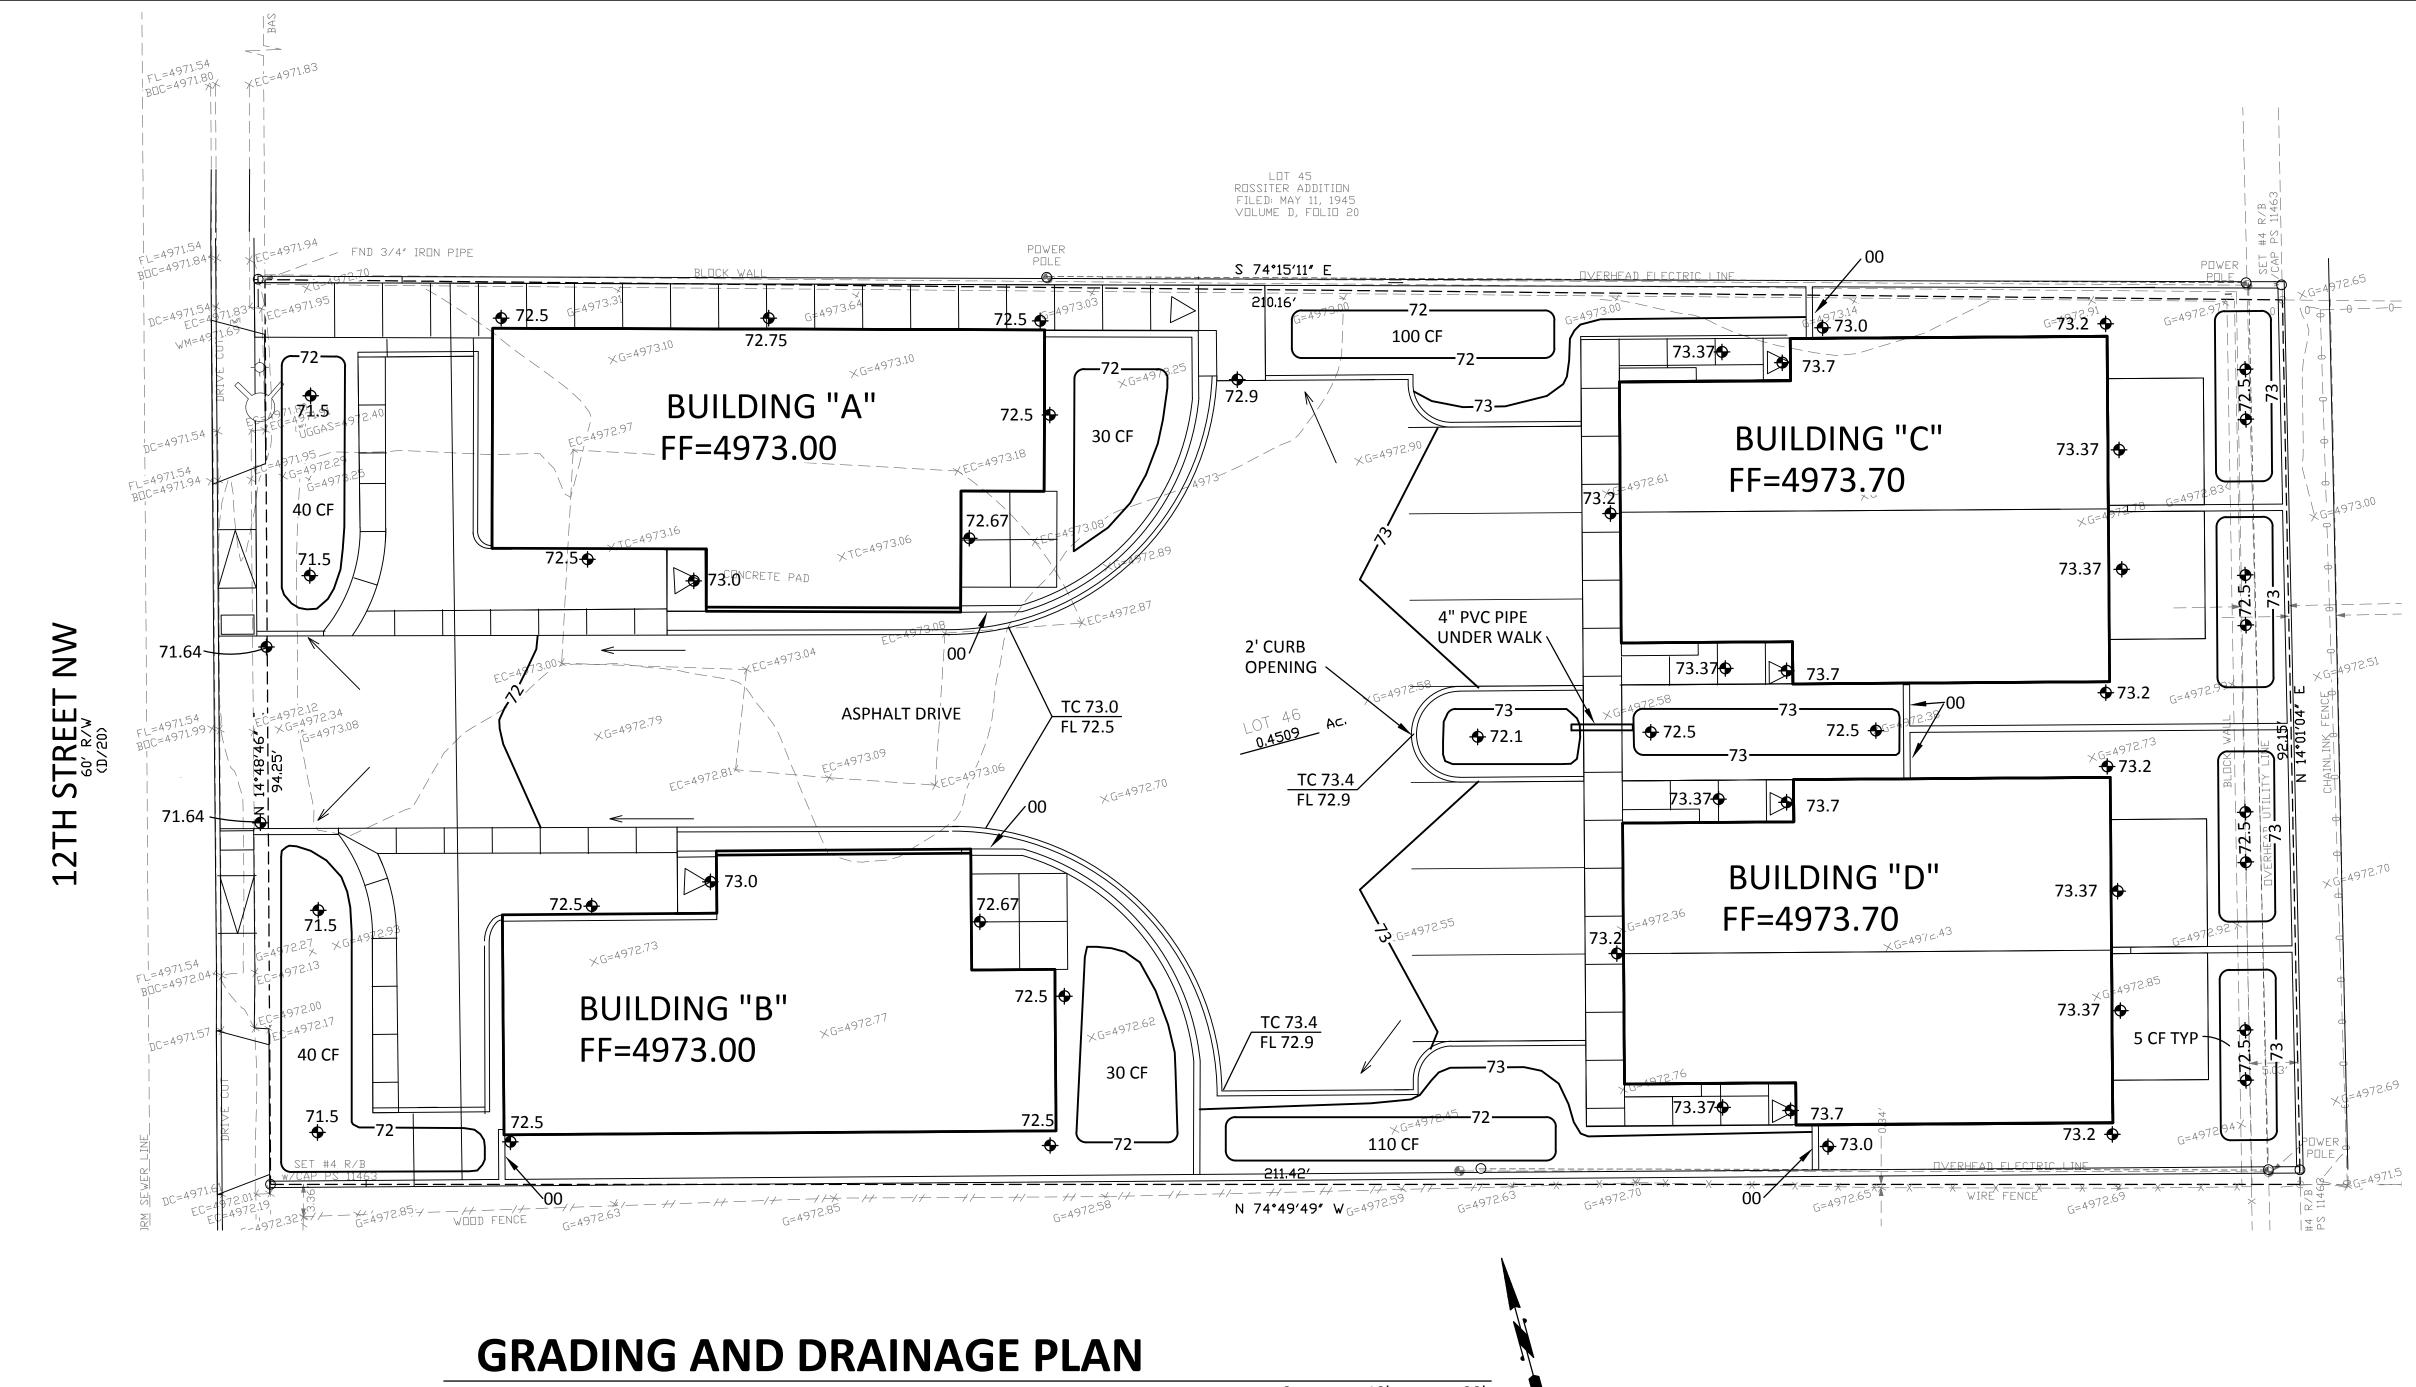

1" = 10'

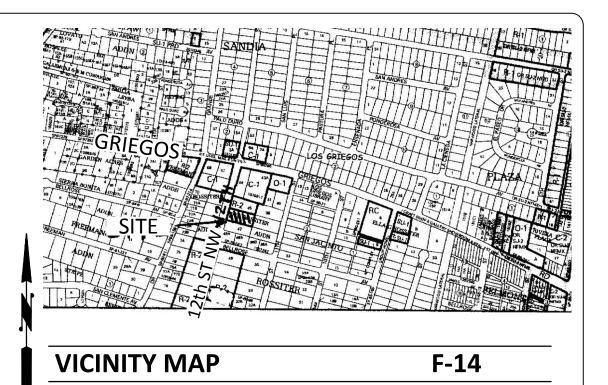

DRAINAGE INFORMATION

NOT TO SCALE

ADDRESS: 4622 12th Street NW, Albuquerque, NM LEGAL DESCRIPTION: Lot 46 Rossiter Addition SITE AREA: 19,640 SF (0.4509 acres)

BENCHMARK: City of Albuquerque Control Station 'DOUGLAS' being a brass cap ELEV= 4975.078 (NAVD 1988)

SURVEYOR: The Survey Office dated August, 2016 PRECIPITATION ZONE: 2

FLOOD HAZARD: From FEMA Map 35001C0119G (9/26/08), this site is identified as being within Zone 'X' which is located within the area of 0.2% annual chance flood, area of 1% annual chance flood with average depths < 1' or drainage areas <1 square mile, and areas protected by levees from 1% annual chance flood.

EXISTING CONDITIONS: The site is presently vacant but a residence was on the lot previously and a slab remains. The site is very flat but does discharge to 12th Street NW.

OFFSITE FLOW: No offsite flow enters the site.

PROPOSED IMPROVEMENTS: The proposed improvements include 4 townhome buildings with an interior access drive, paved parking, and landscape areas.

DRAINAGE APPROACH: The site drainage pattern will remain unchanged as runoff will continue to pond onsite but will discharge west per historic conditions.

Existing land treatment: 50% A, 45% B, & 5% D Precipitation Zone: 2

Q = (0.225)(1.56)+(0.203)(2.28)+(0.022)(4.7)=0.9 CFS

Proposed land treatment: 6% B, 29% C and 65% D Q= [(0.06)(2.28)+(.29)(3.14)+(.65)(4.7)](0.4509)= 1.8 CFS

First flush V= (12,770) (0.34/12) = 362 CF Onsite pond volumes = 100+ 110+ 80+ 60= 350 CF Backyard pond volumes (4) (5 CF) = 20 CF Total V = 370 CF (> 362 OK)

The proposed detention ponding areas contain the first flush volume. Runoff increases slightly but there will be no adverse impact on downstream drainage facilities.

LEGEND			
71	EXISTING CONTOUR LINE	Cinelli / Roger Cinelli & Assoc 2418 Manuel Torres Lane N.W.).
72	NEW CONTOUR LINE	Albuquerque, New Mexico 87107 (505) 243-8211	
FF = 4973.00	FINISH FLOOR ELEVATION		
• 23.5	NEW SPOT ELEVATION		
TC	TOP OF CURB		
FL 00	FLOW LINE TURNED CMU BLOCK AT GRADE	4622 12th STREET NW ALBUQUERQUE, NEW MEXICO	
		DRAWING TITLE:	
		GRADING & DRAINAGE PLAN	
		SEAL DATE PROJECT NO. June 2017	
		DRAWING NO. DRAWING NO. CIVIL102	