

# CITY OF ALBUQUERQUE



September 25, 2017

Jeffery Lucero  
Miller Engineering Consultants, Inc.  
3500 Comanche NE  
Albuquerque, NM 87107

**RE: T-Mobile on 4<sup>th</sup> St  
Grading Plan  
Engineers Stamp Date: 7/20/17  
Hydrology File: F14D075**

Dear Mr. Lucero:

PO Box 1293

Based on the information provided in your submittal received on 8/25/17, the Grading Plan is approved for Building Permit with the following conditions:

Albuquerque

1. Prior to Hydrology approval for Certificate of Occupancy, a Bernalillo County Recorded Drainage Covenant is required for the pond.
2. Prior to Hydrology approval for Certificate of Occupancy, close-out of the public work order is required.

NM 87103

If you have any questions, you can contact me at 924-3695 or [dpeterson@cabq.gov](mailto:dpeterson@cabq.gov).

[www.cabq.gov](http://www.cabq.gov)


Sincerely,

Dana Peterson, P.E.  
Senior Engineer, Planning Dept.  
Development Review Services




T:\Projects\Clint Wilsey Architect\T-Mobile\Area\Sheets\Grading & Drainage\Plan\_6-14-17.dwg, CD REPORT C04\_C-001, 8/24/2017 3:50:06 PM, jacquez, t

8/24/2017 3:59 PM

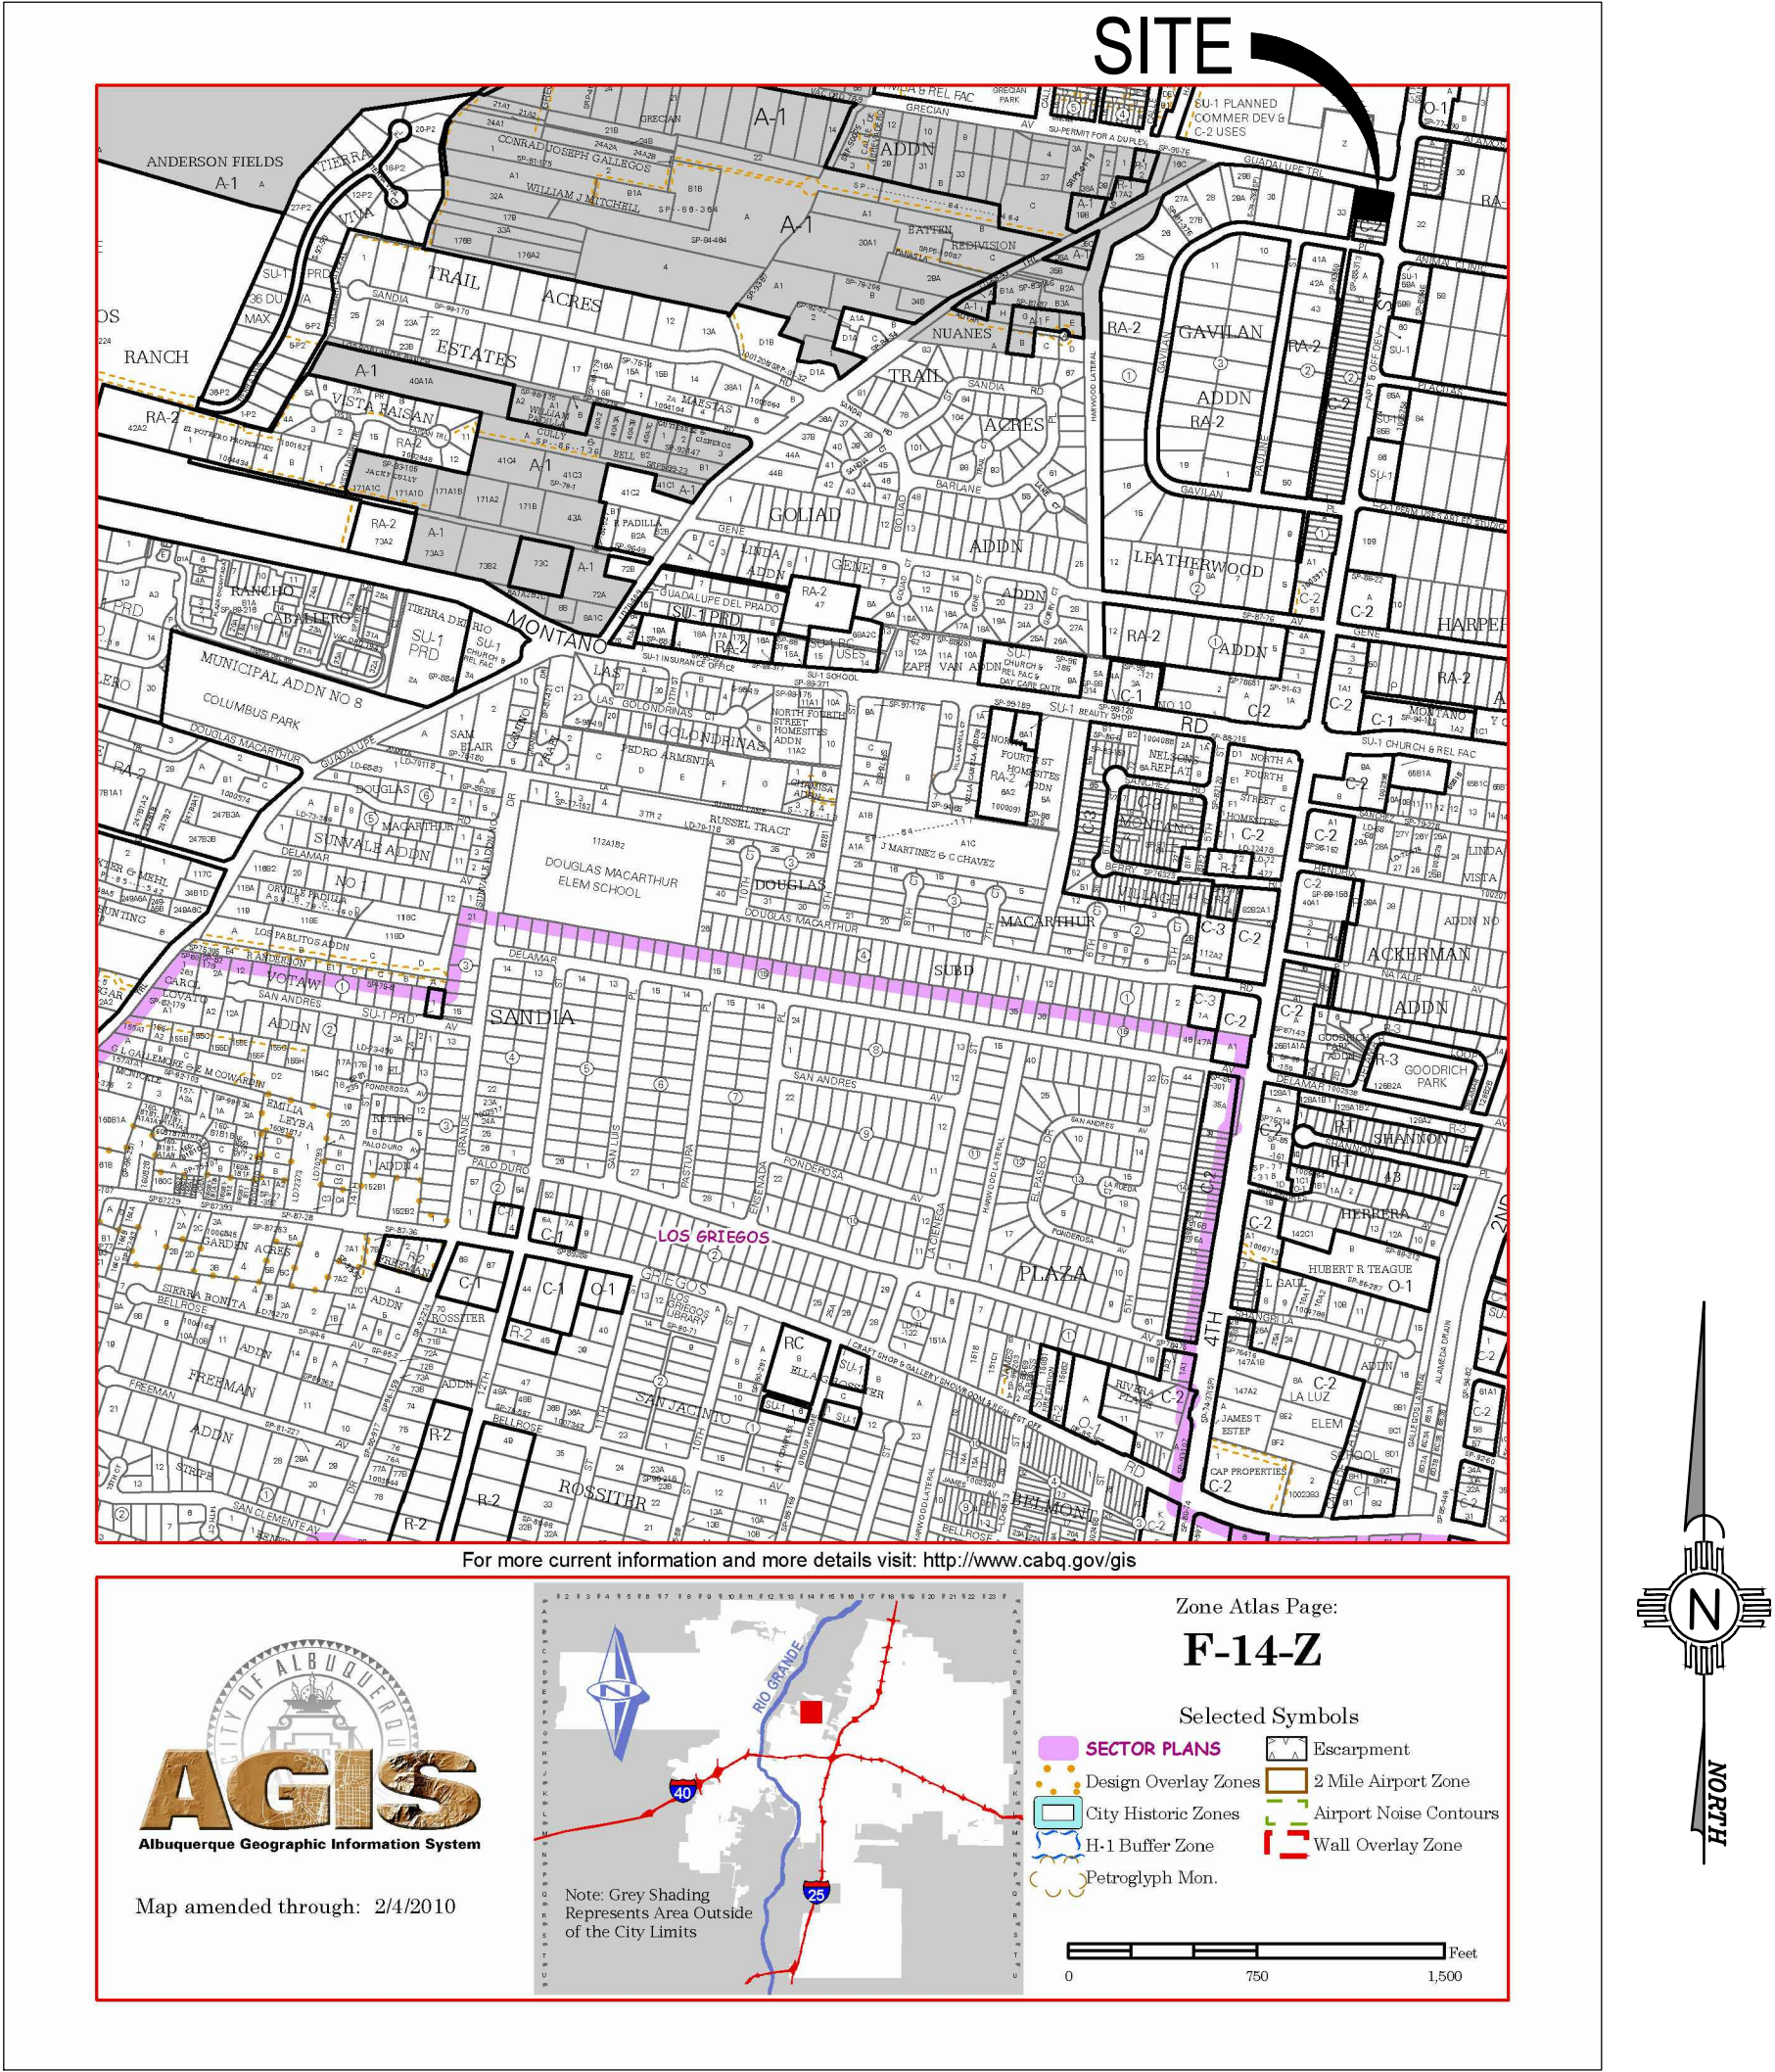

**C1 VICINITY MAP**

ZONE ATLAS MAP F-14-Z

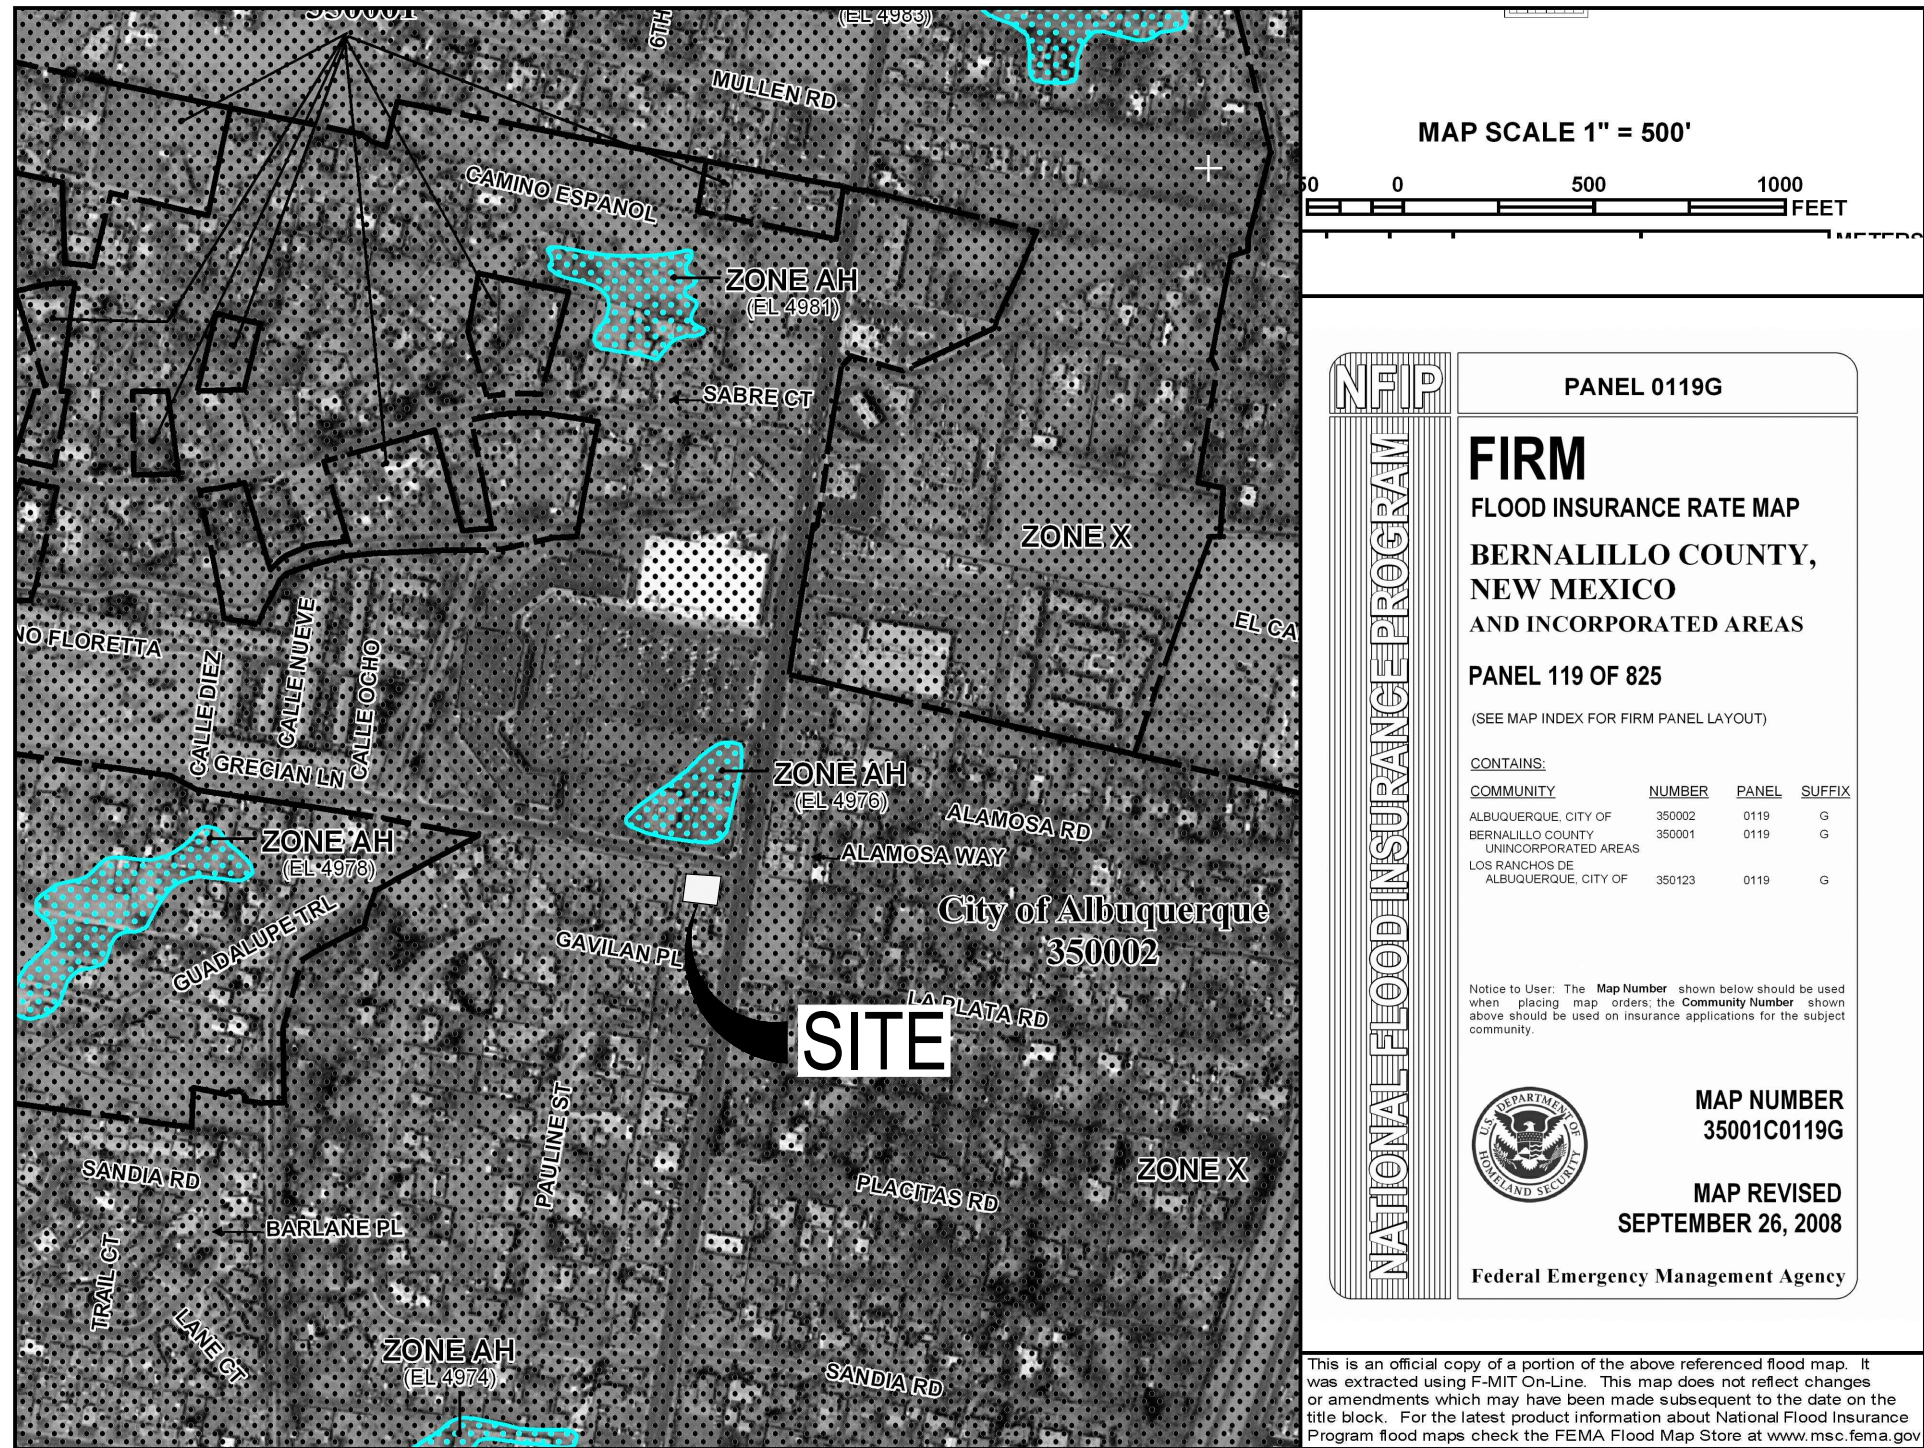

**A1 FLOOD ZONE MAP**

FLOOD ZONE MAP: 35001C0353H

**SITE LOCATION**

T-MOBILE IS LOCATED AT 6015 4th STREET N.W. IN ALBUQUERQUE, NM. THE BOUNDARY IS RECTANGULAR IN SHAPE AND BOUNDED BY EXISTING RESIDENCES TO THE WEST, EXISTING BUSINESS AND RESIDENCES TO THE SOUTH, AN EXISTING RESIDENCES AND GUADALUPE TRAIL N.W. TO THE NORTH, AND 4TH STREET N.W. TO THE EAST.

**EXISTING ON SITE CONDITIONS**

THE SITE IS PARTIALLY DEVELOPED WITH AN EXISTING BUILDING AND AN EXISTING ASPHALT PAVED PARKING AREA ALONG 4TH STREET. THE SITE IS ACCESSED FROM 4TH STREET ON THE EAST SIDE OF THE SITE. THE PROPERTY HAS ONE DRAINAGE BASIN, WHICH IS IDENTIFIED AS BASIN A. THIS REPORT FOCUSES ON THE PRE AND POST HYDROLOGY. BASIN A DRAINS TO THE WEST SOUTHWEST INTO AN EXISTING ALLEY ADJACENT TO THE SITE ON THE WEST SIDE VIA SURFACE FLOWS. THE DRAINAGE DATA ON THIS PAGE SUMMARIZES THE EXISTING PEAK DISCHARGE AND RUNOFF VOLUME FOR BASIN A.

**PROPOSED CONDITIONS**

THE PROPOSED DEVELOPMENT OF THE SITE WILL CONSIST OF 2800 SQUARE FOOT BUILDING, ASSOCIATED CONCRETE FLATWORK, SIDEWALKS, ASPHALT PARKING LOT, AND LANDSCAPING. THE PROPOSED IMPROVEMENTS ARE ALL LOCATED IN PROPOSED DRAINAGE BASIN A. A SMALL PORTION OF BASIN A WILL FREE DISCHARGE INTO 4TH STREET AND GUADALUPE TRAIL VIA SURFACE FLOW. THE REMAINDER OF BASIN A, INCLUDING THE PROPOSED BUILDING WILL DISCHARGE INTO THE WATER HARVEST AREA (RETENTION) ALONG THE WEST PORTION OF THE PROPERTY. THE DRAINAGE DATA ON THIS PAGE SUMMARIZES THE PROPOSED PEAK DISCHARGE AND RUNOFF VOLUME FOR BASIN A.

**OFFSITE FLOWS**

THERE ARE NO OFFSITE FLOWS THAT DRAIN ONTO THE SITE.

**CONCLUSION**

RUNOFF VOLUME AND FLOW RATE INCREASED AS A RESULT OF CHANGES IN LAND TREATMENTS FOR BASIN A BY 0.011 ACRE FEET AND THE PEAK FLOW RATE HAS INCREASED BY 0.15 CFS. THE PROPOSED RUNOFF VOLUME OF 0.062 AF MINUS THE PROPOSED POND VOLUME OF 0.014 AF IS 0.048 AF WHICH IS LESS THAN THE EXISTING RUNOFF VOLUME OF 0.051 AF. THEREFORE THE PROPOSED IMPROVEMENTS ON THE SITE WILL IMPROVE THE DOWNSTREAM CAPACITY.

THE PROPOSED GRADING IMPROVEMENTS WILL INCLUDE SIDEWALK CULVERTS, VALLEY GUTTERS, CURB AND GUTTERS AND CURB CUTS ALLOWING STORMWATER INTO AND OUT OF THE PROPOSED WATER HARVESTING AREA. THIS WATER HARVESTING AREA WILL BE USED TO MANAGE THE FIRST FLUSH AS REQUIRED BY THE RECENT CITY OF ALBUQUERQUE DRAINAGE ORDINANCE CHANGES. THE VOLUME OF THE FIRST FLUSH FOR THE SITE (0.44-0.1 INCHES \* IMPERVIOUS AREA)= 350 cf. THE WATER HARVEST AREA VOLUME = 392 cf (Ø SPILLWAY INVERT) > 350 cf. THEREFOR MANAGES THE FIRST FLUSH. (SEE CALCULATIONS BELOW). ALL POSSIBLE IMPERVIOUS AREAS WILL BE DISCHARGED THROUGH THE PROPOSED WATER HARVEST AREA.

**GENERAL NOTES:**

- EXISTING TOPOGRAPHIC DATA SHOWN ON THESE PLANS WAS PROVIDED BY SURV-TEK SURVEYING, INC. MILLER ENGINEERING CONSULTANTS HAS UNDERTAKEN NO FIELD VERIFICATION OF THIS INFORMATION.
- VERTICAL DATUM IS BASED ON THE ALBUQUERQUE CONTROL SURVEY BENCHMARK "12-E14" HAVING A PUBLISHED ELEVATION OF 4978.63' (NAVD 1988).  
  
TBM SET PK NAIL WITH ALUMINUM DISK "LS 9750" IN ALLEY JUST SOUTHWEST OF THE SOUTHWEST PROPERTY CORNER. ELEV. 4965.21.
- THE CONTRACTOR IS RESPONSIBLE FOR ALL TEMPORARY SEDIMENT AND EROSION CONTROL DEVICES DURING THE CONSTRUCTION PHASE.
- CONTRACTOR SHALL OBTAIN A GRADING PERMIT FROM THE CITY OF ALBUQUERQUE, PRIOR TO ANY GRADING OR CONSTRUCTION.
- TWO WORKING DAYS PRIOR TO ANY EXCAVATION CONTRACTOR MUST CONTACT LINE LOCATING SERVICE 260-1990 FOR LOCATION OF EXISTING UTILITIES.
- ALL EMBANKMENTS SHALL BE PLACED AND COMPACTED IN LIFTS OF MAXIMUM OF 8". THE EMBANKMENTS SHALL BE WETTED AND COMPACTED TO 95% OPTIMUM DENSITY PER ASTM D1557 AND 95% UNDER ALL STRUCTURES INCLUDING DRIVEWAYS AND PARKING LOTS.
- MAINTENANCE OF THESE FACILITIES SHALL BE THE RESPONSIBILITY OF THE OWNER(S) OF THE PROPERTY SERVED.
- THE CONTRACTOR SHALL FIELD VERIFY LOCATION AND SIZE OF ALL UTILITIES PRIOR TO CONSTRUCTION.
- THE SUBJECT PROPERTY (AS SHOWN HEREON) APPEARS TO LIE WITHIN ZONE "X" (AREAS OF 0.2% ANNUAL CHANCE FLOOD; AREAS OF 1% ANNUAL CHANCE FLOOD WITH AVERAGE DEPTHS OF LESS THAN 1 FOOT OR WITH DRAINAGE AREAS LESS THAN 1 SQUARE MILE; AND AREAS PROTECTED BY LEVEES FROM 1% ANNUAL CHANCE FLOOD.) IN ACCORDANCE WITH THE NATIONAL FLOOD INSURANCE PROGRAM RATE MAP NO. 35001C0119 G, EFFECTIVE DATE 9-26-2008.
- ALL WORK PERFORMED SHALL COMPLY WITH THE REQUIREMENTS OF THE CITY OF ALBUQUERQUE STORM DRAINAGE REGULATIONS. ALL WORK PERFORMED SHALL COMPLY WITH THE REQUIREMENTS OF THE CITY OF ALBUQUERQUE "GRADING AND DRAINAGE DESIGN REQUIREMENTS AND POLICIES FOR LAND DEVELOPMENT."
- THE OWNER, CONTRACTOR AND/OR BUILDER SHALL COMPLY WITH ALL APPROPRIATE LOCAL, STATE AND FEDERAL REGULATIONS AND REQUIREMENTS.
- THE CONTRACTOR SHALL TAKE ALL APPROPRIATE AND REASONABLE MEASURES TO PREVENT SEDIMENT OR POLLUTANT LADEN STORM WATER FROM EXITING THE SITE DURING CONSTRUCTION. STORMWATER MAY BE DISCHARGED IN A MANNER, WHICH COMPLIES WITH THE APPROVED GRADING AND DRAINAGE PLAN.
- THE CONTRACTOR SHALL TAKE ALL APPROPRIATE MEASURES TO PREVENT THE MOVEMENT OF CONSTRUCTION RELATED SEDIMENT, DUST, MUD, POLLUTANTS, DEBRIS, WASTE, ETC FROM THE SITE BY WIND, STORM FLOW OR ANY OTHER METHOD EXCLUDING THE INTENTIONAL, LEGAL TRANSPORTATION OF SAME IN A MANNER ACCEPTABLE BY THE CITY.
- THE CONTRACTOR SHALL NOT DISTURB AREAS OUTSIDE THE AREAS SHOWN AS "SLOPE LIMITS" ON THE GRADING AND DRAINAGE PLAN.

**WATER HARVEST VOLUMES**


WATER HARVEST AREA 1 proposed					
Pond Rating Table					
Side Slope 1:1					
Depth (ft)	Area (sq ft)	(ac)	Volume (ac-ft)	Cum Volume (ac-ft)	
74	115	0.003	0.000	0.000	
75	175	0.004	0.003	0.003	
76	341	0.008	0.006	0.009	
76.5	431	0.010	0.004	0.014	spillway top of pond

**DRAINAGE DATA**


Precipitation Zone 2 - 100-year Storm		P(360) = 2.33 in		P(1440) = 2.75 in	
Basin	Area (Ac)	A	B C D	Ew (in)	V(100-6) (af)
Existing Conditions					
Site	0.315	0.000	0.000 0.128 0.187	1.718	0.051
Total	0.315				0.051
Proposed Conditions					
Site	0.315	0.000	0.000 0.032 0.283	2.02	0.053
Total	0.315				0.062

Precipitation Zone 2 - 10-year Storm		P(360) = 1.52 in		P(1440) = 1.8 in	
Basin	Area (Ac)	A	B C D	Ew (in)	V(10-6) (af)
Existing Conditions					
Site	0.315	0.000	0.000 0.128 0.187	1.718	0.045
Total	0.315				0.051
Proposed Conditions					
Site	0.315	0.000	0.000 0.032 0.283	1.257	0.033
Total	0.315				0.039

**CONSULTANT:**

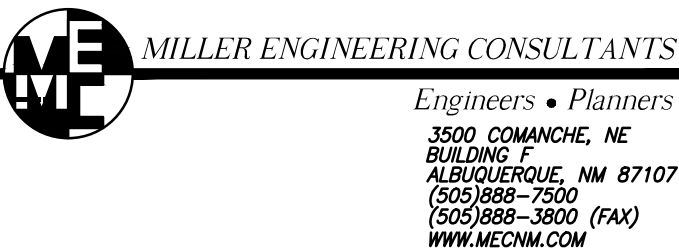

**ARCHITECT:**

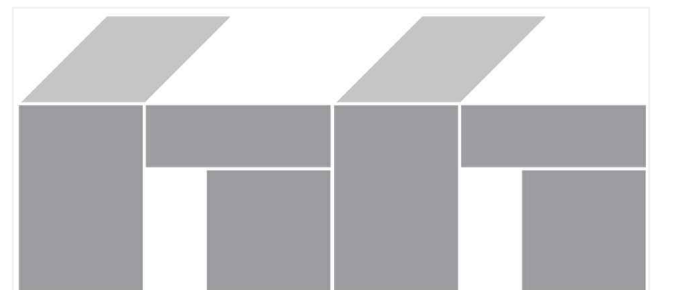

**Architect:**

Clint Wilsey / 66Architect, LLC  
[clint.wilsey@gmail.com](mailto:clint.wilsey@gmail.com)  
505 280-0043

**DRAWN BY:** CJW

ISSUE: PERMIT SET

**TMOBILE STORE**

6015 4th St. NW  
Albuquerque, NM

DATE: 5/31/17

**SHEET TITLE:**

GRADING AND  
DRAINAGE  
REPORT

**C-001**





Spot Elevations:  
Inv. Elev=4977.04 (E)  
Inv. Elev=4972.02 (SW)  
Inv. Elev=4972.81 (NW)


CONTROL POINT  
PK Nail with aluminum disk stamped  
"SUR-T&D CONTROL"  
Elevation= 4977.24'

### LEGEND:

• 38.00 FG	PROPOSED SPOT ELEVATIONS (FINISHED GRADE)	=====	GRADE BREAK-HIGH POINT
• MATCH (95.19)	MATCH EXISTING ELEVATIONS	-----	SWALE
TC ON	TOP OF CONCRETE	-----SD-----	STORM DRAIN LINE
FL	FLOW LINE, CURB		
INV	INVERT	===== 5895 =====	PROPOSED MAJOR CONTOUR
FG	FINISH GRADE	----- 5895 -----	PROPOSED MINOR CONTOUR
TBC	TOP OF BASE COURSE	----- 5895 -----	EXISTING MAJOR CONTOUR
TC	TOP OF CURB	----- 5895 -----	EXISTING MINOR CONTOUR
TG	TOP OF GRATE		
→	FLOW ARROW		
			SEE PUBLIC WORK ORDER PLANS FOR WORK IN CITY RIGHT OF WAY.

### KEYED NOTES:

- 1 NEW CONCRETE SIDEWALK OR CONCRETE FLATWORK AS PER C.O.A. STANDARD DWG 2430. CONTRACTOR SHALL SUBMIT A JOINT PATTERN TO THE PROJECT ARCHITECT FOR REVIEW AND APPROVAL PRIOR TO CONSTRUCTION.
- 2 NEW TYPE A HANDICAP RAMP, SEE DETAIL SHEET C-501.
- 3 NEW WATER HARVEST AREA. TOP=76.65 (INV IN), INV=74.00 (INV OUT). REQ'D. VOL.=0.008 AF. PROVIDED VOL. @ 76.57 (SPILLWAY ELEV.)=0.009 AF. MAX WSEL=76.57. SIDE SLOPE 2:1 WITH FILTER FABRIC AND 6" OF 2-3" COBBLE STONES. SEE DETAIL ON SHEET C-501.
- 4 NEW 24" WIDE SIDEWALK CULVERT AND EMERGENCY SPILLWAY WITH STEEL PLATE TOP. (FIELD VERIFY ELEVATIONS PRIOR TO CONSTRUCTION) INV. SLOPE AT 2% MIN. AS PER C.O.A. STANDARD DETAIL 2236.
- 5 NEW TYPE B HANDICAP RAMP, AS PER C.O.A. STANDARD DETAIL.
- 6 NEW 36" CONCRETE VALLEY GUTTER SEE DETAIL SHEET C-501.
- 7 NEW CURB AND GUTTER. SEE DETAIL SHEET C-501.
- 8 NEW BUILDING. SEE ARCHITECTURAL PLANS FOR DETAILS.
- 9 SAWCUT EXISTING CONCRETE CURB AND GUTTER TO NEAREST CONSTRUCTION JOINT AND MATCH WITH NEW CONCRETE CURB AND GUTTER.
- 10 EXISTING BUILDING AND ASPHALT TO BE DEMOLISHED. SEE ARCHITECTURAL PLANS.
- 11 LANDSCAPE AREA. SEE ARCHITECTURAL PLANS FOR DETAILS.
- 12 NEW 24" WIDE CURB CUT.
- 13 NEW HEAVY DUTY CONCRETE PAVEMENT SECTION. SEE DETAIL SHEET C-501 FOR PAVING SECTIONS AND IN THE GEOTECHNICAL REPORT.
- 14 NEW HOT MIX ASPHALT (HMA) PAVING. ALL PARKING SPACES WILL CONSIST OF LIGHT DUTY HOT MIX ASPHALT PAVING. ALL OTHER AREAS SHALL CONSIST OF HEAVY DUTY HOT MIX ASPHALT PAVING. SEE DETAIL SHEET C-501 FOR PAVING SECTIONS.
- 15 NEW CONCRETE VALLEY GUTTER AS PER COA STANDARD DETAIL 2420.
- 16 MATCH NEW TOP OF CONCRETE VALLEY GUTTER OR CONCRETE BARRIER CURB WITH EXISTING ASPHALT PAVEMENT AT THE LIP OF EXISTING CURB. CONTRACTOR SHALL FIELD VERIFY ELEVATIONS AND LOCATION PRIOR TO CONSTRUCTION.
- 17 MATCH EXISTING TOP BACK OF CURB WITH TOP OF CONCRETE ELEVATION. AND SLOPE AT 2% UP MAXIMUM.
- 18 NEW CONCRETE HEADER CURB. SEE DETAIL SHEET C-501.
- 19 EXISTING POWER POLE TO REMAIN.
- 20 NEW TRASH ENCLOSURE. SEE ARCHITECTURAL PLANS FOR DETAILS.
- 21 NEW ASPHALT OVERLAY. SEE DETAIL SHEET C-501.
- 22 RAISE EXISTING UTILITY VAULT TO GRADE.
- 23 EXISTING ANCHOR TO REMAIN.
- 24 MATCH NEW ASPHALT WITH TOP OF NEW ASPHALT IN ALLEY. CONTRACTOR TO FIELD VERIFY ELEVATION PRIOR TO CONSTRUCTION.
- 25 NEW STANDARD CURB AND GUTTER. AS PER COA STD. DWG. 2415A.
- 26 SEE PUBLIC WORK ORDER PLANS FOR WORK IN THE CITY RIGHT OF WAY.
- 27 NEW 24" WIDE SIDEWALK CULVERT WITH STEEL PLATE TOP. (FIELD VERIFY ELEVATIONS PRIOR TO CONSTRUCTION) INV. SLOPE AT 2% MIN. AS PER C.O.A. STANDARD DETAIL 2236.

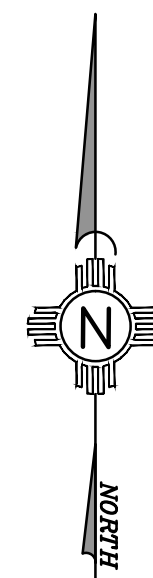

10 5 0 10 15 20  
SCALE: 1"=10'  
CONTOUR INTERVAL = 1'



## A1 GRADING AND DRAINAGE PLAN

SCALE: 1"=10'

### CONSULTANT:

**ME** MILLER ENGINEERING CONSULTANTS  
Engineers • Planners  
3500 COMANCHE, NE  
BUILDING F  
ALBUQUERQUE, NM 87107  
(505)888-7500  
(505)888-3800 (FAX)  
WWW.MECNM.COM

### ARCHITECT:



### Architect:

Clint Wilsey / 66Architect, LLC  
clint.wilsey@gmail.com  
505 280-0043

### DRAWN BY:

CJW

20-17. REVISED PER COA COMMENTS.

### ISSUE: PERMIT SET

### TMOBILE STORE

6015 4th St. NW  
Albuquerque, NM

### DATE:

5/31/17

### SHEET TITLE:

GRADING AND  
DRAINAGE PLAN

C-101