


GENERAL CONSTRUCTION NOTES:

- 1. THE CONTRACTOR SHALL CONTACT THE LOCAL UTILITY SUPPLIERS AT LEAST THREE (3) DAYS PRIOR TO ANY UTILITY CONSTRUCTION (INCLUDING CONNECTIONS TO EXISTING SYSTEM) TO COORDINATE THE VARIOUS ITEMS OF WORK WITH OPERATIONS STAFF. THE CONTRACTOR SHALL CONTACT WATER UTILITY TWO (2) WEEKS PRIOR TO WATER SHUT-OFF AND INFORM ANY AFFECTED USERS OF INTERRUPTIONS IN UTILITY SERVICES.
- 2. ALL TEES, BENDS AND CAPS ON WATER PIPING SHALL BE BLOCKED ACCORDING CITY OF ALBUQUERQUE STANDARD DETAIL 2320.
- 3. ALL TRENCH BACKFILL SHALL BE COMPACTED TO A MINIMUM OF 95% OF OPTIMUM (MODIFIED) ASTM D-1557, ±2%.
- 4. ALL NON-UTILITY WORK DETAILED ON THESE PLANS SHALL BE PERFORMED EXCEPT AS OTHERWISE STATED IN ACCORDANCE WITH THE AWAYA STANDARD SPECIFICATIONS FOR PUBLIC WORKS CONSTRUCTION, CURRENT EDITION AS AMENDED.
- 5. PRIOR TO CONSTRUCTION, THE CONTRACTOR SHALL EXCAVATE AND VERIFY THE HORIZONTAL AND VERTICAL LOCATIONS OF ALL OBSTRUCTIONS AND EXISTING PAVEMENT. SHOULD A CONFLICT EXIST, THE CONTRACTOR SHALL NOTHEY THE ENGINEER SO THAT THE CONFLICT CAN BE RESOLVED WITH A MINIMUM AMOUNT OF DELAY.
- 6. EXISTING UTILITY LINE LOCATIONS ARE SHOWN IN AN APPROXIMATE MANNER ONLY, AND SUCH LINES MAY EXIST WHERE NONE ARE SHOWN. THE LOCATION OF ANY SUCH EXISTING LINES IS BASED ON INFORMATION PROVIDED BY THE UTILITY COMPANY, THE OWNER, OR OTHERS, AND THE INFORMATION MAY BE INCOMPLETE OR MAY BE OBSOLETE BY THE TIME CONSTRUCTION COMMENCES. THE CONTRACTOR SHALL COMPLY WITH STATE STATUTES, MUNICIPAL AND LOCAL ORDINANCES, RULES AND REGULATIONS PERTAINING TO THE LOCATION OF THESE LINES AND FACILITIES IN PLANNING AND CONDUCTING EXCAVATION, WHETHER BY CALLING OR NOTIFYING THE UTILITIES, COMPLY WITH (BLUE STAKE) PROCEDURES, OR OTHERWISE.
- 7. THE GEOTECHNICAL REPORT INDICATES THAT ON SITE NON-EXPANSIVE SOILS MAY BE USED FOR ENGINEERED FILL OR FOR GENERAL SITE GRADING AND EXTERIOR SLABS. NO MATERIALS PITS HAVE BEEN DESIGNATED FOR THIS PROJECT. IT IS ANTICIPATED THAT ANY REQUIRED ENGINEERED SOILS WOULD BE OBTAINED FROM EXISTING STATE AND EPA COMPLIANT BORROW SOURCES.
- ALL NEW STREET PAVING AND CURB AND GUTTER SHALL MATCH THE ELEVATIONS OF ABUTTING EXISTING AREAS AS SHOWN IN THE PLANS OR AS DIRECTED BY THE PROJECT OWNERS REPRESENTATIVE.
- 9. THE CONTRACTOR SHALL COORDINATE HIS CONSTRUCTION ACTIVITIES WITH ALL OTHER CONTRACTORS AND UTILITY COMPANIES WORKING IN THE SAME AREA.
- 10. WHEN ABUTTING NEW PAVEMENT TO EXISTING, CONTRACTOR SHALL SAW CUT, TO FULL PAVEMENT DEPTH, THE EXISTING PAVEMENT TO A NEAT VERTICAL STRAIGHT LINE AS REQUIRED TO REMOVE ANY BROKEN OR CRACKED PAVEMENT AND MATCH NEW TO EXISTING. THIS WORK SHALL BE CONSIDERED INCIDENTAL AND NO ADDITIONAL PAYMENT WILL BE MADE THEREFORE.
- 11. THE CONTRACTOR SHALL ASSUME RESPONSIBILITY FOR ANY DAMAGE TO EXISTING PAVEMENTS, PAVEMENT MARKINGS, CURB AND GUTTER, OR SIDEWALK DURING CONSTRUCTION, APART FROM THOSE SECTIONS INDICATED FOR REMOVAL ON THE PLANS, AND SHALL REPAIR OR REPLACE IN KIND AT HIS OWN EXPENSE.
- 12. CONTRACTOR SHALL BE RESPONSIBLE FOR ACQUIRING, AT HIS OWN EXPENSE, ALL PERMITS NECESSARY FOR CONSTRUCTION. PERMITS ASSOCIATED WITH ENVIRONMENTAL CONCERNS AND SURFACE DISTURBANCE OF SOILS SHOULD BE ACQUIRED THROUGH THE CITY OF LAS CRUCES OF FEDERAL EPA AS REQIRED
- 13. OVERNIGHT PARKING OF CONSTRUCTION VEHICLES ON PRIVATE PROPERTY IS THE SOLE RESPONSIBILITY OF THE CONTRACTOR.
- 14. ALL TRENCH EXCAVATION BACKFILL WITHIN THE ROADWAY PRISM SHALL BE COMPACTED TO 95% OF THE MODIFIED PROCTOR PER ASTM D-1557 AS APPLICABLE.
- 15. ANY EARTHWORK HAUL ON THIS PROJECT WILL BE CONSIDERED AS INCLUDED IN THE CONTRACT PRICE. NO SEPARATE PAYMENT WILL BE MADE THEREFORE.
- 16. THE CONTRACTOR SHALL BE RESPONSIBLE FOR ALL REMOVALS REQUIRED TO COMPLETE THE PROJECT. ADDITIONAL REMOVALS NOT SHOWN ON THE PLANS WILL BE CONSIDERED INCLUDED IN THE CONTRACT PRICE.
- 17. THE CONSTRUCTION CLEAR ZONE FOR THIS PROJECT IS 30 FT. FROM THE EDGE OF DRIVING LANE. THE CONTRACTOR SHALL NOT STORE EQUIPMENT OR MATERIAL WITHIN THE CONSTRUCTION CLEAR ZONE UNLESS THE EQUIPMENT OR MATERIAL IS PROPERLY SHIELDED UTILIZING CURRENT SAFETY DESIGN AND INSTALLATION METHODS. THE SAFETY DESIGN FOR SHIELDING SHALL BE PROVIDED BY THE CONTRACTOR AND MUST BE APPROVED BY THE OWNERS PROJECT REPRESENTATIVE BEFORE IMPLEMENTING. THIS WORK, INCLUDING DESIGN, INSTALLATION, AND REMOVAL OF THE SHIELDING, SHALL BE CONSIDERED INCIDENTAL TO THE COMPLETION OF THE PROJECT AND NO SEPARATE MEASUREMENT OR PAYMENT WILL BE MADE THEREFOR.
- THE CONTRACTOR SHALL MAINTAIN AN UP TO DATE SET OF AS-BUILT PLANS FOR THE PROJECT. THESE PLANS SHALL BE KEPT CURRENT, WITHIN TWO (2) WEEKS, AT ALL TIMES AND SHALL BE SUBJECT TO REVIEW BY THE OWNERS PROJECT REPRESENTATIVE THROUGHOUT THE PROJECT AND WILL BE REVIEWED BY THE OWNERS PROJECT REPRESENTATIVE FOR ACCURACY AND COMPLETENESS AT LEAST ONCE EVERY 30 DAYS. THE FINAL AS-BUILT PLANS SHALL BE SUBMITTED TO THE OWNER'S MANAGER PRIOR TO FULL PAYMENT.
- 19. CONTRACTOR TO PROVIDE CONSTRUCTION JOINT LAYOUT FOR PCC PAVED AREAS TO ARCHITECT A MINIMUM OF TWO (2) WEEKS PRIOR TO CONCRETE PLACEMENT. WRITTEN APPROVAL OF JOINT LAYOUT MUST BE PROVIDED TO CONTRACTOR PRIOR TO PLACEMENT OF ANY CONCRETE IN THIS AREA.
- 20. THE CONTRACTOR SHALL PREPARE & OBTAIN ANY NECESSARY DUST OR EROSION CONTROL PERMITS FROM REGULATORY AGENCIES. THE CONTRACTOR SHALL PREPARE AN EPA APPROVED STORM WATER POLLUTION PREVENTION (SWPP) PLAN FOR THIS PROJECT. ALL PERMITS MUST BE OBTAINED PRIOR TO START OF CONSTRUCTION.
- 21. THE CONTRACTOR SHALL MAINTAIN AND PROTECT ALL EXISTING SURVEY MONUMENTS WITHIN THE CONSTRUCTION AREA. SHOULD A MONUMENT BE DAMAGED OR DESTROYED IT WILL BE REPLACED IN ACCORDANCE WITH SURVEY PRACTICE STANDARDS AT NO ADDITIONAL EXPENSE TO THE OWNER.
- 22. ALL TRAFFIC HANDLING SHALL COMPLY WITH THE MANUAL OF UNIFORM TRAFFIC CONTROL DEVICES (MUTCD). A TRAFFIC HANDLING CONTROL PLAN SHALL BE PREPARED BY THE CONTRACTOR AND SUBMITTED TO THE ARCHITECT/ENGINEER AND ENTITY HAVING JURISDICTION OVER THE ADJOINING ROADWAYS FOR APPROVAL PRIOR TO COMMENCEMENT OF ANY WORK.
- 23. ALL MATERIAL REQUIRING DISPOSAL SHALL BE REMOVED FROM THE PROJECT SITE AND DISPOSED OF IN AN EPA APPROVED LANDFILL OR APPROPRIATE FACILITY. ALL ASPHALTIC ROADWAY MATERIAL, AND CONCRETE CURB AND GUTTER, IS TO BE REMOVED FROM THE PROJECT. CONTRACTOR SHALL SUBMIT DISPOSAL MANIFEST TO OWNER'S PROJECT REPRESENTATIVE FOR ALL MATERIAL REQUIRING A DISPOSAL MANIFEST. THIS ALSO INCLUDES REMOVAL AND DISPOSAL OF ANY AND ALL TRANSITE MATERIALS IN ACCORDANCE WITH EPA AND OTHER GOVERNMENTAL AGENCY REQUIREMENTS AS NECESSARY. ALL DISPOSALS SHALL BE AT AN APPROVED EPA FACILITY. THIS WORK IS CONSIDERED INCIDENTAL AND NO ADDITIONAL PAYMENT SHALL BE MADE THEREFORE.
- 24. NO ON-SITE ASPHALT AND/OR CONCRETE BATCH PLANTS ARE ANTICIPATED FOR THIS PROJECT.
- 25. THE CONTRACTOR IS ADVISED THAT THE CURB AND GUTTER SHOWN FOR INSTALLATION SHALL BE IN PLACE PRIOR TO PLACEMENT OF ASPHALTIC SURFACING MATERIALS.
- 26. CONTRACTOR SHALL CONFORM TO ALL CITY OF ALBUQUERQUE WATER, AND WASTE WATER SPECIFICATIONS AND STANDARDS.
- 27. ALL WATER LINES SHALL BE PVC C-900-200 PSI AND SEWER LINES TO BE PVC SDR35.
- 28. CONTRACTOR TO ABANDON OLD UTILITY LINES (WATER AND SEWER) IN PLACE OR REMOVE AS NECESSARY TO PERMIT NEW CONSTRUCTION. TOP PORTION OF MANHOLES SHALL BE REMOVED. GATE VALVES, VALVE BOXES AND WATER METERS SHALL BE REMOVED FROM ALL BUILDINGS AND CONTRACTOR SHALL ABIDE BY GOVERNING REGULATIONS AND PROCEDURES FOR ABANDONMENT, REMOVAL AND DISPOSAL OF ITEMS MENTIONED. CONTRACTOR TO PROVIDE TIE IN TO EXISTING UTILITIES IN SUCH A MANNER THAT SERVICE IS MAINTAINED TO ANY EXISTING FACILITIES. IN THE EVENT THAT SERVICES MUST BE DISCONNECTED FOR A PERIOD OF TIME THIS WORK WILL BE PERFORMED AT SUCH TIMES WHEN THE FACILITY IS NOT IN USE OR AS DESCRIBED BY WRITTEN DIRECTION OF THE OWNER.
- 29. THE SITE AND UTILITY SURVEY WAS PROVIDED TO J.E.L. & ASSOCIATES, LLC (JEL) BY THE OWNER. JEL ASSUMES NO RESPONSIBILITY FOR THE ACCURACY OF SAID SURVEY.

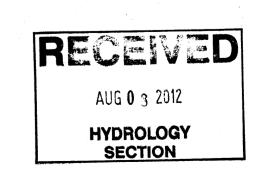



4700 Lincoln N.E., Suite 111 Albuquerque, N.M. 87109 Phone: (505) 342-6200 Fax: (505) 342-6201





Car Crafters
Automotive Repair Garage
5404 Edith Blvd. NE
Albuquerque, New Mexico 87107

Project Number
Drawn By T.D.S.
Checked E.J.L.
Issue Date 12/22/20
GENERAL
CONSTRUCTION

NOTES

2100

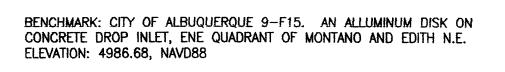

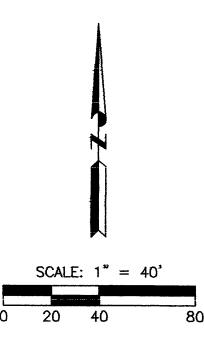

Car Crafters

stomotive Repair Garage
5404 Edith Blvd. NE

uquerque, New Mexico 87107

DSA


Darren Sowell

4700 Lincoln N.E., Suite 111 Albuquerque, N.M. 87109 Phone: (505) 342-6200 Fax: (505) 342-6201

Project Number
Drawn By T.D.S.
Checked E.J.L.
Issue Date 12/22/2011

EXISTING SITE
PLAN

Scale:

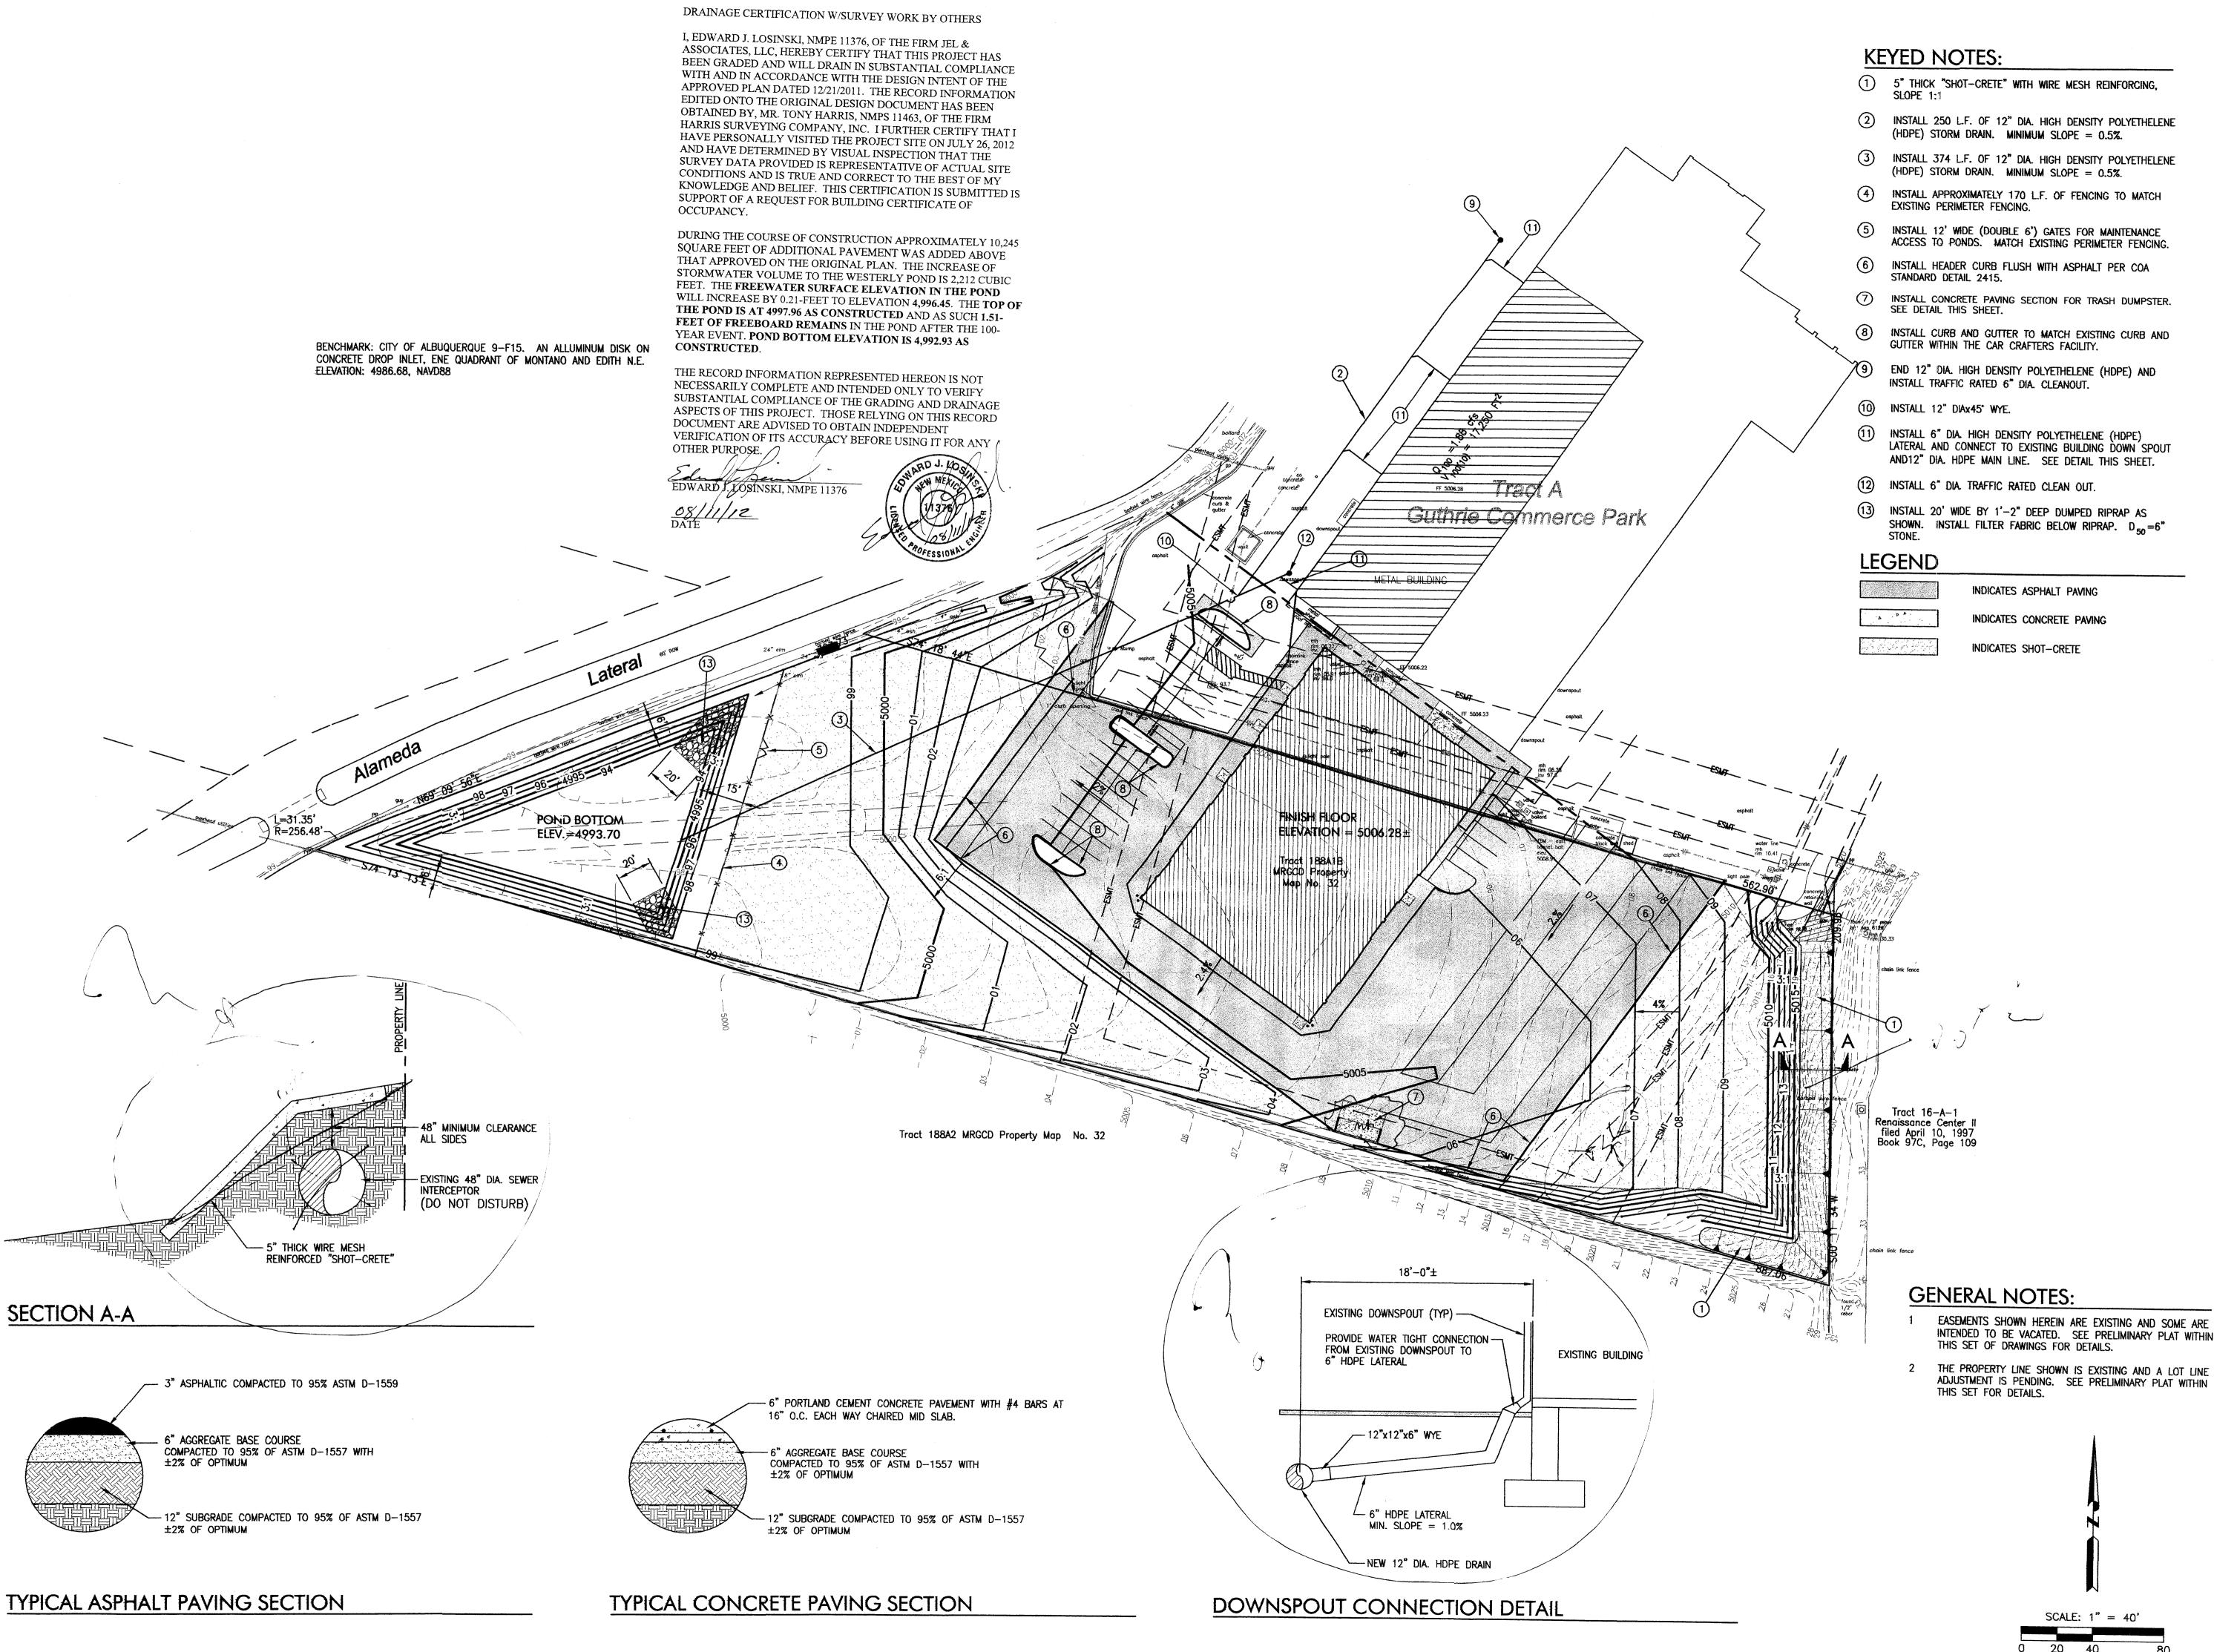



4700 Lincoln N.E., Suite 111 Albuquerque, N.M. 87109 Phone: (505) 342-6200 Fax: (505) 342-6201



Automotive Repair Garage 5404 Edith Blvd. NE

Project Number

Project Number
Drawn By T.D.S.
Checked E.J.L.

GRADING AND
DRAINAGE PLAN

Scale:

<u>LEGEND</u>


PRE-DEVELOPMENT BASIN
POST-DEVELOPMENT BASIN

DSA

Darren Sowell

ARCHITECTS

4700 Lincoln N.E., Suite 111 Albuquerque, N.M. 87109 Phone: (505) 342-6200 Fax: (505) 342-6201

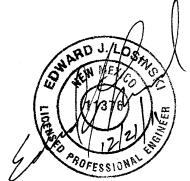

Car Crafters
Automotive Repair Garage
5404 Edith Blvd. NE
Albuquerque, New Mexico 87107

Project Number
Drawn By
Checked
Issue Date

SCALE: 1" = 40'

Drawn By T.D.S.

Checked E.J.L.

Issue Date 12/22/2011

PRE AND POST

DEVELOPMENT

DRAINAGE BASINS

Scale

C103

BENCHMARK: CITY OF ALBUQUERQUE 9-F15. AN ALLUMINUM DISK ON CONCRETE DROP INLET, ENE QUADRANT OF MONTANO AND EDITH N.E. ELEVATION: 4986.68, NAVD88

FOR DRAINAGE CALCULATIONS

SUMMARY SEE SHEET C104

Darren Sowell ARCHITECTS

4700 Lincoln N.E., Suite 111 Albuquerque, N.M. 87109 Phone: (505) 342-6200 Fax: (505) 342-6201

Project Number

T.D.S. E.J.L.

PRE AND POST DEVELOPMENT DRAINAGE BASINS

C103A

CAR CRAFTER FACILITY PHASE II

- I. PURPOSE AND SCOPE
 THE PURPOSE OF THIS DRAINAGE PLAN IS TO PRESENT THE EXISTING AND
 PROPOSED DRAINAGE MANAGEMENT PLANS FOR THE PROPOSED CAR CRAFTERS
 FACILITY LOCATED ON MONTANO NEAR THE ALAMEDA LATERAL. THE SITE CURRENTLY
 IS DISTURBED BUT UNDEVELOPED.
- II. SITE DESCRIPTION AND HISTORY
 THE SITE IS CURRENTLY VACANT AND WAS PART OF A FACILITY THAT STORED
 VINTAGE TRUCKS. NO STRUCTURES WERE KNOWN TO EXIST ON THIS PROPERTY
 BUT THE VEHICLES WERE STORED THERE UNTIL LATE 2004. THE SITE WAS
 ACCESSED THROUGH THE SUNRISE HEIGHTS SUBDIVISION VIA A CROSSING OVER THE
 ALAMEDA LATERAL.

THE SITE GENERALLY SLOPES FROM EAST TO SOUTHWEST TOWARD THE ALAMEDA LATERAL. WATER FROM THE SITE PRESENTLY OVERTOPS A SMALL DEPRESSION AND ENTERS THE ALAMEDA LATERAL.

- III. COMPUTATIONAL PROCEDURES
 HYDRAULIC ANALYSIS WAS PERFORMED UTILIZING THE DESIGN CRITERIA FOUND IN
 THE COA-DPM SECTION 22.2 RELEASED IN JUNE 1997.
- IV. PRECIPITATION

 THE 100-YEAR 6-HOUR DURATION STORM WAS USED AS THE DESIGN STORM FOR THIS ANALYSIS. THE SITE IS LOCATED WITHIN ZONE 2 AS IDENTIFIED IN THE DPM SECTION 22.2. TABLES WITHIN THAT SECTION WERE USED TO ESTABLISH THE 6-HOUR PRECIPITATION, EXCESS PRECIPITATION AND PEAK DISCHARGE.
- V. EXISTING DRAINAGE CONDITIONS OVERVIEW

 THE 3.36 ACRES SITE, LOCATED WITHIN ZONE ATLAS K-13-Z HAS NOT BEEN STRUCTURALLY DEVELOPED. THE SITE WAS FORMERLY USED FOR STORAGE OF VINTAGE TRUCKS AND MINOR WORK ON THE SAME.

THE SITE GENERALLY SLOPES FROM EAST TO SOUTHWEST. THERE IS A LARGE DETENTION POND LOCATED UPSTREAM OF THE SITE (ON THE EAST SIDE) THAT IS PART OF THE RENAISSANCE PARK DEVELOPMENT. THERE IS A LARGE EMBANKMENT TO CONTAIN THIS DETENTION POND ALONG THE EAST PROPERTY LINE. THE ONLY OFFSITE DRAINAGE FROM THE EAST IS FROM WATER THAT LANDS DIRECTLY ON THE EMBANKMENT.

THE SITE IS BOUND BY TRACT A GUTHRIE COMMERCE PARK ON THE NORTH, THE ALAMEDA LATERAL TO THE WEST, TRACT 188A2 MRGCD TO THE SOUTH AND TRACT 16-A-1 RENAISSANCE CENTER II TO THE EAST.

ALL FLOWS WITHIN TRACT A, GUTHRIE COMMERCE PARK ARE CONVEYED TO THE NORTH AND ENTER MONTANO BLVD. A 25' WIDE STRIP OF EMBANKMENT LOCATED WITHIN TRACT 16-A-1, RENAISSANCE CENTER II FLOWS ONTO THE SITE FROM THE EAST. FROM THE SOUTH ONLY A SMALL SLIVER OF LAND VARYING FROM 4 FEET TO 13 FEET CONTRIBUTES STORM FLOW TO THE PROPERTY.

THE PEAK RUNOFF FROM ALL CONTRIBUTARY AREAS FLOWS WEST WHERE A SMALL DETENTION POND IS QUICKLY FILLED ALLOWING THE BALANCE OF WATER TO ENTER INTO THE ALAMEDA LATERAL WHERE IT IS CONVEYED TO THE SOUTH.

VI. THE SITE IMPROVEMENTS INCLUDE THE CONSTRUCTION OF AN APPROXIMATELY 24,275 SQUARE FOOT CAR CRAFTERS AUTO BODY FACILITY AND ASSOCIATED PARKING AND OUTSIDE STORAGE AREA. IN ORDER TO RECTIFY THE INAPPROPRIATE DISCHARGE OF STORM FLOWS TO THE ALAMEDA LATERAL, A RETENTION POND WILL BE CONSTRUCTED ON THE WEST SIDE OF THE PROPERTY.

BASED ON DISCUSSIONS WITH THE COA HYDROLOGY DEPARTMENT (MR. CURTIS CHEME) A PORTION OF THE GENERATED STORM FLOW FROM TRACT A, GUTHRIE COMMERCE PARK WILL BE COLLECTED VIA SUBSURFACE STORM DRAIN AND COLLECTED WITHIN THE PROPOSED RETENTION POND. AN ADDITIONAL 1-FOOT OF FREEBOARD ABOVE THE 100-YEAR, 10-DAY RUNOFF VOLUME WILL ALSO BE PROVIDED.

THE PEAK DISCHARGE FOR TRACT 188A1B IS 13.07 CFS, THE COLLECTION OF ROOF DRAINAGE FROM TRACT A, GUTHRIE COMMERCE PARK IS 1.88 CFS, AND THE COLLECTION OF PRE-DEVELOPMENT BASIN "B" IS 0.39 CFS, FOR A TOTAL OF 15.34 CFS. THE 100-YEAR 10-DAY VOLUME GENERATED IS 34,855 C.F.

THE SITE IS FULLY RETAINED AFTER THE CONSTRUCTION OF THE PROPOSED POND AND WILL LOWER CURRENT IMPACTS TO DOWNSTREAM FACILITIES.

DRAIN	NAGE SUMM	ARY		
PROJECT	CAR CRAFTERS			
DATE	12/22/11			
BY	EDDY L.			
CITE LOCATION				
SITE LOCATION				
PRECIPITATION ZONE	2 PER TABLE A-1	COA SECTION 22.2		
EXISTING CONDITION SUM	MARY			
BASIN NAME	BASIN A	BASIN B	BASIN C	
AREA (SF)	17,424	5401	146,362	
AREA (ocres)	0.40	0.12	2.36	
%A LAND TREATMENT		0.12	2.50	
%B LAND TREATMENT				
%C LAND TREATMENT		100	100	
%D LAND TREATMENT	100	100	100	
	100			
SOIL TREATMENT (acres)				
%A LAND TREATMENT	0.0	0.0	0.0	
%B LAND TREATMENT	0.0	0.0	0.0	
%C LAND TREATMENT	0.0	0.12	3.36	
%D LAND TREATMENT	0.40	0.0	0.0	
EXCESS RUNOFF (acre feet)				
100YR 6HR	0.07	0.01	0.32	
10YR 6HR	0.04	0.01	0.15	
2YR 6HR	0.03	0.00	0.04	
100YR 24HR	0.08	0.01	0.32	
PEAK DISCHARGE (cfs)				
100YR	1.88	0.39	10.55	
10YR	1.26	0.21	5.75	
2YR	0.74	0.07	2.02	
		10.07	1 2.02	
PROPOSED CONDITION SUA	AMARY			
BASIN NAME	BASIN A	BASIN B	BASIN 1	
AREA (SF)	17,424	5401	146,362	
AREA (acres)	0.40	0.12	3.36	
%A LAND TREATMENT				
%B LAND TREATMENT				
%C LAND TREATMENT		100	52 45	
%D LAND TREATMENT	100	48	52 45 48 55	
SOIL TREATMENT (acres)				
%A LAND TREATMENT	0.0	0.0	0.0	
%B LAND TREATMENT	0.0	0.0	0.0	
%C LAND TREATMENT	0.0	0.12	175 1.51	
%D LAND TREATMENT	0.40	1.61	1.67 1.85	
		1.01	1,03	
EXCESS RUNOFF (acre feet)	0.07	0.04	0.10	
100YR 6HR	0.07	0.01	0,48 0.47	
10YR 6HR	0.04	0.01	926 0.27	
2YR 6HR	0.03	0.00	913 0.14	
100YR 24HR	0.08	0.01	0.50	
PEAK DISCHARGE (cfs)				
100YR	1.88	0.39	13.07 /3.43	
10YR	1.26	0.21	8.85 B.39	
2YR	0.74	0.07	4.85 4.34	

POND VOLUME DEPTH CALCULATION Q 100

AREA OF POND = 10,400 FT².

REQUIRED PONDING VOLUME = 34,855 FT³.

DEPTH © 0₁₀₀ = 3.35 FEET


POND BOTTOM ELEVATION = 4993.65.

WATER SURFACE ELEVATION = 4997.01.

TOP OF POND ELEVATION = 4998.00.

EREEBOARD = 1'±.

See Certification Below

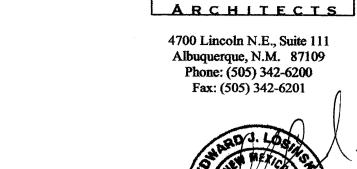

Darren Sowell

DRAINAGE CERTIFICATION W/SURVEY WORK BY OTHERS

I, EDWARD J. LOSINSKI, NMPE 11376, OF THE FIRM JEL & ASSOCIATES, LLC, HEREBY CERTIFY THAT THIS PROJECT HAS BEEN GRADED AND WILL DRAIN IN SUBSTANTIAL COMPLIANCE WITH AND IN ACCORDANCE WITH THE DESIGN INTENT OF THE APPROVED PLAN DATED 12/21/2011. THE RECORD INFORMATION EDITED ONTO THE ORIGINAL DESIGN DOCUMENT HAS BEEN OBTAINED BY, MR. TONY HARRIS, NMPS 11463, OF THE FIRM HARRIS SURVEYING COMPANY, INC. I FURTHER CERTIFY THAT I HAVE PERSONALLY VISITED THE PROJECT SITE ON JULY 26, 2012 AND HAVE DETERMINED BY VISUAL INSPECTION THAT THE SURVEY DATA PROVIDED IS REPRESENTATIVE OF ACTUAL SITE CONDITIONS AND IS TRUE AND CORRECT TO THE BEST OF MY KNOWLEDGE AND BELIEF. THIS CERTIFICATION IS SUBMITTED IS SUPPORT OF A REQUEST FOR BUILDING CERTIFICATE OF OCCUPANCY.

DURING THE COURSE OF CONSTRUCTION APPROXIMATELY 10,245 SQUARE FEET OF ADDITIONAL PAVEMENT WAS ADDED ABOVE THAT APPROVED ON THE ORIGINAL PLAN. THE INCREASE OF STORMWATER VOLUME TO THE WESTERLY POND IS 2,212 CUBIC FEET. THE FREEWATER SURFACE ELEVATION IN THE POND WILL INCREASE BY 0.21-FEET TO ELEVATION 4,996.45. THE TOP OF THE POND IS AT 4997.96 AS CONSTRUCTED AND AS SUCH 1.51-FEET OF FREEBOARD REMAINS IN THE POND AFTER THE 100-YEAR EVENT. POND BOTTOM ELEVATION IS 4,992.93 AS CONSTRUCTED.

THE RECORD INFORMATION REPRESENTED HEREON IS NOT NECESSARILY COMPLETE AND INTENDED ONLY TO VERIFY SUBSTANTIAL COMPLIANCE OF THE GRADING AND DRAINAGE ASPECTS OF THIS PROJECT. THOSE RELYING ON THIS RECORD DOCUMENT ARE ADVISED TO OBTAIN INDEPENDENT VERIFICATION OF ITS ACCURACY BEFORE USING IT FOR ANY OTHER PURPOSE

EDWARD I KOSINSKI, NMPE 11376

O8/11/12
DATE

Automotive Repair Garage 5404 Edith Blvd. NE

Project Number
Drawn By
Checked


DRAINAGE SUMMARY

AND CALCULATIONS

C104

T.D.S.

E.J.L.

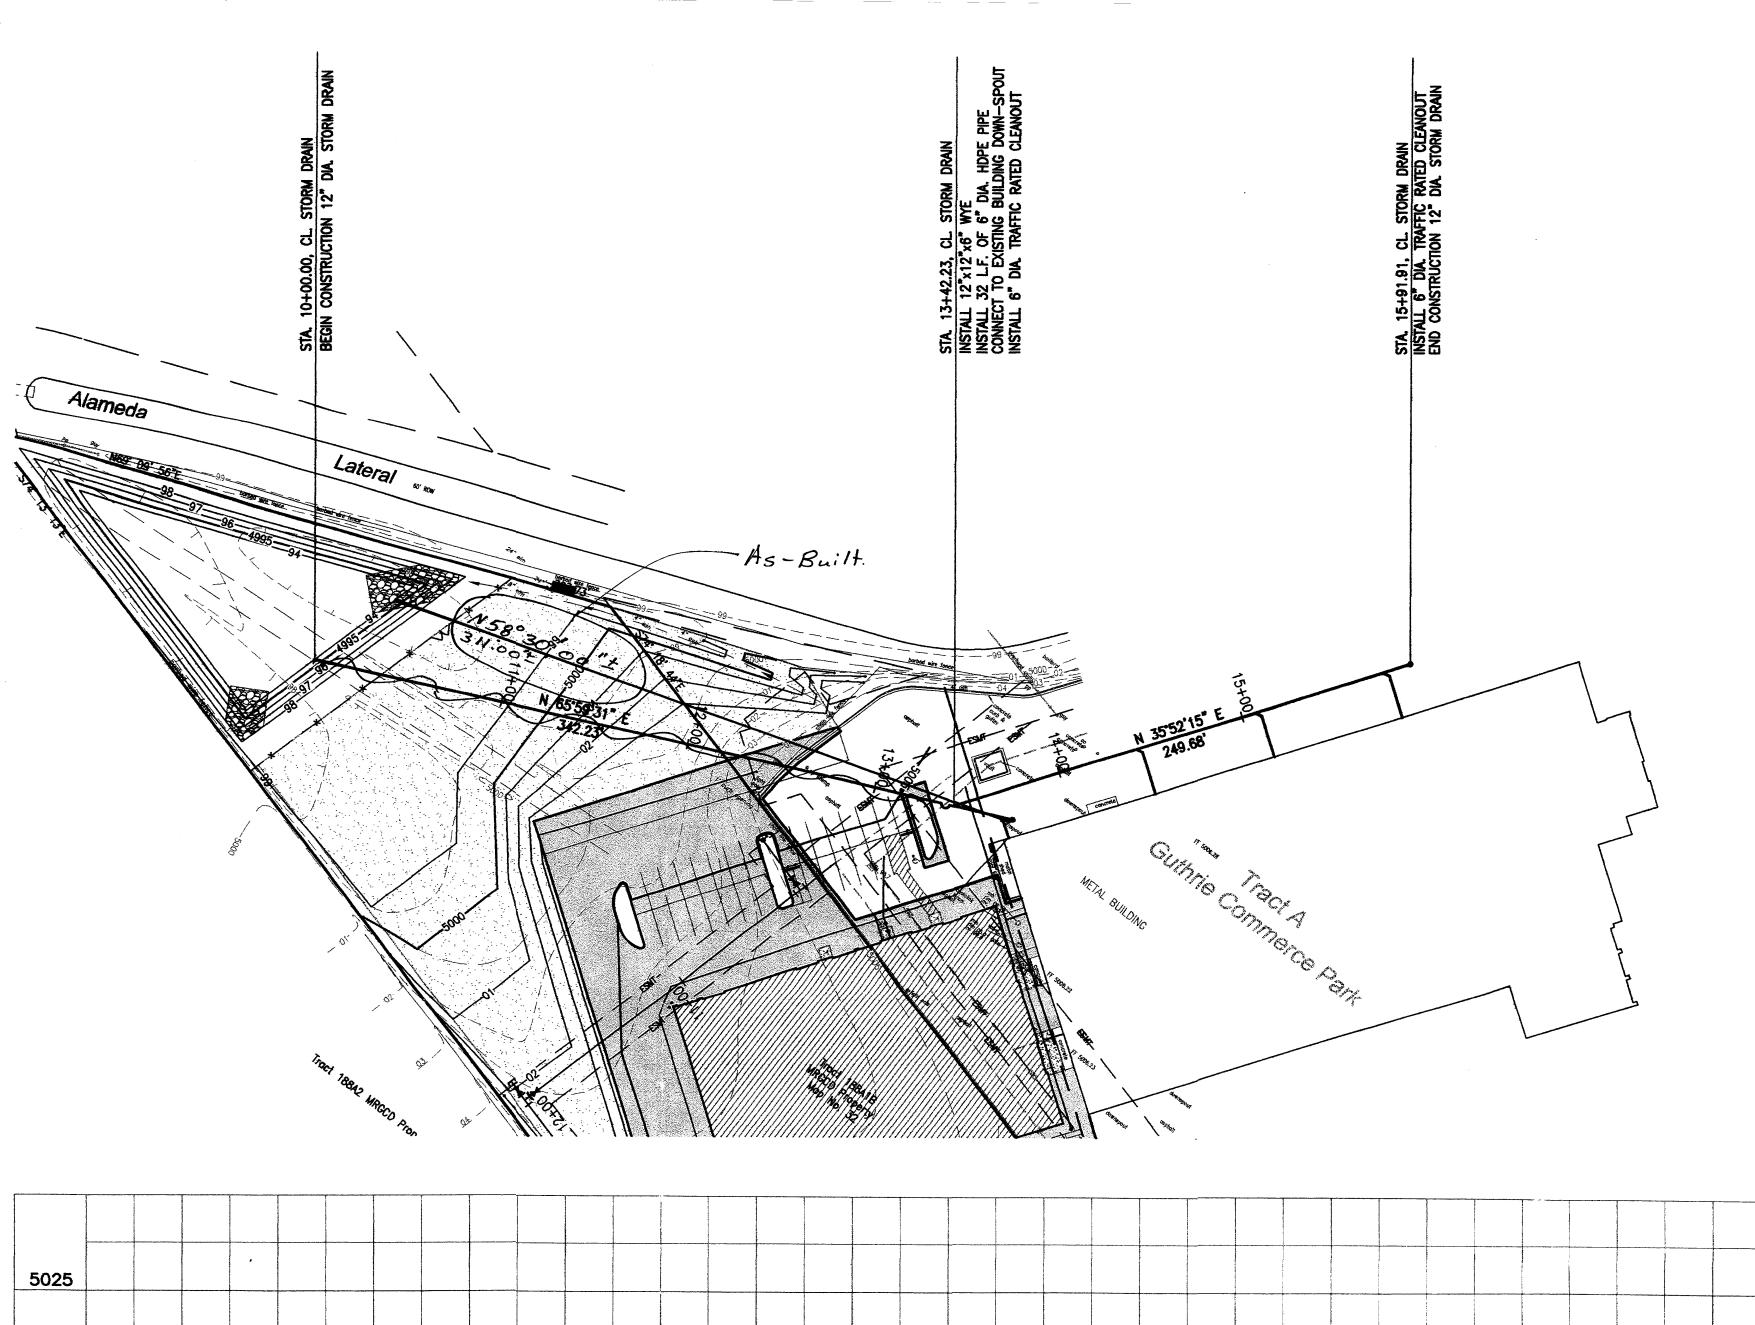

DRAINAGE CERTIFICATION W/SURVEY WORK BY OTHERS

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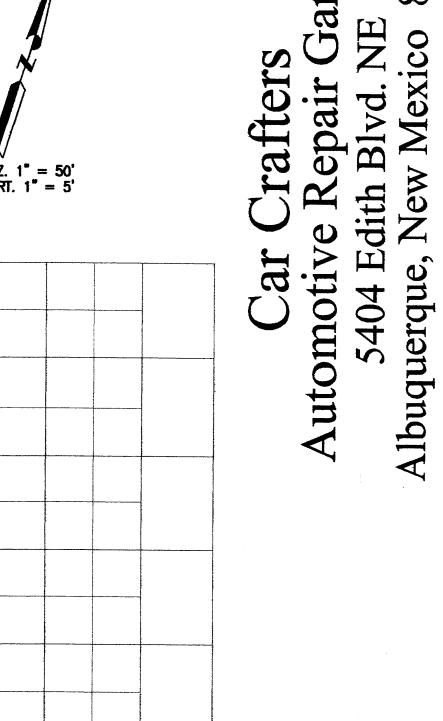
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EDWARD J. LOSINSKI, NMPE 11376

08/11/12





E.J.L.

Issue Date 12 STORM SEWER


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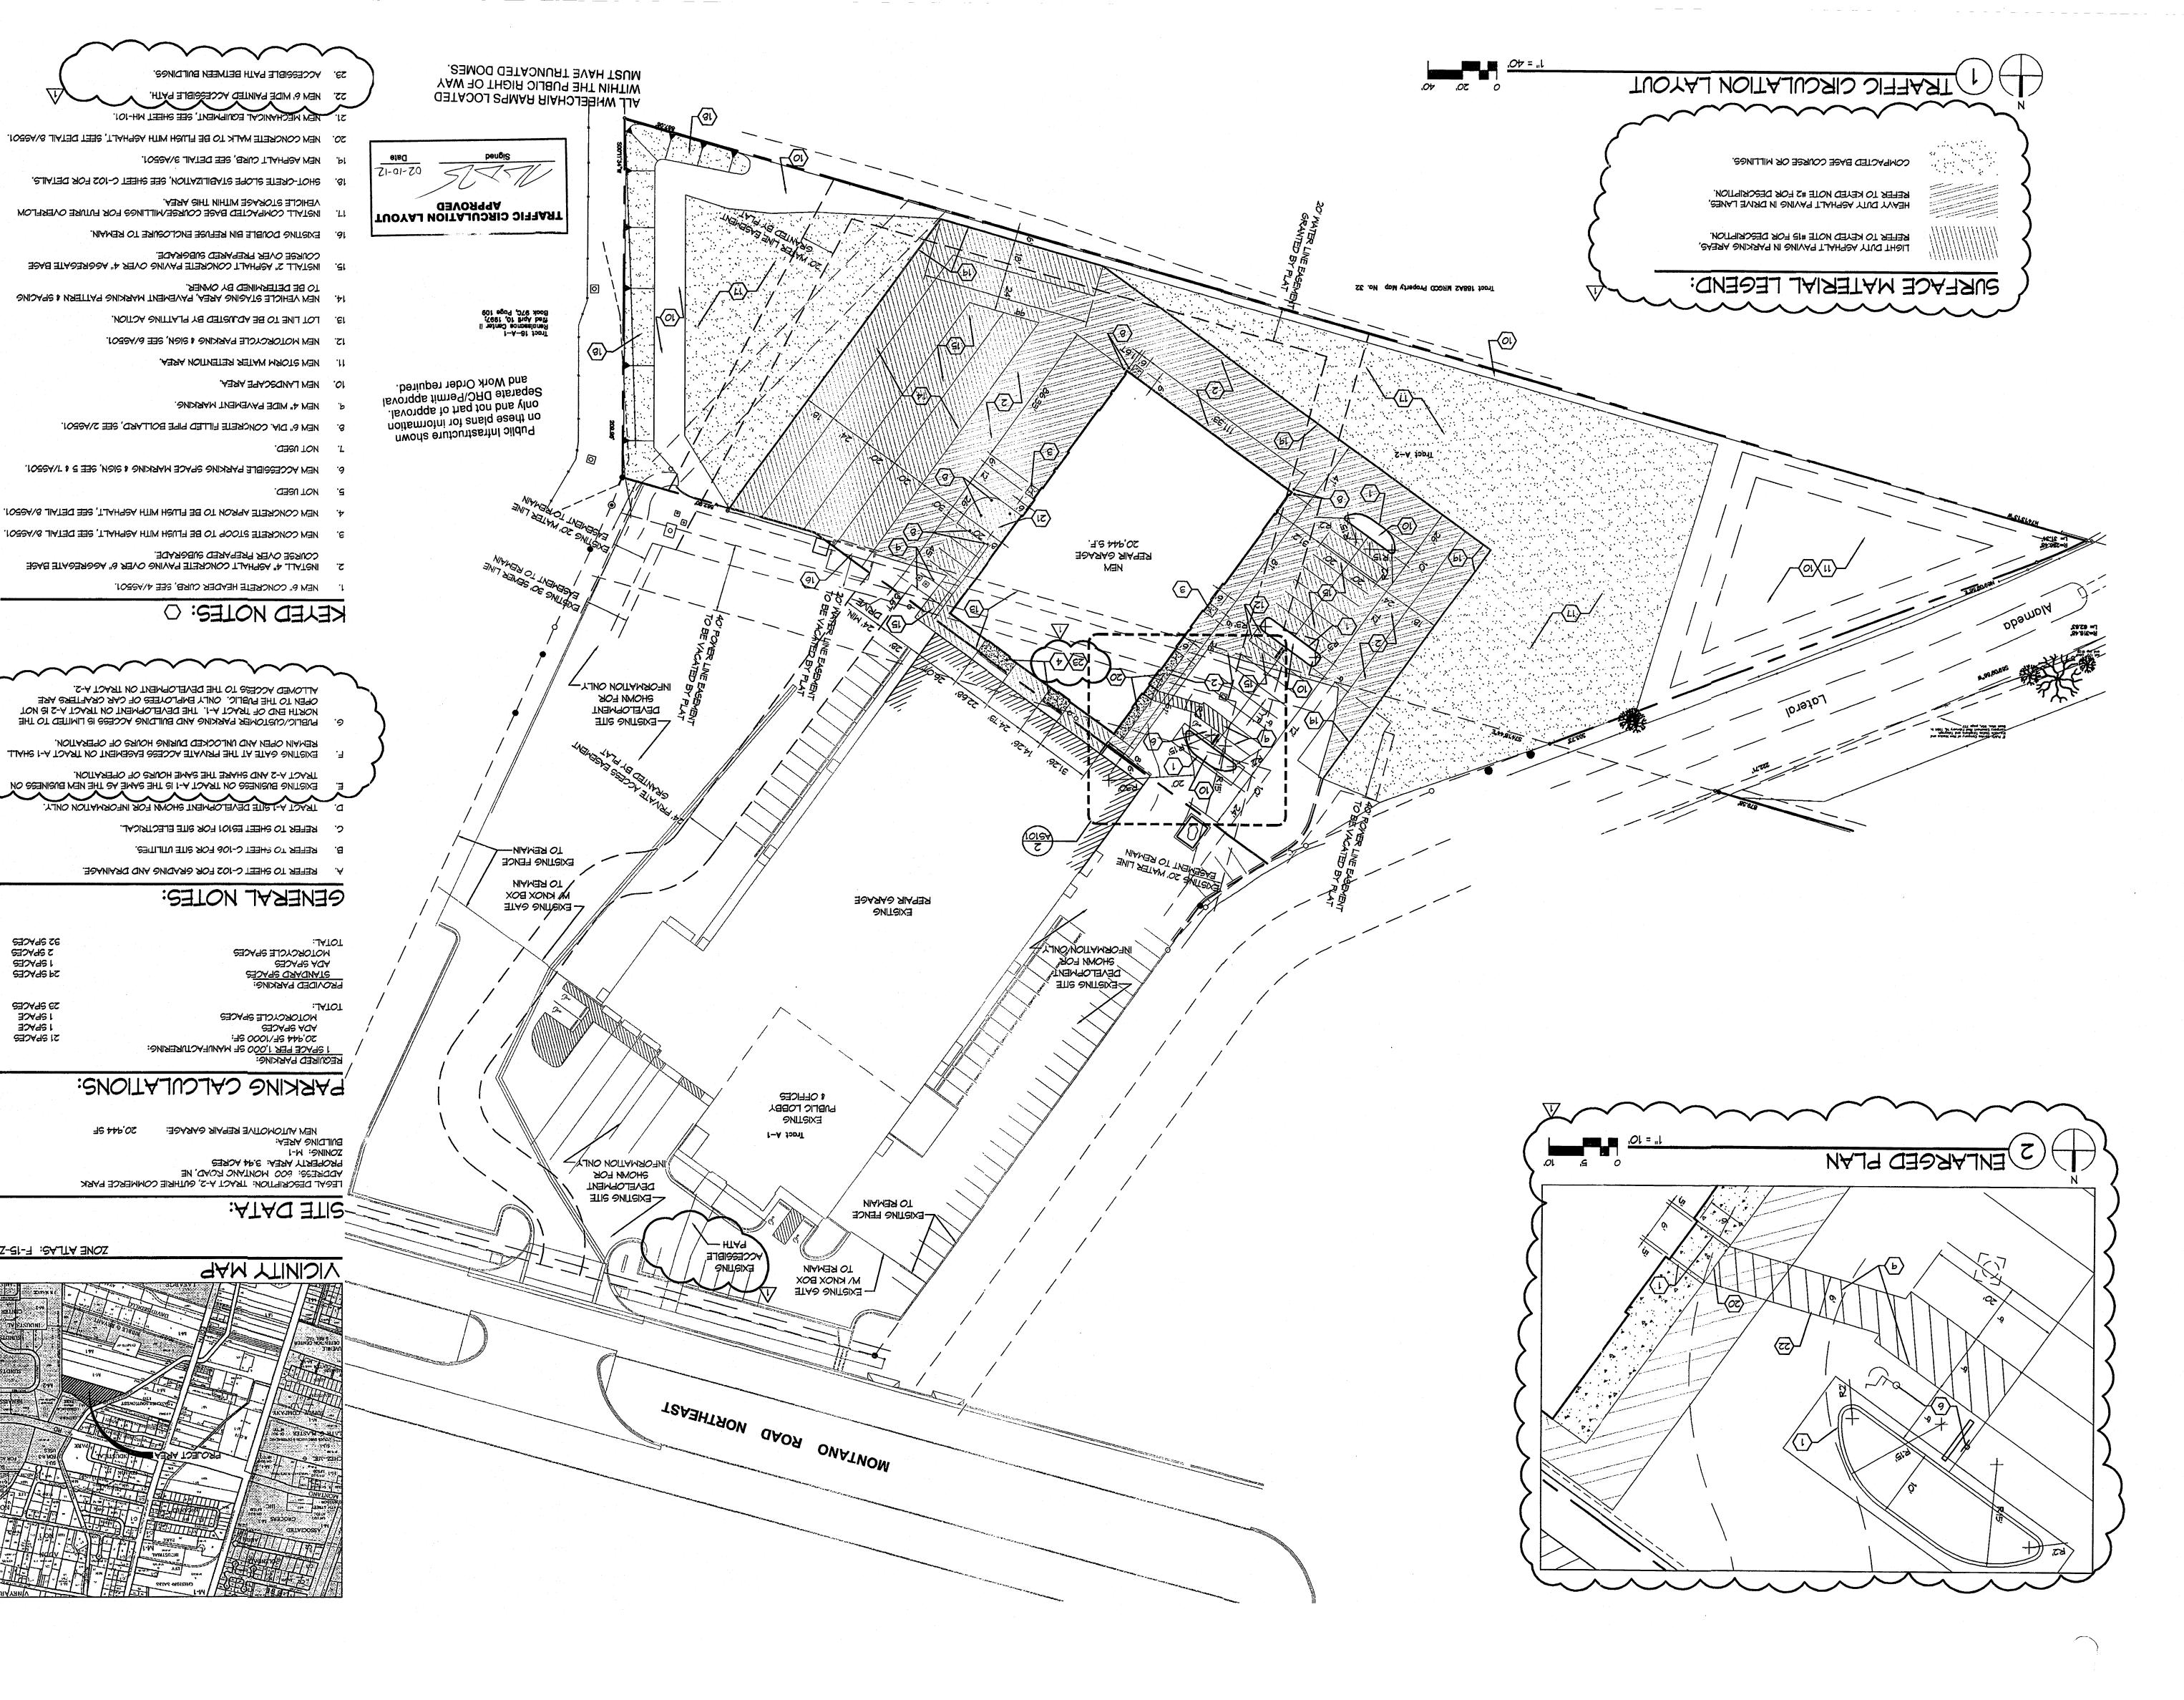
PROFILE

DSA

Darren Sowell

4700 Lincoln N.E., Suite 111 Albuquerque, N.M. 87109 Phone: (505) 342-6200 Fax: (505) 342-6201



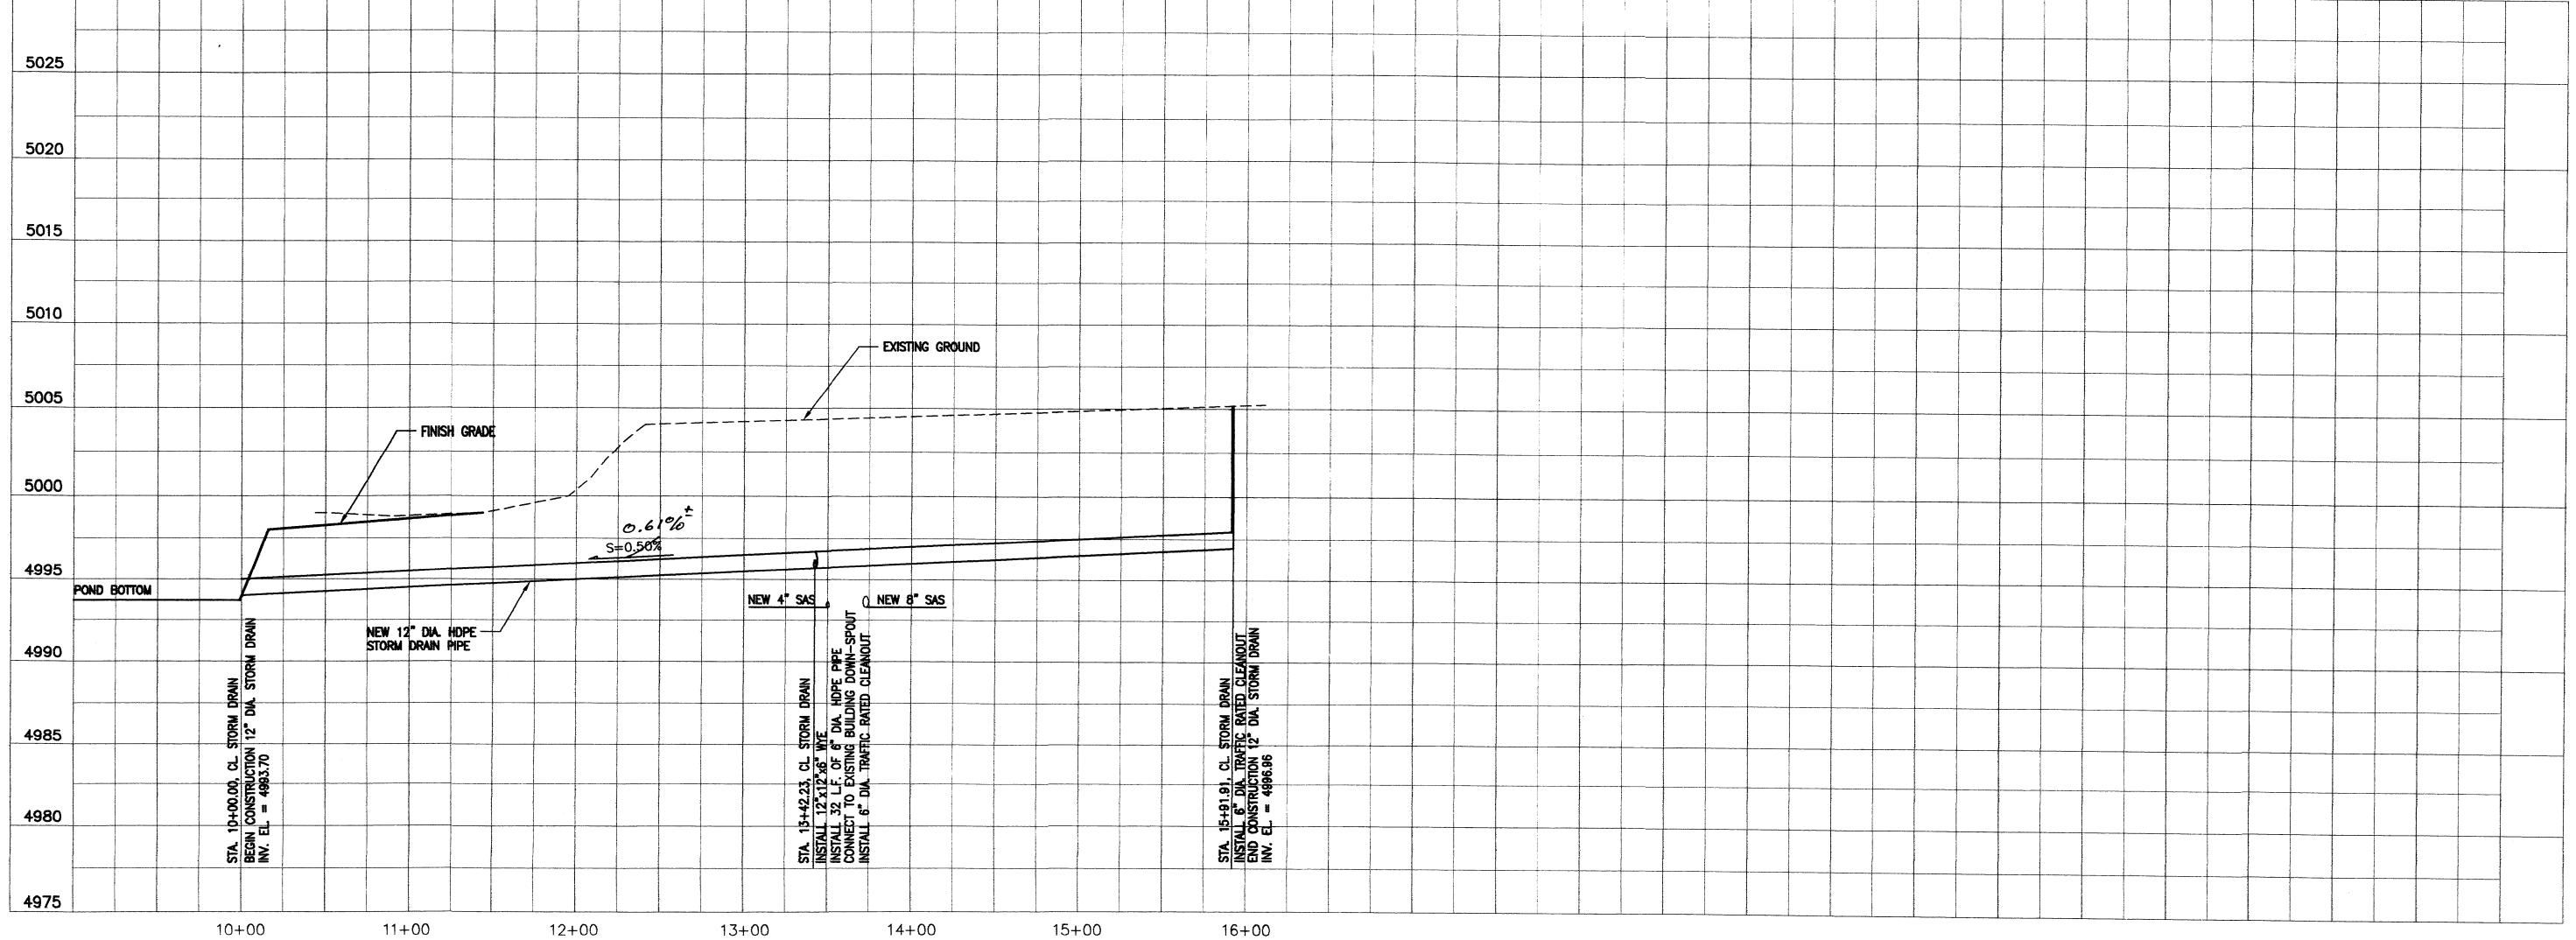

Scale: AS SHOWN TUOYAL CIRCULATION **SIJJAAT** ssue Date Septmenber 23, 2011 Срескед

Drawn By

Project Number

1 1-31-2012 PERMIT COMMENTS SECTION

HADBOTOGA EE8 02 7015 BECEINED

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cepair Ga Blvd. NE w Mexico NE Garage 87107

230A98 S 230A98 SE

1 SPACES

29 SPACES


23 SPACES 1 SPACE


SHOARS IS

ZONE ATLAS: F-15-Z

21-2-2

Albuquerque, N.M. 87109 Phone: (505) 342-6200 Fax: (505) 342-6201 4700 Lincoln M.E., Suite 111 ARCHITECTS Darren Sowell VSCI

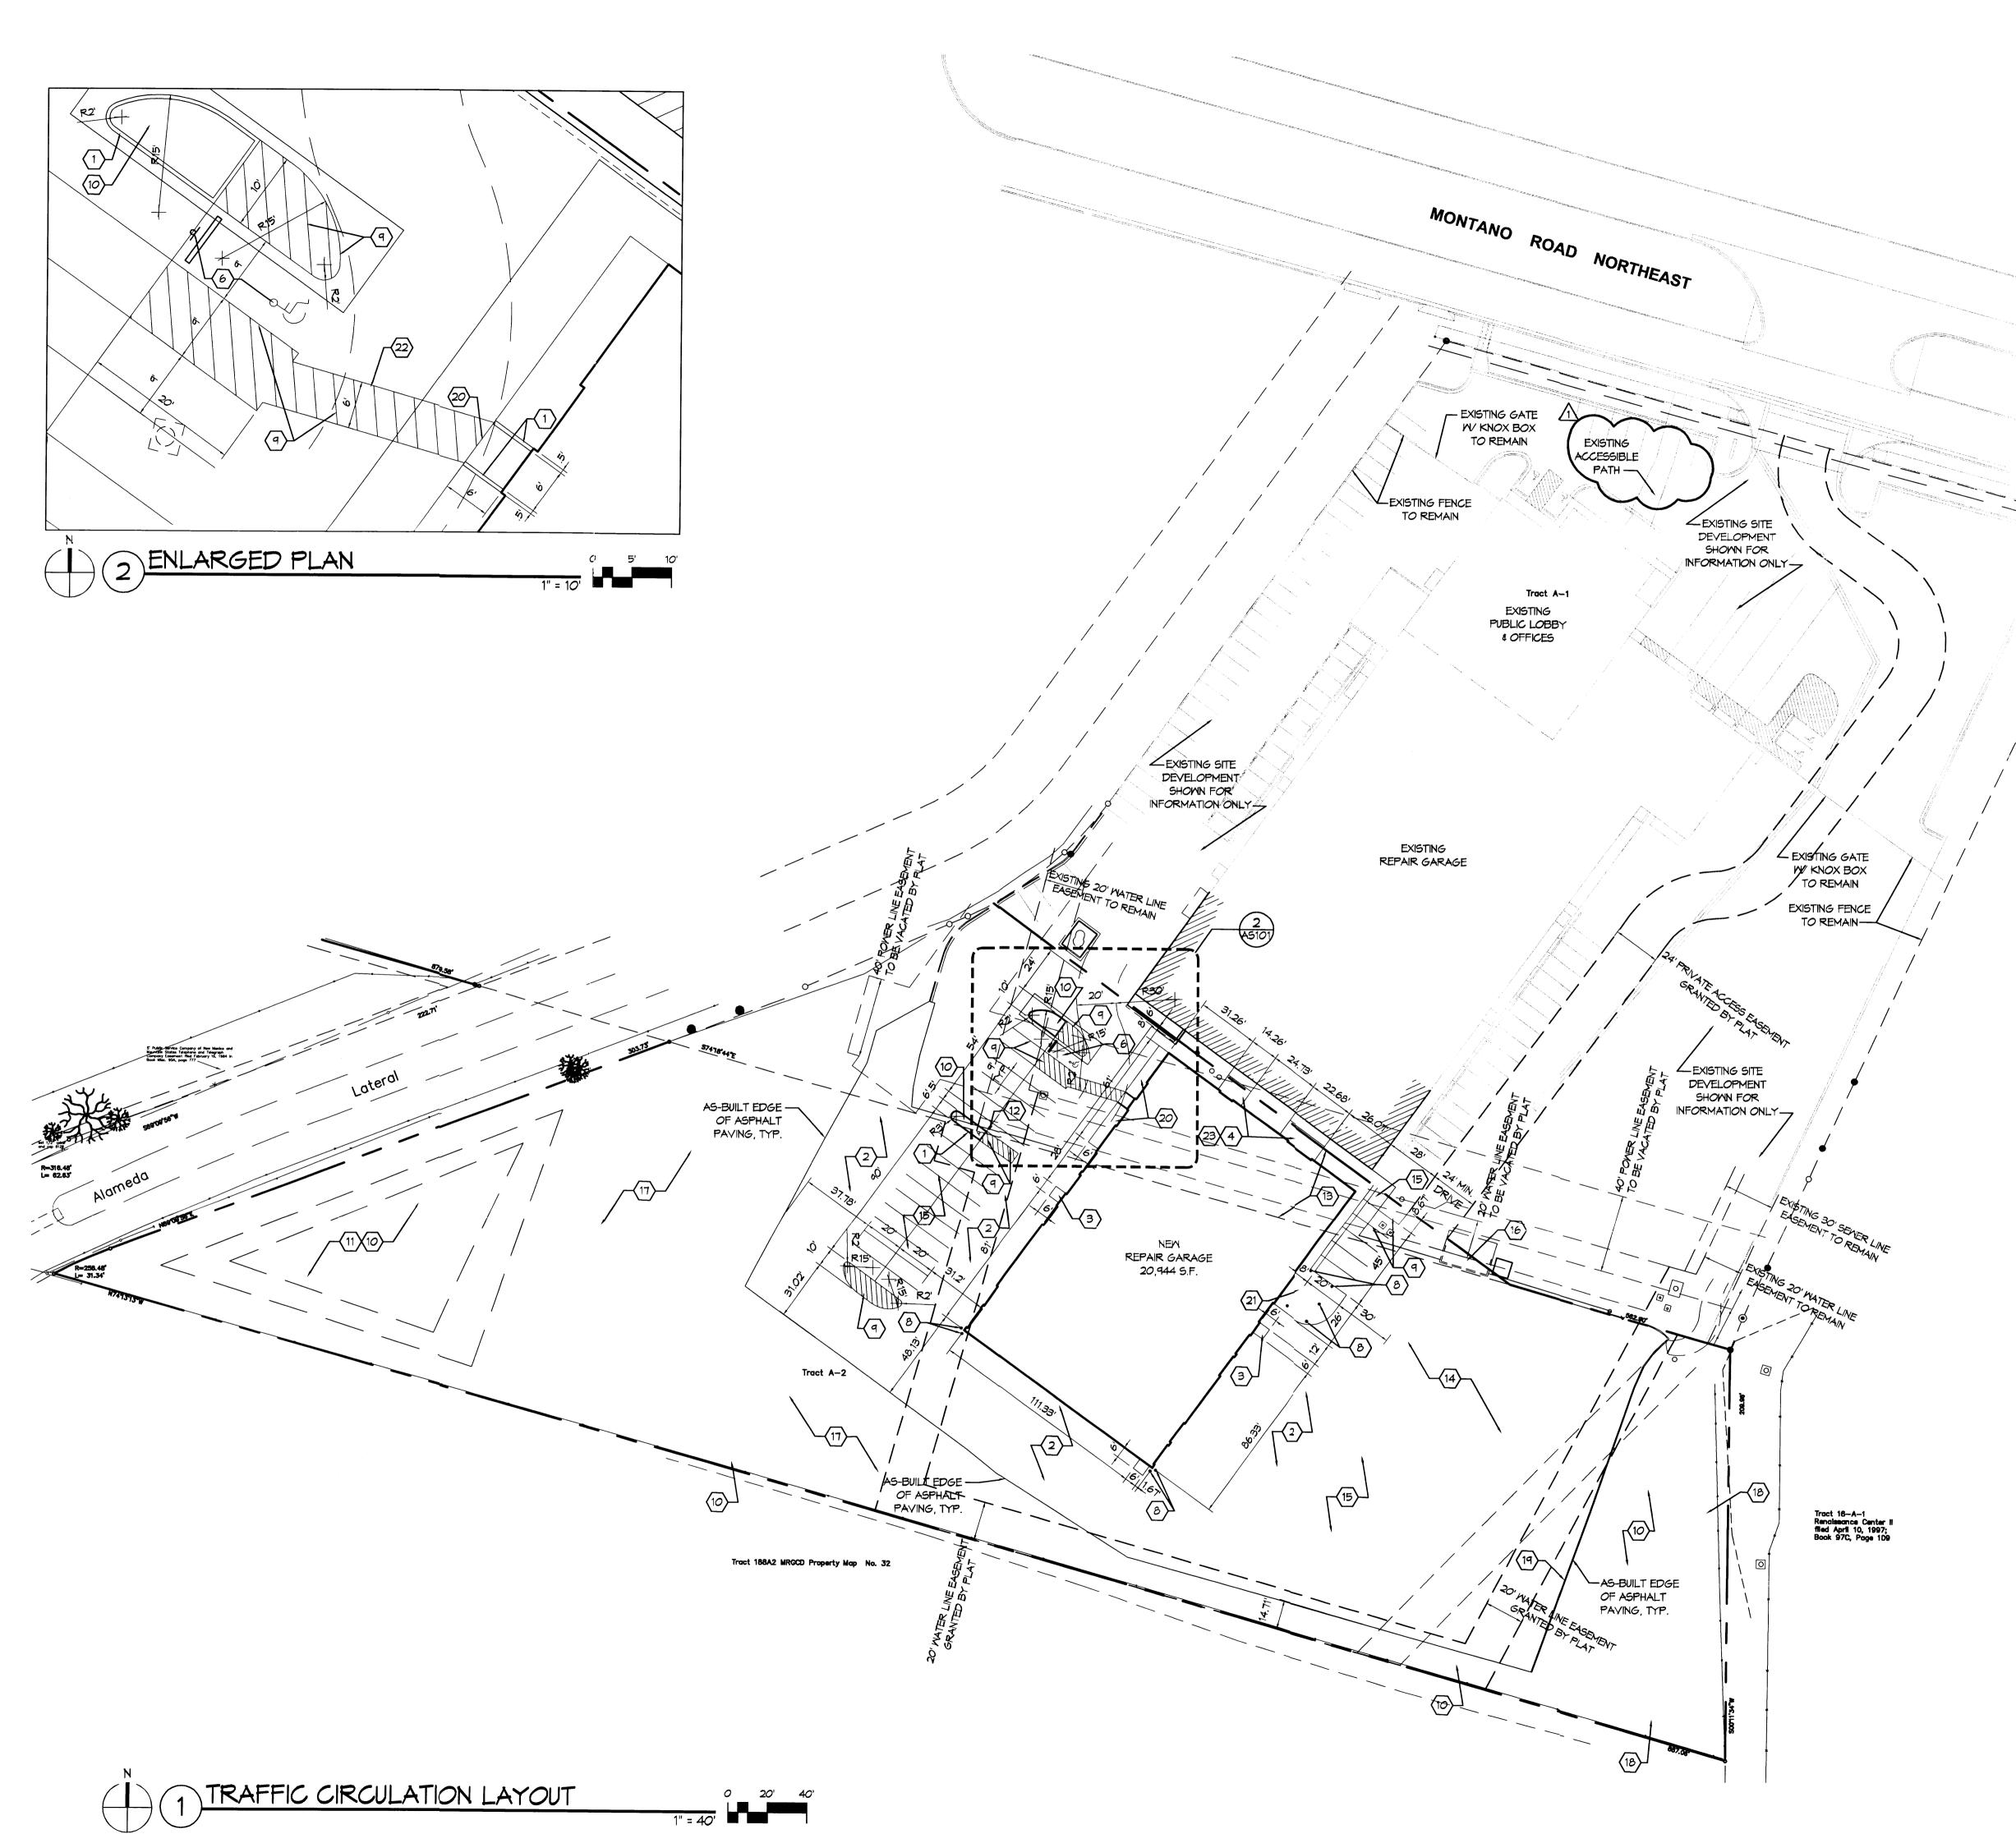

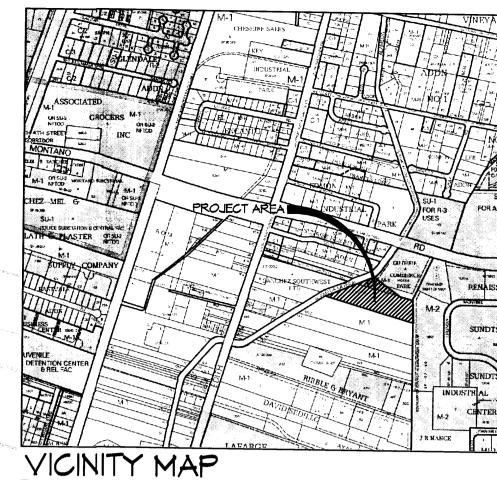

ZONE ATLAS: F-15-Z

SITE DATA:

LEGAL DESCRIPTION: TRACT A-2, GUTHRIE COMMERCE PARK ADDRESS: 600 MONTANO ROAD, NE PROPERTY AREA: 3.94 ACRES ZONING: M-1

BUILDING AREA: NEW AUTOMOTIVE REPAIR GARAGE:

PARKING CALCULATIONS:

REQUIRED PARKING:

1 SPACE PER 1,000 SF MANUFACTURERING:
20,944 SF/1000 SF: ADA SPACES

MOTORCYCLE SPACES

21 SPACES 1 SPACE 1 SPACE 23 SPACES

PROVIDED PARKING: STANDARD SPACES ADA SPACES MOTORCYCLE SPACES

29 SPACES 1 SPACES 2 SPACES 32 SPACES

GENERAL NOTES:

- REFER TO SHEET C-102 FOR GRADING AND DRAINAGE.
- B. REFER TO SHEET C-106 FOR SITE UTILITIES.
- REFER TO SHEET ES101 FOR SITE ELECTRICAL.
- D. TRACT A-1 SITE DEVELOPMENT SHOWN FOR INFORMATION ONLY.
- EXISTING BUSINESS ON TRACT A-1 IS THE SAME AS THE NEW BUSINESS ON TRACT A-2 AND SHARE THE SAME HOURS OF OPERATION.
- F. EXISTING GATE AT THE PRIVATE ACCESS EASEMENT ON TRACT A-1 SHALL REMAIN OPEN AND UNLOCKED DURING HOURS OF OPERATION.
- G. PUBLIC/CUSTOMER PARKING AND BUILDING ACCESS IS LIMITED TO THE NORTH END OF TRACT A-1. THE DEVELOPMENT ON TRACT A-2 IS NOT OPEN TO THE PUBLIC. ONLY EMPLOYEES OF CAR CRAFTERS ARE ALLOWED ACCESS TO THE DEVELOPMENT ON TRACT A-2.

KEYED NOTES: ()

- NEW 6" CONCRETE HEADER CURB, SEE 4/AS501.
- INSTALL 4" ASPHALT CONCRETE PAVING OVER 6" AGGREGATE BASE COURSE OVER PREPARED SUBGRADE.
- 3. NEW CONCRETE STOOP TO BE FLUSH WITH ASPHALT, SEE DETAIL 8/AS501.
- 4. NEW CONCRETE APRON TO BE FLUSH WITH ASPHALT, SEE DETAIL 8/AS501.
- 5. NOT USED.
- 6. NEW ACCESSIBLE PARKING SPACE MARKING & SIGN, SEE 5 & 7/AS501.
- 7. NOT USED.
- 8. NEW 6" DIA. CONCRETE FILLED PIPE BOLLARD, SEE 2/AS501.
- 9. NEW 4" WIDE PAVEMENT MARKING.
- 10. NEW LANDSCAPE AREA.
- 11. NEW STORM WATER RETENTION AREA.
- 12. NEW DOUBLE-SIDED MOTORCYCLE PARKING SIGN, SEE 6/AS501.
- 13. LOT LINE TO BE ADJUSTED BY PLATTING ACTION.
- 14. NEW VEHICLE STAGING AREA, PAVEMENT MARKING PATTERN & SPACING TO BE DETERMINED BY OWNER.
- INSTALL 2" ASPHALT CONCRETE PAVING OVER 4" AGGREGATE BASE COURSE OVER PREPARED SUBGRADE.

16. EXISTING DOUBLE BIN REFUSE ENCLOSURE TO REMAIN.

- 17. INSTALL COMPACTED BASE COURSE/MILLINGS FOR FUTURE OVERFLOW VEHICLE STORAGE WITHIN THIS AREA.
- 18. SLOPE NOT TO EXCEED 3:1, SEE SHEET C-102 FOR DETAILS.
- 19. NEW ASPHALT CURB, SEE DETAIL 3/AS501.
- 20. NEW CONCRETE WALK TO BE FLUSH WITH ASPHALT, SEET DETAIL 8/AS501.
- 21. NEW MECHANICAL EQUIPMENT, SEE SHEET MH-101.
- 22. NEW 6' WIDE PAINTED ACCESSIBLE PATH.
- 23. ACCESSIBLE PATH BETWEEN BUILDINGS.

Garage Repair th Blvd. É Z utomoti 5404

DSA

Darren Sowell ARCHITECTS

4700 Lincoln N.E., Suite 111 Albuquerque, N.M. 87109 Phone: (505) 342-6200


Fax: (505) 342-6201

1 1-31-2012 PERMIT COMMENTS 2 8-8-12 RECORD DRAWING

Project Number Drawn By Checked Issue Date Septmenber 23, 2011 TRAFFIC CIRCULATION

LAYOUT

Scale: AS SHOWN

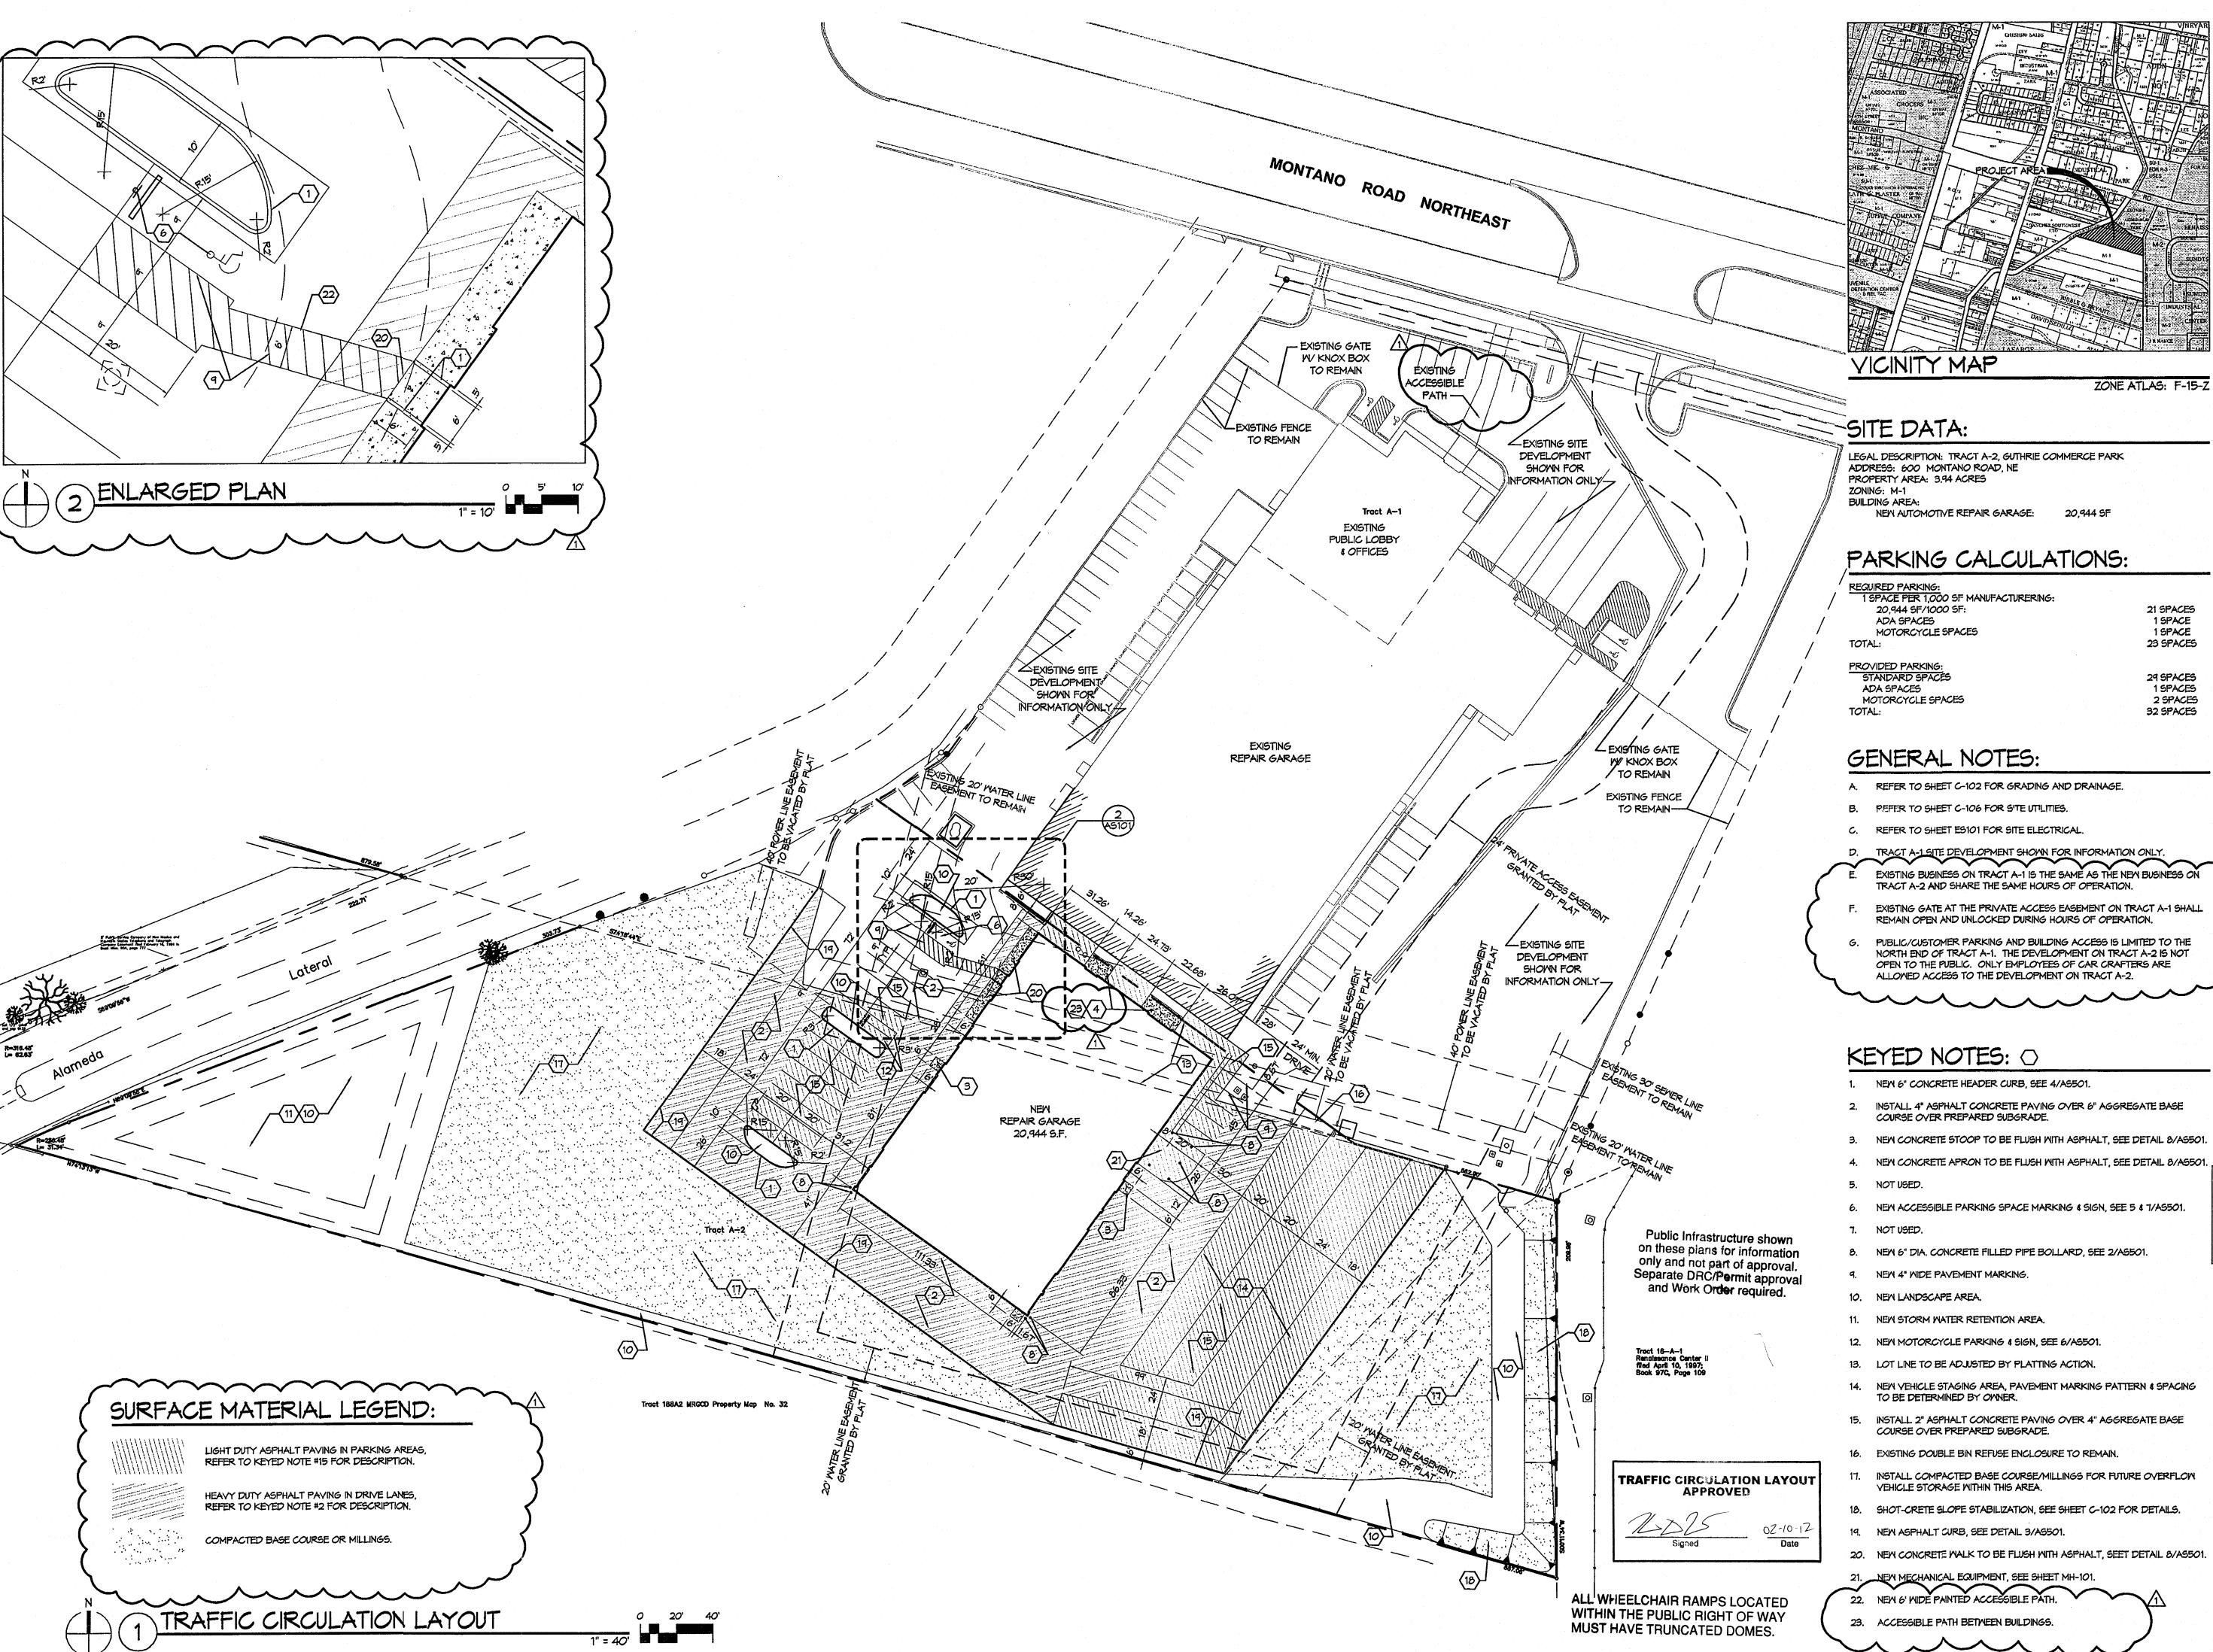

Darren Sowell

ARCHITECTS 4700 Lincoln N.E., Suite 111 Albuquerque, N.M. 87109 Phone: (505) 342-6200

Fax: (505) 342-6201



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- PUBLIC/CUSTOMER PARKING AND BUILDING ACCESS IS LIMITED TO THE NORTH END OF TRACT A-1. THE DEVELOPMENT ON TRACT A-2 IS NOT OPEN TO THE PUBLIC. ONLY EMPLOYEES OF CAR CRAFTERS ARE
- 3. NEW CONCRETE STOOP TO BE FLUSH WITH ASPHALT, SEE DETAIL 8/AS501.
- 14. NEW VEHICLE STAGING AREA, PAVEMENT MARKING PATTERN & SPACING
- 15. INSTALL 2" ASPHALT CONCRETE PAVING OVER 4" AGGREGATE BASE
- 17. INSTALL COMPACTED BASE COURSE/MILLINGS FOR FUTURE OVERFLOW
- 20. NEW CONCRETE WALK TO BE FLUSH WITH ASPHALT, SEET DETAIL 8/AS501.

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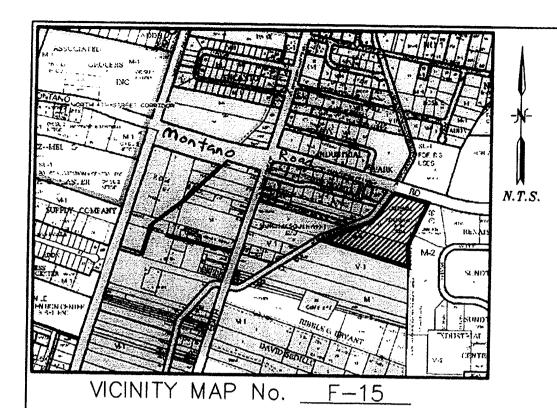
FEB 07 2012 **HYDROLOGY** SECTION

1 1-31-2012 PERMIT COMMENTS

Project Number Checked Issue Date Septmenber 23, 2011

TRAFFIC CIRCULATION LAYOUT

Scale: AS SHOWN



APPROVED on the condition that all rights of the Middle Rio Grande Conservancy District in easements, rights of way, assessments and liens, are fully reserved to said District, and that If provision for irrigation source and easements are not provided for by the subdivider for the subdivision, addition, or plat, said District is absolved of all obligations to furnish irrigation waters and services to any portions thereof, other than from existing turnouts. APPROVED A. PSILL DATE 11/14/11

PURPOSE OF PLAT:

THE PURPOSE OF THIS PLAT IS TO RE-ALIGN THE LOT LINE BETWEEN TRACT A AND TRACT 188A1B M.R.G.C.D. MAP No. 32, VACATE A PORTION OF THE PUBLIC WATERLINE EASEMENT AS SHOWN AND GRANT ALL EASEMENTS AS SHOWN

GENERAL NOTES:

- 1: UNLESS NOTED, No. 4 REBAR WITH CAP STAMPED P.S.#11463 WERE SET AT ALL PROPERTY CORNERS.
- 2: THIS PLAT SHOWS ALL EASEMENTS OF RECORD. 3: TOTAL AREA OF PROPERTY: 7.7279 ACRES.
- 4: TALOS LOG NO. ____N/A
- 5: BASIS OF BEARINGS IS THE NEW MEXICO STATE PLANE
- ORDINATE SYSTEM, CENTRAL ZONE, NAD 1983. 6: DISTANCES ARE GROUND, BEARINGS ARE GRID.
- 7: BEARINGS AND DISTANCES SHOWN IN PARENTHESIS ARE RECORD.
- 8: DATE OF FIELD WORK: MAY/JUNE 2011
- 9: NO PROPERTY WITHIN THE AREA OF THIS PLAT SHALL AT ANY TIME BE SUBJECT TO A DEED RESTRICTION, COVENANT, OR BINDING AGREEMENT PROHIBITING SOLAR COLLECTORS FROM BEING INSTALLED ON BUILDINGS OR ERECTED ON LOTS OR PARCELS WITHIN THE AREA OF PROPOSED PLAT
- 10: Annexation Case No. 0-11-63
- 11: Enactment No. 0-2011-030
- 12: This Property lies within the City Limits for the City of Albuguerque.
- 13: By the recording of this plat, a reciprocal drainage Easement is granted for the benefit of Tracts A-1

THIS IS TO CERTIFY THAT TAXES ARE CURRENT AND PAID ON UPC#101506143912540239 101506146215840241 PROPERTY OWNER OF RECORD: Headstart Enterprises BERNALILLO CO. TREASURER'S OFFICE: 11-12-1

LEGAL DESCRIPTION

TRACT LETTERED 'A' OF THE PLAT OF GUTHRIE COMMERCE PARK, CITY OF ALBUQUERQUE, BERNALILLO COUNTY, NEW MEXICO, AS THE SAME IS SHOWN AND DESIGNATED ON THE PLAT THEREOF, FILED IN THE OFFICE OF THE COUNTY CLERK OF BERNALILLO COUNTY, NEW MEXICO ON MAY 10, 2007 IN PLAT BOOK 2007C, PAGE 115 AND TRACT NUMBERED 188-A-1-B AS SHOWN ON THE MIDDLE RID GRANDE CONSERVANCY DISTRICT MAP No. 32, ALL BEING MORE PARTICULARLY DESCRIBED AS FOLLOWS BEGINNING AT THE NORTHEAST CORNER OF THE HEREIN DESCRIBED TRACT, BEING A POINT ON THE SOUTHERLY LINE OF MONTANO ROAD, WHENCE CITY OF ALBUQUERQUE CONTROL MONUMENT "I-25-20" HAVING NEW MEXICO STATE PLANE COORDINATES OF (CENTRAL ZONE, 1983) N= 1502367.513 AND E= 1530649.760 BEARS S 36*37'35' E, A DISTANCE OF 3016.70 FEET RUNNING THENCE S 25'02'55' W, A DISTNACE OF 312.51 FEET TO A POINT, THENCE S 24.52'02" W, A DISTANCE OF 133.88 FEET TO A POINT, THENCE S 21.08'39' W, A DISTANCE OF 17.31 FEET TO A POINT, THENCE S 00-11'52' W, A DISTANCE OF 209.96 FEET TO THE SOUTHEAST CORNER, THENCE N 74°12'55' W, A DISTANCE OF 885.83 FEET TO THE SOUTHWEST CORNER, BEING A POINT ON THE EASTELRY LINE OF THE ALAMEDA LATERAL; THENCE ALONG THE EASTERLY LINE OF THE ALAMEDA LATERAL FOR THE NEXT 5 CALLS 30.42 FEET ALONG THE ARC OF A CURVE TO THE RIGHT HAVING A RADIUS OF 256.48, A CENTRAL ANGLE OF 06'47'43' FEET AND HAVING A CHORD BEARING AND DISTANCE OF N 65'45'40' E, 30.40 FEET TO A POINT OF TANGENCY, THENCE N 69°01'14' E, A DISTANCE OF 303.73 FEET TO AN ANGLE POINT;
THENCE N 66°24'45' E, A DISTANCE OF 166.18 FEET TO A POINT OF CURVE; THENCE 92.43 FEET ALONG THE ARC OF A CURVE TO THE LEFT HAVING A RADIUS OF 173.25 FEET, A CENTRAL ANGLE OF 30°34'01' AND HAVING A CHORD BEARING AND DISTANCE OF N 51°07'03' E, 91.34 FEET TO A POINT OF TANGENCY, THENCE N 35*50'44" E, A DISTANCE OF 292.85 FEET TO THE NORTHWEST CORNER, BEING A POINT ON THE SOUTHERLY LINE OF MONTANO ROAD, THENCE LEAVING THE EASTERLY LINE OF THE ALAMEDA LATERAL, S 74°49'30' E, ALONG THE SOUTHERLY LINE OF MONTAND ROAD, A DISTANCE OF 354.14 FEET TO THE NORTHEAST CORNER AND PLACE OF BEGINNING CONTAINING 7.7279 ACRES MORE OR LESS

PUBLIC UTILITY EASEMENTS

PUBLIC UTILITY EASEMENTS shown on this plat are granted for the common and joint

A. Public Service Company of New Mexico ("PNM"), a New Mexico corporation, (PNM Electric) for installation, maintenance, and service of overhead and underground electrical lines, transformers, and other equipment and related facilities reasonably necessary to provide electrical services.

B. New Mexico Gas Company for installation, maintenance, and service of natural gas lines, valves and other equipment and facilities reasonably necessary to provide

natural gas services. C. Qwest for the installation, maintenance, and service of such lines, cable, and other related equipment and facilities reasonably necessary to provide communication

services.

D. Cable TV for the installation, maintenance, and service of such lines, cable, and other related equipment and facilities reasonably necessary to provide Cable services. included, is the right to build, rebuild, construct, reconstruct, locate, relocate, change, remove, replace, modify, renew, operate and maintain facilities for purposes described above, together with free access to, from, and over said easements, with the right and privilege of going upon, over and across adjoining lands of Grantor for the purposes set forth herein and with the right to utilize the right of way and easement to extend services to customers of Grantee, including sufficient working area space for electric transformers, with the right and privilege to trim and remove trees, shrubs or bushes which interfere with the purposes set forth herein. No building, sign, pool (aboveground or subsurface), hot tub, concrete or wood pool decking, or other (aboveground or subsurface), hot tub, concrete or wood pool decking, or other structure shall be erected or constructed on said easements, nor shall any well be drilled or operated thereon. Property owners shall be soluly responsible for correcting any violations of National Electrical Safety Code by construction of pools, decking, or any structures adjacent to or near easements shown on this plat. Easements for electric transformer/switchgears, as installed, shall extend ten (10) feet in front of transformer/switchgear doors and five (5) feet on each side.

in approving this plat, Public Service Company of New Mexico (PNM) and New Mexico Gos Company (NMGC) did not conduct a Title Search of the properties shown hereon. Consequently, PNM and NMGC do not waive or release any easement or easement rights which may have been granted by prior plat, replat or other document and which are not shown on this plat.

FREE CONSENT

THE SUBDIVISION HEREON DESCRIBED IS WITH THE FREE CONSENT AND IN ACCORDANCE WITH THE DESIRES OF THE JNDERSIGNED OWNERS AND PROPRIETOR THEREOF. SAID OWNER / PROPRIETOR DOES HEREBY GRANT ANY AND ALL EASEMENTS AS MAY BE CREATED BY THIS PLAT. THOSE SIGNING AS OWNERS WARRANT THAT THEY HOLD AMONG THEM COMPLETE AND INDEFEASIBLE TITLE IN FEE SIMPLE TO THE LAND SUBDIVIDED.

uth Jim Guthrie

ACKNOWLEDGMENT STATE OF NEW MEXICO) S.S. COUNTY OF BERNALILLO)

THIS INSTRUMENT WAS ACKNOWLEDGED BEFORE ME A NOTARY PUBLIC _ DAY OF Dolober 2011

10-13-11

BY: Jim Guthine

MY COMMISSION EXPIRES: July 18, 2012 BY: 400 BY

PLAT OF

TRACTS A-1 AND A-2 GUTHRIE COMMERCE PARK

ELENA GALLEGOS LAND GRANT AND TOWN OF ALBUQUERQUE GRANT PROJECTED SECTION 33, TOWNSHIP 11 NORTH, RANGE 3 EAST, N.M.P.M. CITY OF ALBUQUERQUE BERNALILLO COUNTY, NEW MEXICO

OCTOBER, 2011

PROJECT NUMBER: 1004228	
APPLICATION NUMBER: 11 DRB 70313	
UTILITY APPROVALS: Vihille Y. Salleans PUBLIC SERVICE COMPANY OF NEW MEXICO	11-22-20 DATE
	// -14-201) DATE
NEW MERICO CAS COMPANY	
QWEST TELECOMMUNICATIONS OF THE THEY I	INK QC DATE
- SOT WHEN THE	IMA GIC DATE
COMCAST NOTE IN FILE	DATE
	5 7 2
CITY APPROVALS:	
M R 21/2.1	
MIV SUBJECTION () JOHN ()	10-31-11 DATE
CITY SURVEYOR	DATE
4/4	1
*REAL PROPERTY DIVISION (CONDITIONAL)	DATE
ν/A	
**ENVIRONMENTAL HEALTH DEPARTMENT (CONDITIONAL)	DATE
155	
TRAFFIC ENGINEERING, TRANSPORTATION DIVISION	11-16-11 DATE
$\triangle A \wedge A $,
ABCWUA Cotte	16/6/11
	DATE
PARKS AND RECREATION DEPARTMENT	11/16/11 DATE
	DATE
Center a chee	11-16-11
	DATE
Center a. cheme	11-16-4
CITY ENGINEER	DATE
K/ / / / /	.,
DRB CHAIRPERSON, PLANNING DEPARTMENT	//-ZZ-(1 DATE
	VAIL

APPROVED on the condition that all rights
Grande Conservants ights of way, as reserved to on for Irrinot prosubdivi-11/22/2011 12:23 PM Page: 1 of 2 styPLAT R:\$25.00 B: 2011C P: 0126 M. Toulous Olivere, Bernalill ot is ab-ish irriga-PEB 07 2012 any portions ...isting turnous.

SURVEYORS CERTIFICATE: STATE OF NEW MEXICO) S.S. COUNTY OF BERNALILLO)

DOC# 2011106586

I, ANTHONY L. HARRIS, A DULY PROFESSIONAL LICENSED LAND SURVEYOR, UNDER THE LAWS OF THE STATE OF NEW MEXICO, DO HEREBY CERTIFY THAT THE PLAT WAS PREPARED UNDER MY DIRECT SUPERVISION, THAT I AM RESPONSIBLE FOR SAID PLAT AND MEETS THE REQUIREMENTS FOR MONUMENTATION AND SURVEY OF THE ALBUQUERQUE SUBDIVISION ORDINANCE AND IS TRUE AND CORRECT TO THE BEST OF MY KNOWLEDGE AND BELIEF AND MEETS THE MINIMUM REQUIREMENTS FOR LAND SURVEYS AS SET FORTH BY THE STATE OF NEW MEXICO.

HYDROLOGY

SECTION


GIVEN UNDER MY HAND AND SEAL AT ALBUQUERQUE, NEW MEXICO, THIS 13th DAY OF October, 2011.

Lowthoung ANTHONY L. HAPRIS. P.S. # 11463 LA CALBUQUERQUE, NEW MEXICO 87110 PAR. (505) 889-8645 PHONE: (505) 889-8056

##483

DATE

SHEET 1 OF 2

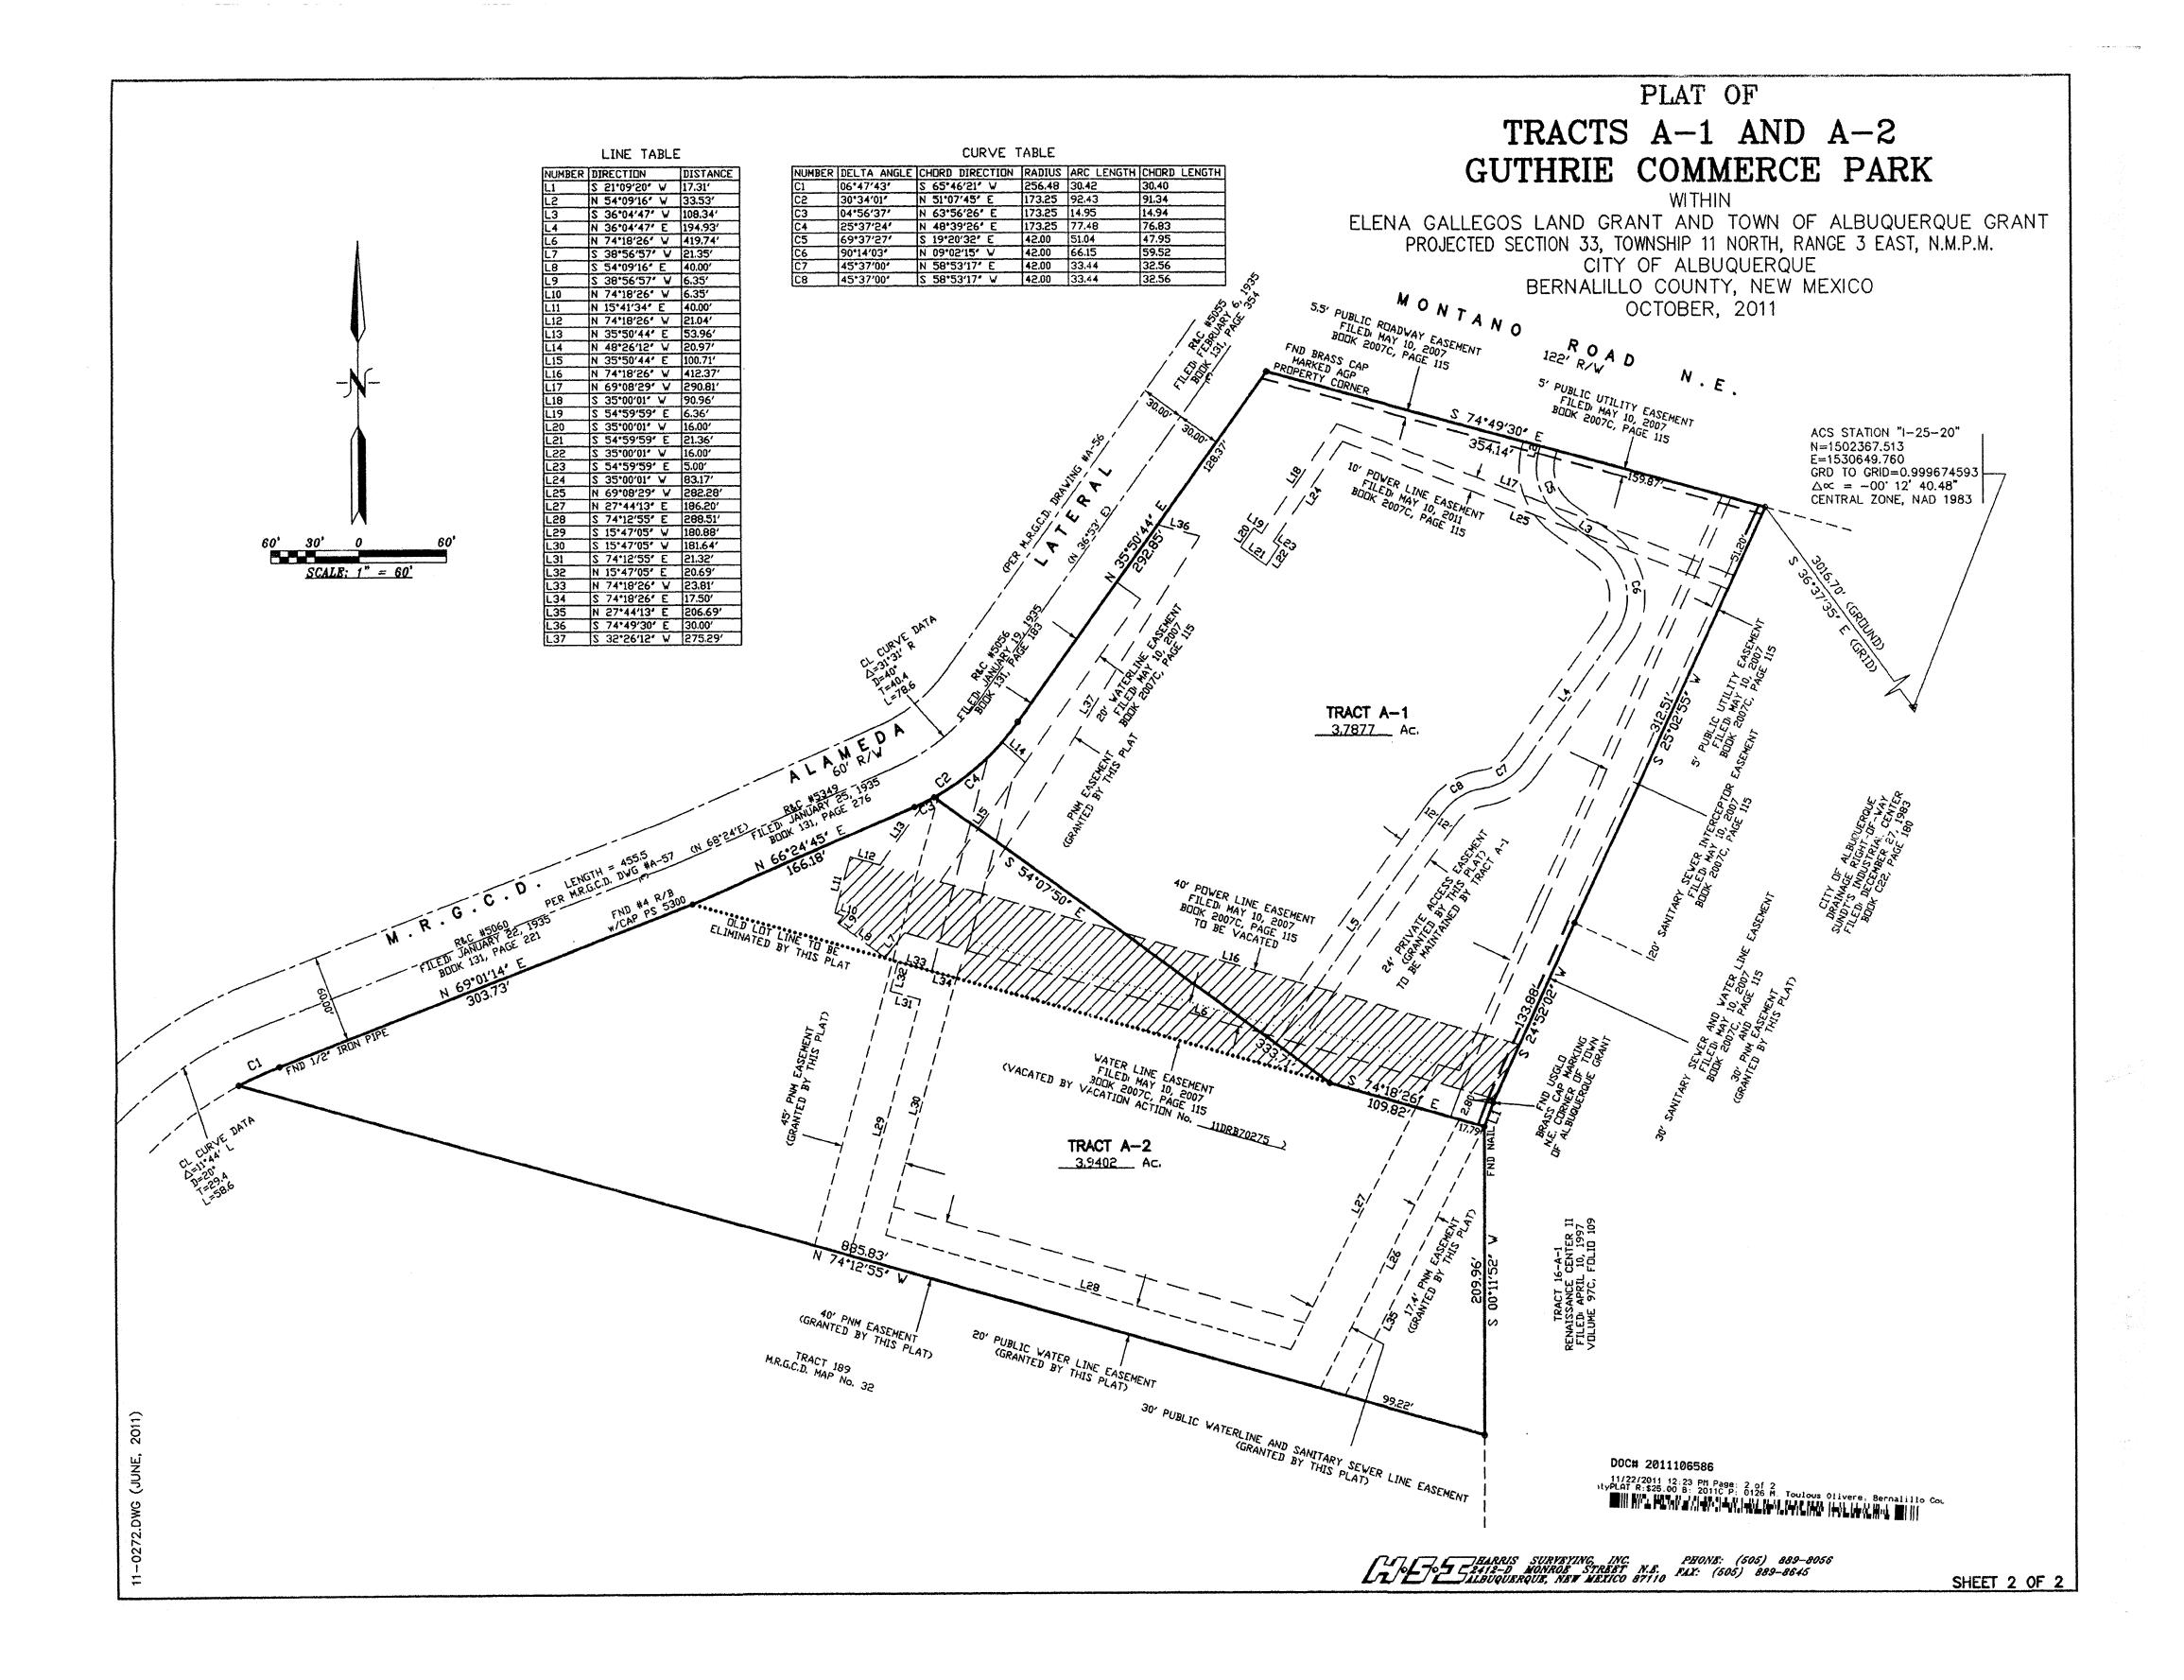

GENERAL CONSTRUCTION NOTES:

- THE CONTRACTOR SHALL CONTACT THE LOCAL UTILITY SUPPLIERS AT LEAST THREE (3) DAYS PRIOR TO ANY UTILITY CONSTRUCTION (INCLUDING CONNECTIONS TO EXISTING SYSTEM) TO COORDINATE THE VARIOUS ITEMS OF WORK WITH OPERATIONS STAFF. THE CONTRACTOR SHALL CONTACT WATER UTILITY TWO (2) WEEKS PRIOR TO WATER SHUT-OFF AND INFORM ANY AFFECTED USERS OF INTERRUPTIONS IN UTILITY SERVICES.
- ALL TEES, BENDS AND CAPS ON WATER PIPING SHALL BE BLOCKED ACCORDING CITY OF ALBUQUERQUE STANDARD DETAIL 2320.
- 3. ALL TRENCH BACKFILL SHALL BE COMPACTED TO A MINIMUM OF 95% OF OPTIMUM (MODIFIED) ASTM D-1557, ±2%.
- 4. ALL NON-UTILITY WORK DETAILED ON THESE PLANS SHALL BE PERFORMED EXCEPT AS OTHERWISE STATED IN ACCORDANCE WITH THE AWWA STANDARD SPECIFICATIONS FOR PUBLIC WORKS CONSTRUCTION, CURRENT EDITION AS AMENDED.
- 5. PRIOR TO CONSTRUCTION, THE CONTRACTOR SHALL EXCAVATE AND VERIFY THE HORIZONTAL AND VERTICAL LOCATIONS OF ALL OBSTRUCTIONS AND EXISTING PAVEMENT. SHOULD A CONFLICT EXIST, THE CONTRACTOR SHALL NOTIFY THE ENGINEER SO THAT THE CONFLICT CAN BE RESOLVED WITH A MINIMUM AMOUNT OF DELAY.
- 6. EXISTING UTILITY LINE LOCATIONS ARE SHOWN IN AN APPROXIMATE MANNER ONLY, AND SUCH LINES MAY EXIST WHERE NONE ARE SHOWN. THE LOCATION OF ANY SUCH EXISTING LINES IS BASED ON INFORMATION PROVIDED BY THE UTILITY COMPANY, THE OWNER, OR OTHERS, AND THE INFORMATION MAY BE INCOMPLETE OR MAY BE OBSOLETE BY THE TIME CONSTRUCTION COMMENCES. THE CONTRACTOR SHALL COMPLY WITH STATE STATUTES, MUNICIPAL AND LOCAL ORDINANCES, RULES AND REGULATIONS PERTAINING TO THE LOCATION OF THESE LINES AND FACILITIES IN PLANNING AND CONDUCTING EXCAVATION, WHETHER BY CALLING OR NOTIFYING THE UTILITIES, COMPLY WITH (BLUE STAKE) PROCEDURES, OR OTHERWISE.
- THE GEOTECHNICAL REPORT INDICATES THAT ON SITE NON-EXPANSIVE SOILS MAY BE USED FOR ENGINEERED FILL OR FOR GENERAL SITE GRADING AND EXTERIOR SLABS. NO MATERIALS PITS HAVE BEEN DESIGNATED FOR THIS PROJECT. IT IS ANTICIPATED THAT ANY REQUIRED ENGINEERED SOILS WOULD BE OBTAINED FROM EXISTING STATE AND EPA COMPLIANT BORROW SOURCES.
- ALL NEW STREET PAVING AND CURB AND GUTTER SHALL MATCH THE ELEVATIONS OF ABUTTING EXISTING AREAS AS SHOWN IN THE PLANS OR AS DIRECTED BY THE PROJECT OWNERS REPRESENTATIVE.
- THE CONTRACTOR SHALL COORDINATE HIS CONSTRUCTION ACTIVITIES WITH ALL OTHER CONTRACTORS AND UTILITY COMPANIES WORKING IN THE SAME
- 10. WHEN ABUTTING NEW PAVEMENT TO EXISTING, CONTRACTOR SHALL SAW CUT, TO FULL PAVEMENT DEPTH, THE EXISTING PAVEMENT TO A NEAT VERTICAL STRAIGHT LINE AS REQUIRED TO REMOVE ANY BROKEN OR CRACKED PAVEMENT AND MATCH NEW TO EXISTING. THIS WORK SHALL BE CONSIDERED INCIDENTAL AND NO ADDITIONAL PAYMENT WILL BE MADE THEREFORE.
- 11. THE CONTRACTOR SHALL ASSUME RESPONSIBILITY FOR ANY DAMAGE TO EXISTING PAVEMENTS, PAVEMENT MARKINGS, CURB AND GUTTER, OR SIDEWALK DURING CONSTRUCTION, APART FROM THOSE SECTIONS INDICATED FOR REMOVAL ON THE PLANS, AND SHALL REPAIR OR REPLACE IN KIND AT HIS OWN EXPENSE.
- 12. CONTRACTOR SHALL BE RESPONSIBLE FOR ACQUIRING, AT HIS OWN EXPENSE, ALL PERMITS NECESSARY FOR CONSTRUCTION. PERMITS ASSOCIATED WITH ENVIRONMENTAL CONCERNS AND SURFACE DISTURBANCE OF SOILS SHOULD BE ACQUIRED THROUGH THE CITY OF LAS CRUCES OF FEDERAL EPA AS REQIRED
- 13. OVERNIGHT PARKING OF CONSTRUCTION VEHICLES ON PRIVATE PROPERTY IS THE SOLE RESPONSIBILITY OF THE CONTRACTOR.
- 14. ALL TRENCH EXCAVATION BACKFILL WITHIN THE ROADWAY PRISM SHALL BE COMPACTED TO 95% OF THE MODIFIED PROCTOR PER ASTM D-1557 AS APPLICABLE.
- 15. ANY EARTHWORK HAUL ON THIS PROJECT WILL BE CONSIDERED AS INCLUDED IN THE CONTRACT PRICE. NO SEPARATE PAYMENT WILL BE MADE THEREFORE.
- 16. THE CONTRACTOR SHALL BE RESPONSIBLE FOR ALL REMOVALS REQUIRED TO COMPLETE THE PROJECT. ADDITIONAL REMOVALS NOT SHOWN ON THE PLANS WILL BE CONSIDERED INCLUDED IN THE CONTRACT PRICE.
- THE CONSTRUCTION CLEAR ZONE FOR THIS PROJECT IS 30 FT. FROM THE EDGE OF DRIVING LANE. THE CONTRACTOR SHALL NOT STORE EQUIPMENT OR MATERIAL WITHIN THE CONSTRUCTION CLEAR ZONE UNLESS THE EQUIPMENT OR MATERIAL IS PROPERLY SHIELDED UTILIZING CURRENT SAFETY DESIGN AND INSTALLATION METHODS. THE SAFETY DESIGN FOR SHIELDING SHALL BE PROVIDED BY THE CONTRACTOR AND MUST BE APPROVED BY THE OWNERS PROJECT REPRESENTATIVE BEFORE IMPLEMENTING. THIS WORK, INCLUDING DESIGN, INSTALLATION, AND REMOVAL OF THE SHIELDING, SHALL BE CONSIDERED INCIDENTAL TO THE COMPLETION OF THE PROJECT AND NO SEPARATE MEASUREMENT OR PAYMENT WILL BE MADE THEREFOR.
- THE CONTRACTOR SHALL MAINTAIN AN UP TO DATE SET OF AS-BUILT PLANS FOR THE PROJECT. THESE PLANS SHALL BE KEPT CURRENT, WITHIN TWO (2) WEEKS, AT ALL TIMES AND SHALL BE SUBJECT TO REVIEW BY THE OWNERS PROJECT REPRESENTATIVE THROUGHOUT THE PROJECT AND WILL BE REVIEWED BY THE OWNERS PROJECT REPRESENTATIVE FOR ACCURACY AND COMPLETENESS AT LEAST ONCE EVERY 30 DAYS. THE FINAL AS-BUILT PLANS SHALL BE SUBMITTED TO THE OWNER'S MANAGER PRIOR TO FULL PAYMENT.
- 19. CONTRACTOR TO PROVIDE CONSTRUCTION JOINT LAYOUT FOR PCC PAVED AREAS TO ARCHITECT A MINIMUM OF TWO (2) WEEKS PRIOR TO CONCRETE PLACEMENT. WRITTEN APPROVAL OF JOINT LAYOUT MUST BE PROVIDED TO CONTRACTOR PRIOR TO PLACEMENT OF ANY CONCRETE IN THIS AREA.
- 20. THE CONTRACTOR SHALL PREPARE & OBTAIN ANY NECESSARY DUST OR EROSION CONTROL PERMITS FROM REGULATORY AGENCIES. THE CONTRACTOR SHALL PREPARE AN EPA APPROVED STORM WATER POLLUTION PREVENTION (SWPP) PLAN FOR THIS PROJECT. ALL PERMITS MUST BE OBTAINED PRIOR TO START OF CONSTRUCTION.
- 21. THE CONTRACTOR SHALL MAINTAIN AND PROTECT ALL EXISTING SURVEY MONUMENTS WITHIN THE CONSTRUCTION AREA. SHOULD A MONUMENT BE DAMAGED OR DESTROYED IT WILL BE REPLACED IN ACCORDANCE WITH SURVEY PRACTICE STANDARDS AT NO ADDITIONAL EXPENSE TO THE OWNER.
- 22. ALL TRAFFIC HANDLING SHALL COMPLY WITH THE MANUAL OF UNIFORM TRAFFIC CONTROL DEVICES (MUTCD). A TRAFFIC HANDLING CONTROL PLAN SHALL BE PREPARED BY THE CONTRACTOR AND SUBMITTED TO THE ARCHITECT/ENGINEER AND ENTITY HAVING JURISDICTION OVER THE ADJOINING ROADWAYS FOR APPROVAL PRIOR TO COMMENCEMENT OF ANY WORK.
- ALL MATERIAL REQUIRING DISPOSAL SHALL BE REMOVED FROM THE PROJECT SITE AND DISPOSED OF IN AN EPA APPROVED LANDFILL OR APPROPRIATE FACILITY. ALL ASPHALTIC ROADWAY MATERIAL, AND CONCRETE CURB AND GUTTER, IS TO BE REMOVED FROM THE PROJECT. CONTRACTOR SHALL SUBMIT DISPOSAL MANIFEST TO OWNER'S PROJECT REPRESENTATIVE FOR ALL MATERIAL REQUIRING A DISPOSAL MANIFEST. THIS ALSO INCLUDES REMOVAL AND DISPOSAL OF ANY AND ALL TRANSITE MATERIALS IN ACCORDANCE WITH EPA AND OTHER GOVERNMENTAL AGENCY REQUIREMENTS AS NECESSARY. ALL DISPOSALS SHALL BE AT AN APPROVED EPA FACILITY. THIS WORK IS CONSIDERED INCIDENTAL AND NO ADDITIONAL PAYMENT SHALL BE MADE THEREFORE.
- 24. NO ON-SITE ASPHALT AND/OR CONCRETE BATCH PLANTS ARE ANTICIPATED FOR THIS PROJECT.
- 25. THE CONTRACTOR IS ADVISED THAT THE CURB AND GUTTER SHOWN FOR INSTALLATION SHALL BE IN PLACE PRIOR TO PLACEMENT OF ASPHALTIC SURFACING MATERIALS.
- 26. CONTRACTOR SHALL CONFORM TO ALL CITY OF ALBUQUERQUE WATER, AND WASTE WATER SPECIFICATIONS AND STANDARDS.
- 27. ALL WATER LINES SHALL BE PVC C-900-200 PSI AND SEWER LINES TO BE PVC SDR35.
- 28. CONTRACTOR TO ABANDON OLD UTILITY LINES (WATER AND SEWER) IN PLACE OR REMOVE AS NECESSARY TO PERMIT NEW CONSTRUCTION. TOP PORTION OF MANHOLES SHALL BE REMOVED. GATE VALVES, VALVE BOXES AND WATER METERS SHALL BE REMOVED FROM ALL BUILDINGS AND CONTRACTOR SHALL ABIDE BY GOVERNING REGULATIONS AND PROCEDURES FOR ABANDONMENT, REMOVAL AND DISPOSAL OF ITEMS MENTIONED. CONTRACTOR TO PROVIDE TIE IN TO EXISTING UTILITIES IN SUCH A MANNER THAT SERVICE IS MAINTAINED TO ANY EXISTING FACILITIES. IN THE EVENT THAT SERVICES MUST BE DISCONNECTED FOR A PERIOD OF TIME THIS WORK WILL BE PERFORMED AT SUCH TIMES WHEN THE FACILITY IS NOT IN USE OR AS DESCRIBED BY WRITTEN DIRECTION OF THE OWNER.
- 29. THE SITE AND UTILITY SURVEY WAS PROVIDED TO J.E.L. & ASSOCIATES, LLC (JEL) BY THE OWNER. JEL ASSUMES NO RESPONSIBILITY FOR THE ACCURACY OF SAID SURVEY.



4700 Lincoln N.E., Suite 111 Albuquerque, N.M. 87109 Phone: (505) 342-6200 Fax: (505) 342-6201



Car Crafters Automotive Repair Garage 5404 Edith Blvd. NE Albuquerque, New Mexico 87107

DEC 27 2011
HYDROLOGY

SECTION

30	
Project Number	

Drawn By T.D.S.

Checked E.J.L.


Issue Date 12/22/2011


GENERAL

CONSTRUCTION

Scale:

BENCHMARK: CITY OF ALBUQUERQUE 9-F15. AN ALLUMINUM DISK ON CONCRETE DROP INLET, ENE QUADRANT OF MONTANO AND EDITH N.E. ELEVATION: 4986.68, NAVD88

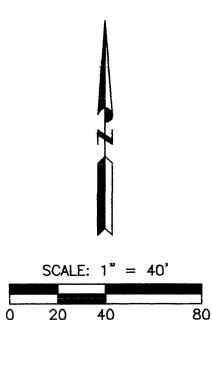

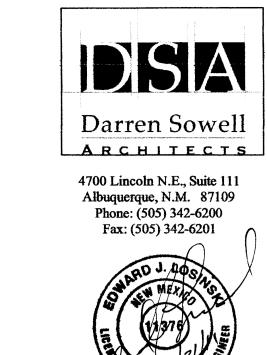


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HYDROLOGY SECTION

Drawn By Checked

T.D.S. E.J.L. Issue Date 12 EXISTING SITE 12/22/2011

PLAN



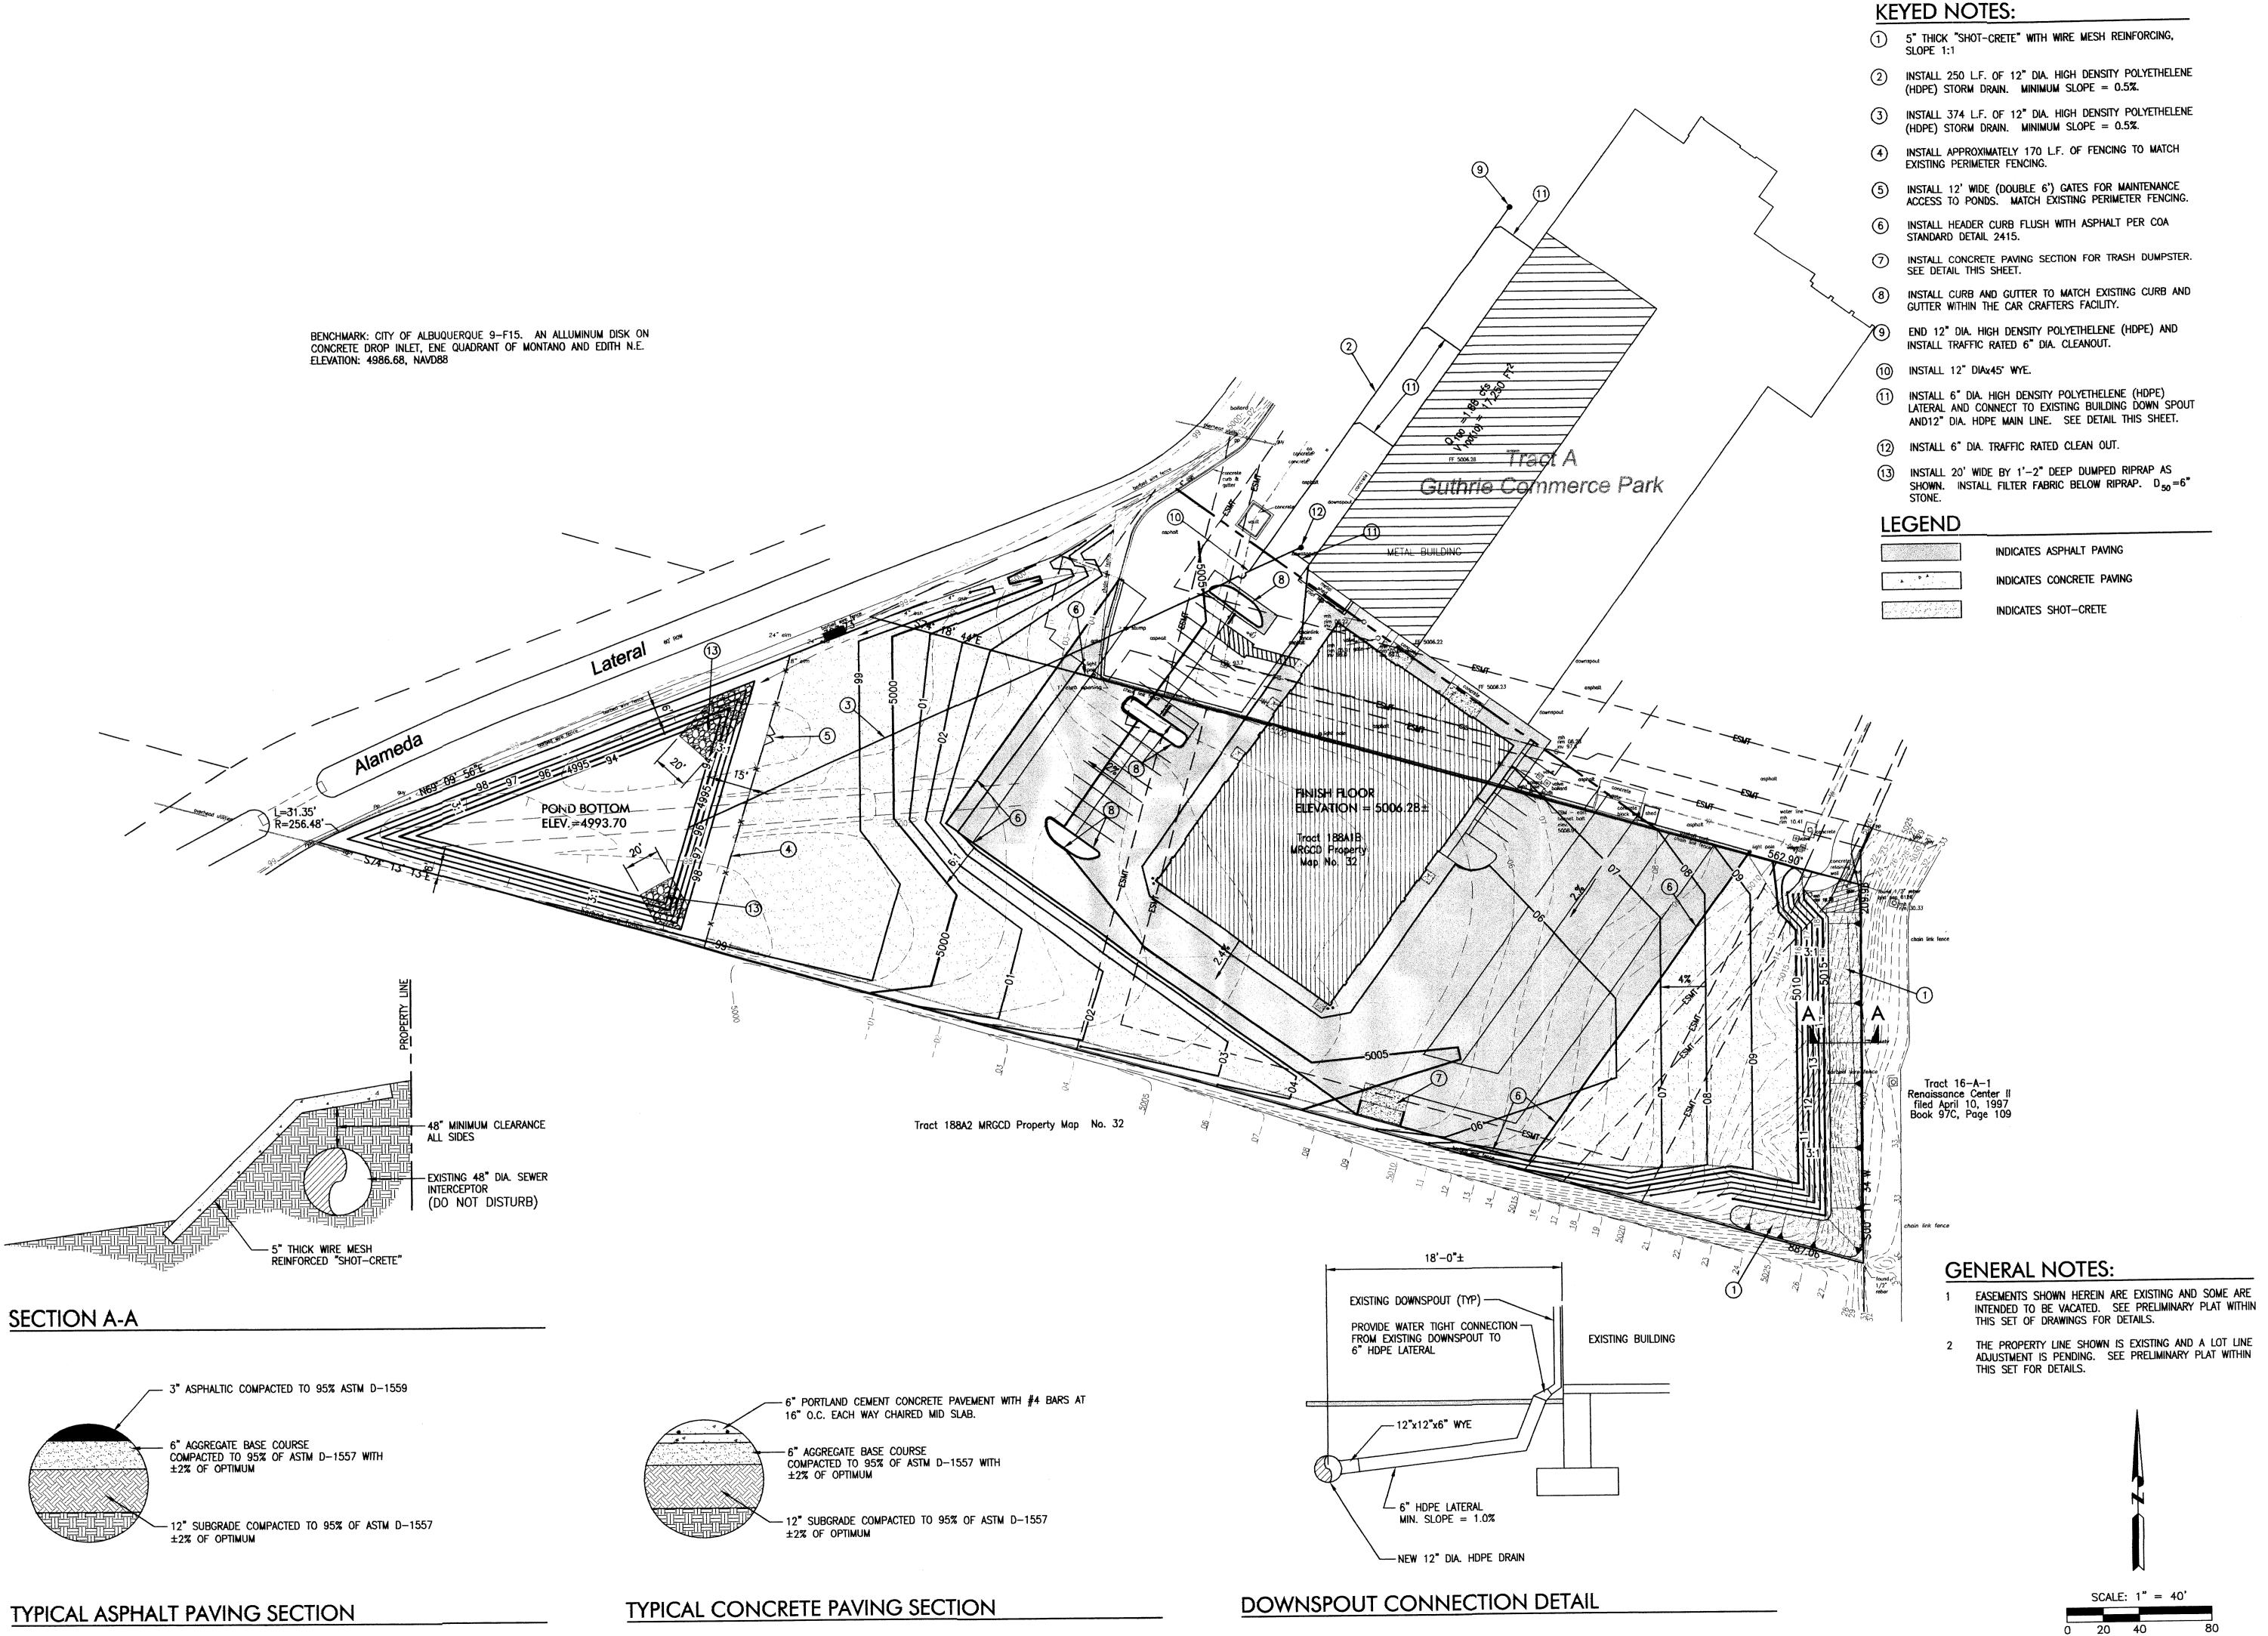

4700 Lincoln N.E., Suite 111 Albuquerque, N.M. 87109 Phone: (505) 342-6200 Fax: (505) 342-6201



Automotive Repair Garage 5404 Edith Blvd. NE Albuquerque, New Mexico 87107

RECEIVED

DEC 2.7 2011

HYDROLOGY
SECTION

roject Number	
rawn By	T.D.S.
hecked	E.J.L.
ssue Date	12/22/2011

GRADING AND
DRAINAGE PLAN


Scale:

PRE-DEVELOPMENT BASIN

POST-DEVELOPMENT BASIN



4700 Lincoln N.E., Suite 111 Albuquerque, N.M. 87109 Phone: (505) 342-6200 Fax: (505) 342-6201

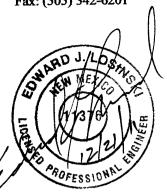

Car Crafters Automotive Repair Garage 5404 Edith Blvd. NE Albuquerque, New Mexico 87107

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DEC 27 2011

HYDROLOGY SECTION

Project Number 10
Drawn By T.D.S.

Checked E.J.L.

Issue Date 12/22/2011

PRE AND POST


DEVELOPMENT

DRAINAGE BASINS

Scale:

C103

SCALE: 1" = 40'
0 20 40 80

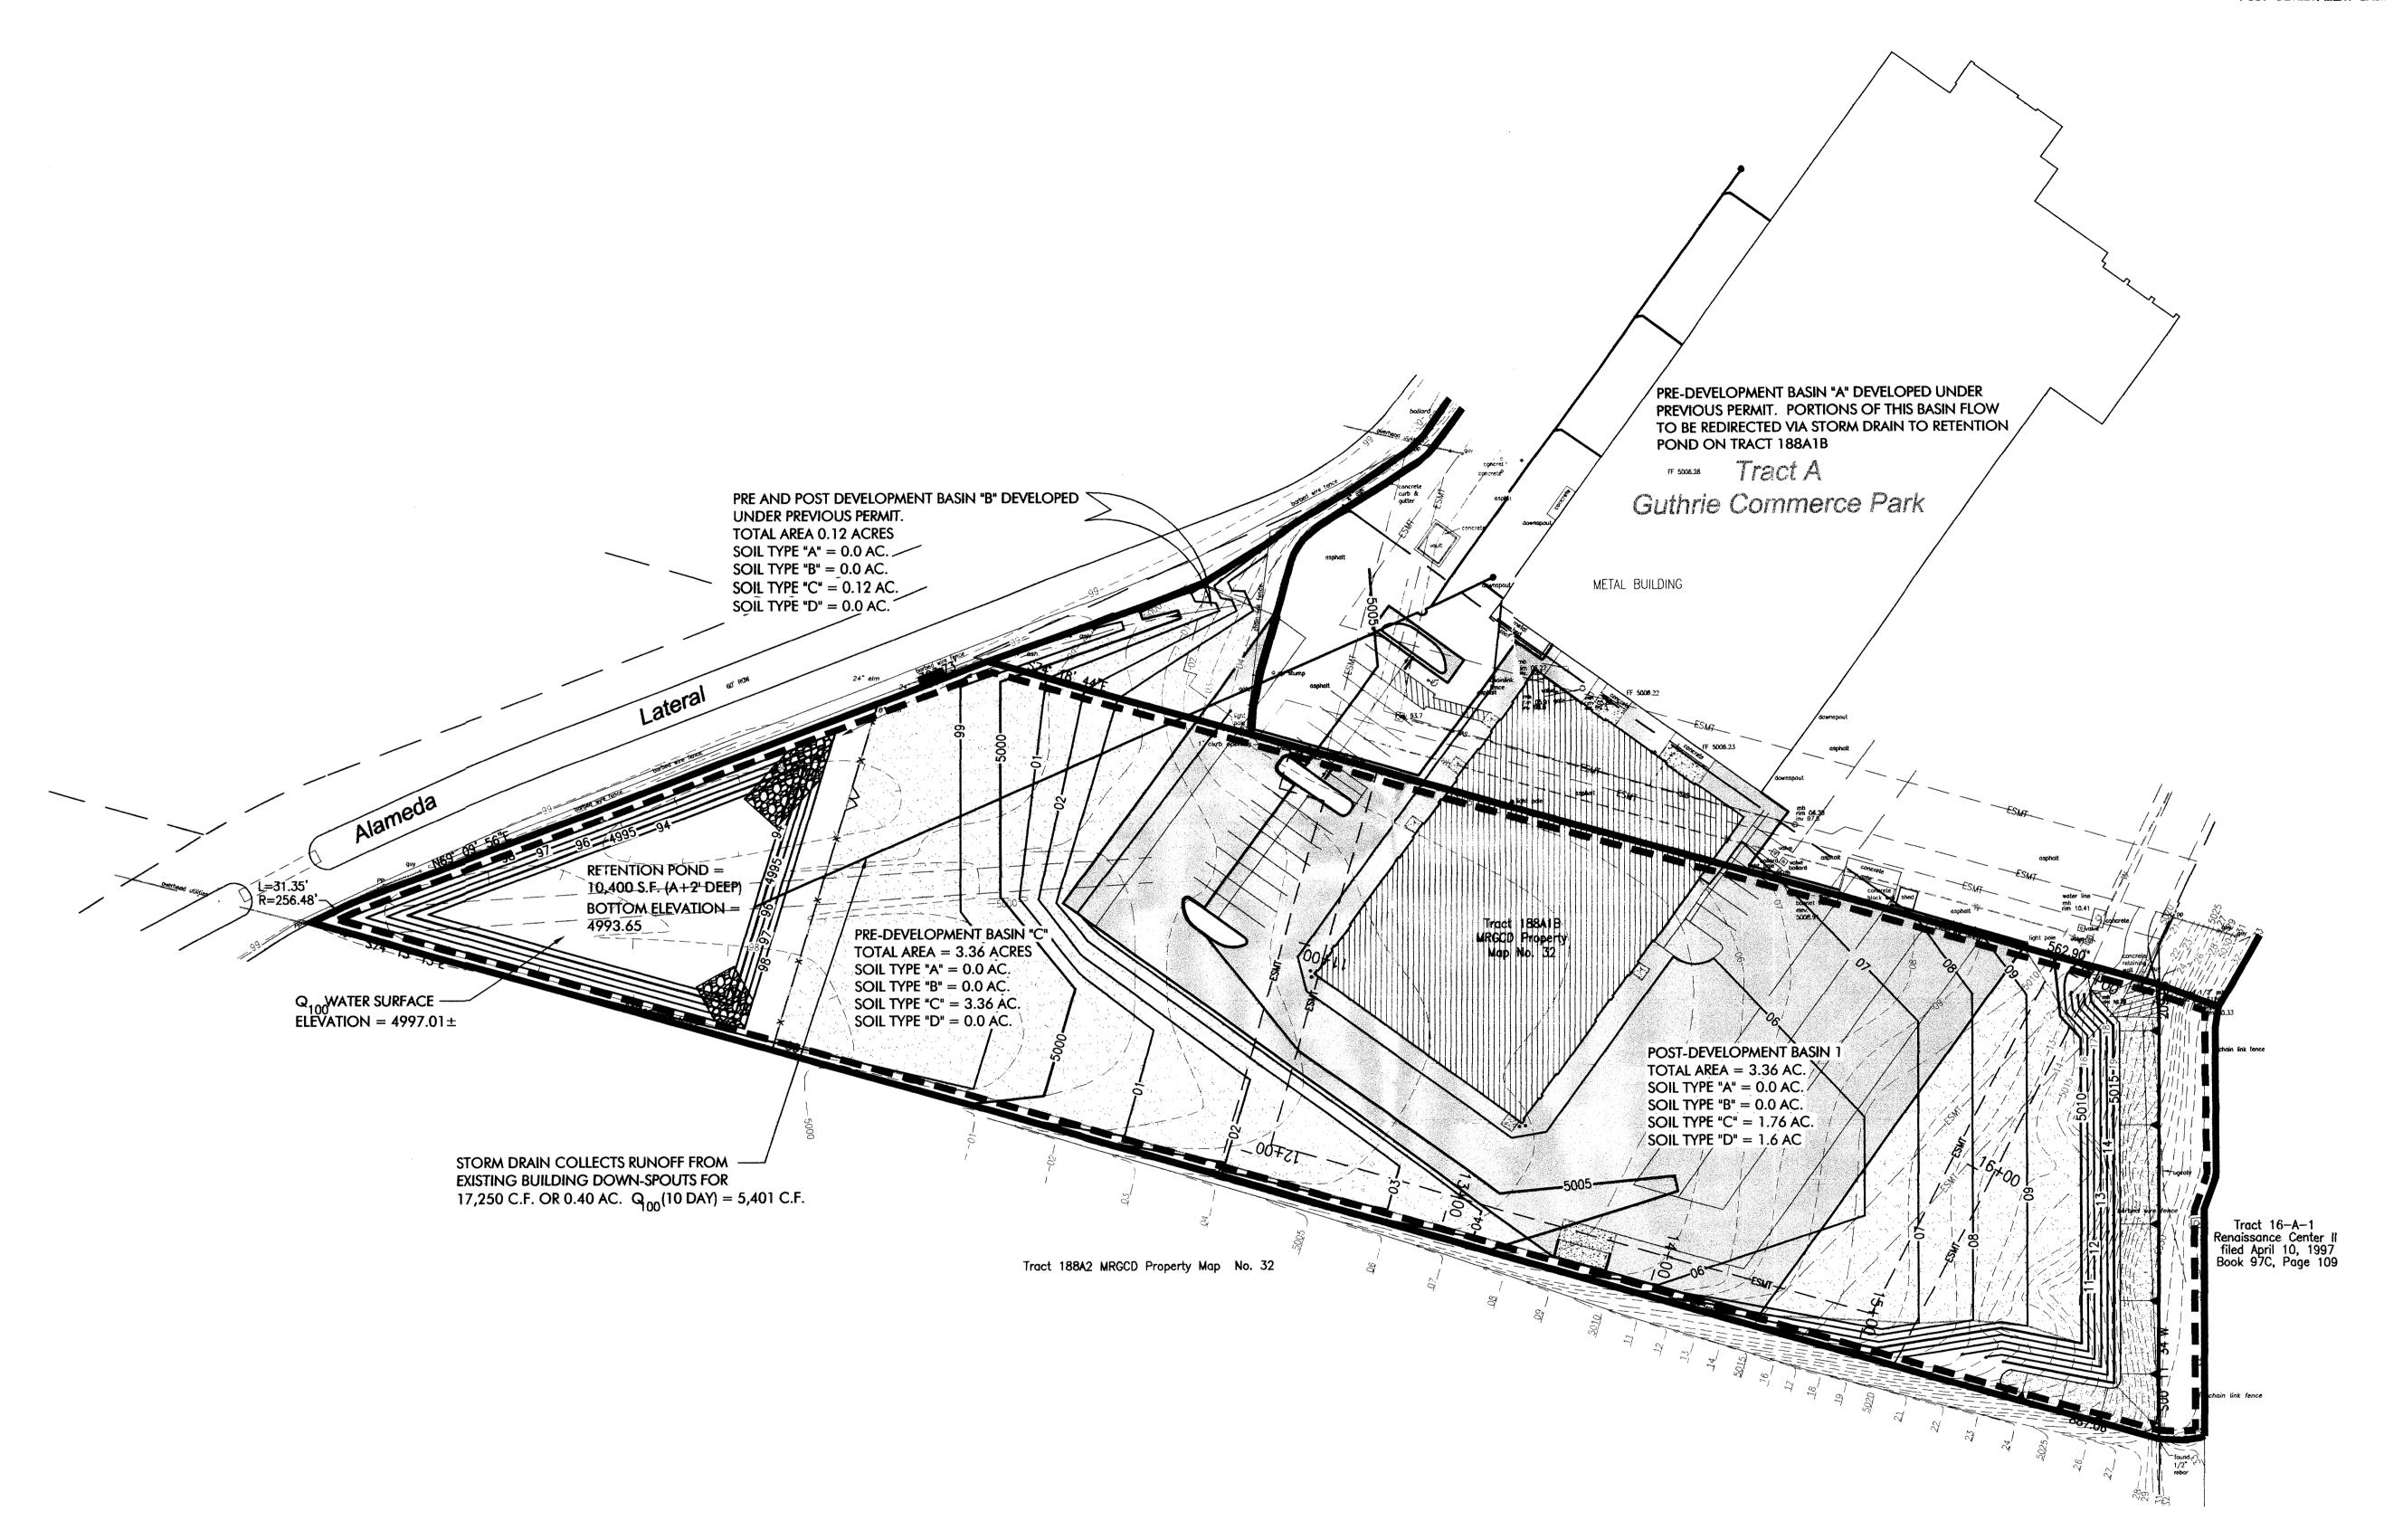

FOR DRAINAGE CALCULATIONS SUMMARY SEE SHEET C104

BENCHMARK: CITY OF ALBUQUERQUE 9-F15. AN ALLUMINUM DISK ON CONCRETE DROP INLET, ENE QUADRANT OF MONTANO AND EDITH N.E. ELEVATION: 4986.68, NAVD88

CAR CRAFTER FACILITY PHASE II

- I. PURPOSE AND SCOPE
 THE PURPOSE OF THIS DRAINAGE PLAN IS TO PRESENT THE EXISTING AND
 PROPOSED DRAINAGE MANAGEMENT PLANS FOR THE PROPOSED CAR CRAFTERS
 FACILITY LOCATED ON MONTANO NEAR THE ALAMEDA LATERAL. THE SITE CURRENTLY
 IS DISTURBED BUT UNDEVELOPED.
- II. SITE DESCRIPTION AND HISTORY
 THE SITE IS CURRENTLY VACANT AND WAS PART OF A FACILITY THAT STORED
 VINTAGE TRUCKS. NO STRUCTURES WERE KNOWN TO EXIST ON THIS PROPERTY
 BUT THE VEHICLES WERE STORED THERE UNTIL LATE 2004. THE SITE WAS
 ACCESSED THROUGH THE SUNRISE HEIGHTS SUBDIVISION VIA A CROSSING OVER THE
 ALAMEDA LATERAL.

THE SITE GENERALLY SLOPES FROM EAST TO SOUTHWEST TOWARD THE ALAMEDA LATERAL. WATER FROM THE SITE PRESENTLY OVERTOPS A SMALL DEPRESSION AND ENTERS THE ALAMEDA LATERAL.

- III. COMPUTATIONAL PROCEDURES
 HYDRAULIC ANALYSIS WAS PERFORMED UTILIZING THE DESIGN CRITERIA FOUND IN
 THE COA-DPM SECTION 22.2 RELEASED IN JUNE 1997.
- IV. PRECIPITATION
 THE 100-YEAR 6-HOUR DURATION STORM WAS USED AS THE DESIGN STORM FOR
 THIS ANALYSIS. THE SITE IS LOCATED WITHIN ZONE 2 AS IDENTIFIED IN THE DPM
 SECTION 22.2. TABLES WITHIN THAT SECTION WERE USED TO ESTABLISH THE
 6-HOUR PRECIPITATION, EXCESS PRECIPITATION AND PEAK DISCHARGE.
- V. EXISTING DRAINAGE CONDITIONS OVERVIEW
 THE 3.36 ACRES SITE, LOCATED WITHIN ZONE ATLAS K-13-Z HAS NOT BEEN
 STRUCTURALLY DEVELOPED. THE SITE WAS FORMERLY USED FOR STORAGE OF
 VINTAGE TRUCKS AND MINOR WORK ON THE SAME.

THE SITE GENERALLY SLOPES FROM EAST TO SOUTHWEST. THERE IS A LARGE DETENTION POND LOCATED UPSTREAM OF THE SITE (ON THE EAST SIDE) THAT IS PART OF THE RENAISSANCE PARK DEVELOPMENT. THERE IS A LARGE EMBANKMENT TO CONTAIN THIS DETENTION POND ALONG THE EAST PROPERTY LINE. THE ONLY OFFSITE DRAINAGE FROM THE EAST IS FROM WATER THAT LANDS DIRECTLY ON THE EMBANKMENT.

THE SITE IS BOUND BY TRACT A GUTHRIE COMMERCE PARK ON THE NORTH, THE ALAMEDA LATERAL TO THE WEST, TRACT 188A2 MRGCD TO THE SOUTH AND TRACT 16-A-1 RENAISSANCE CENTER II TO THE EAST.

ALL FLOWS WITHIN TRACT A, GUTHRIE COMMERCE PARK ARE CONVEYED TO THE NORTH AND ENTER MONTANO BLVD. A 25' WIDE STRIP OF EMBANKMENT LOCATED WITHIN TRACT 16-A-1, RENAISSANCE CENTER II FLOWS ONTO THE SITE FROM THE EAST. FROM THE SOUTH ONLY A SMALL SLIVER OF LAND VARYING FROM 4 FEET TO 13 FEET CONTRIBUTES STORM FLOW TO THE PROPERTY.

THE PEAK RUNOFF FROM ALL CONTRIBUTARY AREAS FLOWS WEST WHERE A SMALL DETENTION POND IS QUICKLY FILLED ALLOWING THE BALANCE OF WATER TO ENTER INTO THE ALAMEDA LATERAL WHERE IT IS CONVEYED TO THE SOUTH.

VI. THE SITE IMPROVEMENTS INCLUDE THE CONSTRUCTION OF AN APPROXIMATELY 24,275 SQUARE FOOT CAR CRAFTERS AUTO BODY FACILITY AND ASSOCIATED PARKING AND OUTSIDE STORAGE AREA. IN ORDER TO RECTIFY THE INAPPROPRIATE DISCHARGE OF STORM FLOWS TO THE ALAMEDA LATERAL, A RETENTION POND WILL BE CONSTRUCTED ON THE WEST SIDE OF THE PROPERTY.

BASED ON DISCUSSIONS WITH THE COA HYDROLOGY DEPARTMENT (MR. CURTIS CHEME) A PORTION OF THE GENERATED STORM FLOW FROM TRACT A, GUTHRIE COMMERCE PARK WILL BE COLLECTED VIA SUBSURFACE STORM DRAIN AND COLLECTED WITHIN THE PROPOSED RETENTION POND. AN ADDITIONAL 1—FOOT OF FREEBOARD ABOVE THE 100—YEAR, 10—DAY RUNOFF VOLUME WILL ALSO BE

THE PEAK DISCHARGE FOR TRACT 188A1B IS 13.07 CFS, THE COLLECTION OF ROOF DRAINAGE FROM TRACT A, GUTHRIE COMMERCE PARK IS 1.88 CFS, AND THE COLLECTION OF PRE-DEVELOPMENT BASIN "B" IS 0.39 CFS, FOR A TOTAL OF 15.34 CFS. THE 100-YEAR 10-DAY VOLUME GENERATED IS 34,855 C.F.

VII THE SITE IS FULLY RETAINED AFTER THE CONSTRUCTION OF THE PROPOSED POND AND WILL LOWER CURRENT IMPACTS TO DOWNSTREAM FACILITIES.

DRAIN	AGE SUMMA	AK Y	
PROJECT	CAR CRAFTERS		
DATE	12/22/11		
BY	EDDY L.		
SITE LOCATION			
PRECIPITATION ZONE	2 PER TABLE A-1	COA SECTION 22.2	
EXISTING CONDITION SUMM	MRY		
BASIN NAME	BASIN A	BASIN B	BASIN C
AREA (SF)	17,424	5401	146,362
AREA (acres)	0.40	0.12	2.36
%A LAND TREATMENT			
%B LAND TREATMENT			
%C LAND TREATMENT		100	100
%D LAND TREATMENT	100		
SOIL TREATMENT (acres)			
%A LAND TREATMENT	0.0	0.0	0.0
%B LAND TREATMENT	0.0	0.0	0.0
%C LAND TREATMENT	0.0	0.12	3.36
%D LAND TREATMENT	0.40	0.0	0.0
EXCESS RUNOFF (acre feet)	0.07	0.01	0.32
100YR 6HR	0.04	0.01	0.15
10YR 6HR 2YR 6HR	0.03	0.00	0.04
100YR 24HR	0.08	0.01	0.32
	0.00		
PEAK DISCHARGE (cfs)	1.88	0.39	10.55
100YR	1.26	0.21	5.75
10YR	0.74	0.07	2.02
2YR	0.74	1 0.07	2.02
PROPOSED CONDITION SU/	MMARY		
BASIN NAME	BASIN A	BASIN B	BASIN 1 C. C.
AREA (SF)	17,424	5401	146,362
AREA (acres)	0.40	0.12	3.36
%A LAND TREATMENT			
%B LAND TREATMENT			
%C LAND TREATMENT		100 52	52
%D LAND TREATMENT	100	48	48
	,,00		
SOIL TREATMENT (acres)	0.0	0.0	0.0
%A LAND TREATMENT	0.0	0.0	0.0
%B LAND TREATMENT	0.0	0.12	1.75
%C LAND TREATMENT %D LAND TREATMENT	0.40	1.61	1.61
	0.40	1.01	
EXCESS RUNOFF (acre feet)	0.07	0.01	0.45
100YR 6HR	0.07	0.01	0.45
10YR 6HR	0.04	0.00	0.13
2YR 6HR	0.03	0.00	0.50
100YR 24HR	0.00	0.01	0.00

PEAK DISCHARGE (cfs)

1.26

0.74

0.21

0.07

8.05

4.05


100YR

10YR

2YR

POND VOLUME DEPTH CALCULATION Q 100

AREA OF POND = $10,400 \text{ FT}^2$. REQUIRED PONDING VOLUME = $34,855 \text{ FT}^3$. DEPTH © $Q_{100} = 3.35 \text{ FEET}$. POND BOTTOM ELEVATION = 4993.65. WATER SURFACE ELEVATION = 4997.01. TOP OF POND ELEVATION = 4998.00.

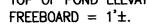



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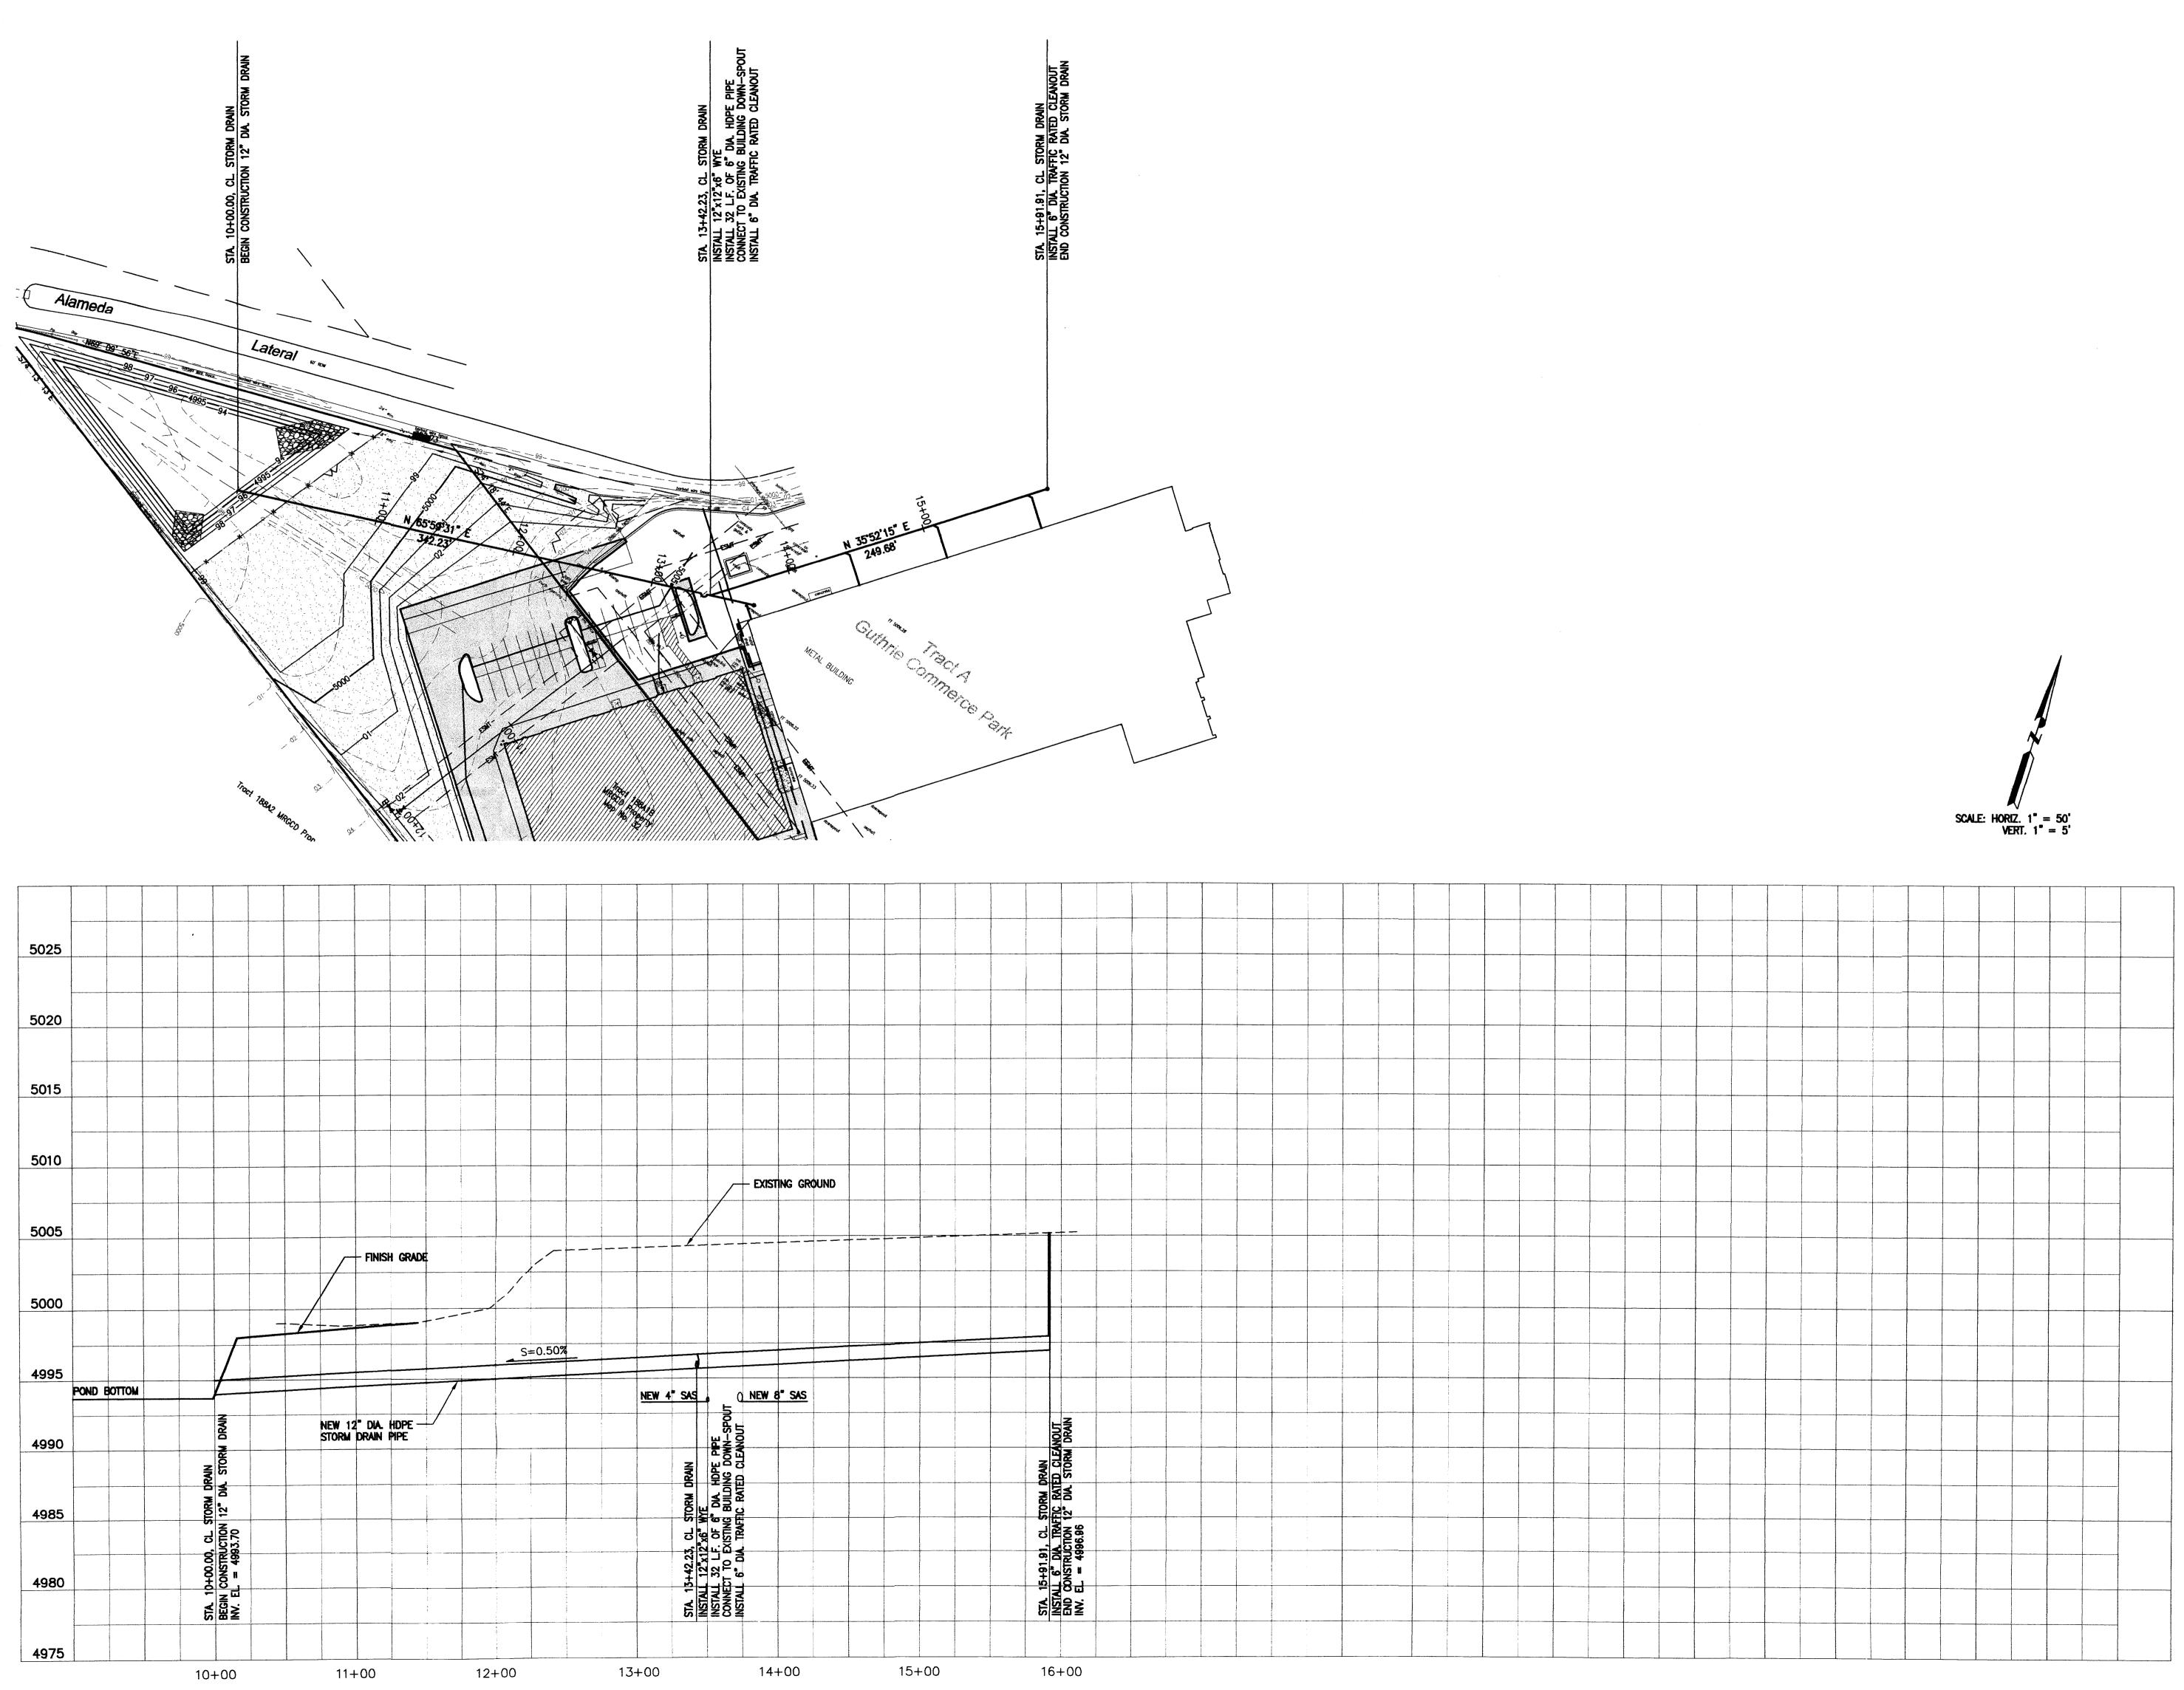
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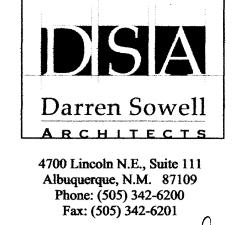
HYDROLOGY SECTION

Project Number 10
Drawn By T.D.S.
Checked E.J.L.
Issue Date 12/22/201
DRAINAGE
SUMMARY

AND CALCULATIONS

Scale







Car Crafters
Automotive Repair Garage
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HYDROLOGY SECTION

Project Number 1016


Project Number 1016
Drawn By T.D.S.
Checked E.J.L.
Issue Date 12/22/2011
STORM SEWER


STORM SEWER
PLAN AND
PROFILE


Scale:

KEYED NOTES:

- (1) CAP EXISTING 8" DIA. WATER LINE.
- 2) NEW OR RELOCATED FIRE HYDRANT PER COA STANDARD DETAIL 2340.
- 3 REMOVE AND RELOCATE EXISTING FIRE HYDRANT.
- RECONNECT EXISTING BUILDING SERVICE LINE WITH CLEANOUT TO NEW 8" DIA. SEWER MAIN LINE.
- 5) INSTALL NEW 8" DIA PVC SDR35 SEWER LINE.
- 6 PLUG EXISTING 8" DIA. SANITARY SEWER LINE TO THE EAST.
- (7) EXISTING LIFT STATION.
- (8) REMOVE EXISTING SEWER LINES AND APPERTANANCES.
- 9 INSTALL NEW 8" GATE VALVE WITH VALVE BOX
- (10) INSTALL NEW 12" GATE VALVE WITH VALVE BOX.
- (1) INSTALL NEW 12" END CAP WITH THRUST RESTRAINT.
- REMOVE SECTION OF EXISTING 8" DIA. WATER LINE.
- (13) CONNECT NEW SANITARY SEWER LINE TO EXISTING LINE AND PROVIDE 6" CLEANOUT FOR SERVICE PURPOSES. (THIS NEW SEWER LINE IS PRIVATELY OWNED)
- 20' WIDE WATER LINE EASEMENT TO BE GRANTED TO THE ALBUQUERQUE BERNALILLO COUNTY WATER UTILITY AUTHORITY.
- INSTALL 22.5° BEND WITH RESTRAINTS IN 6" DIA. WATER LINE AND APPROX. 14 L.F. OF NEW 6" DIA. PVC C900 WATER LINE TO MECHANICAL ROOM. SEE PLUMBING PLANS FOR CONTINUATION. LINE SHALL SUPPLY FIRE RISER DIRECTLY WITH BRANCH "DOWNSTREAM" FOR DOMESTIC USE. BACKFLOW PREVENTION TO BE INSTALLED WITHIN MECHANICAL ROOM.
- (16) INSTALL APPROX. 30 L.F. OF 4" DIA. SEWER LINE AND CONNECT TO NEW MANHOLE. MIN. SLOPE = 1.0%
- 17) INSTALL 22.5° BEND.
- 18 INSTALL APPROX. 20 L.F. OF 4" DIA. SEWER LINE WITH DOUBLE CLEANOUT. FOR CONTINUATION SEE PLUMBING DRAWINGS.
- (19) INSTALL 8"x8"x4" WYE.
- (20) INSTALL 8"x8"x8" WYE.
- (21) INSTALL 12"x12"x8" TEE

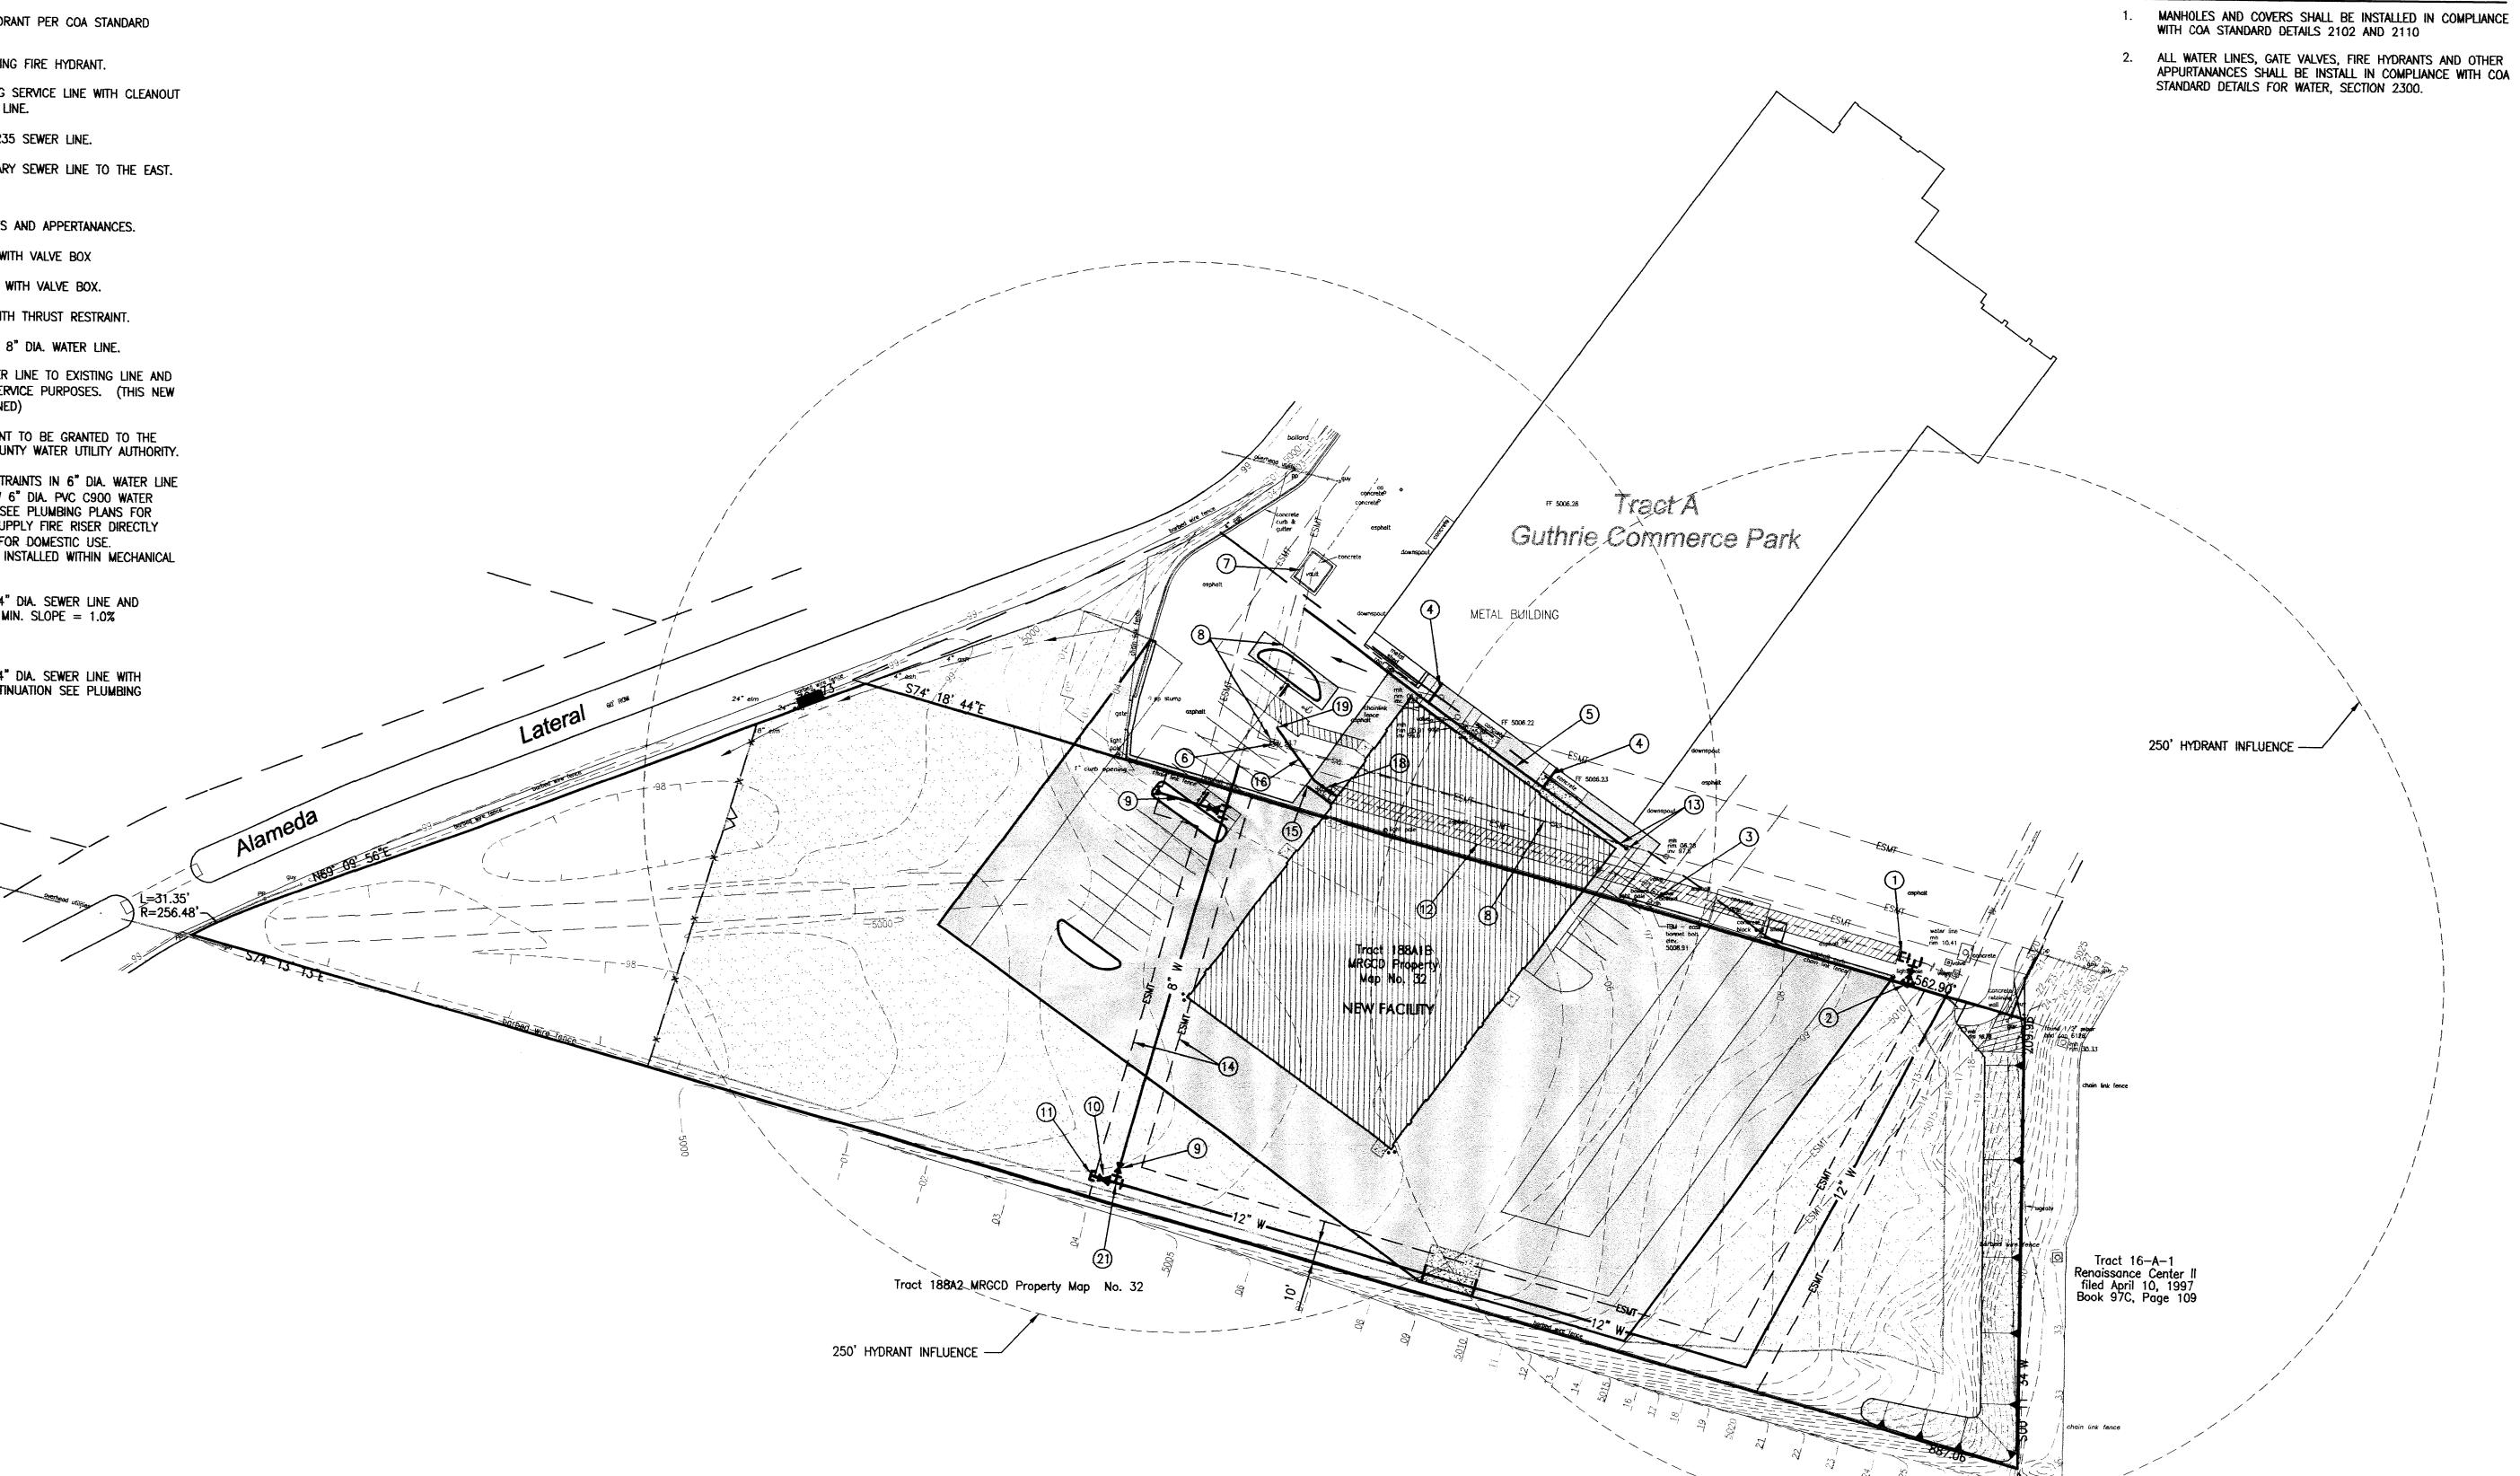

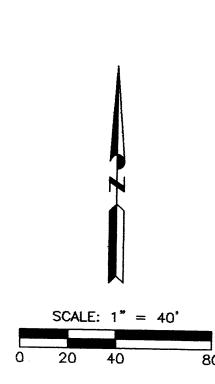

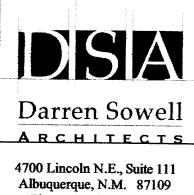

GENERAL NOTES:

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HYDROLOGY SECTION

Project Number
Drawn By T.D.S

Project Number
Drawn By T.D.S.
Checked E.J.L.
Issue Date 12/22/2011
OVERALL UTILITY
LAYOUT PLAN

Scale:






Albuquerque,

RECEIVED DEC 27 2011

T.D.S. E.J.L. 12/22/2011

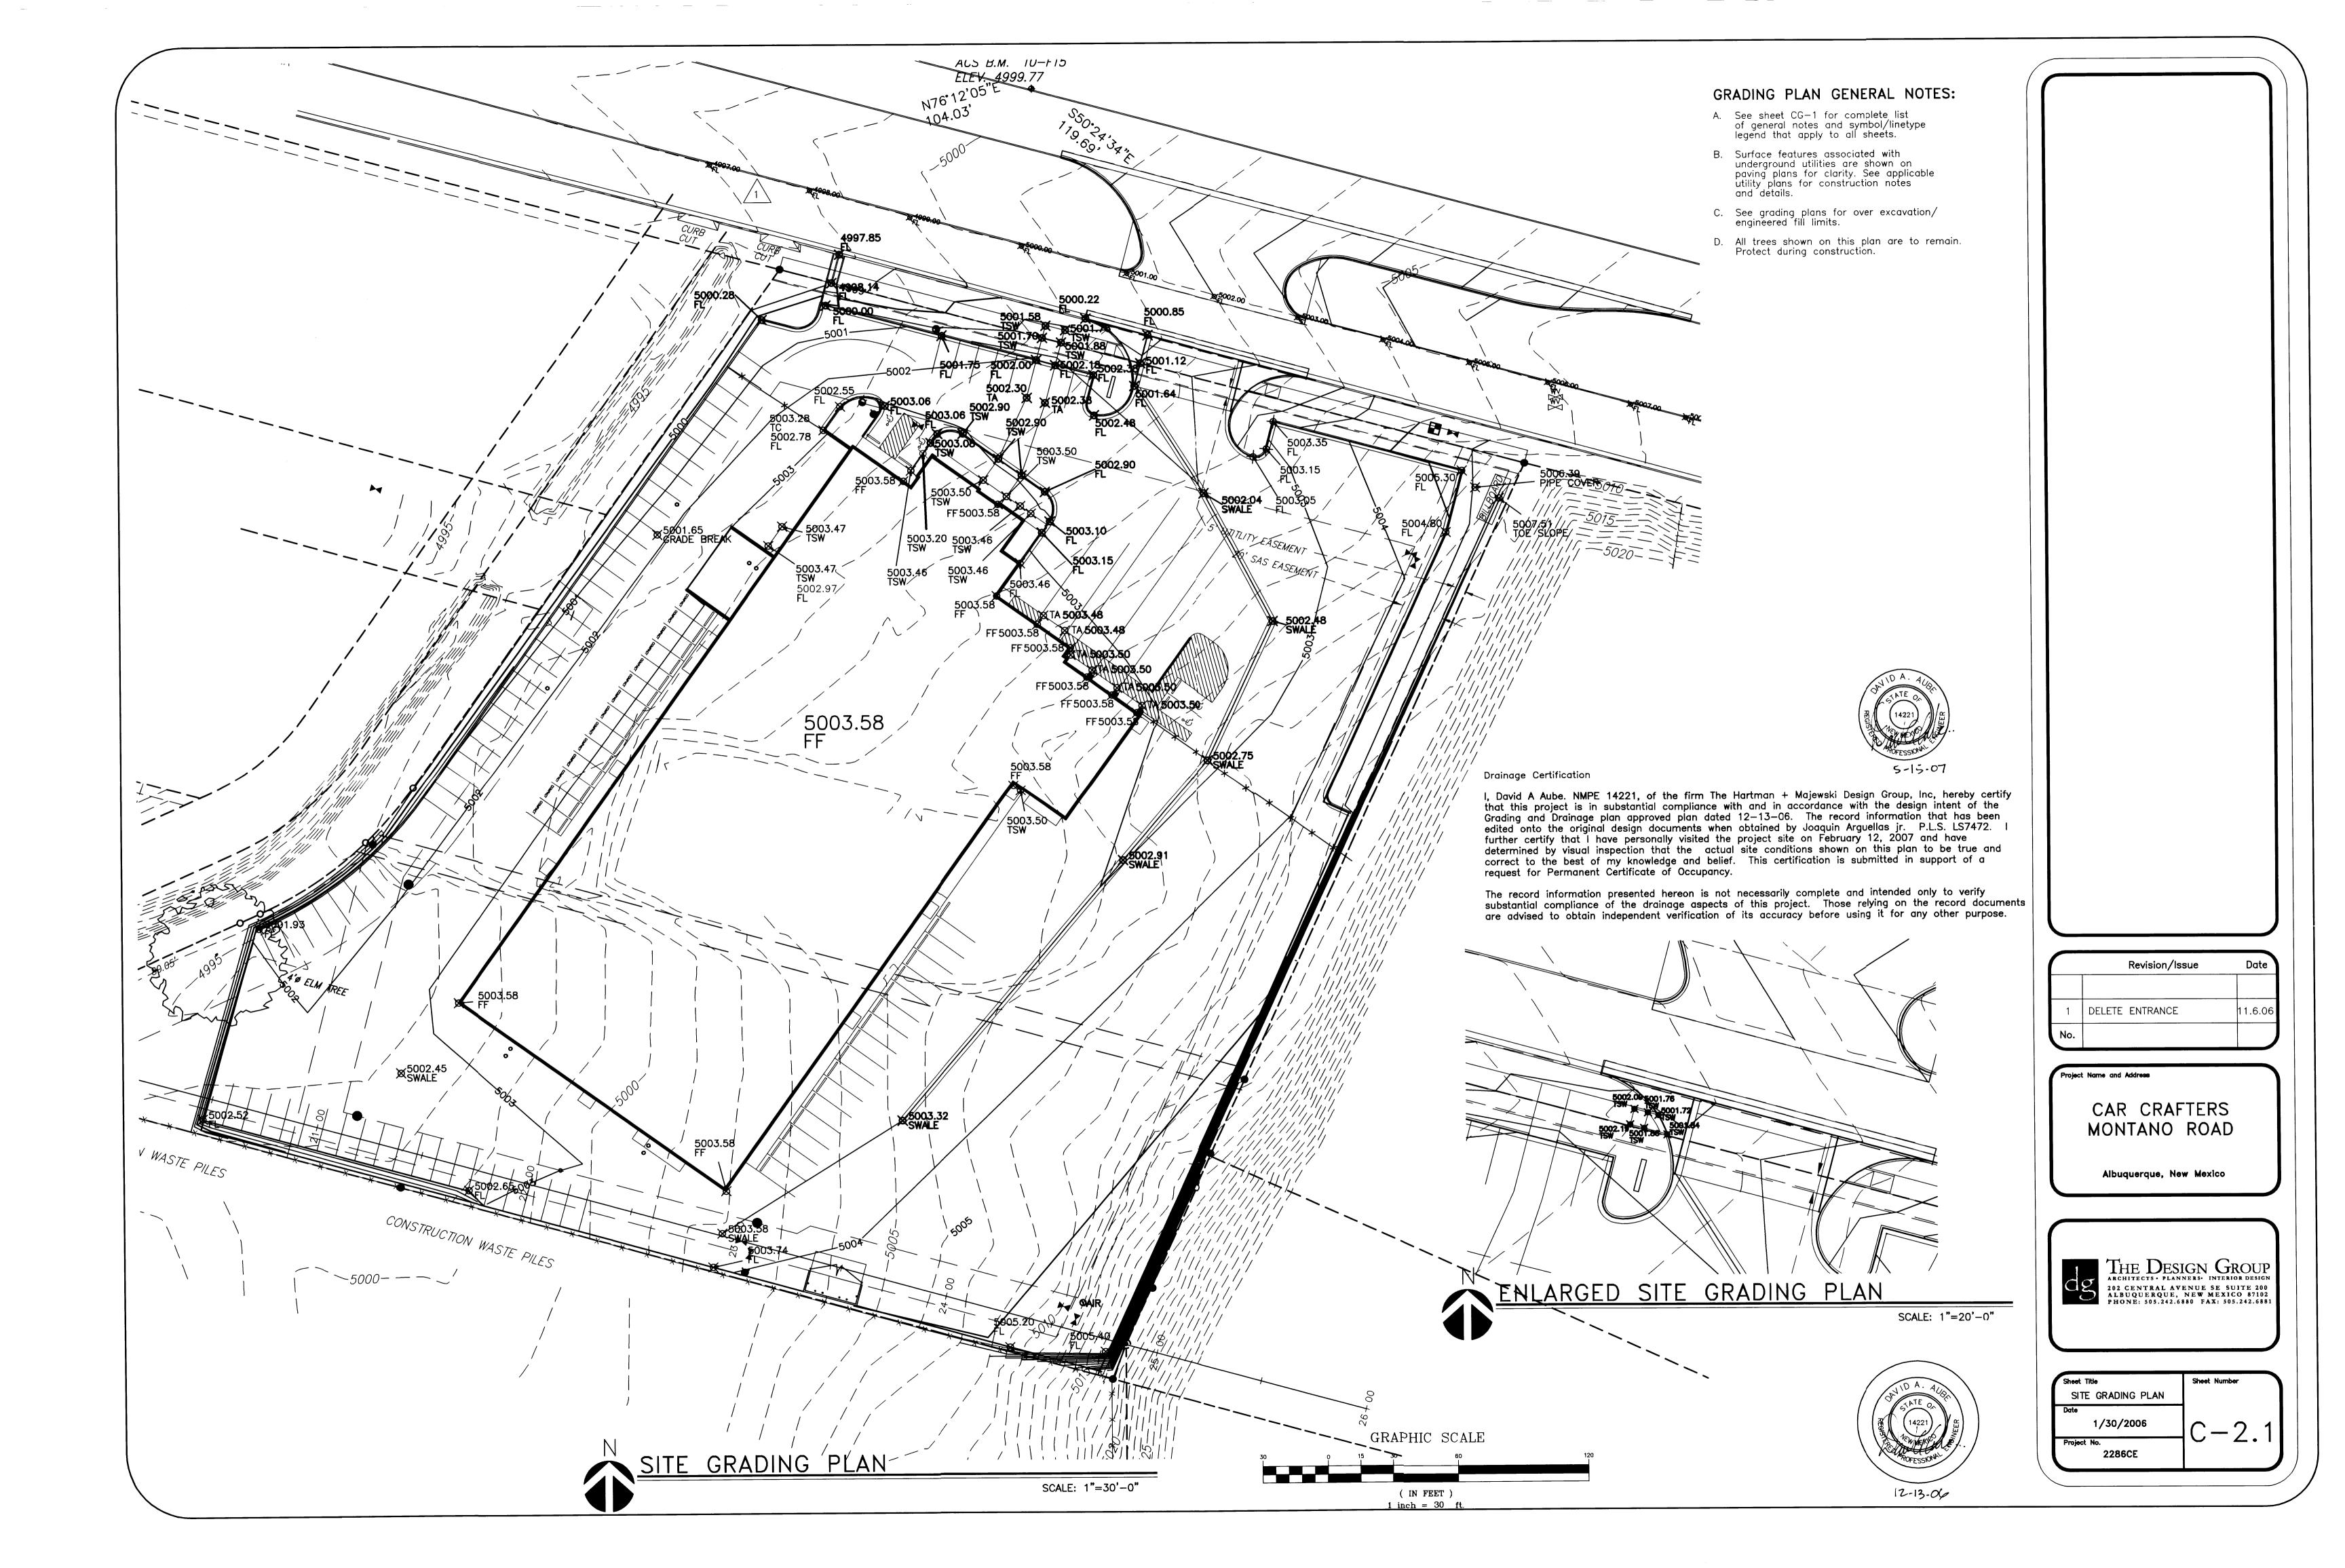

Car Crafters Facility

PURPOSE AND SCOPE

The purpose of this drainage plan is to present the existing and proposed drainage management plans for the proposed Car Crafters Facility located on Montano near the Alameda Lateral. The site currently has a single 9,000 sf metal building and dirt access roads.

SITE DESCRIPTION AND HISTORY

The site was used for storage of vintage trucks. There were shops in the metal building for minor work on these vehicles. The Metal building was constructed around 1974 and vehicles were stored there until late 2004. The site was accessed through the Sunrise Heights Subdivision acrossed the Alameda Lateral.

The site generally slopes form east to southwest toward the Alameda Lateral. There is a retention pond located in the southwest corner near the Alameda Lateral. No water from the site is discharged into the Lateral.

III. COMPUTATIONAL PROCEDURES

Hydrologic analysis was performed utilizing the design criteria found in the COA-DPM Section 22.2 released in June 1997.

IV. PRECIPITATION

The 100-yr 6-hr duration storm was used as the design storm for this analysis. This site is located within Zone 2 as identified in the DPM Section 22.2. Tables within that section were used to establish the 6-hr precipitation, excess precipitation and peak discharge.

V. EXISTING DRAINAGE CONDITIONS OVERVIEW

The 4.4 acres site, located within Zone Atlas K-13-Z was first developed in 1974. The site was formerly used for storage of vintage trucks and minor work on the same.

The site generally slopes from east to the south west. There is a large detention pond located upstream of the site (on the east side) that is part of the Renessance Park development. There is a large embankment to contain this detention pond along the east propoerty line. The only offsite drainage from the east is from water that lands directly on the embankment

The site is bounded by Montano on the north side. There is COA Standard C&G that conveys water within the street section to an existing sump condition catch basin located approximately 200' west of the project limits. There are catch basins located on Montano to the east of the subject site that were designed to collect all water flowing down Montano from the East.

The site is bounded on the west by the Alameda Lateral, and by and empty property (sloping South) along the south property line.

The peak runoff from all On—site and Off—Site basins is collected in a retention pond located in the southwest corner of the site. No water from the site enters the Alameda Lateral. The combined peak runoff into the retenion pond was 13.26 cfs with excess runoff volume of 0.426 acre feet for the 100-yr(24-h) event.

wing funt

VI. DRAINAGE MANAGEMENT PLAN

The site improvements include removal of the existing 9,000 sf metal building and the construction of a new 49,867 sf. sf Car Crafters Auto Body Facility and associated parking facilities. There will be a one new drive pads constructed for direct access from Montano. There will also be a sidewalk culvert constructed on the west side of the site to allow for release of water into Montano.

The site is designed to 85% impervious treatment and 15% landscaping. (except the small ponding located in the southwest corner.)

The site is designed to drain toward Montano. The peak runoff for the developed flow that will discharge into Montano is 19.60 cfs. The existing catch basin located west of the site along Montano is in a sump condition and should have approximately 22 cfs capacity. Because the catch basins to the east of the site picked up all surface water there should be sufficient capacity for this site to discharge freely into Montano.

The drive pad located at the east side of the site will drain a majority of the on site storm runoff into Montano. The peak flow rate through this drive pad is 12.00 cfs. The remaining runoff, 7.60cfs, will be drained through a pair of 2' wide sidewalk culverts on the west side of the site into Montano. The sidewalk culverts and drive pad are to be constructed per Public Work Order Drawings for project number 763181.

There is approximately 1/6 acre in the south west corner of the site that cannot (without excessive earthwork) be drained into Montano. This area will need to retain the rainfall that lands within the proposed closed basin to prevent discharge into the Alameda Lateral. The peak runoff generated by this basin is 0.36 cfs with an excess runoff volume of .01 acre feet for the 100-yr 24-hr event. This area will be graded to create a flat spot to retain storm runoff up to 6" cap.

VII. CONCLUSIONS


The site is designed for free discharge into Montano. There should not be any significant impact to the large storm drainage system in Montano or downstream facilities. There is a small retention pond necessary in the southwest corner of the site that will retain only the water that lands in the ponding area (no parking lot drainage will flow into this area).


10yr.

2yr.

Wind I mor

Drainage Summary Car Crafters Project: Project Numbe: 12/12/06 Date: Dave A By: Site Location 2 Per Table A-1 COA DPM Section 22.2 Precipitaion Zone **Existing summary** Off Ex #2 Off Ex #1 Ex 2 Ex 1 Basin Name 4644.8 104073.6 13720.9 87166.5 Area (sf) 0.31 0.11 2.00 2.39 Area (acres) 0 %A Land treatment 20 20 70 70 %B Land treatment 20 %C Land treatment %D Land treatment Soil Treatment (acres) 0.00 0.00 0.00 0.00 Area "A" 0.02 1.67 1.40 0.06 Area "B" 0.09 0.40 0.25 0.36 Area "C" 0.36 0.20 0.00 0.00 Area "D" Excess Runoff (acre-feet) 0.2058 0.0278 0.0094 0.1641 100yr. 6hr. 0.0724 0.0124 0.0042 10yr. 6hr. 0.0946 0.0011 2yr. 6hr. 0.0033 0.0205 0.0309 0.0278 0.0094 0.1708 0.2177 100yr. 24hr. Peak Discharge (cfs) 5.39 0.32 6.62 0.93 100 yr. 0.49 0.17 2.64 10yr. 3.33 0.16 0.05 1.02 2yr. **Proposed summary** Off Ex #1 Pro 2 Off Ex #2 Pro 1B Pro 1A Basin Name 13720.9 4644.8 101402 82450 Area (sf) 0.11 0.31 2.33 1.89 0.15 Area (acres) 0 0 0 %A Land treatment 20 15 20 20 %B Land treatment 80 80 %C Land treatment 0 0 85 %D Land treatment Soil Treatment (acres) 0.00 0.00 0.00 0.00 0.00 Area "A" 0.02 0.06 0.35 0.03 0.28 Area "B" 0.09 0.25 0.00 0.12 Area "C" 0.00 0.00 0.00 1.98 1.61 0.00 Area "D" Excess Runoff (acre-feet) 0.0094 0.0278 0.3723 0.3027 0.0130 100yr. 6hr. 0.0058 0.0124 0.0042 0.1863 0.2291 10yr. 6hr. 0.0033 0.0011 0.0015 0.1308 2yr. 6hr. 0.1064 0.0278 0.0094 0.0130 0.3563 0.4382 100yr. 24hr. Peak Discharge (cfs) 0.32 10.10 8.21 0.44 0.93 100 yr. 5.32 0.23 0.49 0.17 6.54

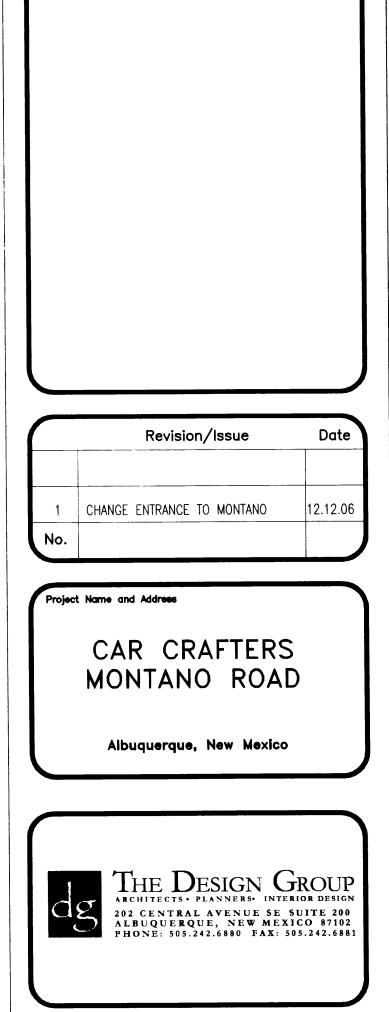

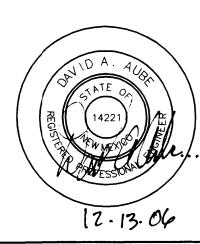


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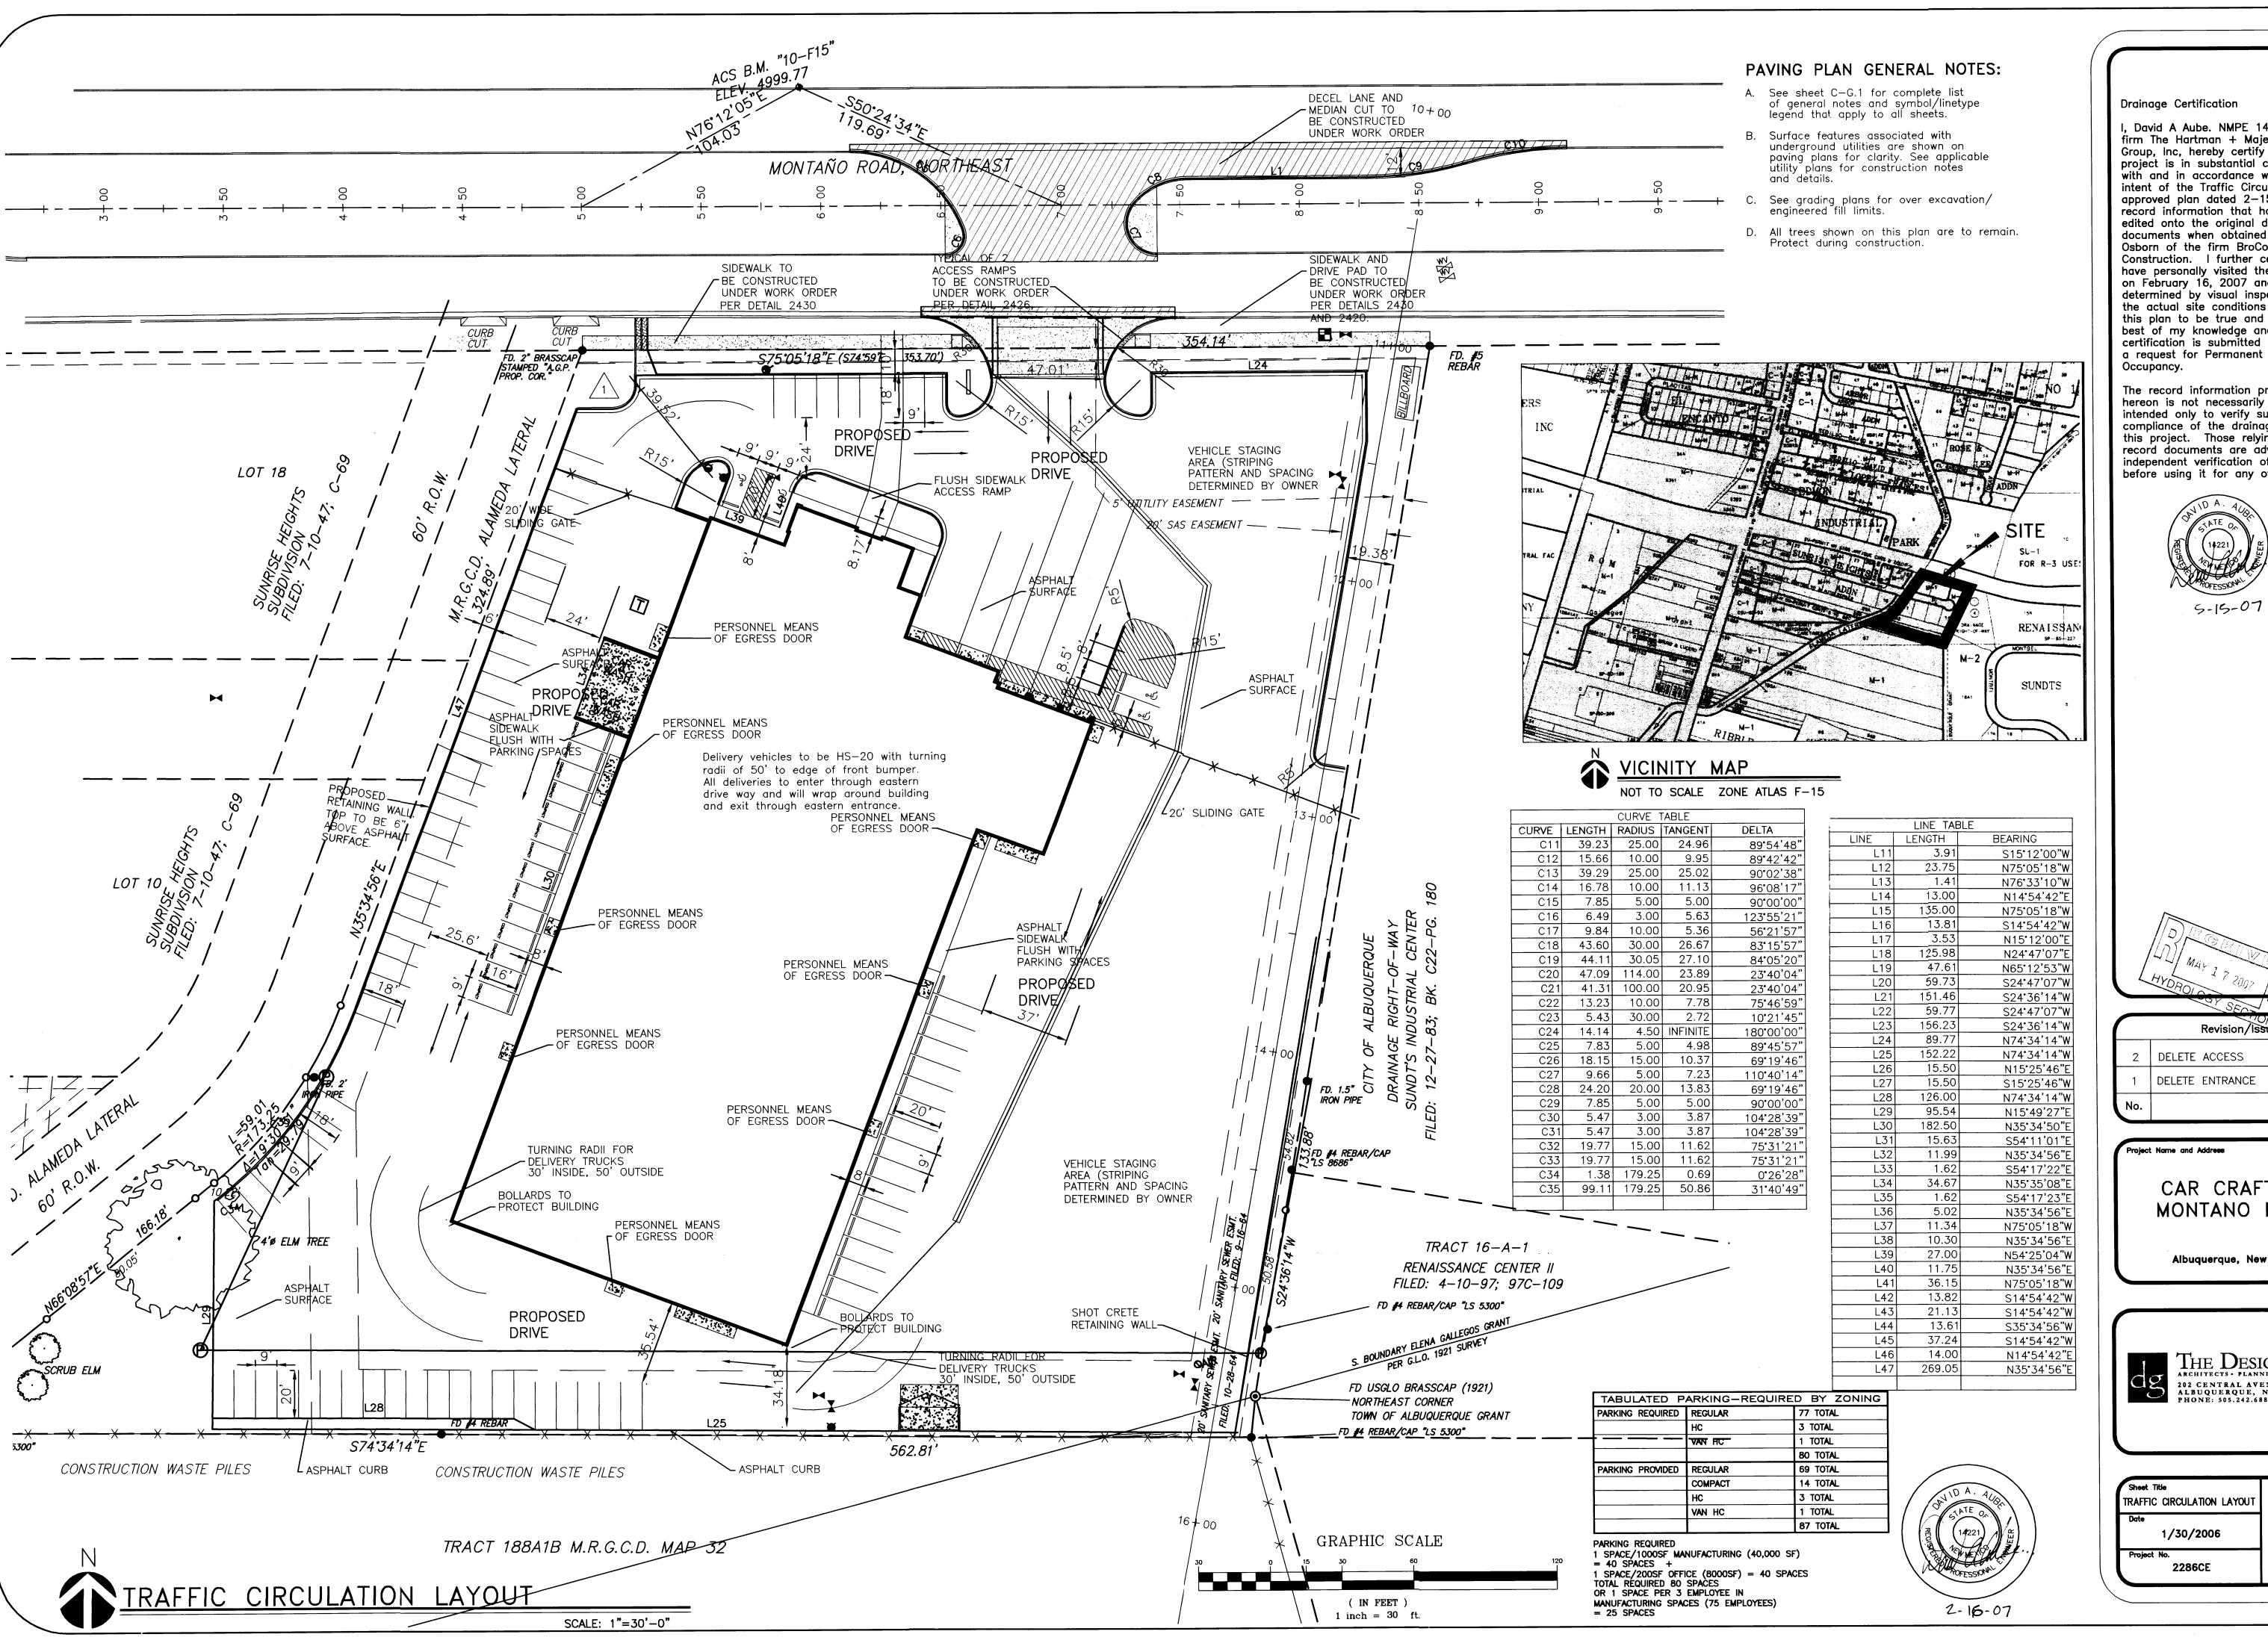
0.07

3.02

3.71

0.16



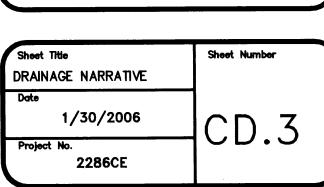


Drainage Certification

I, David A Aube. NMPE 14221, of the firm The Hartman + Majewski Design Group, Inc, hereby certify that this project is in substantial compliance with and in accordance with the design intent of the Traffic Circulation Plan approved plan dated 2-15-07. The record information that has been edited onto the original design documents when obtained by Danny Osborn of the firm BroCon Construction. I further certify that have personally visited the project site on February 16, 2007 and have determined by visual inspection that the actual site conditions shown on this plan to be true and correct to the best of my knowledge and belief. This certification is submitted in support of a request for Permanent Certificate of

The record information presented hereon is not necessarily complete and intended only to verify substantial compliance of the drainage aspects of this project. Those relying on the record documents are advised to obtain independent verification of its accuracy before using it for any other purpose.





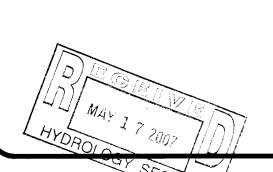

	0503				
1		Revision/Issue	Date		
	2	DELETE ACCESS	12.20.06		
	1	DELETE ENTRANCE	11.6.06		
	No.				

CAR CRAFTERS MONTANO ROAD

Albuquerque, New Mexico



