CITY OF ALBUQUERQUE

Planning Department Alan Varela, Director



Mayor Timothy M. Keller

October 11, 2022

Joe Lavender Burns & McDonnell 3501 E. Speedway Blvd. Suite 245 Tucson, AZ 85716

Re: New Mexico Expansion
4401 Alexander Blvd. NE
Traffic Circulation Layout
Engineer's/Architect's Stamp XX-XX-XX (F16-D003B1)

Dear Mr. Lavender,

Based upon the information provided in your submittal received 09-26-22, the above referenced plan cannot be approved for Building Permit until the following comments are addressed:

- 1. List the number of Motorcycle and Bicycle parking spaces required by the IDO.
- 2. The traffic circulation layout must be stamped, signed, and dated by an engineer or architect licensed in the state of New Mexico.
- 3. Clarify existing property lines and proposed property lines.
- 4. Sidewalk need to be built at the perimeter of the site, and reference COA std dwg 2430.
- 5. All sidewalks along streets should be placed at the property line.
- 6. Due to proposing gates, please provide turning templates.
- 7. Please list the width and length for all existing and proposed parking spaces. Some dimensions are not shown.
- 8. The minimum parking stall dimensions are:

www.cabq.gov

PO Box 1293

Albuquerque

NM 87103

Type of parking	Min. Width	Min. Length	Min. Overhang
Standard	8.5'	18'	2'
Compact	7.5'	15'	1.5'
Motorcycle	4'	8'	N/A
ADA	8.5'	18'	2'

- 9. The ADA accessible parking sign must have the required language per 66-7-352.4C NMSA 1978 "Violators Are Subject to a Fine and/or Towing." Please call out detail and location of signs.
- ADA curb ramps must be updated to current standards and have truncated domes installed.
- 11. Motorcycle parking spaces shall be designated by its own conspicuously posted upright sign, either free-standing or wall mounted per the zoning code.

CITY OF ALBUQUERQUE

Planning Department Alan Varela, Director



Mayor Timothy M. Keller

- 12. The pavement marking "MC" should be shown in the opposite direction for motorcycles entering the parking space.
- 13. All bicycle racks shall be designed according to the following guidelines:
 - a. The rack shall be a minimum 30 inches tall and 18 inches wide.
 - b. The bicycle frame shall be supported horizontally at two or more places. Comb/toaster racks are not allowed.
 - c. The rack shall be designed to support the bicycle in an upright position. See the IDO for additional information.
 - d. The rack allows varying bicycle frame sizes and styles to be attached.
 - e. The user is not required to lift the bicycle onto the bicycle rack.
 - f. Each bicycle parking space is accessible without moving another bicycle.
- 14. Bicycle racks shall be sturdy and anchored to a concrete pad.
- 15. A 1-foot clear zone around the bicycle parking stall shall be provided.
- 16. Bicycle parking spaces shall be at least 6 feet long and 2 feet wide.
- Total 2 to your partning operation of all reads to reactioning and 2 to or made.
- 17. Please provide details for all the proposed signs and pavement marking.
- 18. Per the IDO, a 6 ft. wide ADA accessible pedestrian pathway is required from the public sidewalk to the building entrances. Please clearly show this pathway and provide details.
- 19. Per DPM, a 6 ft. wide ADA accessible pedestrian pathway is required from the ADA parking stall access aisles to the building entrances. Please clearly show this pathway and provide details.
- ADA accessible pedestrian pathway should not be placed behind parking space or adjacent to a vehicular way. Vehicle and pedestrian/wheel chair conflicts should be avoided as much as possible.
 - 21. Define ADA pathways by labeling of ramps, flush pavement, dimensioning of pathways, doorways, etc.
- 22. Curbing should be installed to delineate landscape, parking, and pedestrian ways and identify points of access. Please call out detail and location of barrier curb.
- 23. Parking areas shall have barriers to prevent vehicles from extending over public sidewalk, public right-of-way, or abutting lots.
- 24. Refuse vehicle maneuvering shall be contained on-site. The refuse vehicle shall not back into the public right of way. provide a copy of refuse approval.
- 25. It is not apparent what type of pavement surface is being proposed. A hard driving surface will be required as part of this proposed project for parking area and drive aisles.
- 26. Please provide a sight distance exhibit
- 27. Show the clear sight triangle and add the following note to the plan: "Landscaping and signage will not interfere with clear sight requirements. Therefore, signs, walls, trees,

PO Box 1293

Albuquerque

NM 87103

www.cabq.gov

CITY OF ALBUQUERQUE

Planning Department Alan Varela, Director



Mayor Timothy M. Keller

and shrubbery between 3 and 8 feet tall (as measured from the gutter pan) will not be acceptable in the clear sight triangle.

- 28. Please specify the City Standard Drawing Number when applicable.
- 29. Provide notes showing what work is included and on the work order and the private work on site.
- 30. Work within the public right of way requires a work order with DRC approved plans.
- 31. Please add a note on the plan stating "All improvements located in the Right of Way must be included on the work order."
- 32. Please provide a letter of response for all comments given.
- 33. Traffic Studies: See the Traffic Impact Study (TIS) thresholds. In general, a minimum combination of 100 vehicles entering and exiting in the peak hour warrants a Traffic Impact Study. Visit with Traffic Engineer for determination, and fill out a TIS Form that states whether one is warranted. In some cases, a trip generation may be requested for determination (Contact Matt Grush: mgrush@cabq.gov).

PO Box 1293

Once corrections are complete resubmit

1. The Traffic Circulation Layout

Albuquerque

- 2. A Drainage Transportation Information Sheet (DTIS)
- 3. Send an electronic copy of your submittal to PLNDRS@cabq.gov.

NM 87103

4. The \$75 re-submittal fee.

For log in and evaluation by Transportation.

www.cabq.gov

If you have any questions, please contact me at (505) 924-3675.

Sincerely,

Marwa Al-najjar Associate Engineer, Planning Dept. Development Review Services

\ma via: emailC: CO Clerk, File



City of Albuquerque

Planning Department Development & Building Services Division

DRAINAGE AND TRANSPORTATION INFORMATION SHEET (REV 11/2018)

DRB#:	FPC#·		
Lead Descriptions	Li Cπ.		Work Order#:
Legal Description:			
City Address:			
Applicant:			Contact:
Address:			
			E-mail:
Owner:			Contact:
Address:			
			E-mail:
TYPE OF SUBMITTAL:PLAT (_	# OF LOTS)	_ RESIDENCE	DRB SITE ADMIN SITE
IS THIS A RESUBMITTAL?:	Yes	No	
DEPARTMENT: TRAFFIC/ TRA	NSPORTATION _	HYDROLO	GY/ DRAINAGE
Check all that Apply:		түре оғ	APPROVAL/ACCEPTANCE SOUGHT:
TYPE OF SUBMITTAL:		_	LDING PERMIT APPROVAL
ENGINEER/ARCHITECT CERTIFI	CATION	CER	TIFICATE OF OCCUPANCY
PAD CERTIFICATION		PRE	LIMINARY PLAT APPROVAL
CONCEPTUAL G & D PLAN		SITE	E PLAN FOR SUB'D APPROVAL
GRADING PLAN		SITE	EPLAN FOR BLDG. PERMIT APPROVAL
DRAINAGE MASTER PLAN		FINA	AL PLAT APPROVAL
DRAINAGE REPORT		SIA/	RELEASE OF FINANCIAL GUARANTEE
FLOODPLAIN DEVELOPMENT PE	ERMIT APPLIC	FOU	NDATION PERMIT APPROVAL
ELEVATION CERTIFICATE		GRA	ADING PERMIT APPROVAL
CLOMR/LOMR		SO-1	9 APPROVAL
TRAFFIC CIRCULATION LAYOU'	T (TCL)	PAV	ING PERMIT APPROVAL
TRAFFIC IMPACT STUDY (TIS)		GRA	ADING/ PAD CERTIFICATION
OTHER (SPECIFY)		WOF	RK ORDER APPROVAL
PRE-DESIGN MEETING?		CLO	MR/LOMR
		FLO	ODPLAIN DEVELOPMENT PERMIT
		OTH	IER (SPECIFY)
DATE SUBMITTED:			
COA STAFF:		VIC SUBMITTAL REC	

COA STAFF:

FEE PAID:___



July 22, 2022

City of Albuquerque Planning Department Plaza del Soil Building 600 Second NW Albuquerque, NM 87102

Re: Letter of Authorization 4401 Alexander Blvd NE Site Plan – DRB Process

To Whom It May Concern,

I hereby authorize Burns & McDonnell to act on our behalf to represent Curia Global to the City of Albuquerque for the 4401 Alexander Blvd Site Plan – DRB Process. As Curia New Mexico LLC's (f/k/a Oso Pharmaceutical) Agent, Burns & McDonnell will submit documents to and communicate with the Planning Department until the project's completion.

If in any case, the Planning Department Staff should have questions in this matter, please contact me at Adam.Lysiak@curiaglobal.com.

Sincerely,

Adam Lysiak, P.E.

Adam Lysiak

Senior Director of Project Engineering Adam.Lysiak@curiaglobal.com

(908) 752-9244

cc: Amber Yount, Burns & McDonnell

Steven Karl, Curia Global

PRE-APPLICATION MEETING NOTES

PA#: <u>22-113</u>	Notes Provided (date):2-27-22
Site Address and/or Location: 4401 Alexander Blv	rd. NE 87107
	y and are non-binding. They do not constitute an approval of any ne the exact type of process and/or application required. Factors come significant as a case progresses.
(~8,000SF); Utility Space (~11,000 SF).	~17,000SF); Packaging (~16,000SF); ~ Office type support
	t (Gross Floor Area) has increased from 52,000 SF to
60,000 SF. All submitted drawings reflect the Basic Site Information	(J. Lavender 2022.09.12)
Current Use(s): office	Size (acreage): ~12 acres
Zoning: NR-GM	Overlay Zone(s): N/A (zoning entitlements)
Comprehensive Plan Designations	Corridor(s): within 660' Montano Rd. Major Tansit
Development Area: Change	Near Major Public Open Space (MPOS)?: N/A
Center: Renaissance Employment Center	
Integrated Development Ordinance (IDO)	
Please refer to the IDO for requirements regarding https://www.cabq.gov/planning/codes-policies-reguents	dimensional standards, parking, landscaping, walls, signage, etc. <u>alations/integrated-development-ordinance</u>
Proposed Use(s): <u>Light Manufacturing</u> , Office,	
Use Specific Standards: 4-3(E)(4) Light Manufact	turing
Applicable Definition(s): Light Manufacturing The assembly, fabrication, or processing of goods an growing food or plants in fully enclosed portions of a do not create noise, smoke, fumes, odors, glare, or houlding or lot where such assembly, fabrication, or processes are housed primarily within the fully enclounloading from rail spurs and wholesaling of product incidental to this use. This use does not include any and Manufacturing or Special Manufacturing. See also Carroducts Manufacturing and Cannabis Cultivation Sensitive Lands: Please see IDO Section 14-16-5-standards, and changes to process that may result in the second section in the second s	building, using processes that ordinarily health or safety hazards outside of the processing takes place, where such used portions of a building. Loading and the manufactured at the facility are use that meets the definition of Heavy annabis Definitions for Cannabis-derived
Notice	
Neighborhood Meeting Offer Required? (see IDO T	Table 6-1-1). If yes, please refer to:
https://www.cabq.gov/planning/urban-design-develo	opment/neighborhood-meeting-requirement-in-the-integrated-

Process

development-ordinance

Decision Type(s) (see IDO Table 6-1-1): <u>Site Plan-DRB</u>

Specific Procedure(s)*: 6-6(l	D		
*Please refer to specific proced		teria required to be addi	ressed.
Decision Making Body/ies: _	DRB	Is this a P	RT requirement? <u>Yes</u>
Handouts Provided			
☐ Zoning Map Amendment	☐ Site Plan Amendments	☐ Site Plan- EPC	Site Plan- DRB
☐ Site Plan- Admin	□ Variance-ZHE	☐ Conditional Use	
☐ Site History/Research	Transportation	□ Hydrology	☐ Fire
If you have additional questions, PA# with your inquiry.	please contact Staff at <u>planni</u>	ngprt@cabq.gov or at (S	505) 924-3860. Please include th
Additional Notes:			
• Site is w	vithin a Site Development Plan	2018-1005233 Sundt's	Industrial Center.
0	Please review in case there are	any associated design s	tandards
• Understa	and the permitting process step	os, durations of review a	nd expectations of the City:
0	See above and attached handon	uts for process.	
	ontact permitting for informati g building permit.	on regarding separating	out into two separate submission
0	Zoning/Code Enforcement: A	ngelo Metzgar (ametzga	r@cabq.gov)
• For fire	related questions please contac	et the fire department	
	Fire Marshal: Antonio Chinneeded)	achilla (achinchilla@cab	q.gov) or call 505-924-3611 (if
 For land 	scaping requirements please se	ee IDO Section 5-6 Land	dscaping Buffering and screening

• For waste discharge limitations please contact Solid Waste or Environmental health.

o Solid Waste: Herman Gallegos (hgallegos@cabq.gov)


(pg. 285).

FORM P: PRE-APPROVALS/SIGNATURES

Please refer to the DRB public meeting schedule for meeting dates and deadlines. Your attendance is required.


Leg	gal Description & Location: 4401 Alexander Blvd. NE
	Track B Block 5 Plat Of Tracts A & B Block 5 Sundt's Industrial Center 11.86 AC
Job	Description: Two story expansion of existing building; Aseptic Manufacturing Packaging, Office type support, Utility Space Hydrology:
	 Grading and Drainage Plan AMAFCA Bernalillo County NA NMDOT MRGCD Approved NA NA NA NA NA NA NA NA
	Hydrology Department Date
	<u>Transportation:</u>
	 Traffic Circulations Layout (TCL) Traffic Impact Study (TIS) Neighborhood Impact Analysis (NIA) Bernalillo County MRCOG NMDOT MRGCD Approved NA Approved NA Approved NA Approved NA Approved NA NA Approved NA Date
	Albuquerque Bernalillo County Water Utility Authority (ABCWUA):
	 Water/Sewer Availability Statement/Serviceability Letter Approved NA ABCWUA Development Agreement Approved NA ABCWUA Service Connection Agreement Approved NA
	ABCWUA Date
	Infrastructure Improvements Agreement (IIA*) Approved NA Solid Waste Department Signature on the plan Approved NA Fire Marshall Signature on the plan Approved NA

^{*} Prior to Final Site Plan approval submittals (include a copy of the recorded IIA)

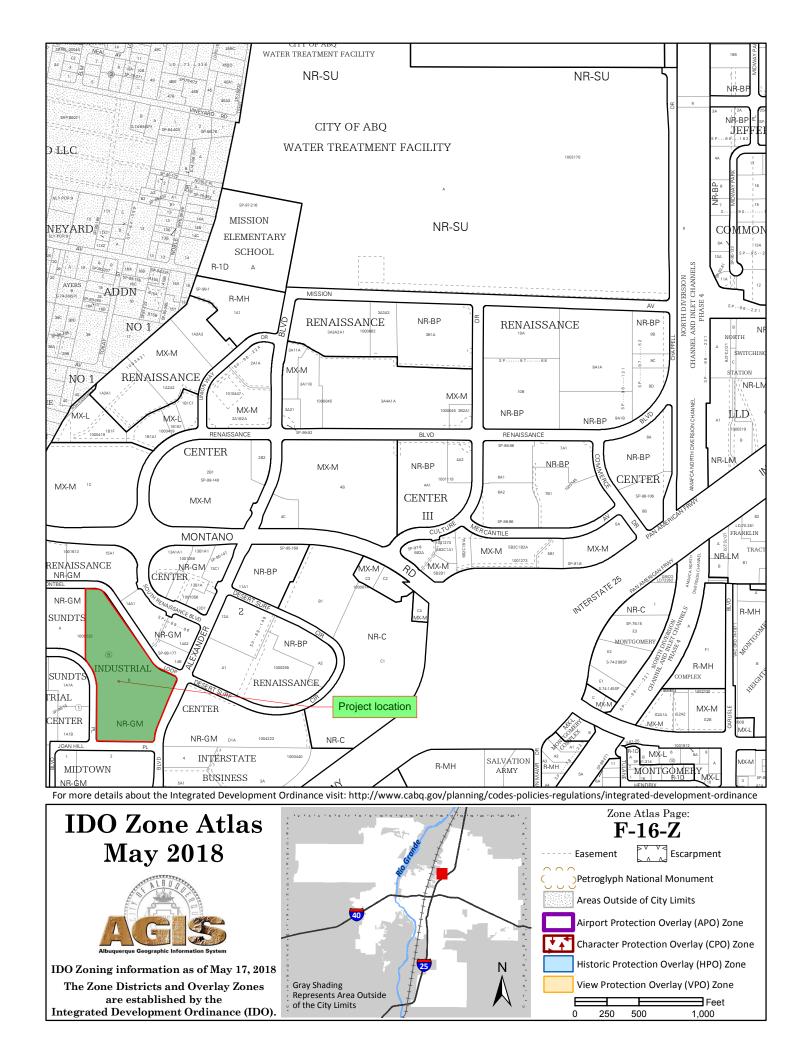

4/13/22, 10:21 AM Zone Atlas

Zone Atlas

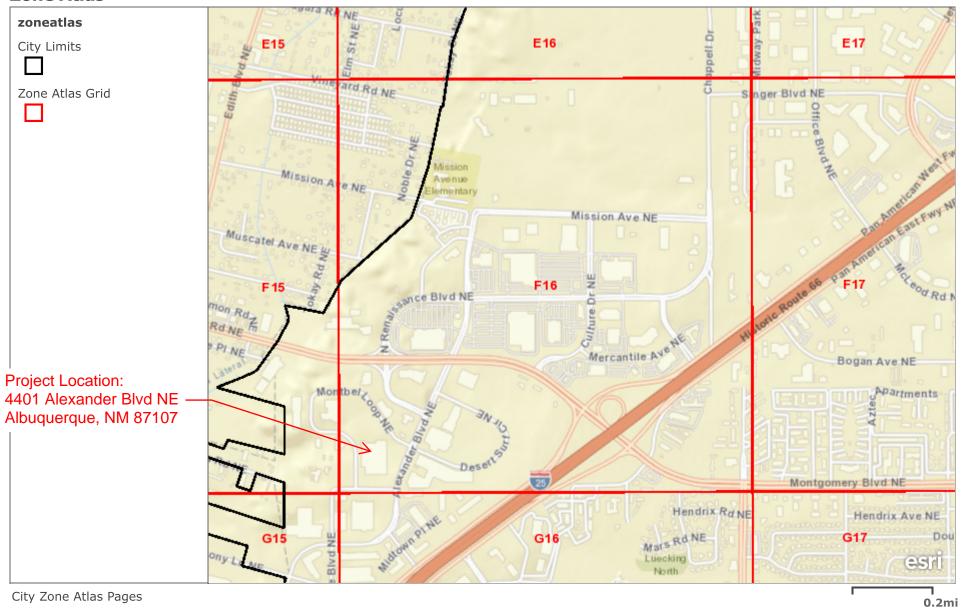

City of Albuquerque, Bernalillo County, NM, Bureau of Land Management, Esri, HERE, Garmin, GeoTechnologies, Inc., NGA, USGS



City of Albuquerque

Planning Department
Development Review Services Division

Traffic Scoping Form (REV 07/2020)

Project Title: New Mexico Expansion Project
Building Permit #: Hydrology File #:
Zone Atlas Page: F-16-Z DRB#: 22-113 EPC#: Work Order#:
Legal Description: TR B BLK 5 PLAT OF TRACTS A & B BLK 5 SUNDT'S INDUSTRIALCENTER CONT 11.8662 AC
Development Street Address: 4401 Alexander Blvd. NE 87107
Applicant: Curia New Mexico, LLC (f/k/a Oso Biopharmaceuticals Manufacturing, LLC) Contact: Adam Lysiak
Address: 4240 Balloon Park Rd NE, Albuquerque, NM 87109
Phone#: 908-752-9244 Fax#:
E-mail: Adam.Lysiak@curiaglobal.com
Development Information
Build out/Implementation Year: 2022 Current/Proposed Zoning: NR-GM
Project Type: New: () Change of Use: () Same Use/Unchanged: () Same Use/Increased Activity: (X)
Change of Zoning: ()
Proposed Use (mark all that apply): Residential: () Office: () Retail: () Mixed-Use: (X)
Describe development and Uses: Two story expansion that includes aseptic manufacturing, packaging, utility space, and office support.
Days and Hours of Operation (if known): 24 hour, 7 day per week manufacturing facility
Facility
Building Size (sq. ft.): approx. 60,000 sq. ft. (Two-Story Building)
Number of Residential Units: N/A
Number of Commercial Units: N/A
<u> Fraffic Considerations</u>
TE Trip Generation Land Use Code
Expected Number of Daily Visitors/Patrons (if known):* 0-10
Expected Number of Employees (if known):* 163 Employees 103 Existing, 60 additional
Expected Number of Delivery Trucks/Buses per Day (if known):*_ 6 to 10 deliveries per day
Trip Generations during PM/AM Peak Hour (if known):* 5 to 8 PM/AM Peak Hour Generations
Driveway(s) Located on: Street Name Joan Hill PI NE

Adjacent Roadway(s) Posted Speed: Street Name Alexander Blvd NE	Posted Speed	35 mph
Street Name Montbel PI NE	Posted Speed	35 mph
* If these values are not known, assumptions will be made by City staff. Depending on the	e assumptions, a f	îull TIS may be required.)
Roadway Information (adjacent to site) (Alexander Blvd NE)		
Comprehensive Plan Corridor Designation/Functional Classification: Major Collecto (arterial, collector, local, main street)	r	
Comprehensive Plan Center Designation: Employment Center (urban center, employment center, activity center, etc.)		
Jurisdiction of roadway (NMDOT, City, County):		
Adjacent Roadway(s) Traffic Volume: 5222 (daily) Volume-to-Capacity (if applicable)	Ratio (v/c): _	N/A
Adjacent Transit Service(s): No Bus Stops Nearest Transit Stop(s): .25	miles west/e	east
Is site within 660 feet of Premium Transit?: No		
Current/Proposed Bicycle Infrastructure: Proposed Bike Lanes (bike lanes, trails)		
Current/Proposed Sidewalk Infrastructure: Sidewalk on both right and left side of	of roadway	
Relevant Web-sites for Filling out Roadway Information:		
City GIS Information: http://www.cabq.gov/gis/advanced-map-viewer		
Comprehensive Plan Corridor/Designation: See GIS map.		
Road Corridor Classification : https://www.mrcog-nm.gov/DocumentCenter/View/1920/Long-pdf?bidld =	g-Range-Roadwa	ay-System-LRRS-
Traffic Volume and V/C Ratio: https://www.mrcog-nm.gov/285/Traffic-Counts and <a< td=""><td>public.mrcog-nı</td><td>n.gov/taqa/</td></a<>	public.mrcog-nı	n.gov/taqa/
Bikeways : http://documents.cabq.gov/planning/adopted-longrange-plans/BTFP/Final/BTFP%2081)	FINAL_Jun25. ₁	odf (Map Pages 75 to
TIS Determination		
<u>Note:</u> Changes made to development proposals / assumptions, from the information pro TIS determination.	vided above, v	vill result in a new
Traffic Impact Study (TIS) Required: Yes [] No []		
Thresholds Met? Yes [] No []		
Mitigating Reasons for Not Requiring TIS: Previously Studied: []		
Notes:		

DATE

Submittal

TRAFFIC ENGINEER


The Scoping Form must be submitted as part of a Traffic Circulation Layout submittal, DRB application for site plan approval, or EPC application. See the Development Process Manual Chapter 7.4 for additional information.


Submit by email to plndrs@cabq.gov and to the City Traffic Engineer mgrush@cabq.gov. Call 924-3362 for information.

Site Plan/Traffic Scoping Checklist

Site plan, building size in sq. ft. (show new, existing, remodel), to include the following items as applicable:


- 1. Access -- location and width of driveways
- 2. Sidewalks (Check DPM and IDO for sidewalk requirements. Also, Centers have wider sidewalk requirements.)
- 3. Bike Lanes (check for designated bike routes, long range bikeway system) (check MRCOG Bikeways and Trails in the 2040 MTP map)
- 4. Location of nearby multi-use trails, if applicable (check MRCOG Bikeways and Trails in the 2040 MTP map)
- 5. Location of nearby transit stops, transit stop amenities (eg. bench, shelter). Note if site is within 660 feet of premium transit.
- 6. Adjacent roadway(s) configuration (number of lanes, lane widths, turn bays, medians, etc.)
- 7. Distance from access point(s) to nearest adjacent driveways/intersections.
- 8. Note if site is within a Center and more specifically if it is within an Urban Center.
- 9. Note if site is adjacent to a Main Street.
- 10. Identify traffic volumes on adjacent roadway per MRCOG information. If site generates more than 100 vehicles per hour, identify volume to capacity (v/c) ratio on this form.

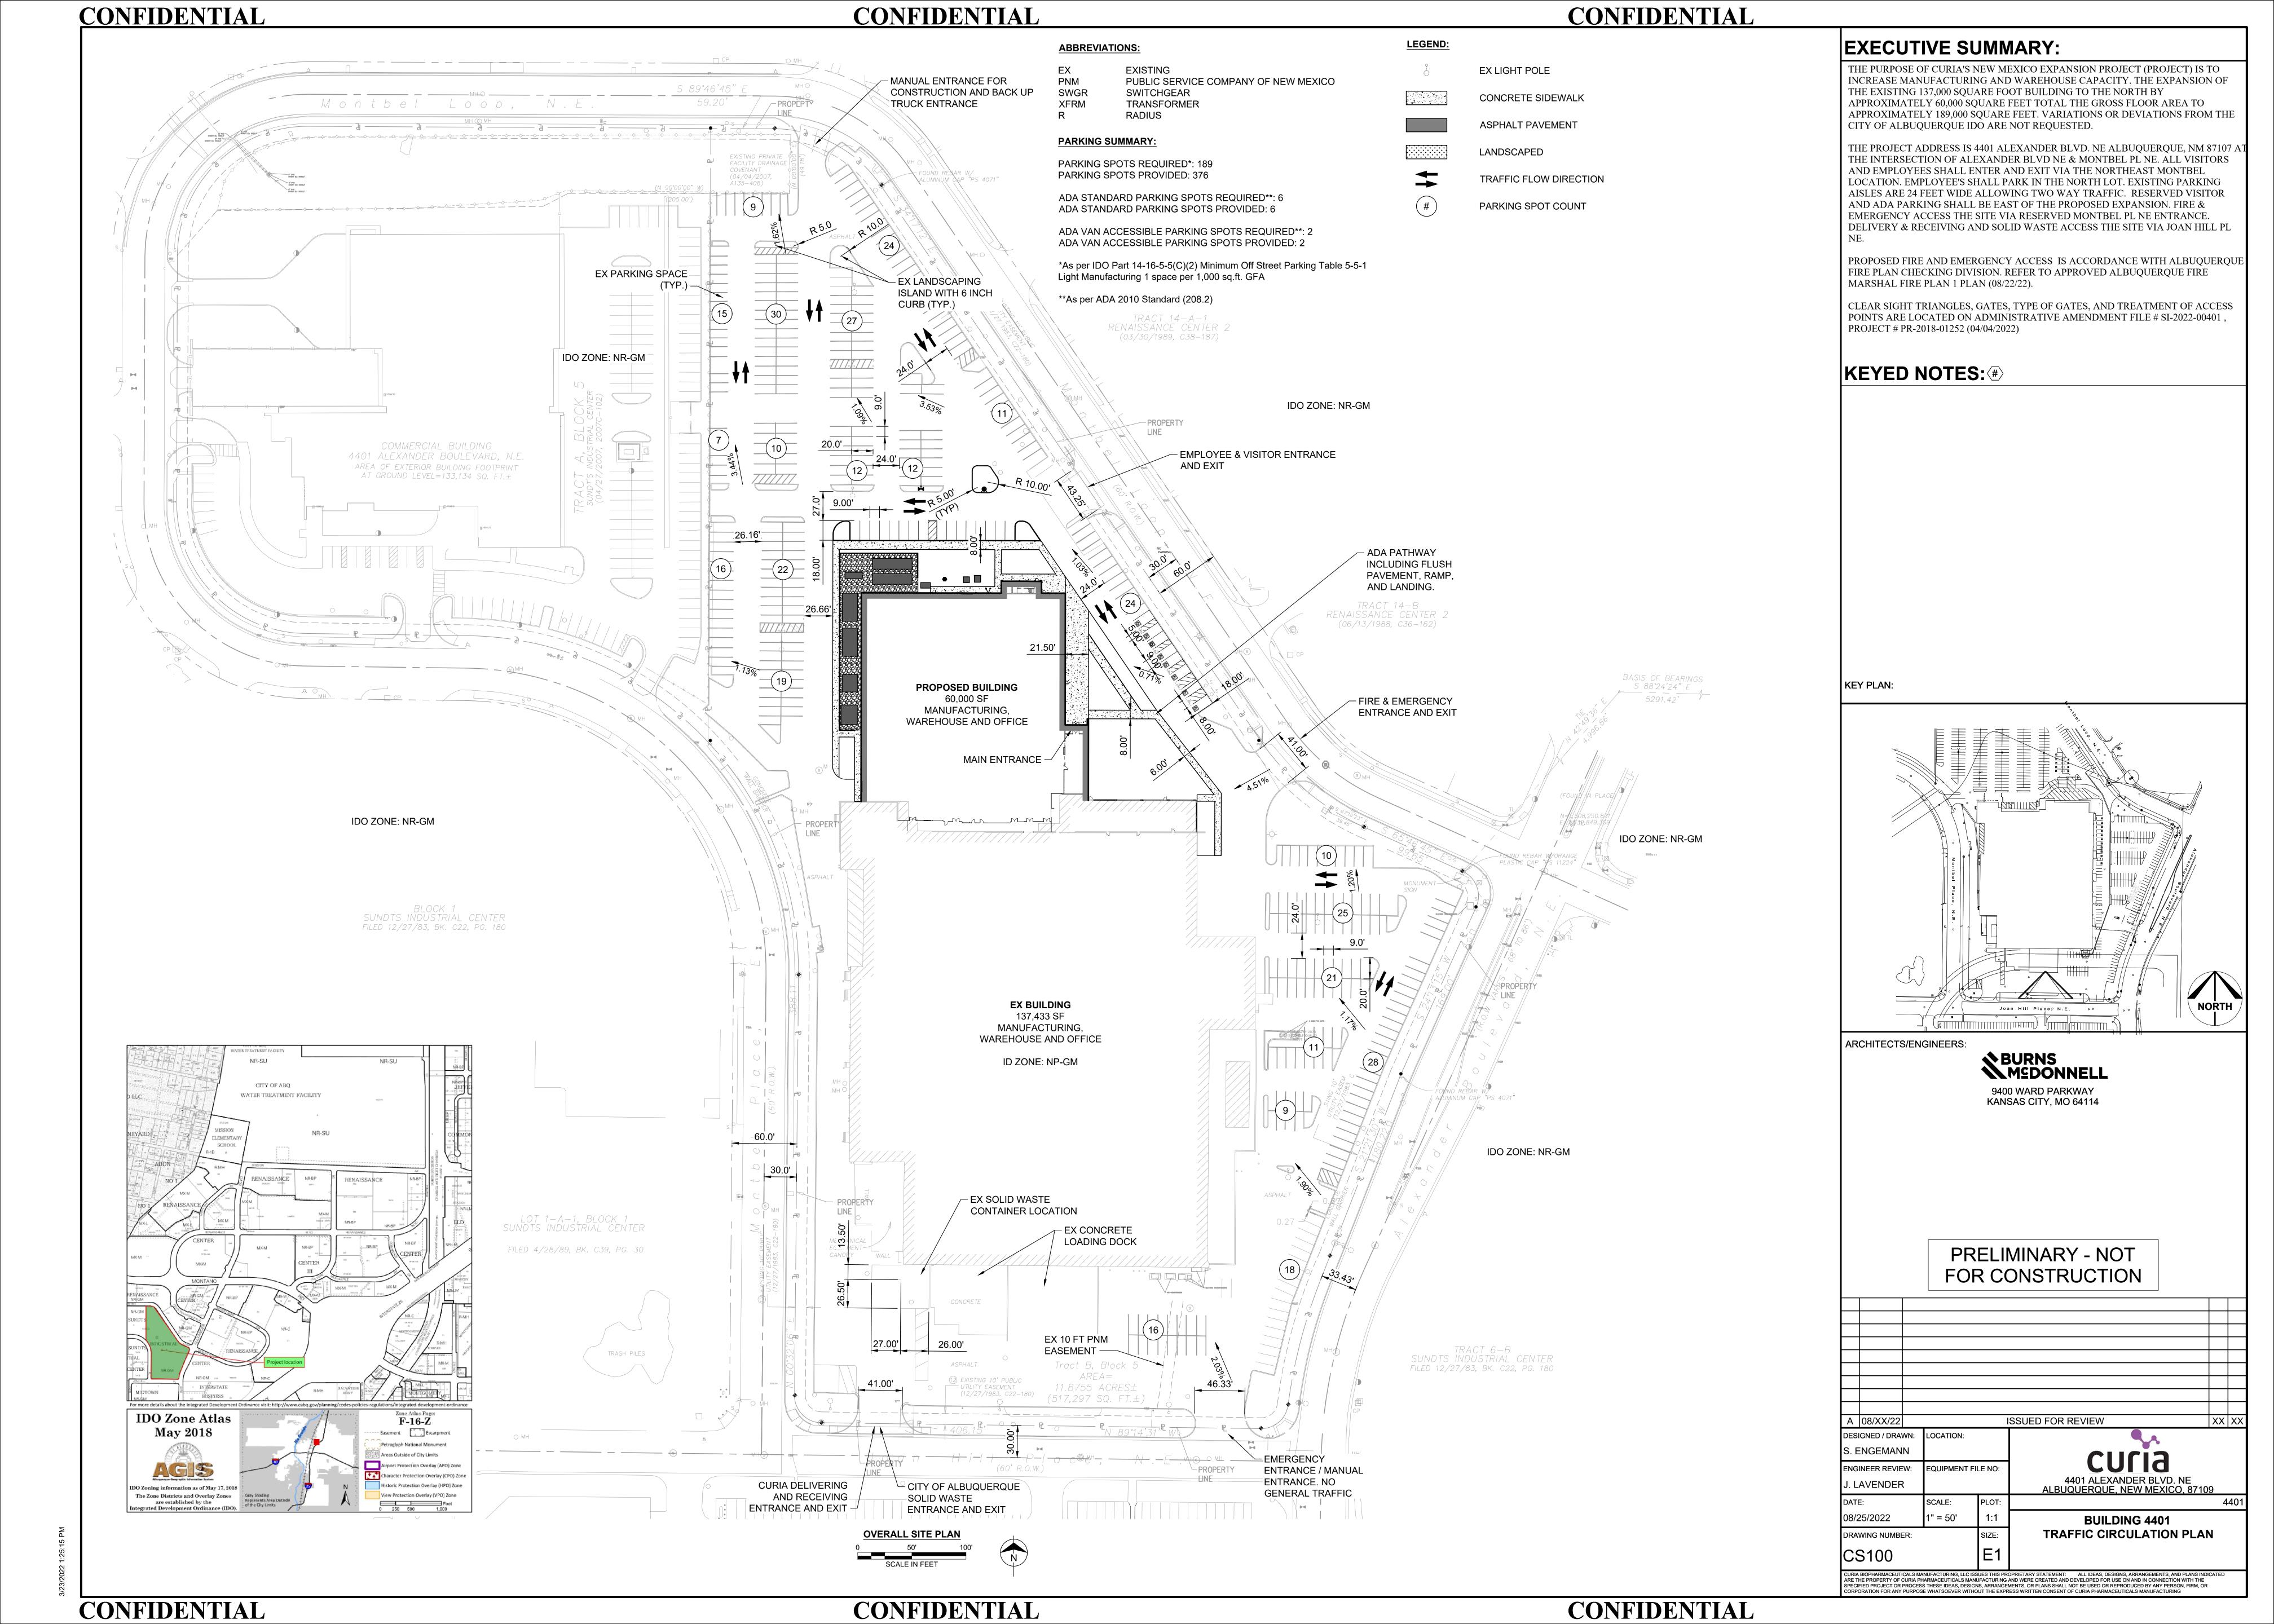


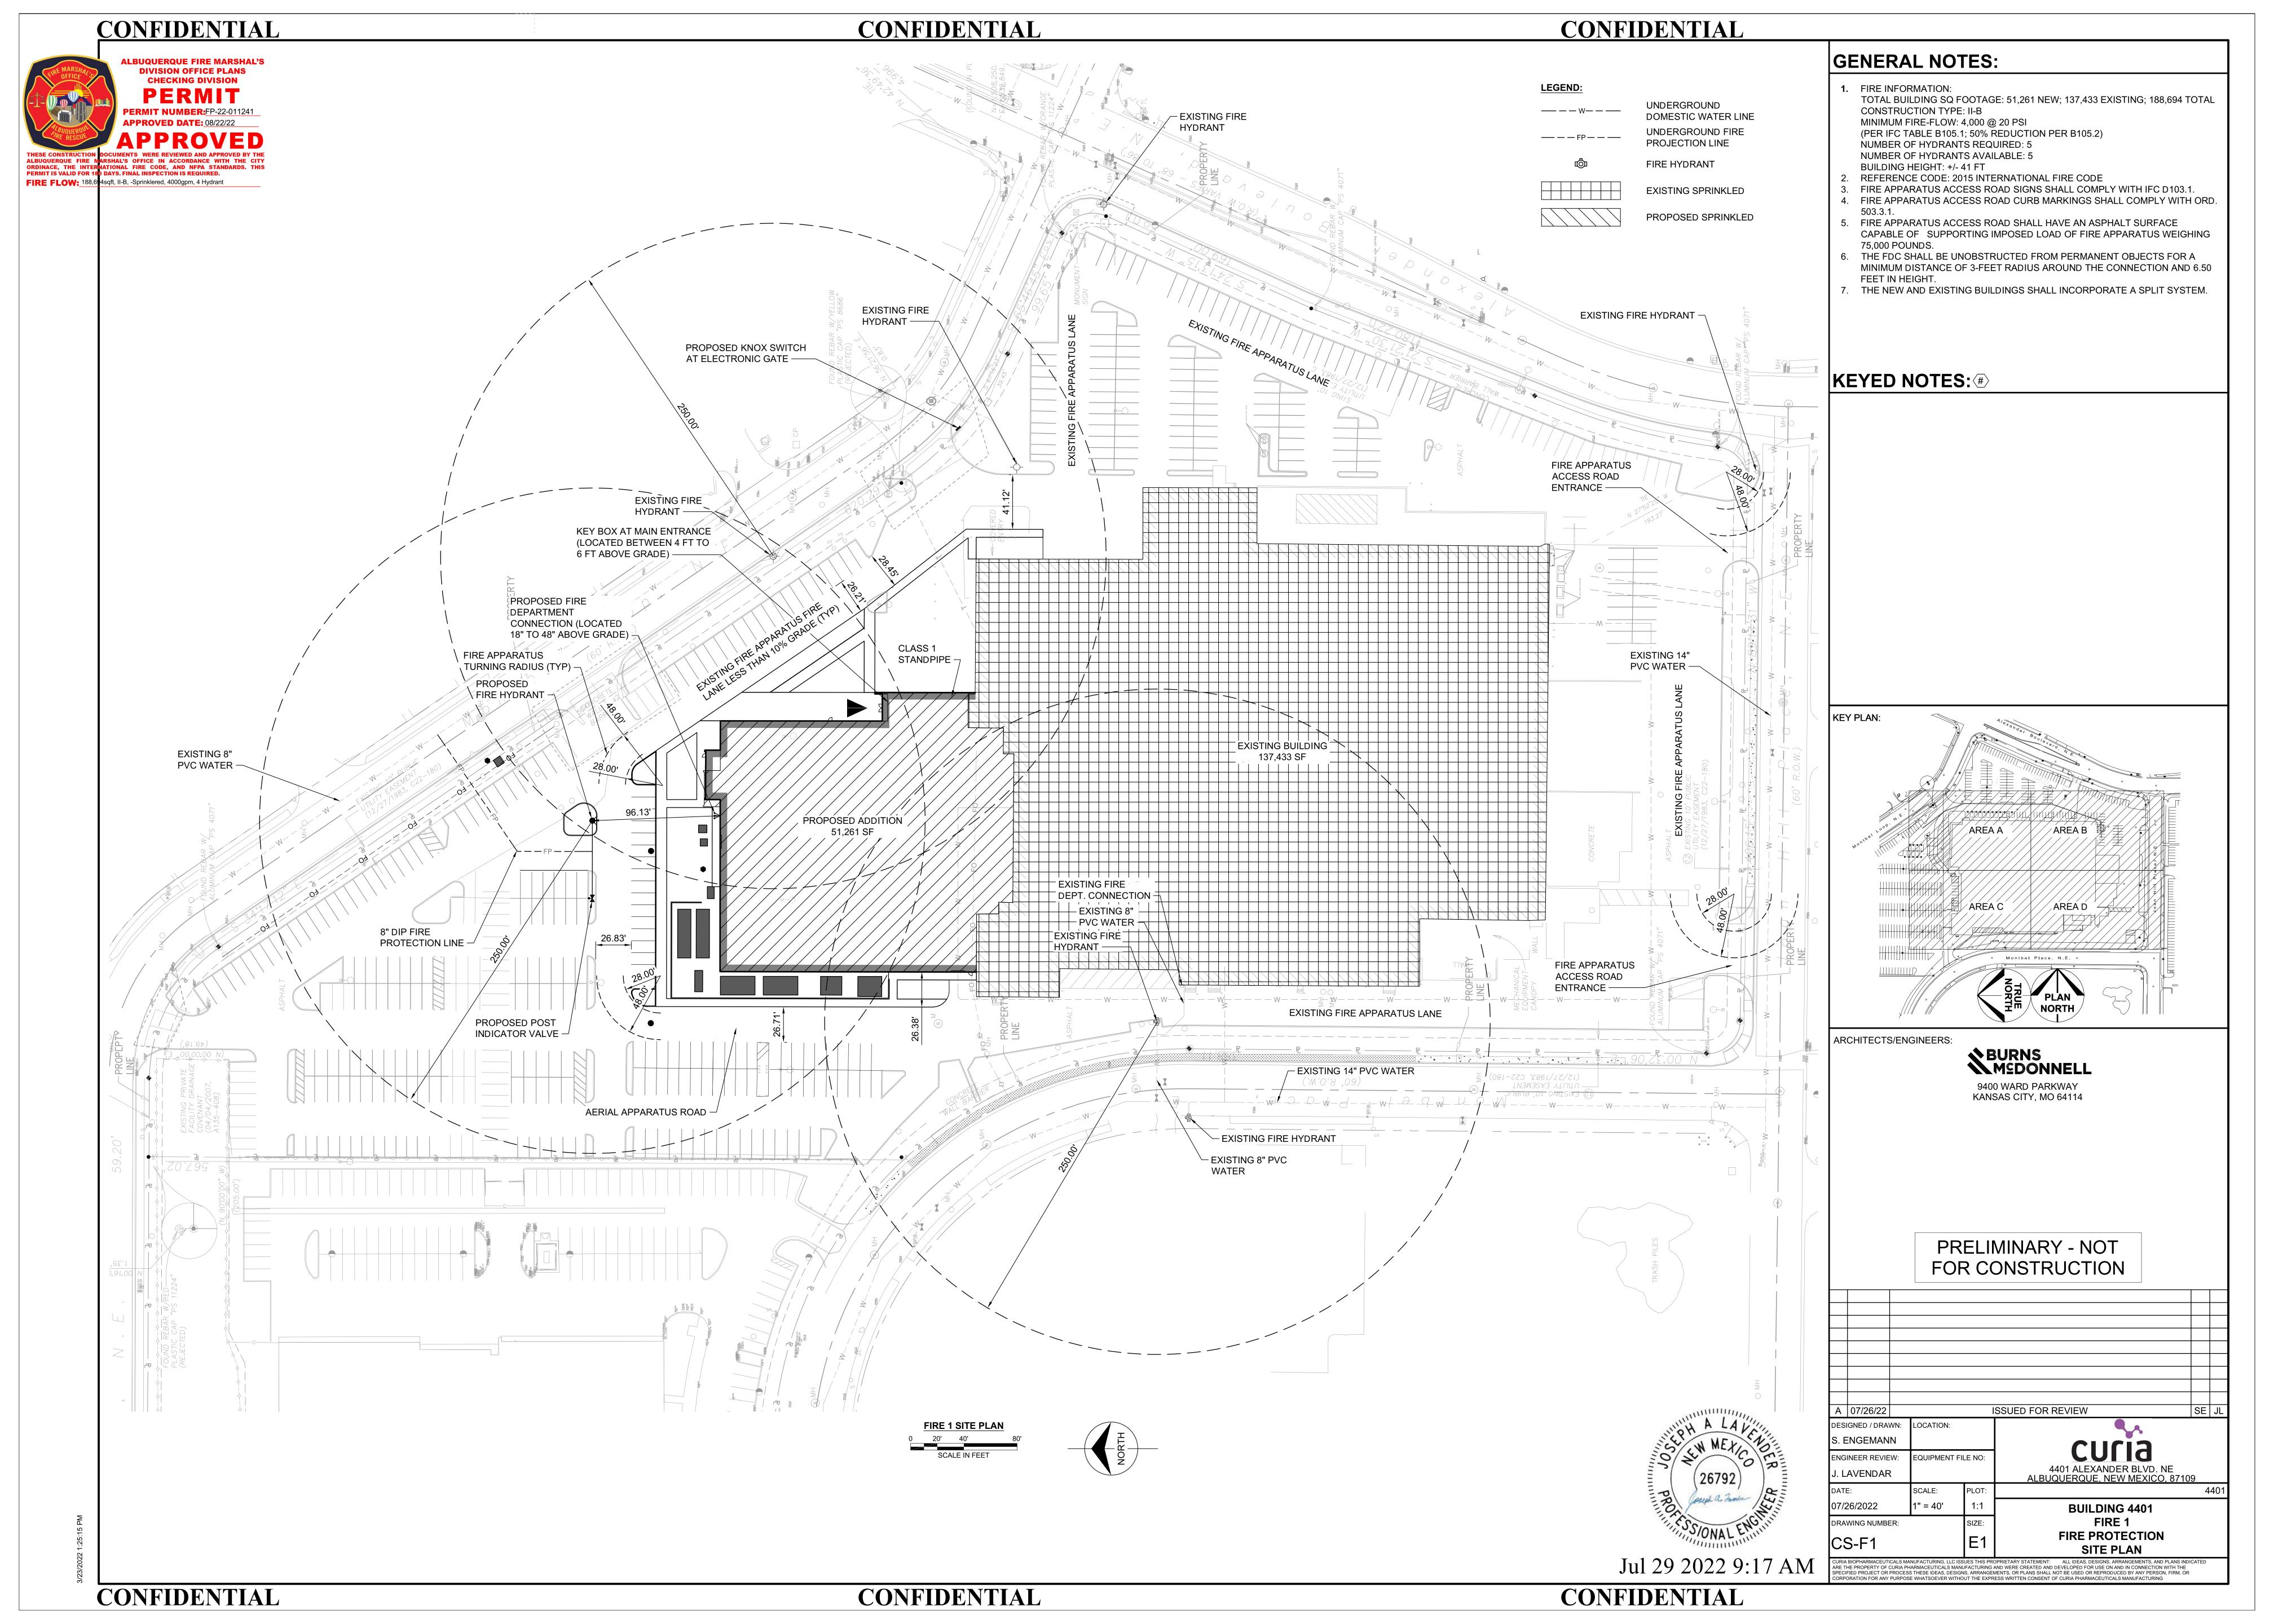


ADMINISTRATIVE AMENDMENT

FILE #: SI-2022-00401 PROJECT #: F	PR-2018-001252
Installation of a security fence around site perimeter; Update Is	andscape to replace
dead trees/plant materials and to accommodate security fence	e; Construction of a
new 5-foot wide public sidewalk around site perimeter; Additio	n of 80 sf security
booth.	
Digitally signed by James M. Aranda DN: cn=James M. Aranda, o=City of Albuquerque, ou=Planning Department, email=jmaranda@cabq.gov, c=US Date: 2022.04.04 09:50:09 -06'00'	4/4/2022
APPROVED BY	DATE

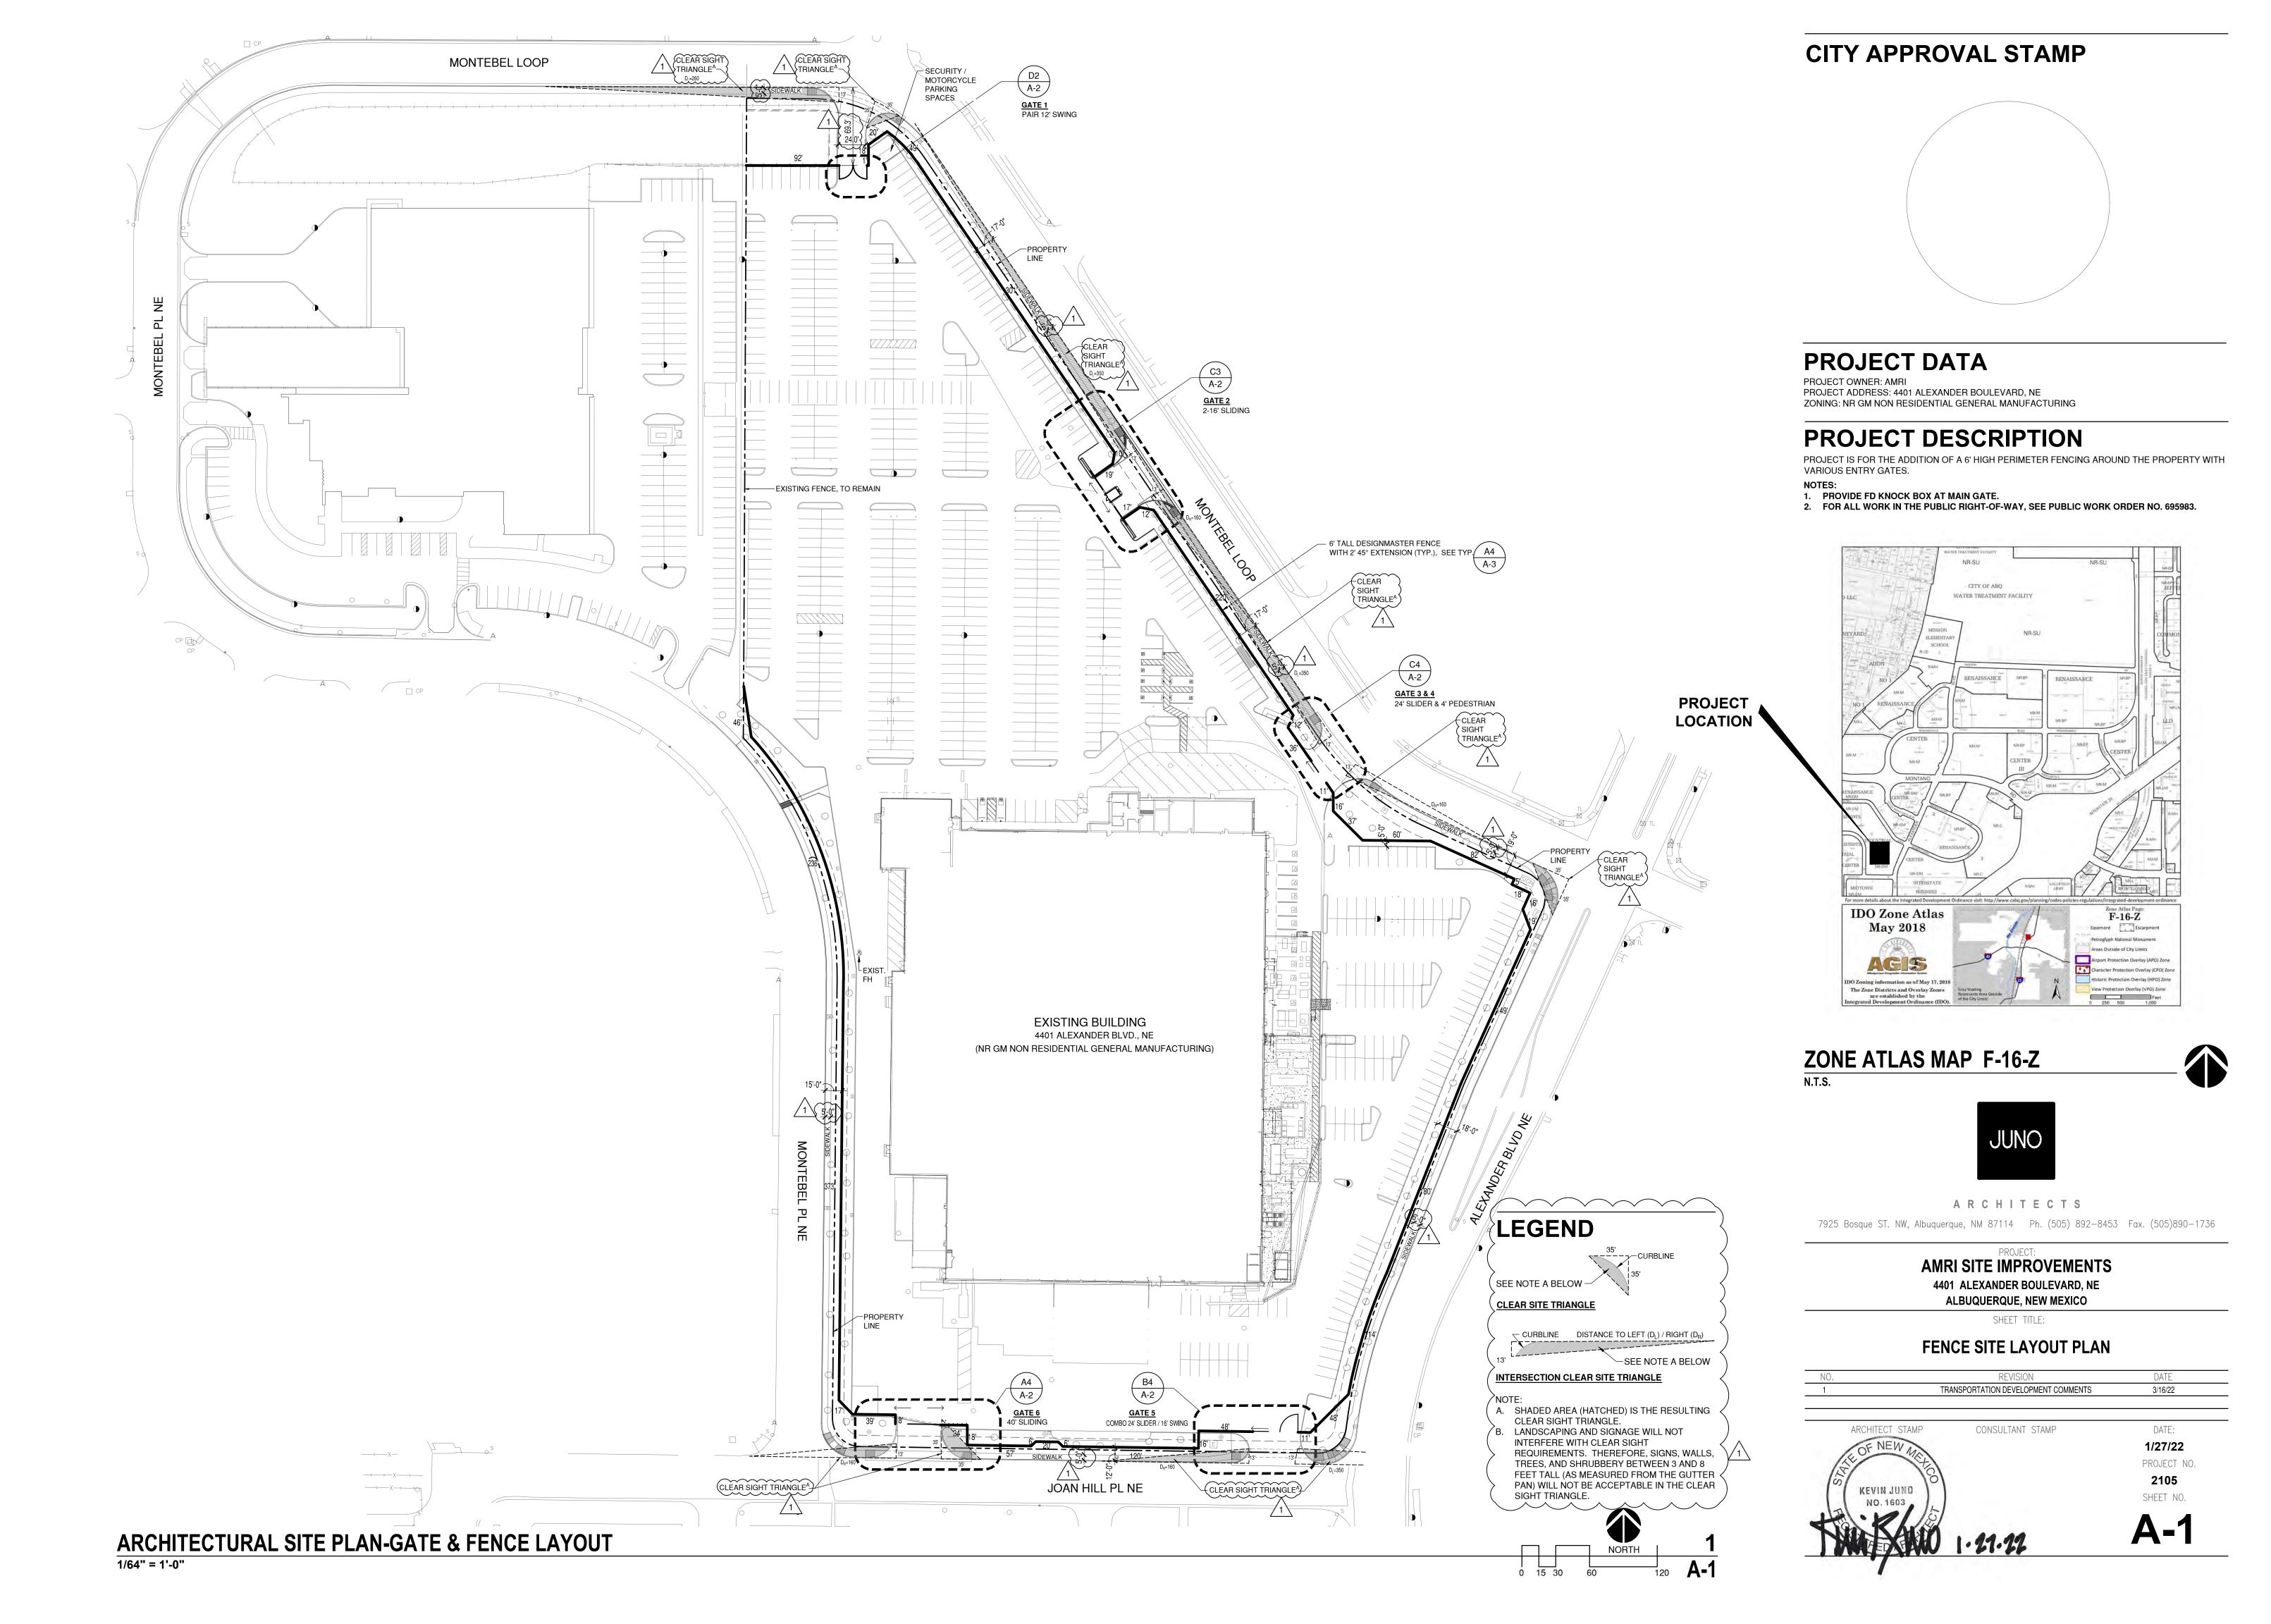

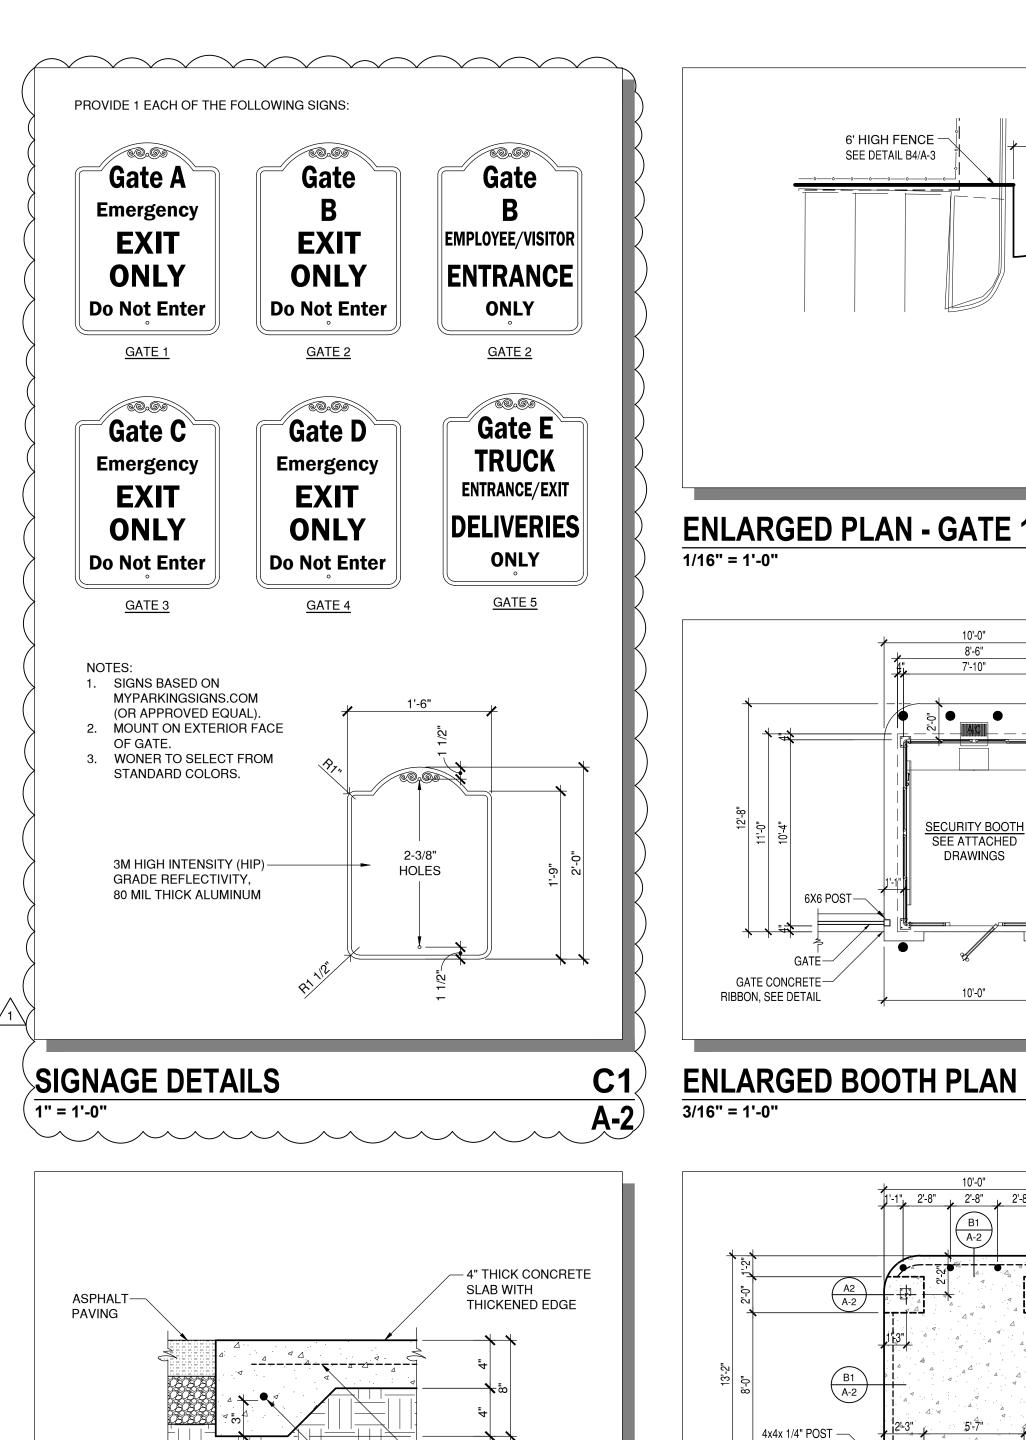

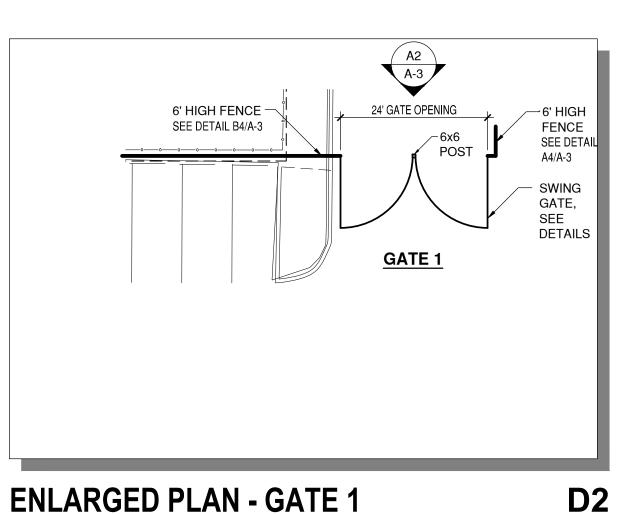

BOLLARD(S) (TYP.)

- ROOF OVERHANG


- CONCRETE SLAB, SEE DETAIL B2/A-2

- 6X6 POST — GATE


ANCHOR BRACKET AT


C2


BASE (TYP.)

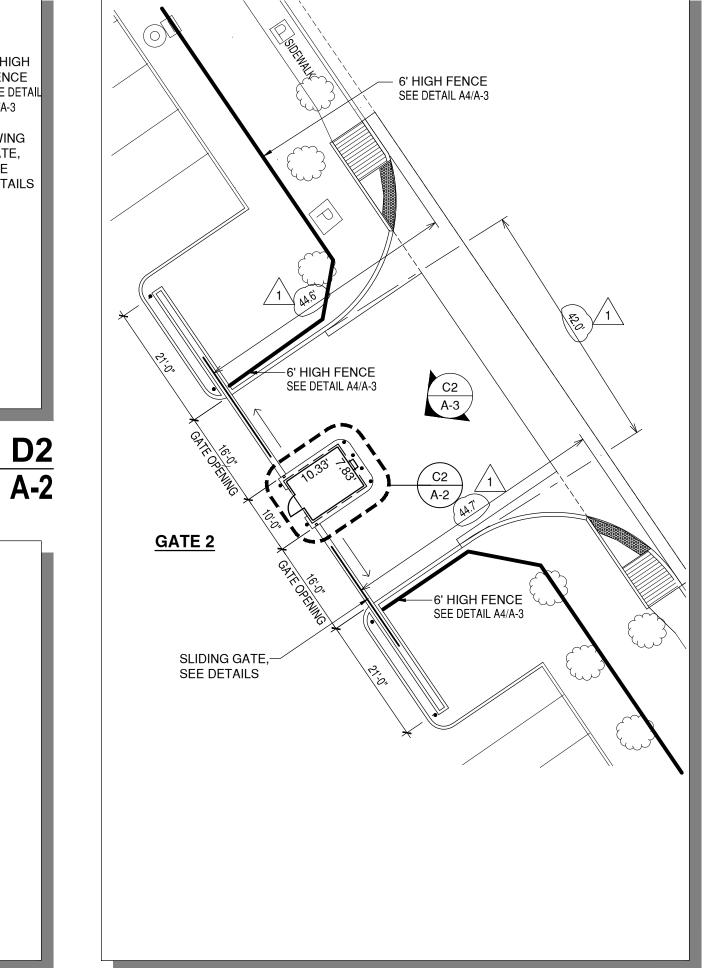


ENLARGED PLAN - GATE 2

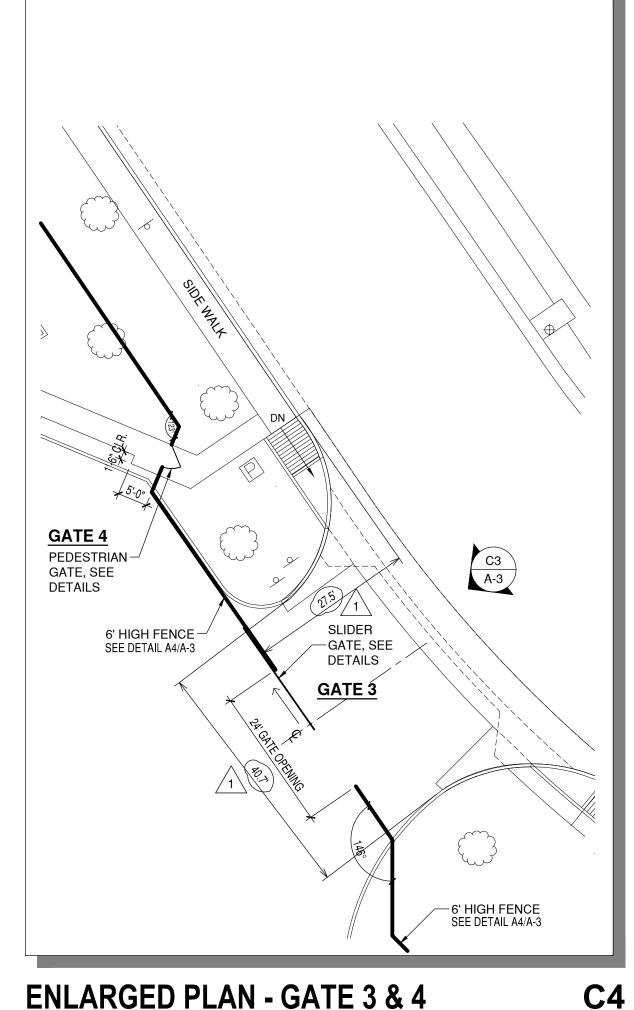

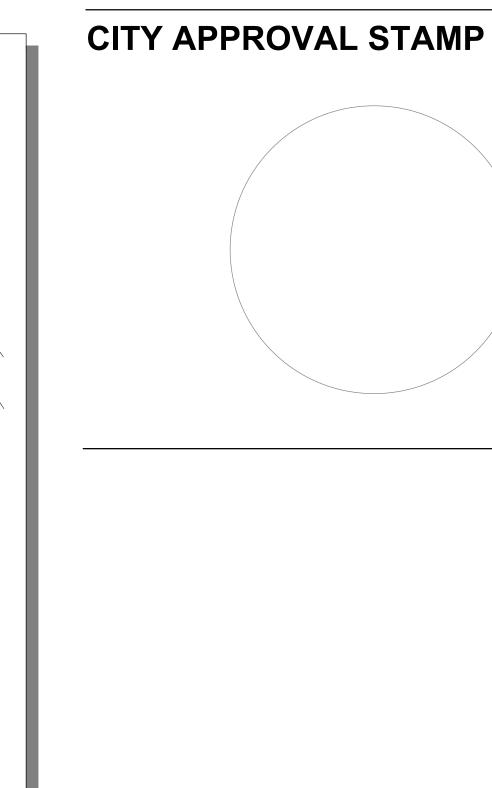

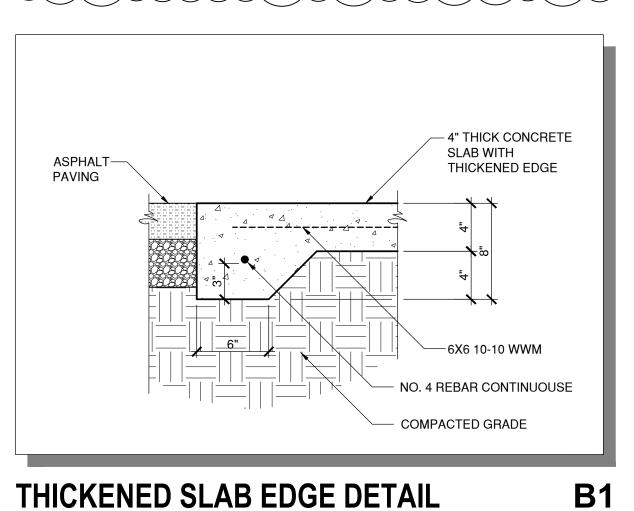

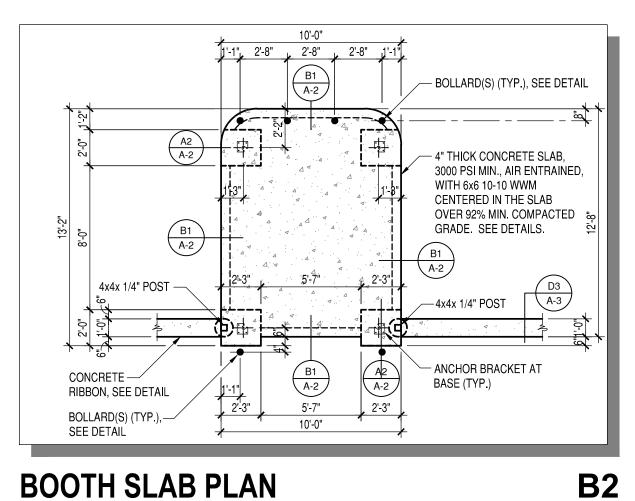


SECURITY BOOTH SEE ATTACHED DRAWINGS


6X6 POST-


GATE CONCRETE—


RIBBON, SEE DETAIL

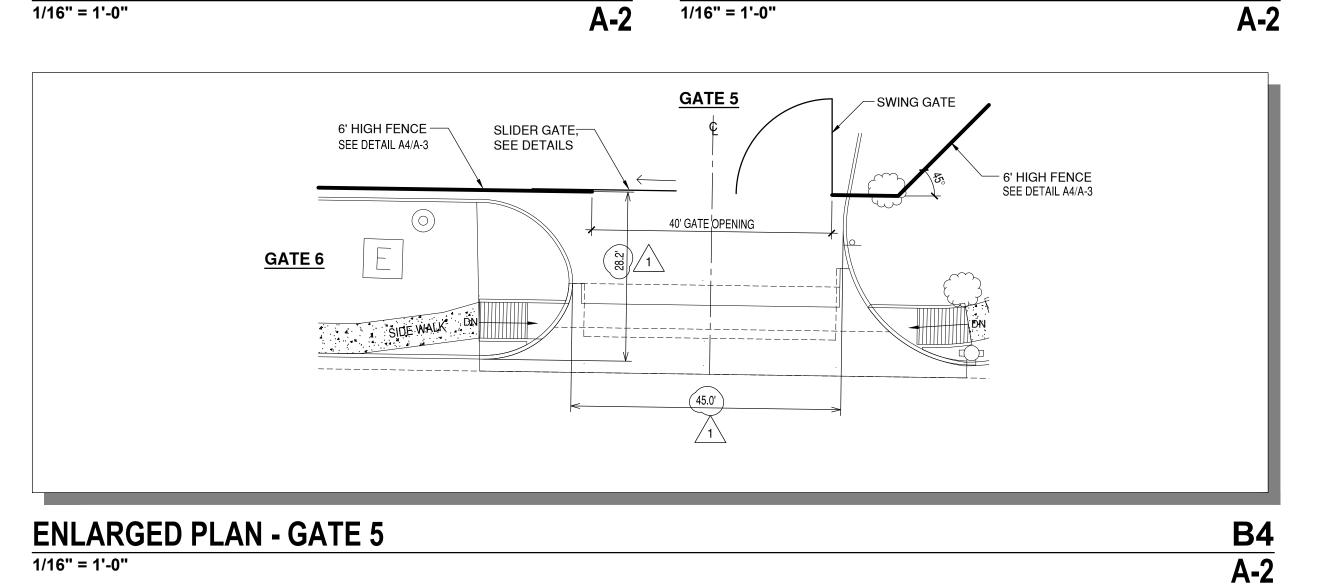

C3

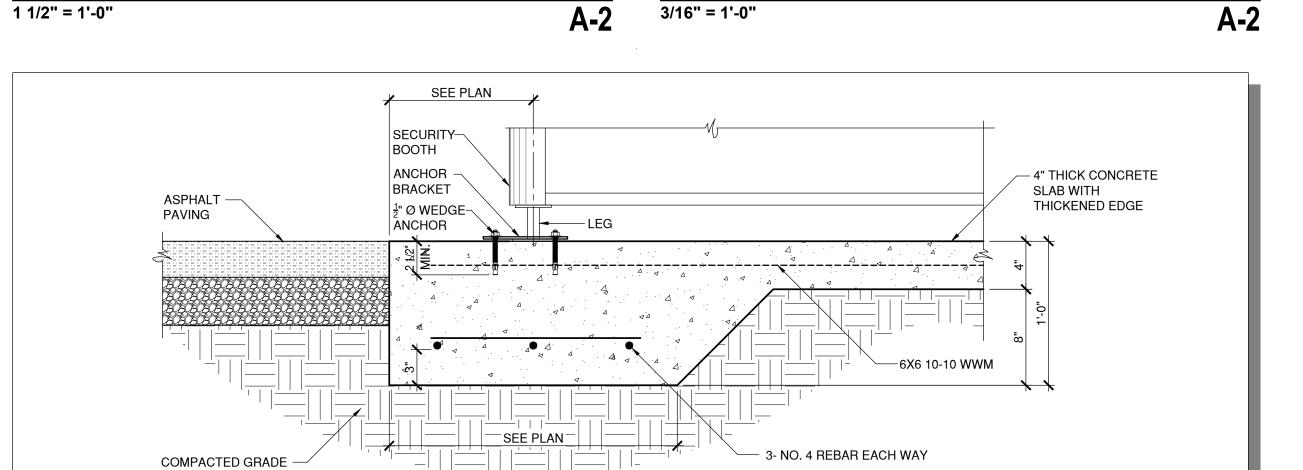

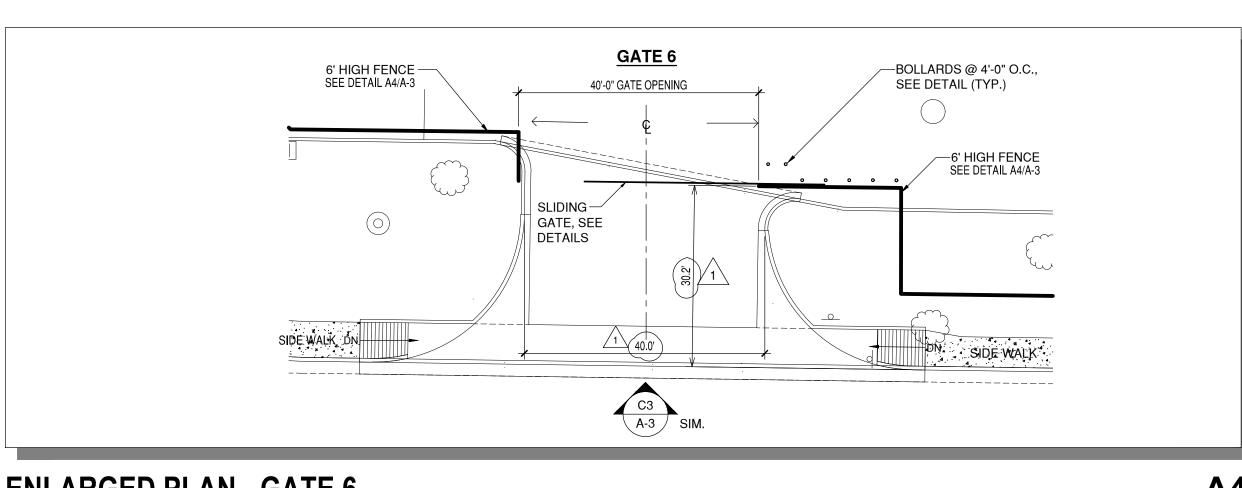

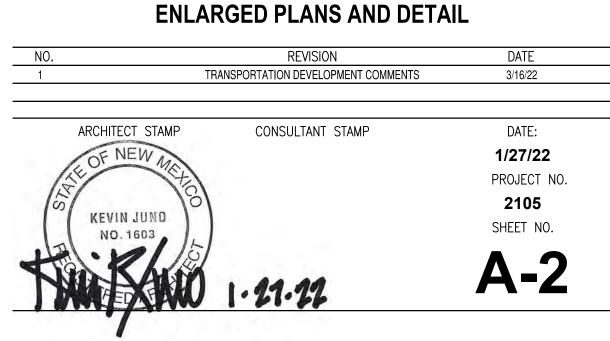

THICKENED SLAB AND BOOTH ANCHORAGE DETAIL 1 1/2" = 1'-0"

A-2


ENLARGED PLAN - GATE 6 1/16" = 1'-0"


JUNO

ARCHITECTS 7925 Bosque ST. NW, Albuquerque, NM 87114 Ph. (505) 892-8453 Fax. (505)890-1736


> AMRI SITE IMPROVEMENTS 4401 ALEXANDER BOULEVARD, NE ALBUQUERQUE, NEW MEXICO

SHEET TITLE:

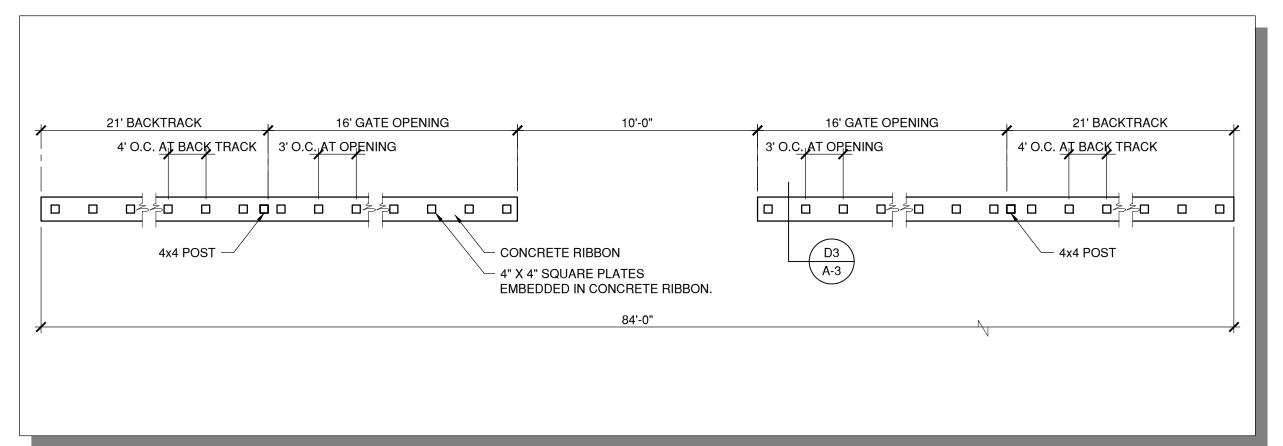

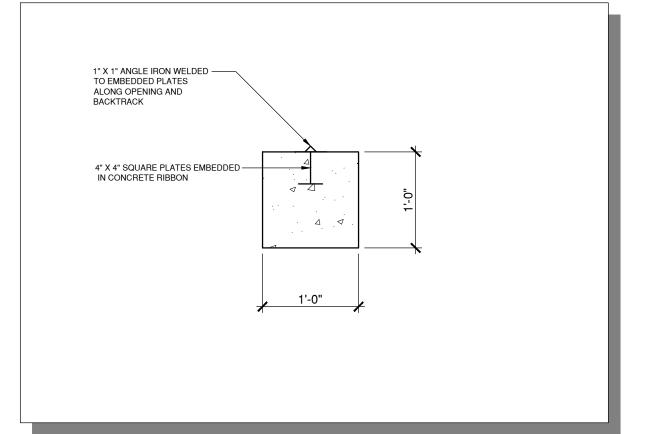

	GATE DIM	ENSIONS	
GATE NUMBER	A	В	С
1	PR. 12'-0"		
2	2@16'-0"		
3	24'-0"		
4	4'-0"	SEE ELEV.	
5	24' SLIDE/16' SWING		
6	40'-0"		

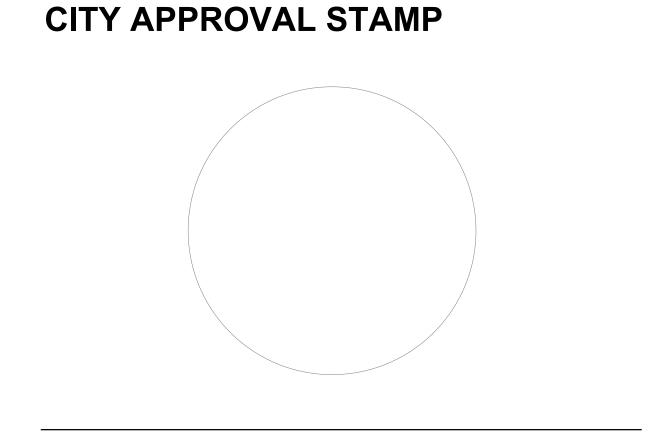


RIBBON PLAN DETAIL	D2
1/4" = 1'-0"	A-3







✓ INSIDE

OUTSIDE

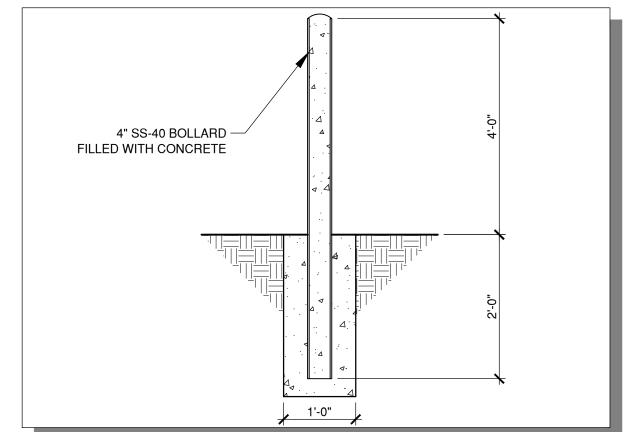

GATE WIDTH (DIMENSION B)	10'-0"	GATE WIDTH (DIMENSION B)	*
16'-0" GATE OPENING 4x4x 1/4" GATE POST	SECURITY BOOTH 4x4x 1/4" GATE POST	16'-0" GATE OPENING	4" SQ 14 GA GATE POST
8' DESIGNMASTER FENCE WELDED TO FRAME 2" SQ 14 GA GATE FRAME 2" X 4" 14 GA BOTTOM RAIL		8' DESIGNMASTER FENCE—WELDED TO FRAME 2" SQ 14 GA GATE—FRAME 2" X 4" 14 GA BOTTOM RAIL—	".08 8'-0"
CONCRETE — V-TRACK RIBBON AT BACK TRACK CONCRETE RIBBON SEE D2 A-3		V-TRACK— TRACK WHEEL— CONCRETE RIBBON— SEE D2 A-3	3.0"

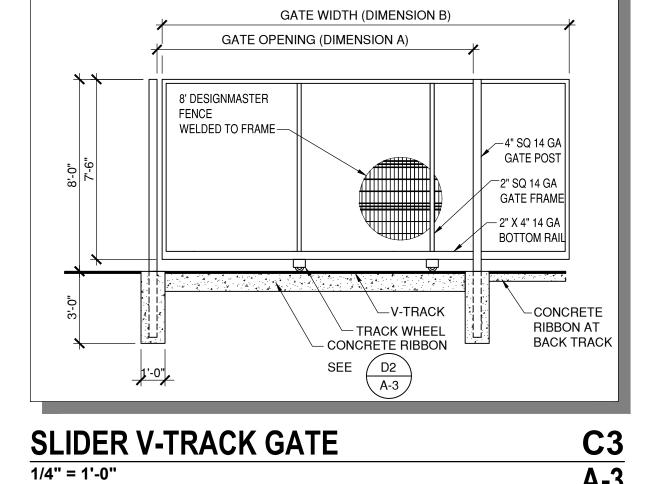

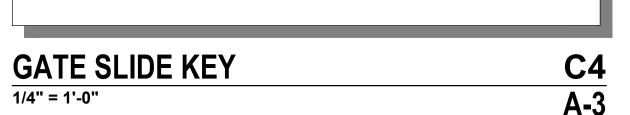


C5 A-3 **BOLLARD DETAIL** 3/4" = 1'-0"





<u>PLAN</u>

ELEVATION

STRONG ARM LATCH

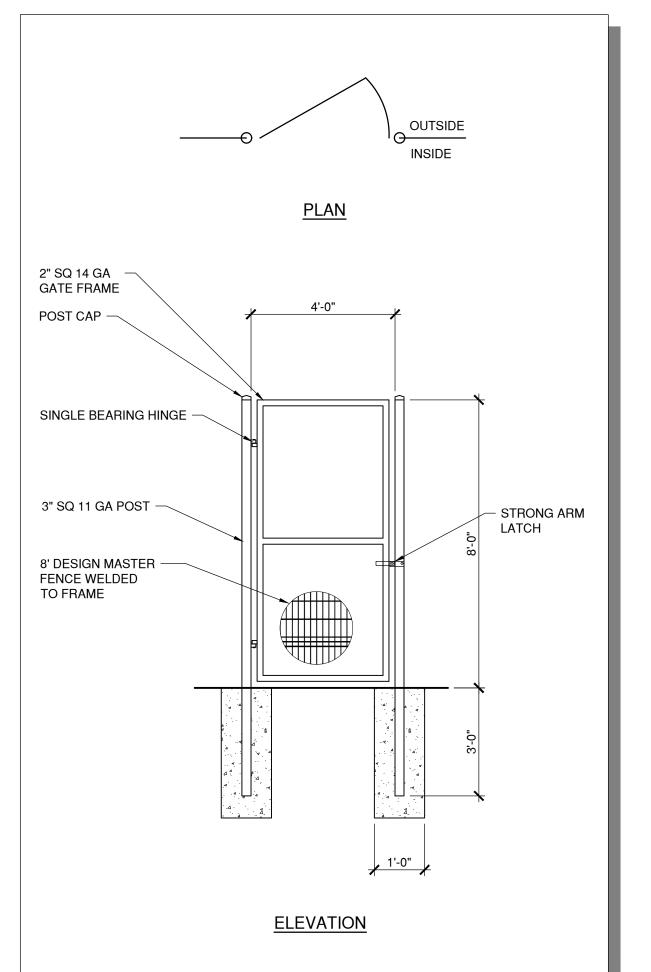

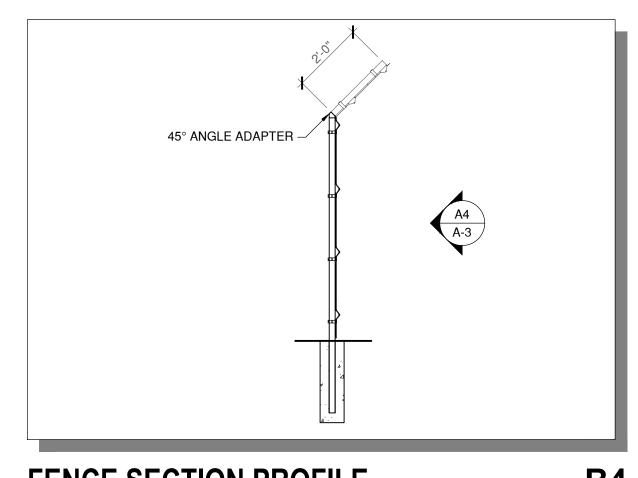

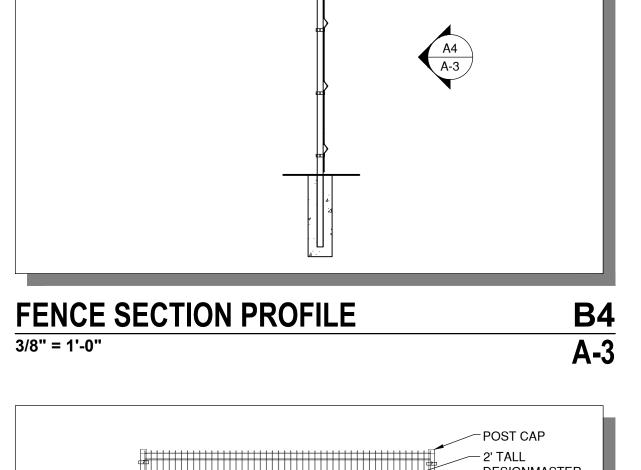



SHEET NO.

SWING GATE 1 DETAIL 3/8" = 1'-0"

2" SQ 14 GA -GATE FRAME


POST CAP -

SINGLE BEARING HINGE -

3" SQ 11 GA POST —


8' DESIGN MASTER


FENCE WELDED TO FRAME

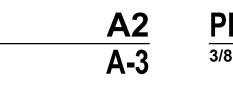


OUTSIDE

1/-0"

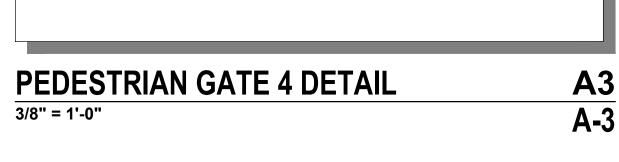


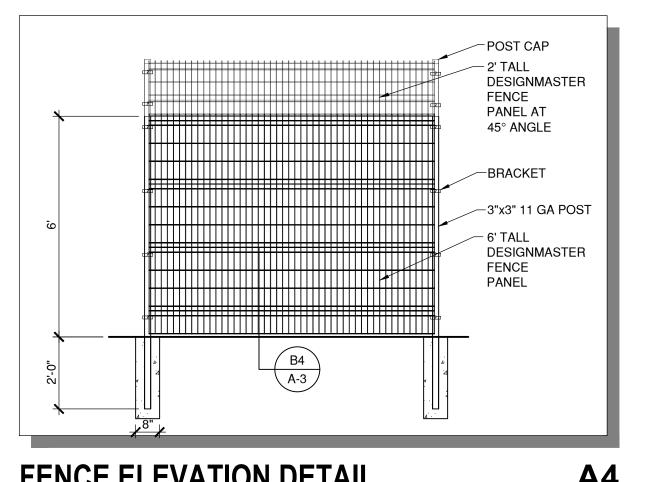

FENCE ELEVATION DETAIL 3/8" = 1'-0"

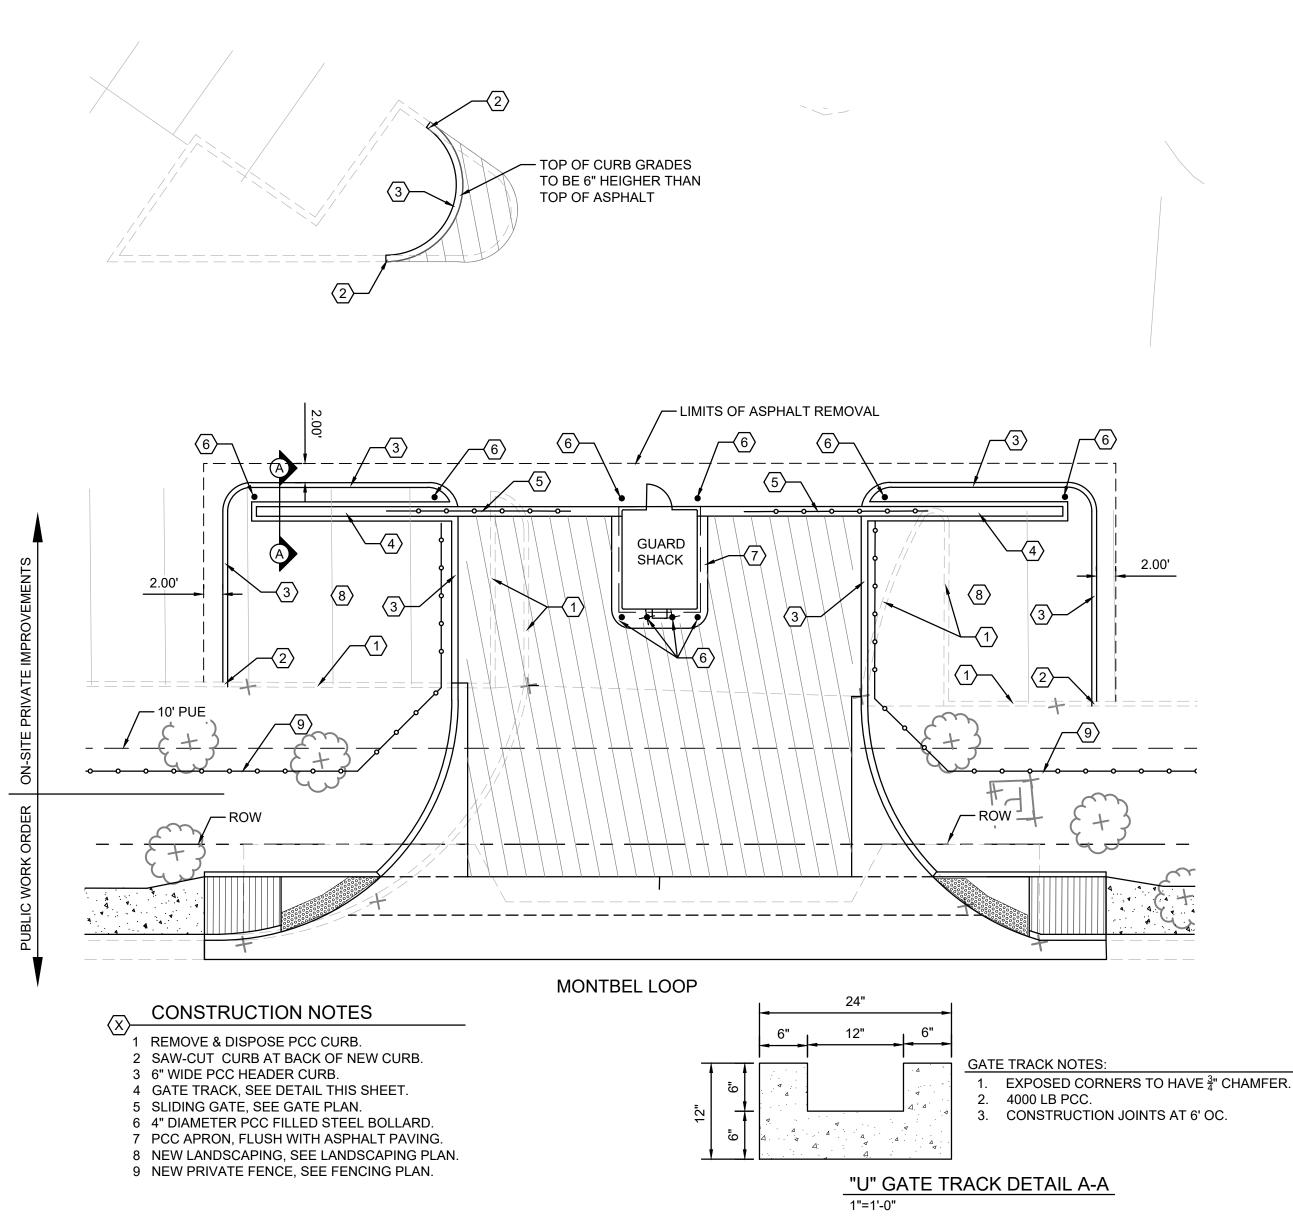


ENTRANCE "B" LAYOUT SCALE: 1"=10'

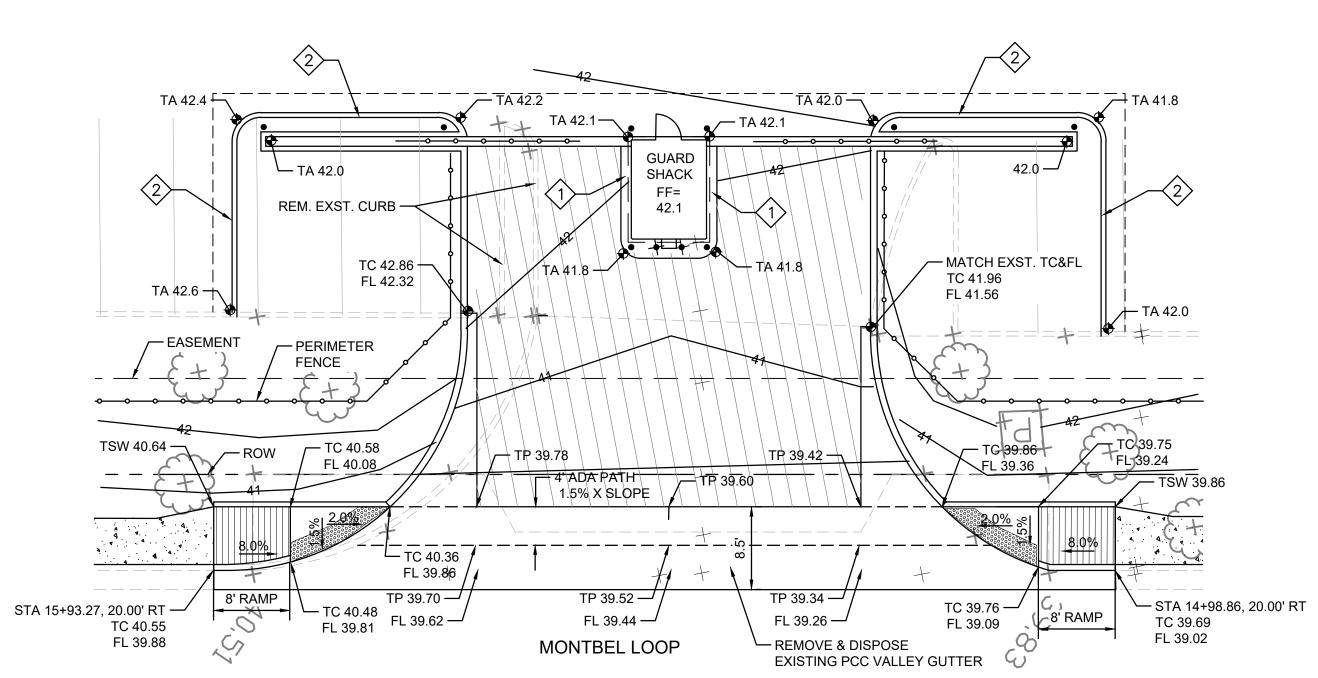

KEYED NOTES

- 1 TRANSITION APRON GRADE FROM PAD ELEVATION TO
- ADJACENT ASPHALT GRADES. 2 ALL CURBS ARE 6" HIGH.

ENTRANCE "B" GRADING SCALE: 1"=10'

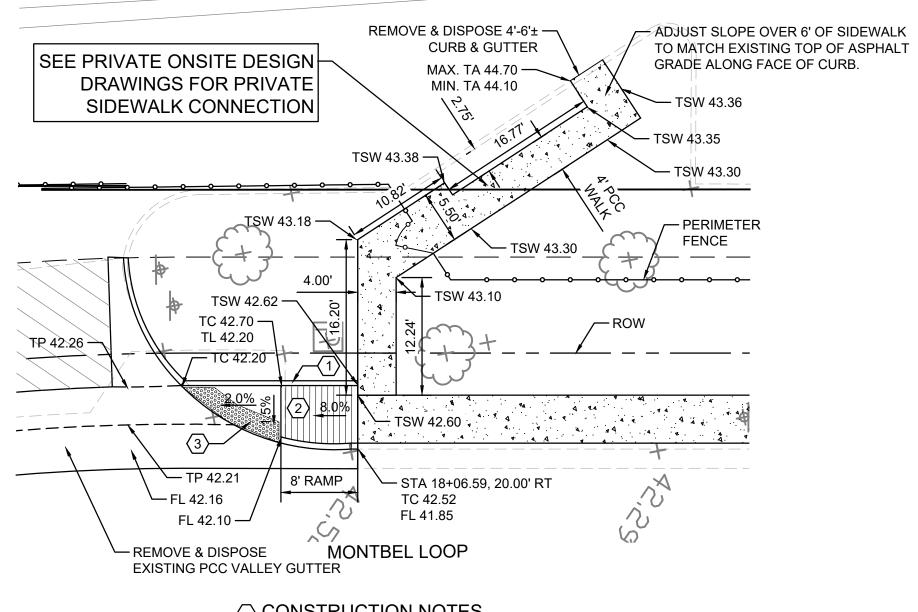


○ CONSTRUCTION NOTES

- 1 INSTALL HEADER CURB TO FULL HEIGHT STD. CURB.
- 2 PCC RAMPS & LANDINGS. 3 TRUNCATED DOMED MATT.

ENTRANCE "C"

SCALE: 1"=10'

CITY APPROVAL STAMP

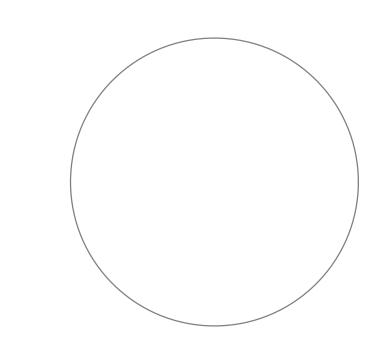







ARCHITECTS

7925 Bosque ST. NW, Albuquerque, NM 87114 Ph. (505) 892-8453 Fax. (505)890-1736


PROJECT: AMRI SITE IMPROVEMENTS 4401 ALEXANDER BOULEVARD, NE ALBUQUERQUE, NEW MEXICO

ENTRANCES B&C LAYOUT & GRADING

NO.	REVISION	DATE
ARCHITECT STAMP	CONSULTANT STAMP	DATE:

1/27/22 PROJECT NO. 2105

SHEET NO.

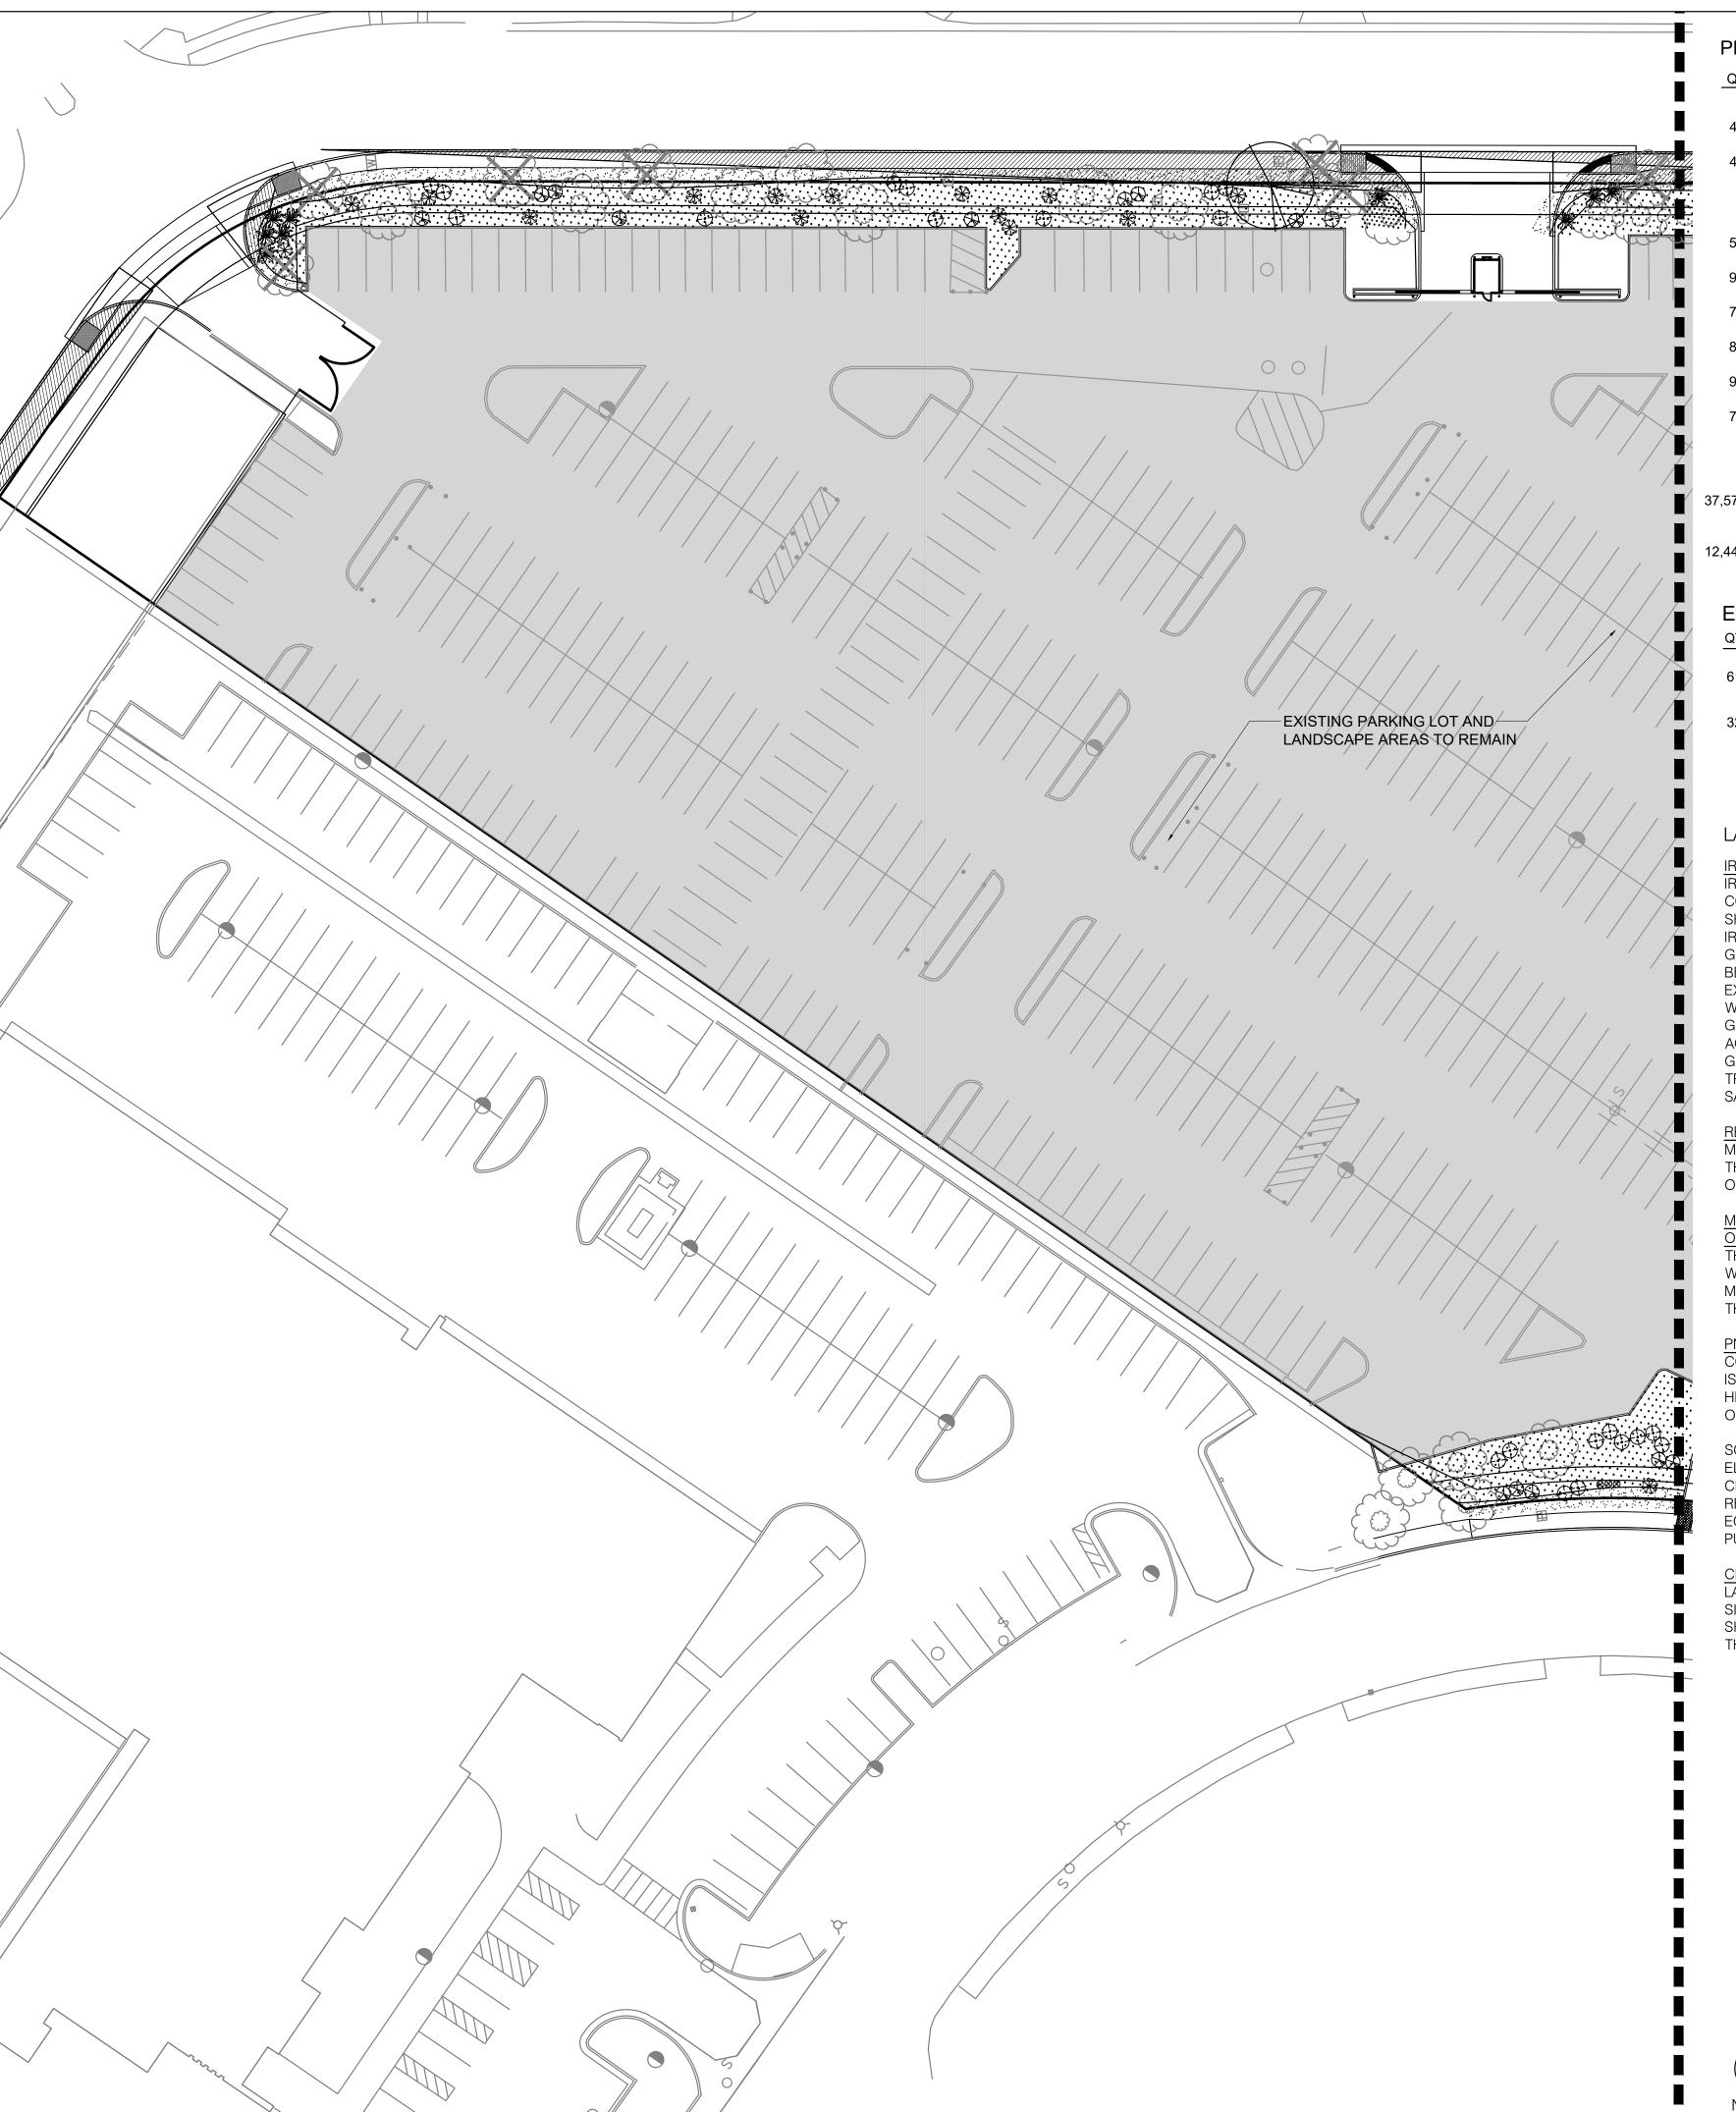

PLANT LEGEND

. SYMBOL	SCIENTIFIC NAME COMMON NAME (WATER USE)	SIZE	MATURE SIZE
	TREES - REFERENCE DETAIL 1-2/L501		
	CHILOPSIS LINEARIS DESERT WILLOW 'BUBBA' (RW)	24"-BOX	20' HT. X 25' SPR.
	PISTACIA CHINENSIS CHINESE PISTACHE (M)	2.5" B&B	40' HT. X 30' SPR

SHRUBS AND GROUNDCOVERS - REFERENCE DETAIL 3-4/L501

			STRUBS AND GROUNDCOVERS - REFER	ENCE DE LA	IL 3-4/L501
5	66	•	UPRIGHT GERMANDER TEUCRIUM CHAMAEDRYS (L)	1-GAL	2' HT. X 2' SPR.
9	2	\bigcirc	CYTISUS X PRAECOX 'ALLGOLD' ALL GOLD SCOTCH BROOM (L)	5-GAL	5' HT. X 5' SPR.
7	'8		FALLUGIA PARADOXA APACHE PLUME (L)	5-GAL	5' HT. X 5' SPR.
8	85	*	JUNIPERUS HORIZONTALIS 'BLUE CHIP' BLUE CHIP JUNIPER (M)	5-GAL	8" HT. X 8' SPR.
9	06	\oplus	NANDINA DOMESTICA 'MONFAR' SIENNA SUNRISE HEAVENLY BAMBOO (M	5-GAL M)	3' HT. X 2' SPR.
7	'3	\bigotimes	BUDDLEJA DAVIDII 'NANHO BLUE' BUDDLEIA NANHO BLUE	5-GAL	5' HT. X 5' SPR.

MULCHES

1" AMARETTO BROWN CRUSHED GRAVEL MULCH AT 3" DEPTH OVER FILTER FABRIC

2"-4" COYOTE MIST COBBLE AT 4" DEPTH OVER FILTER FABRIC 12,444 SF AT HEADER CURBS OR SLOPES GREATER THAN 4:1 PLACE 4-8" COYOTE MIST COBBLE AT 8" DEPTH OVER FILTER FABRIC

EXISTING LANDSCAPE LEGEND

QTY. SYMBOL DESCRIPTION

EXISTING TREES TO REMAIN WITHIN IMPROVEMENT AREA (AVERAGE SPREAD 25' FOR CALCULATIONS)

EXISTING TREE TO BE REMOVED (DUE TO HEALTH OR LOCATION)

EXISTING BUILDING, SITE AND LANDSCAPE TO REMAIN (EXISTING IRRIGATION TO REMAIN AND MUST BE PROVIDED TO EXISTING LANDSCAPE AREAS TO REMAIN)

LANDSCAPE NOTES AND CALCULATIONS

IRRIGATION SYSTEM STANDARDS OUTLINED IN THE WATER CONSERVATION LANDSCAPING AND WATER WASTE ORDINANCE SHALL BE STRICTLY ADHERED TO. A FULLY AUTOMATED IRRIGATION SYSTEM WILL BE USED TO IRRIGATE TREE, SHRUB AND GROUNDCOVER PLANTING AREAS. THE IRRIGATION SYSTEM SHALL BE DESIGNED TO ISOLATE PLANT MATERIAL ACCORDING TO SOLAR EXPOSURE AND WILL BE SET UP BY PLANT ZONES ACCORDING TO WATER REQUIREMENTS. THE TREES WILL BE PROVIDED WITH (6) 2 GPH EMITTERS, WITH THE ABILITY TO BE EXPANDED TO ACCOMMODATE THE GROWTH OF THE TREE. SHRUBS AND GROUNDCOVERS WILL BE PROVIDED WITH (2) 1 GPH EMITTERS. TREES, SHRUBS AND GROUNDCOVERS WILL BE GROUPED ON THE SAME VALVE.

RESPONSIBILITY OF MAINTENANCE

MAINTENANCE OF ALL PLANTING AND IRRIGATION, INCLUDING THOSE WITHIN THE PUBLIC R.O.W., SHALL BE THE RESPONSIBILITY OF THE PROPERTY OWNER.

METHOD FOR COMPLYING WITH WATER CONSERVATION

THE PLANT PALETTE IS PREDOMINANTLY COMPRISED OF PLANTS WITH LOW TO MEDIUM WATER USE REQUIREMENTS, THEREBY MINIMIZING IRRIGATION NEEDS WHILE ENSURING THE VIABILITY OF THE PLANTS.

PNM COORDINATION

COORDINATION WITH PNM'S NEW SERVICE DELIVERY DEPARTMENT IS NECESSARY REGARDING PROPOSED TREE LOCATION AND HEIGHT, SIGN LOCATION AND HEIGHT, AND LIGHTING HEIGHT IN ORDER TO ENSURE SUFFICIENT SAFETY CLEARANCES.

SCREENING WILL BE DESIGNED TO ALLOW FOR ACCESS TO ELECTRIC UTILITIES. IT IS NECESSARY TO PROVIDE ADEQUATE CLEARANCE OF TEN FEET IN FRONT AND AT LEAST 5 FEET ON THE REMAINING THREE SIDES SURROUNDING ALL GROUND-MOUNTED EQUIPMENT FOR SAFE OPERATION, MAINTENANCE AND REPAIR PURPOSES.

CLEAR SIGHT DISTANCE:

LANDSCAPING AND SIGNAGE WILL NOT INTERFERE WITH CLEAR SIGHT REQUIREMENTS. THEREFORE, SIGNS, WALLS, TREES, AND SHRUBBERY BETWEEN 3 AND 8 FEET TALL (AS MEASURED FROM THE GUTTER PAN) WILL NOT BE ACCEPTABLE IN THE AREA.

CITY SUBMITTAL NOTES

- 1. THE LANDSCAPE PLAN ON FILE FOR THIS SITE DEVELOPMENT PLAN WAS ILLEGIBLE. THE PLAN CHANGES WILL ONLY ADDRESS REMOVAL OF TREES LOCATED WITHIN THE NEW SIDEWALK IMPROVEMENT AND ALL OTHER EXISTING TREES WILL REMAIN. ALL EXISTING TURF GRASS HAS DIED AND WILL BE REPLACED WITH GRAVEL OR COBBLE OVER FILTER FABRIC. THE EXISTING SPRAY IRRIGATION SYSTEM WILL BE MODIFIED TO A DRIP SYSTEM.
- 2. ADDITIONAL PLANTINGS WILL BE PLACED TO ENHANCE THE EXISTING LANDSCAPE AREAS.

GENERAL NOTES

LANDSCAPE AREA COVERAGE

COVERAGE.

STREET FRONTAGE.

- PROVIDED TREES: 20

- PROVIDED TREES: 11

- PROVIDED TREES: 5

ALEXANDER BLVD - 561 LF

- REQUIRED TREES: 19

- PROVIDED: 20 TREES

LANDSCAPE AREA TO BE RENNOVATED:

LANDSCAPE LIVE VEGETATIVE COVERAGE

(EXCLUDING BUILDING AND PARKING LOTS TO REMAIN)

(SHRUBS, GRASSES, ETC.) OF THE REQUIRED VEGETATIVE

REQUIRED LIVE VEGETATIVE MATERIAL COVERAGE

PROVIDED LIVE VEGETATIVE MATERIAL COVERAGE

STREET TREE REQUIREMENTS SPECIFY THE SPACING BETWEEN STREET TREES, WITHIN THE PUBLIC RIGHT-OF-WAY, SHALL BE

INSTALLED AT A FREQUENCY OF 30 FEET PER LINEAR FOOT OF

MONTBEL LOOP NE: LOCAL - NO STREET TREES REQUIRED

MONTBEL PLACE NE: LOCAL - NO STREET TREES REQUIRED

JOAN HILL PL NE: LOCAL - NO STREET TREES REQUIRED

REQUIRED GROUND-LEVEL PLANT COVERAGE

PROVIDED GROUND-LEVEL PLANT COVERAGE

LANDSCAPE COVERAGE REQUIREMENTS SPECIFY TREE CANOPIES

AND GROUND-LEVEL PLANTS SHALL COVER A MINIMUM OF 75%. A

MINIMUM OF 25% SHALL BE PROVIDED AS GROUND-LEVEL PLANTS

- 1. PRIOR TO BEGINNING WORK ON THE PROJECT, THE LANDSCAPE CONTRACTOR SHALL REVIEW THE PROJECT IN THE FIELD WITH THE OWNER'S REPRESENTATIVE. IF DISCREPANCIES OCCUR BETWEEN THE DRAWINGS AND THE SITE, THE LANDSCAPE CONTRACTOR SHALL NOTIFY THE OWNER'S REPRESENTATIVE FOR CLARIFICATION PRIOR TO PROCEEDING ON THAT PORTION OF WORK.
- 2. IT IS THE LANDSCAPE CONTRACTOR'S RESPONSIBILITY TO LOCATE ALL UNDERGROUND UTILITIES PRIOR TO COMMENCEMENT OF PLANTING OPERATIONS.
- 3. ALL PLANTING AREAS ARE TO HAVE WEEDS AND COMPETITIVE VEGETATION REMOVED PRIOR TO
- PREPARATION FOR PLANTING. 4. THE OWNER'S REPRESENTATIVE SHALL APPROVE ALL PLANT MATERIAL PRIOR TO PLANTING. IN ADDITION, THE OWNER REPRESENTATIVE RESERVES THE RIGHT TO REFUSE ANY PLANT MATERIAL DEEMED UNACCEPTABLE. THE OWNER'S REPRESENTATIVE IS
- TO APPROVE ANY AND ALL SUBSTITUTIONS. 5. FILTER FABRIC TO BE DEWITT PRO-5 WEED CONTROL, OR EQUAL.

50,018 SF

37,514 SF

44,253 SF

9,378 SF

9,510 SF

6. PLANT QUANTITIES ARE PROVIDED FOR CONTRACTOR'S CONVENIENCE ONLY, PLANS SHALL TAKE PRECEDENCE.



Planning / Landscape Architecture

302 Eighth Street NW

Albuquerque, NM 87102 (505) 764-9801 Fax 842-5495 e-mail:cp@consensusplanning.com

CONSULTANTS

AMRI PUBLIC SIDEWALKS IMPROVEMENTS ALBUQUERQUE, NM

DECEMBER 15 2021


	DECEMBER 10, 2021			
SUB	SUBMITTAL: AA			
REV	REVISIONS			
NO.	DATE	DESCRIPTION		
Λ	3-23-2022	ADD SIGHT TRIANGLES		
PROJECT NO: XXXX				
CAD DWG FILE:				
DESIGNED BY: KP				
DRAWN BY: KP				
CHE	CHECKED BY: CG			

LANDSCAPE PLAN

DRAWING SHEET

SHEET TITLE



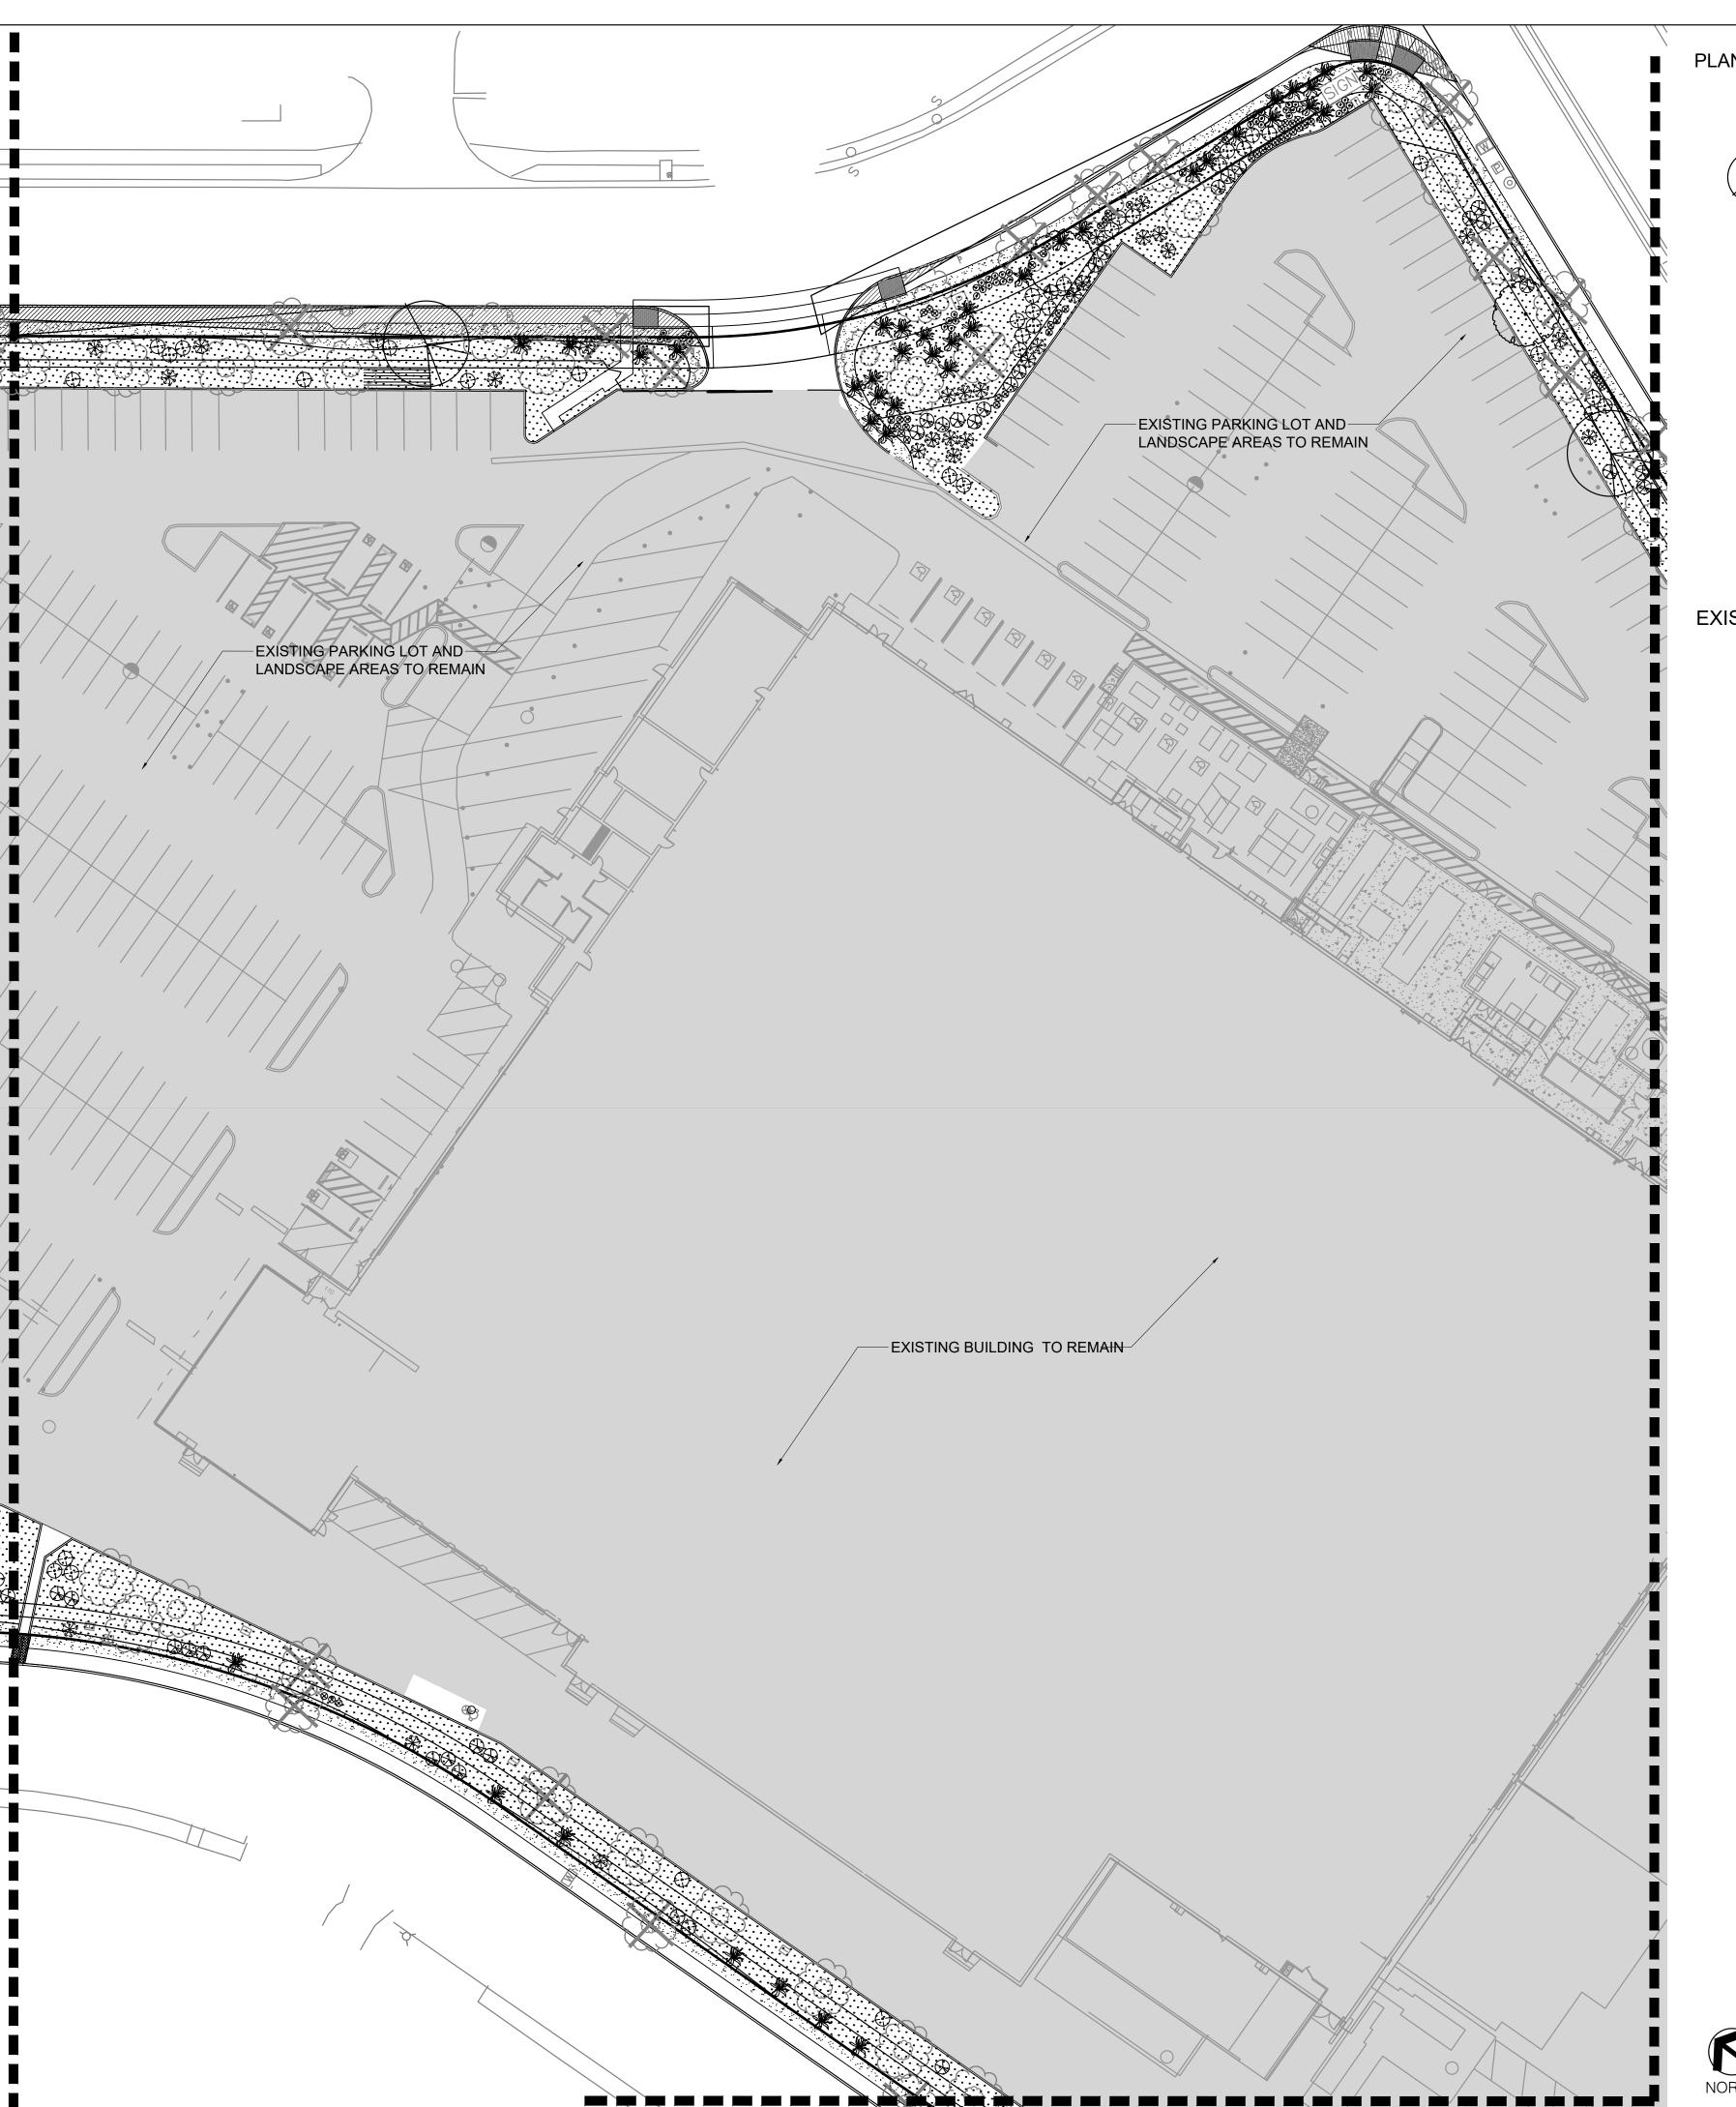

PLANT LEGEND

SCIENTIFIC NAME
COMMON NAME (WATER USE)

SIZE
MATURE SIZE

TREES - REFERENCE DETAIL 1-2/L501

CHILOPSIS LINEARIS
DESERT WILLOW 'BUBBA' (RW)

PISTACIA CHINENSIS
CHINESE PISTACHE (M)

SIZE
MATURE SIZE

24"-BOX 20' HT. X 25' SPR.

2.5" B&B 40' HT. X 30' SPR.

SHRUBS AND GROUNDCOVERS - REFERENCE DETAIL 3-4/L501

● UPRIGHT GERMANDER TEUCRIUM CHAMAEDRYS (L)

CYTISUS X PRAECOX 'ALLGOLD' 5-GAL 5' HT. X 5' SPR. ALL GOLD SCOTCH BROOM (L)

FALLUGIA PARADOXA 5-GAL 5' HT. X 5' SPR. APACHE PLUME (L)

JUNIPERUS HORIZONTALIS 'BLUE CHIP' 5-GAL 8" HT. X 8' SPR. BLUE CHIP JUNIPER (M)

NANDINA DOMESTICA 'MONFAR' 5-GAL 3' HT. X 2' SPR. SIENNA SUNRISE HEAVENLY BAMBOO (M)

BUDDLEJA DAVIDII 'NANHO BLUE' 5-GAL 5' HT. X 5' SPR.

MULCHES

1" AMARETTO BROWN CRUSHED GRAVEL MULCH AT 3" DEPTH OVER FILTER FABRIC




2"-4" COYOTE MIST COBBLE AT 4" DEPTH OVER FILTER FABRIC
AT HEADER CURBS OR SLOPES GREATER THAN 4:1 PLACE 4-8"
COYOTE MIST COBBLE AT 8" DEPTH OVER FILTER FABRIC

EXISTING LANDSCAPE LEGEND

SYMBOL DESCRIPTION



EXISTING TREES TO REMAIN WITHIN IMPROVEMENT AREA (AVERAGE SPREAD 25' FOR CALCULATIONS)

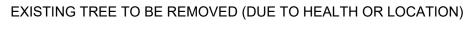

EXISTING BUILDING, SITE AND LANDSCAPE TO REMAIN
(EXISTING IRRIGATION TO REMAIN AND MUST BE PROVIDED TO EXISTING LANDSCAPE AREAS TO REMAIN)

CITY SUBMITTAL NOTES

- 1. THE LANDSCAPE PLAN ON FILE FOR THIS SITE DEVELOPMENT PLAN WAS ILLEGIBLE. THE PLAN CHANGES WILL ONLY ADDRESS REMOVAL OF TREES LOCATED WITHIN THE NEW SIDEWALK IMPROVEMENT AND ALL OTHER EXISTING TREES WILL REMAIN. ALL EXISTING TURF GRASS HAS DIED AND WILL BE REPLACED WITH GRAVEL OR COBBLE OVER FILTER FABRIC. THE EXISTING SPRAY IRRIGATION SYSTEM WILL BE MODIFIED TO A DRIP SYSTEM.
- 2. ADDITIONAL PLANTINGS WILL BE PLACED TO ENHANCE THE EXISTING LANDSCAPE AREAS.

GENERAL NOTES

- 1. PRIOR TO BEGINNING WORK ON THE PROJECT, THE LANDSCAPE CONTRACTOR SHALL REVIEW THE PROJECT IN THE FIELD WITH THE OWNER'S REPRESENTATIVE. IF DISCREPANCIES OCCUR BETWEEN THE DRAWINGS AND THE SITE, THE LANDSCAPE CONTRACTOR SHALL NOTIFY THE OWNER'S REPRESENTATIVE FOR CLARIFICATION PRIOR TO PROCEEDING ON THAT PORTION OF WORK.
- 2. IT IS THE LANDSCAPE CONTRACTOR'S
 RESPONSIBILITY TO LOCATE ALL UNDERGROUND
 UTILITIES PRIOR TO COMMENCEMENT OF PLANTING
 OPERATIONS.
- 3. ALL PLANTING AREAS ARE TO HAVE WEEDS AND COMPETITIVE VEGETATION REMOVED PRIOR TO PREPARATION FOR PLANTING.
- 4. THE OWNER'S REPRESENTATIVE SHALL APPROVE ALL PLANT MATERIAL PRIOR TO PLANTING. IN ADDITION, THE OWNER REPRESENTATIVE RESERVES THE RIGHT TO REFUSE ANY PLANT MATERIAL DEEMED UNACCEPTABLE. THE OWNER'S REPRESENTATIVE IS TO APPROVE ANY AND ALL SUBSTITUTIONS.
- 5. FILTER FABRIC TO BE DEWITT PRO-5 WEED CONTROL, OR EQUAL.
- 6. PLANT QUANTITIES ARE PROVIDED FOR CONTRACTOR'S CONVENIENCE ONLY, PLANS SHALL TAKE PRECEDENCE.



CONSENSUS

Planning / Landscape Architecture
302 Eighth Street NW
Albuquerque, NM 87102
(505) 764-9801 Fax 842-5495
e-mail:cp@consensusplanning.com

CONSULTANTS



AMRI PUBLIC SIDEWALKS IMPROVEMENTS ALBUQUERQUE, NM


DECEMBER 15, 2021

SUB	SUBMITTAL: AA			
REV	REVISIONS			
NO.	D. DATE DESCRIPTION			
1	3-23-2022	ADD SIGHT TRIANGLES		
PRO	PROJECT NO: XXXX			
CAD	CAD DWG FILE:			
DESI	DESIGNED BY: KP			
DRA	DRAWN BY: KP			
CHE	CHECKED BY: CG			
SHE	SHEET TITLE			

LANDSCAPE PLAN

DRAWING SHEET



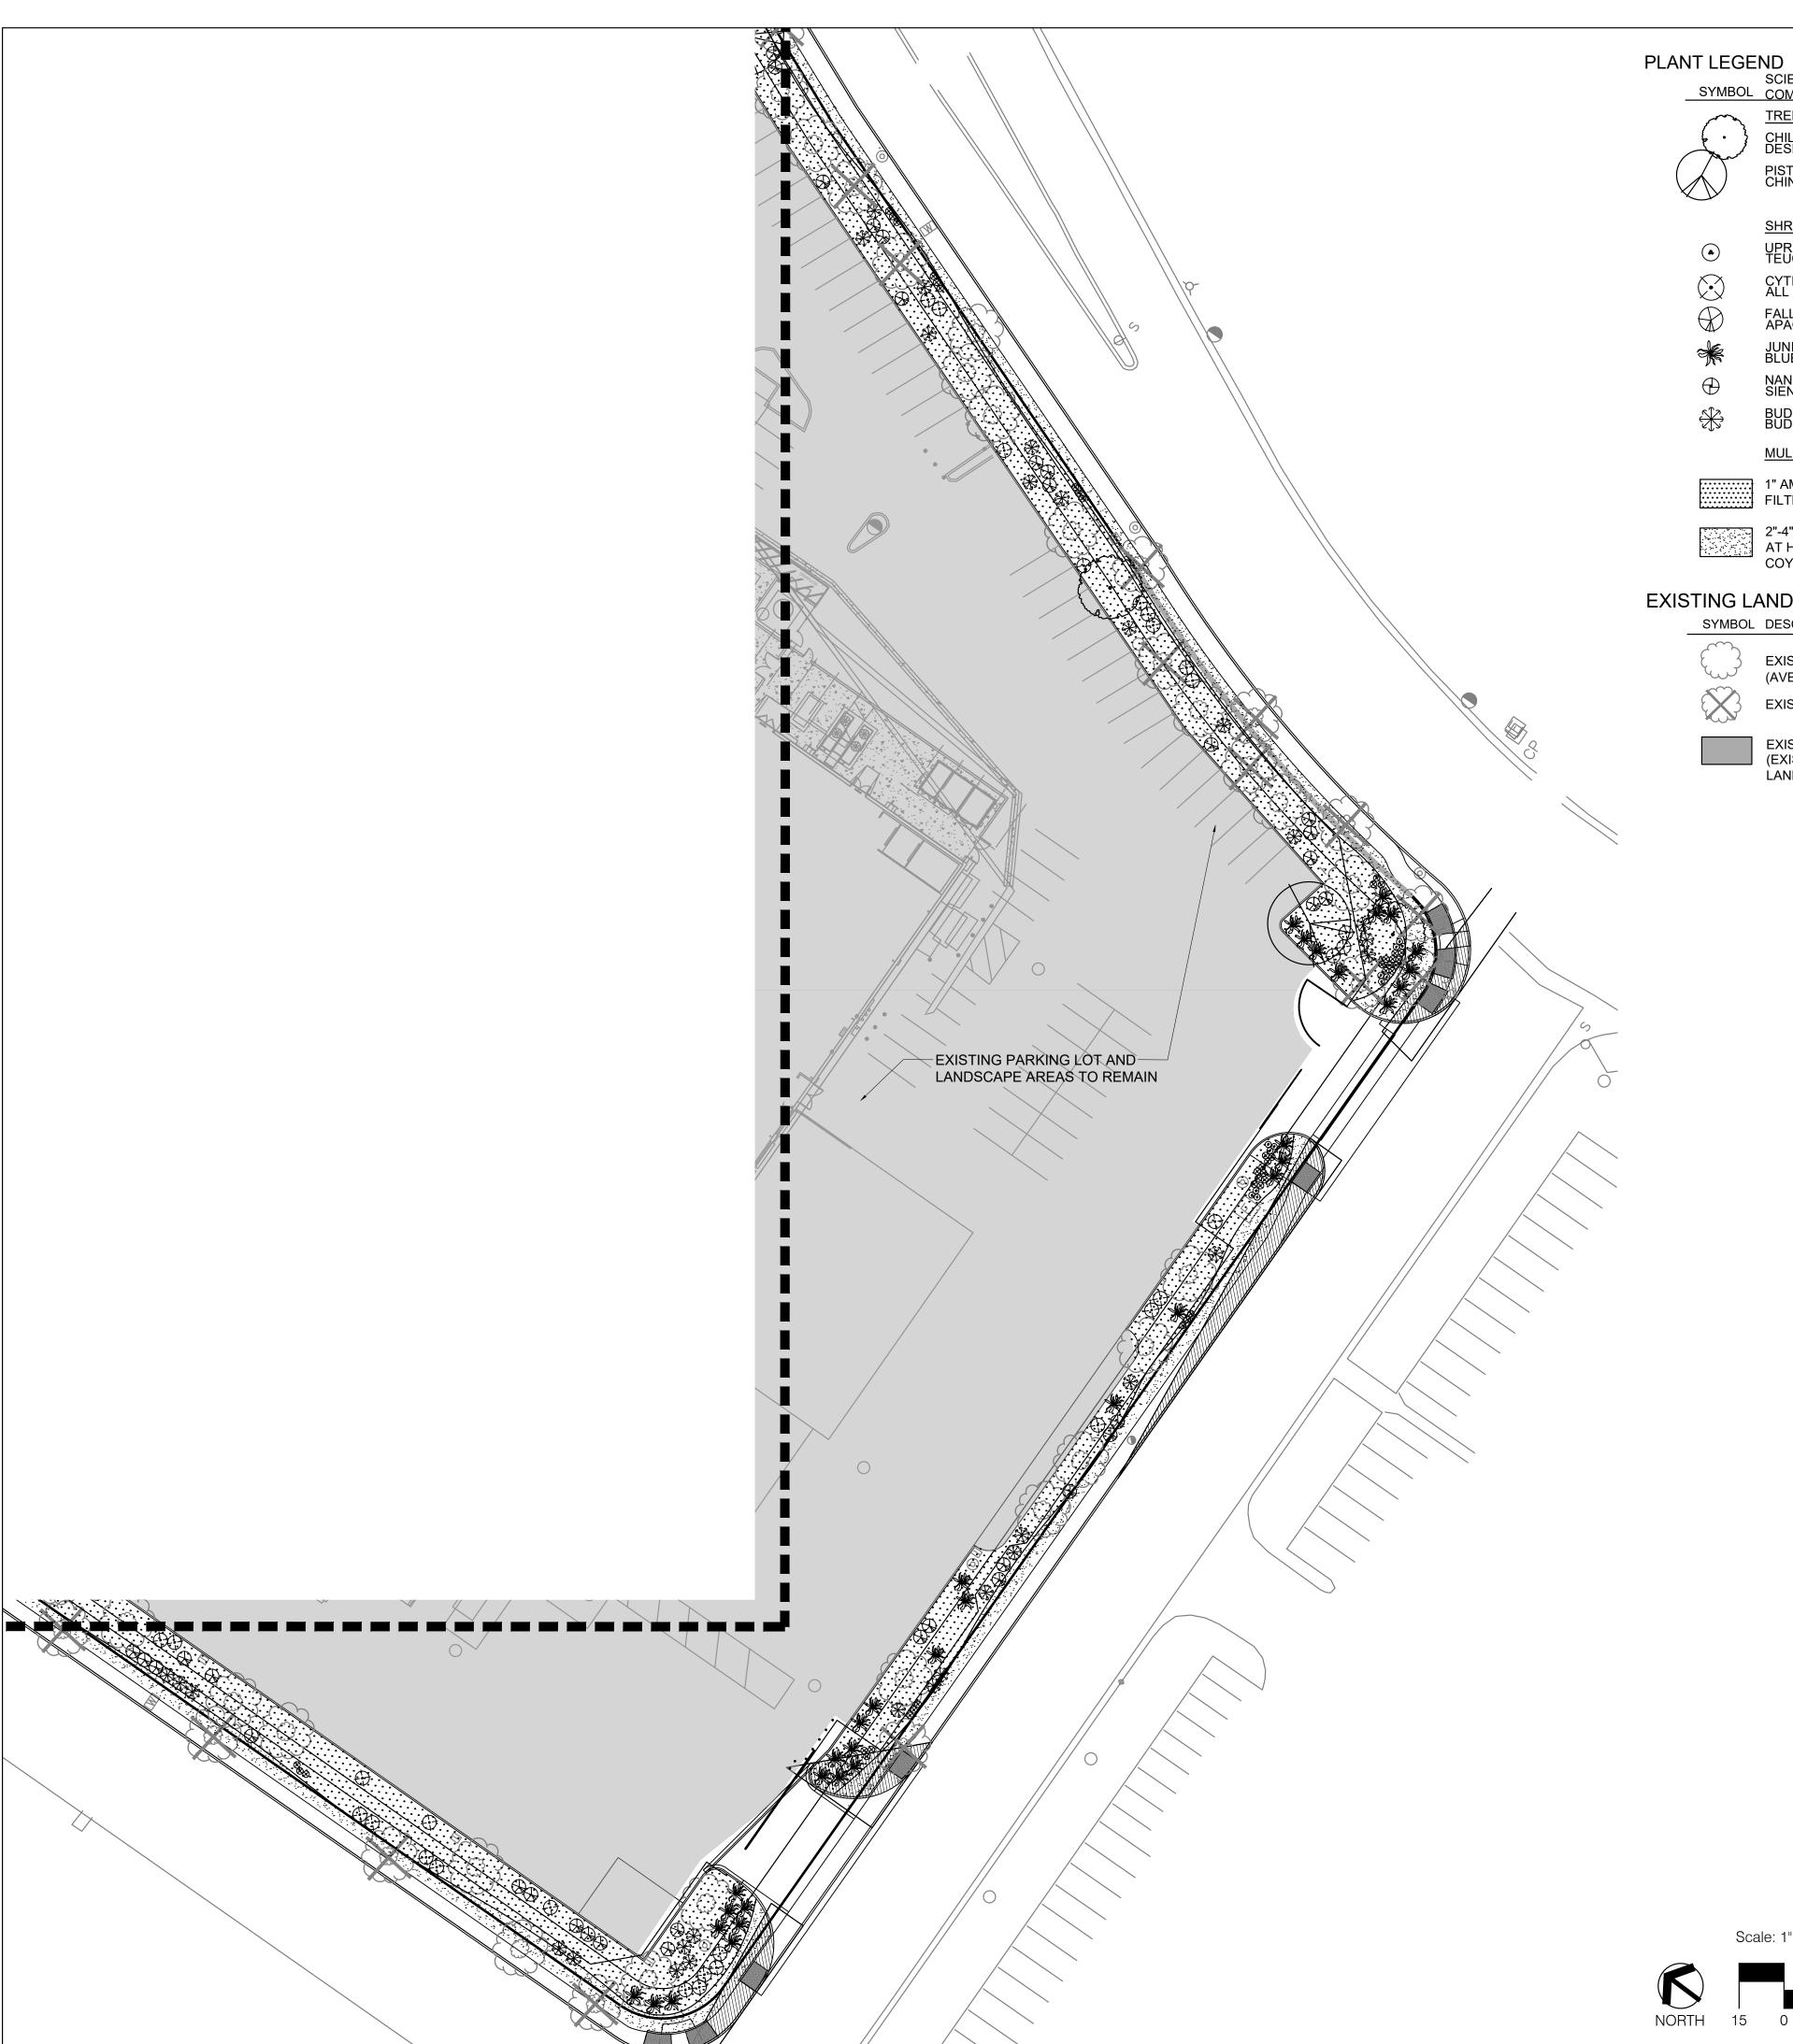

SCIENTIFIC NAME SYMBOL COMMON NAME (WATER USE) SIZE MATURE SIZE TREES - REFERENCE DETAIL 1-2/L501 CHILOPSIS LINEARIS DESERT WILLOW 'BUBBA' (RW) 24"-BOX 20' HT. X 25' SPR. PISTACIA CHINENSIS CHINESE PISTACHE (M) 2.5" B&B 40' HT. X 30' SPR.

SHRUBS AND GROUNDCOVERS - REFERENCE DETAIL 3-4/L501

UPRIGHT GERMANDER TEUCRIUM CHAMAEDRYS (L) 1-GAL 2' HT. X 2' SPR. 5-GAL 5' HT. X 5' SPR. 5-GAL 5' HT. X 5' SPR. JUNIPERUS HORIZONTALIS 'BLUE CHIP' 5-GAL BLUE CHIP JUNIPER (M) 8" HT. X 8' SPR. 3' HT. X 2' SPR. 5-GAL 5' HT. X 5' SPR.

<u>MULCHES</u>

1" AMARETTO BROWN CRUSHED GRAVEL MULCH AT 3" DEPTH OVER FILTER FABRIC

2"-4" COYOTE MIST COBBLE AT 4" DEPTH OVER FILTER FABRIC AT HEADER CURBS OR SLOPES GREATER THAN 4:1 PLACE 4-8" COYOTE MIST COBBLE AT 8" DEPTH OVER FILTER FABRIC

EXISTING LANDSCAPE LEGEND

SYMBOL DESCRIPTION

EXISTING TREES TO REMAIN WITHIN IMPROVEMENT AREA (AVERAGE SPREAD 25' FOR CALCULATIONS)

EXISTING TREE TO BE REMOVED (DUE TO HEALTH OR LOCATION) EXISTING BUILDING, SITE AND LANDSCAPE TO REMAIN

(EXISTING IRRIGATION TO REMAIN AND MUST BE PROVIDED TO EXISTING LANDSCAPE AREAS TO REMAIN)

CITY SUBMITTAL NOTES

- 1. THE LANDSCAPE PLAN ON FILE FOR THIS SITE DEVELOPMENT PLAN WAS ILLEGIBLE. THE PLAN CHANGES WILL ONLY ADDRESS REMOVAL OF TREES LOCATED WITHIN THE NEW SIDEWALK IMPROVEMENT AND ALL OTHER EXISTING TREES WILL REMAIN. ALL EXISTING TURF GRASS HAS DIED AND WILL BE REPLACED WITH GRAVEL OR COBBLE OVER FILTER FABRIC. THE EXISTING SPRAY IRRIGATION SYSTEM WILL BE MODIFIED TO A DRIP SYSTEM.
- 2. ADDITIONAL PLANTINGS WILL BE PLACED TO ENHANCE THE EXISTING LANDSCAPE AREAS.

GENERAL NOTES

- 1. PRIOR TO BEGINNING WORK ON THE PROJECT, THE LANDSCAPE CONTRACTOR SHALL REVIEW THE PROJECT IN THE FIELD WITH THE OWNER'S REPRESENTATIVE. IF DISCREPANCIES OCCUR BETWEEN THE DRAWINGS AND THE SITE, THE LANDSCAPE CONTRACTOR SHALL NOTIFY THE OWNER'S REPRESENTATIVE FOR CLARIFICATION PRIOR TO PROCEEDING ON THAT PORTION OF WORK.
- 2. IT IS THE LANDSCAPE CONTRACTOR'S RESPONSIBILITY TO LOCATE ALL UNDERGROUND UTILITIES PRIOR TO COMMENCEMENT OF PLANTING OPERATIONS.
- 3. ALL PLANTING AREAS ARE TO HAVE WEEDS AND COMPETITIVE VEGETATION REMOVED PRIOR TO PREPARATION FOR PLANTING.
- 4. THE OWNER'S REPRESENTATIVE SHALL APPROVE ALL PLANT MATERIAL PRIOR TO PLANTING. IN ADDITION, THE OWNER REPRESENTATIVE RESERVES THE RIGHT TO REFUSE ANY PLANT MATERIAL DEEMED UNACCEPTABLE. THE OWNER'S REPRESENTATIVE IS TO APPROVE ANY AND ALL SUBSTITUTIONS.
- 5. FILTER FABRIC TO BE DEWITT PRO-5 WEED CONTROL, OR EQUAL.
- 6. PLANT QUANTITIES ARE PROVIDED FOR CONTRACTOR'S CONVENIENCE ONLY, PLANS SHALL TAKE PRECEDENCE.



Planning / Landscape Architecture 302 Eighth Street NW Albuquerque, NM 87102 (505) 764-9801 Fax 842-5495 e-mail:cp@consensusplanning.com

CONSULTANTS




AMRI PUBLIC SIDEWALKS IMPROVEMENTS ALBUQUERQUE, NM

DECEMBER 15, 2021


	SUBMITTAL: AA			
	REV	REVISIONS		
	NO.	DATE	DESCRIPTION	
	1	3-23-2022	ADD SIGHT TRIANGLES	
	PROJECT NO: XXXX			
	CAD DWG FILE:			
	DESIGNED BY: KP DRAWN BY: KP CHECKED BY: CG			
	SHEET TITLE			

LANDSCAPE PLAN

DRAWING SHEET

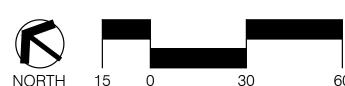

- STRESS POINT OF TREE
- 2. 8' OR 10' LODGEPOLE STAKES DRIVEN AT ANGLE (8' FOR MULTI OR CANOPY, 10' FOR TALL COLUMNAR) 3. 5/8" BLACK POLY TUBING, 12"-15" LONG MIN., NOTCH
- BACKSIDE OF POLY TUBING 4. #10 PLASTIC COATED GUYWIRE - (WRAP TWICE
- AROUND STAKE)
- 5. PLANT TREE ROOT COLLAR 1"-2" ABOVE FINISH GRADE
- 6. WATER RETENTION BASIN 3" DEPTH SHREDDED BARK MULCH. THE WATER RETENTION BASIN SHALL BE TWICE THE PLANTING PIT DIAMETER. THE EDGES OF THE WATER RETENTION BASIN SHALL BE SMOOTHLY FORMED WITH NO OBTRUSIVE EDGES
- 7. 3" LAYER OF ROCK MULCH SEE PLANTING PLAN 8. ROOTBALL WITH REMOVE ROPE AND BURLAP AFTER
- PLANTING 9. SPECIFIED PLANTING MIX - WATER AND TAMP TO

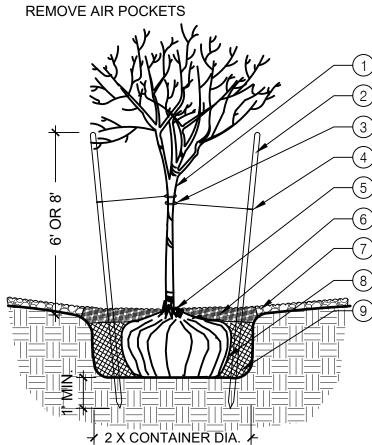


TREE PLANTING

STRESS POINT OF TREE

- 2. 8' OR 10' LODGEPOLE STAKES DRIVEN AT ANGLE (8' FOR MULTI OR CANOPY, 10' FOR TALL COLUMNAR)
- 3. 5/8" BLACK POLY TUBING, 12"-15" LONG MIN., NOTCH BACKSIDE OF POLY TUBING
- 4. #10 PLASTIC COATED GUYWIRE (WRAP TWICE AROUND STAKE)
- 5. PLANT TREE ROOT COLLAR 1"-2" ABOVE FINISH
- 6. WATER RETENTION BASIN 3" DEPTH SHREDDED BARK MULCH. THE WATER RETENTION BASIN SHALL BE TWICE THE PLANTING PIT DIAMETER. THE EDGES OF THE WATER RETENTION BASIN SHALL BE
- SMOOTHLY FORMED WITH NO OBTRUSIVE EDGES 7. 3" LAYER OF ROCK MULCH - SEE PLANTING PLAN
- 8. ROOTBALL WITH REMOVE ROPE AND BURLAP AFTER PLANTING
- 9. SPECIFIED PLANTING MIX WATER AND TAMP TO
- REMOVE AIR POCKETS\ (

SCALE: N.T.S.

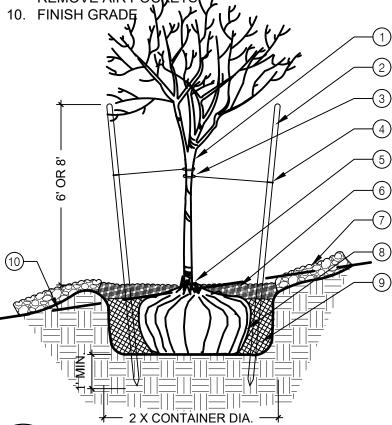


TREE PLANTING ON A SLOPE

1. PLANT TREE ROOT COLLAR 1"-2" ABOVE FINISH GRADE

- 2. WATER RETENTION BASIN 3" LAYER OF SHREDDED BARK MULCH. THE WATER RETENTION BASIN SHALL BE TWICE THE PLANTING PIT DIAMETER. THE EDGES OF THE WATER RETENTION BASIN SHALL BE
- SMOOTHLY FORMED WITH NO OBTRUSIVE EDGES. 3. SPECIFIED PLANTING MIX - WATER AND TAMP TO REMOVE AIR POCKETS
- 4. 3" LAYER OF ROCK MULCH SEE PLANTING PLAN

SCALE: N.T.S.

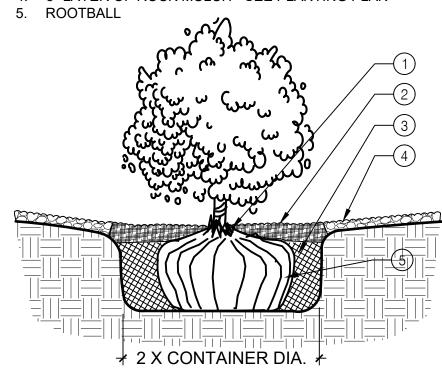


SHRUB PLANTING

1. PLANT TREE ROOT COLLAR 1"-2" ABOVE FINISH GRADE

- 2. 4" WATER RETENTION BASIN 3" LAYER OF SHREDDED BARK MULCH. THE WATER RETENTION BASIN SHALL BE TWICE THE PLANTING PIT DIAMETER. THE EDGES OF THE WATER RETENTION BASIN SHALL BE SMOOTHLY FORMED WITH NO OBTRUSIVE EDGES.
- 3. SPECIFIED PLANTING MIX WATER AND TAMP TO REMOVE AIR POCKETS
- 4. 3" LAYER OF ROCK MULCH SEE PLANTING PLAN
- ROOTBALL

SCALE: N.T.S.

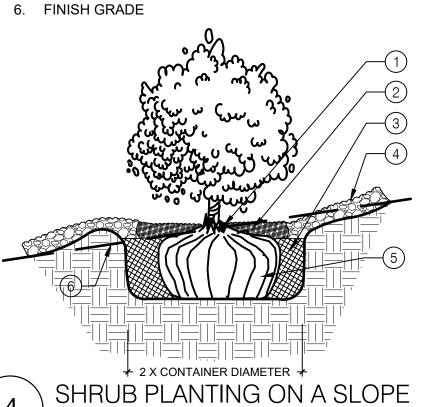

SCALE: N.T.S.

Planning / Landscape Architecture 302 Eighth Street NW Albuquerque, NM 87102 (505) 764-9801 Fax 842-5495 e-mail:cp@consensusplanning.com CONSULTANTS



AMRI PUBLIC SIDEWALKS IMPROVEMENTS ALBUQUERQUE, NM

DECEMBER 15, 2021

	MITTAL	: AA
REV	ISIONS	
NO.	DATE	DESCRIPTION
1	3-23-2022	ADD SIGHT TRIANGLES
PRO	JECT NO:	XXXX
CAD DWG FILE:		
DESIGNED BY: KP		
DRAWN BY: KP		

LANDSCAPE **DETAILS**

DRAWING SHEET

CHECKED BY: CG

SHEET TITLE