CITY OF ALBUQUERQUE

Planning Department Alan Varela, Director



Mayor Timothy M. Keller

April 23, 2024

Joseph A Lavender, RA Burns McDonnell 9400 Ward Pkwy Kansas City, MO 64114

Re: Curia/ New Mexico Expansion 4401 Alexander Blvd. NE Traffic Circulation Layout Architect's Stamp 04-19-24 (F16-D003B1)

Dear Mr. Lavender,

The TCL submittal received 04-12-2024 is approved for Building Permit by Transportation. A copy of the stamped and signed plan will be needed for each of the building permit plans. Please keep the original to be used for certification of the site for final C.O. for Transportation.

PO Box 1293 When the site construction is completed and an inspection for Certificate of Occupancy (C.O.) is requested, use the original City stamped approved TCL for certification. Redline any minor changes and adjustments that were made in the field. A NM registered architect or engineer must stamp, sign, and date the certification TCL along with indicating that the development was built in "substantial compliance" with the TCL. Submit this certification, the TCL, and a completed <u>Drainage and Transportation Information Sheet</u> to front counter personnel for log in and evaluation by Transportation.

NM 87103

Once verification of certification is completed and approved, notification will be made to Building Safety to issue Final C.O. To confirm that a final C.O. has been issued, call Building Safety at 924-3690.


www.cabq.gov

Sincerely,

Ernest Armijo, P.E. Principal Engineer, Planning Dept. Development Review Services

C: CO Clerk, File



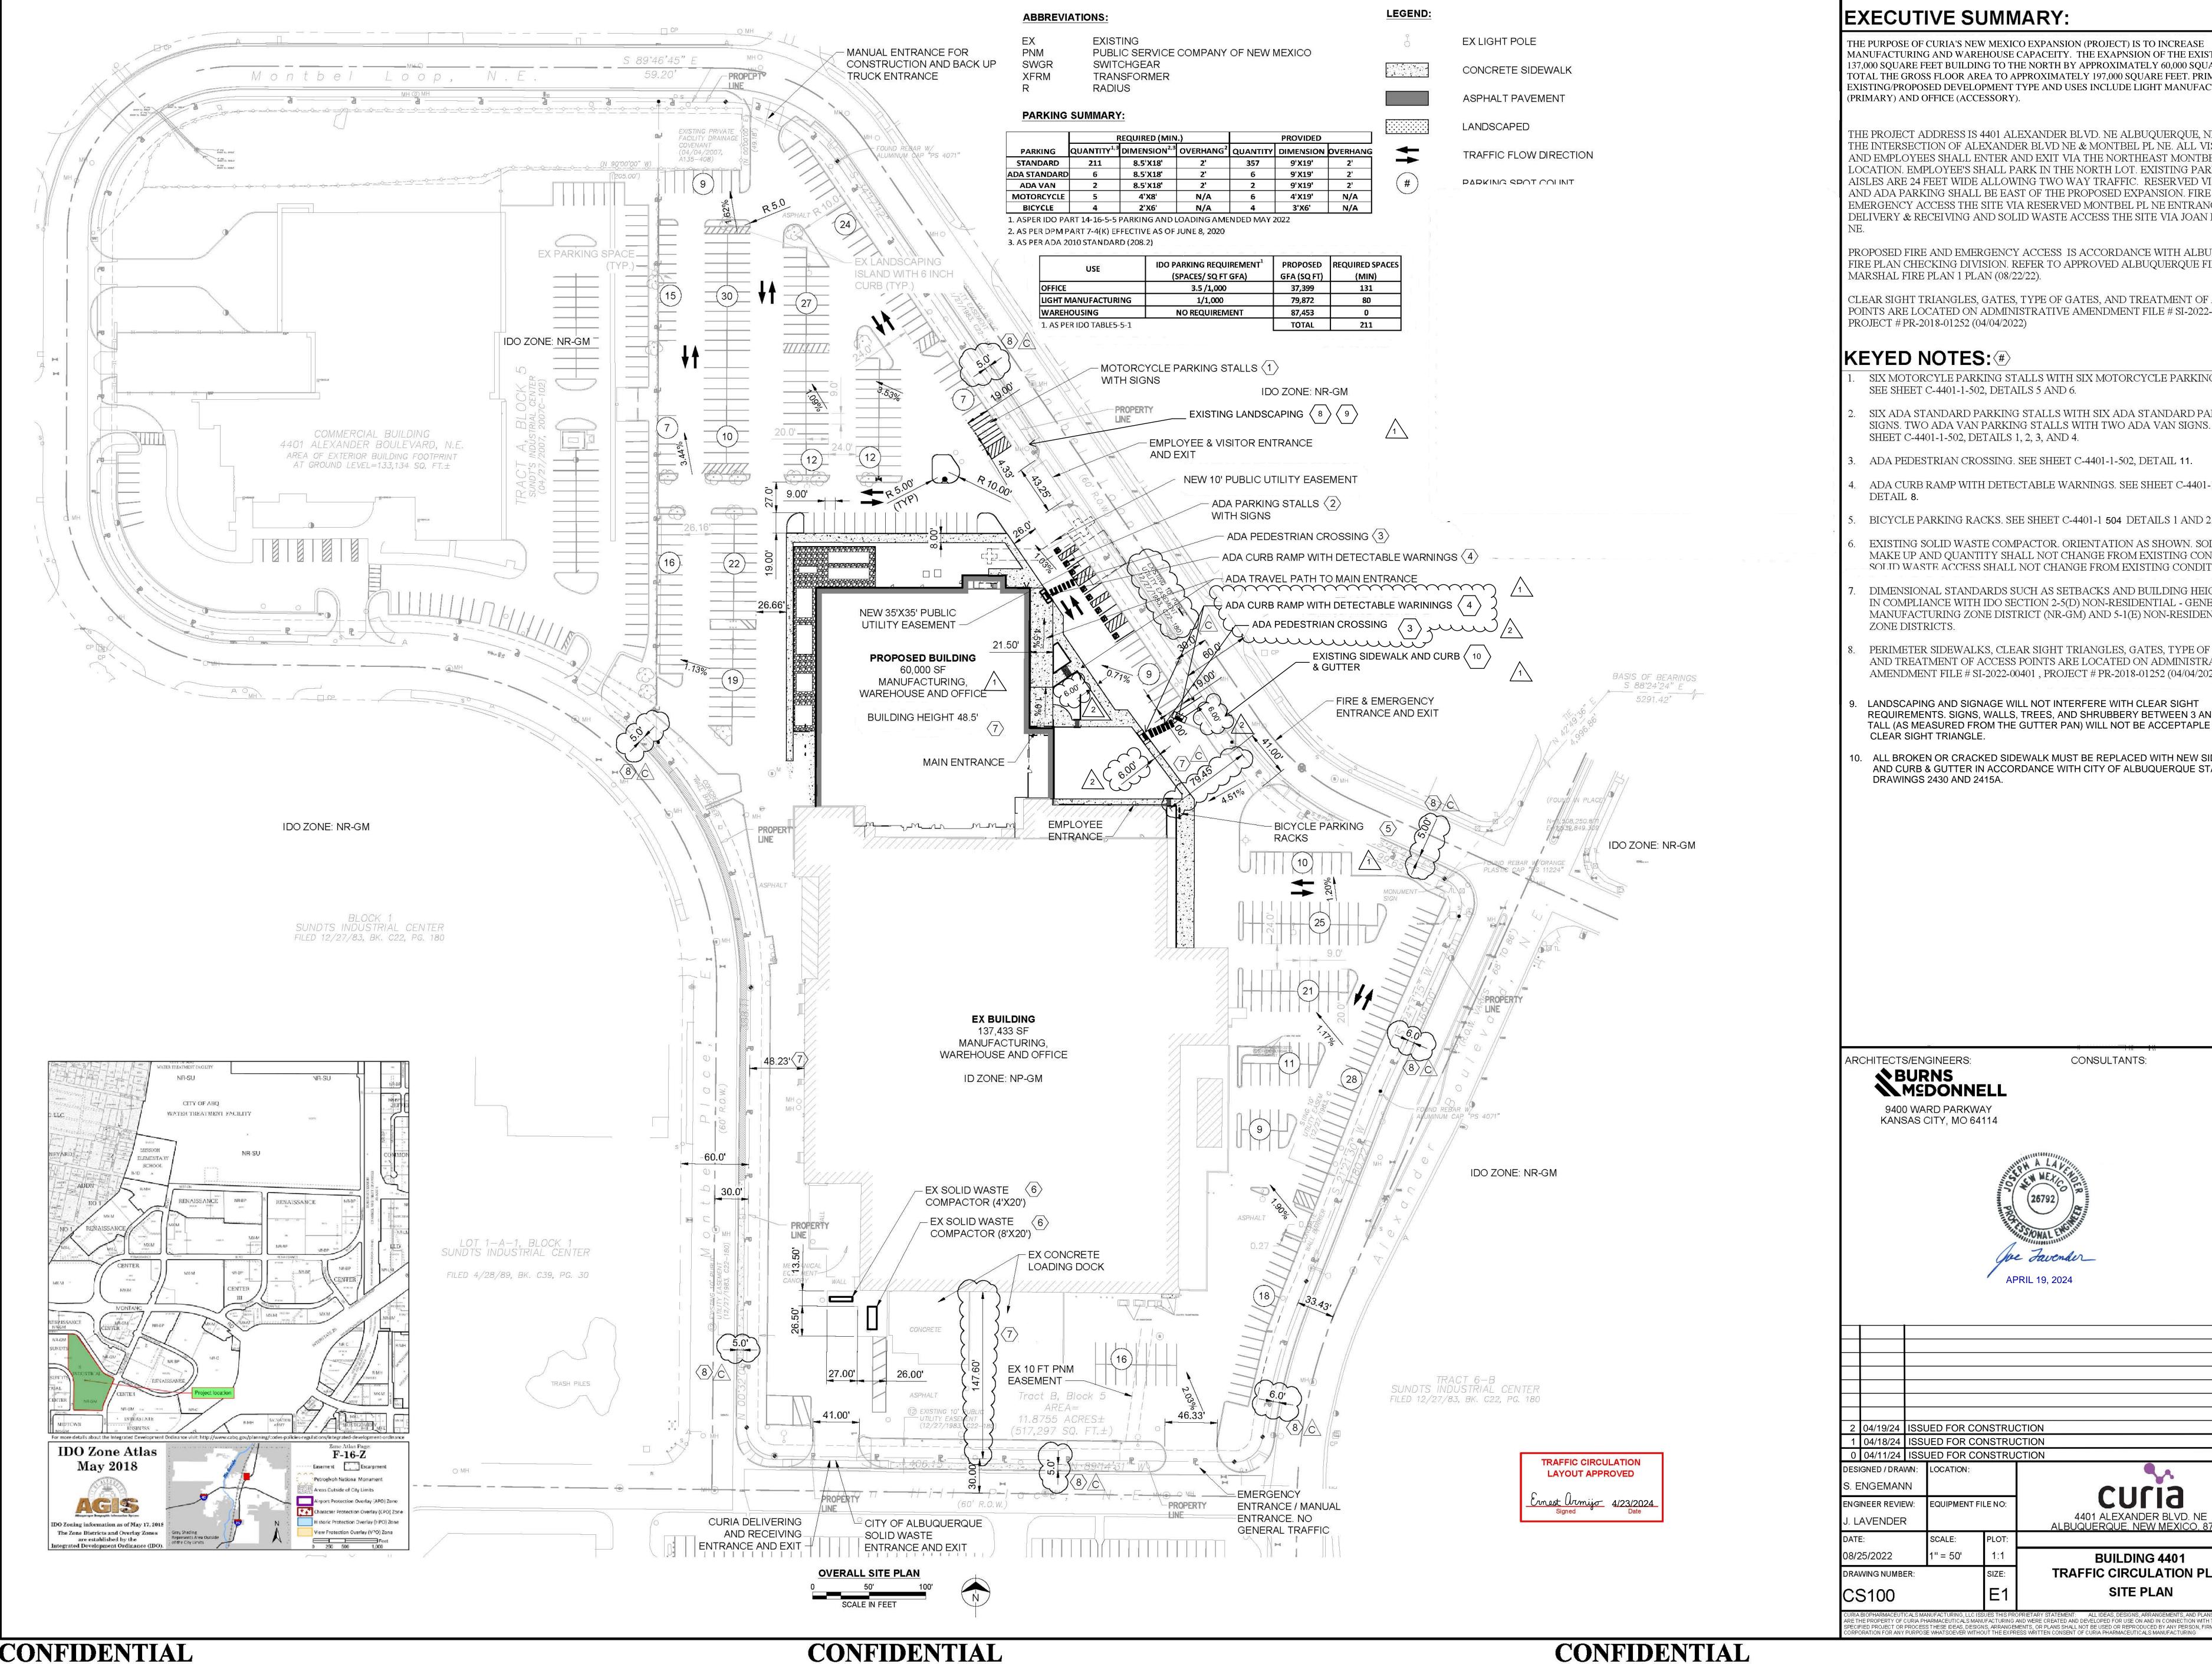

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	REQUIRED (MIN.)			PROVIDED		
PARKING	QUANTITY ^{1,3}	DIMENSION ^{2,3}	OVERHANG ²	QUANTITY	DIMENSION	þ
STANDARD	211	8.5'X18'	2'	357	9'X19'	Γ
ADA STANDARD	6	8.5'X18'	2'	6	9'X19'	
ADA VAN	2	8.5'X18'	2'	2	9'X19'	Γ
MOTORCYCLE	5	4'X8'	N/A	6	4'X19'	
BICYCLE	4	2'X6'	N/A	4	3'X6'	Γ


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MANUFACTURING AND WAREHOUSE CAPACEITY. THE EXAPNSION OF THE EXISTING 37,000 SQUARE FEET BUILDING TO THE NORTH BY APPROXIMATELY 60,000 SQUARE FEET OTAL THE GROSS FLOOR AREA TO APPROXIMATELY 197,000 SQUARE FEET. PRIMARY EXISTING/PROPOSED DEVELOPMENT TYPE AND USES INCLUDE LIGHT MANUFACTURING THE PROJECT ADDRESS IS 4401 ALEXANDER BLVD. NE ALBUQUERQUE, NM 87107 A THE INTERSECTION OF ALEXANDER BLVD NE & MONTBEL PL NE. ALL VISITORS LOCATION. EMPLOYEE'S SHALL PARK IN THE NORTH LOT. EXISTING PARKING AISLES ARE 24 FEET WIDE ALLOWING TWO WAY TRAFFIC. RESERVED VISITOR AND ADA PARKING SHALL BE EAST OF THE PROPOSED EXPANSION. FIRE & EMERGENCY ACCESS THE SITE VIA RESERVED MONTBEL PL NE ENTRANCE DELIVERY & RECEIVING AND SOLID WASTE ACCESS THE SITE VIA JOAN HILL PL PROPOSED FIRE AND EMERGENCY ACCESS IS ACCORDANCE WITH ALBUQUERQUE FIRE PLAN CHECKING DIVISION. REFER TO APPROVED ALBUQUERQUE FIRE CLEAR SIGHT TRIANGLES, GATES, TYPE OF GATES, AND TREATMENT OF ACCESS POINTS ARE LOCATED ON ADMINISTRATIVE AMENDMENT FILE # SI-2022-00401 SIX MOTORCYLE PARKING STALLS WITH SIX MOTORCYCLE PARKING SIGNS SIX ADA STANDARD PARKING STALLS WITH SIX ADA STANDARD PARKING SIGNS. TWO ADA VAN PARKING STALLS WITH TWO ADA VAN SIGNS. SEE ADA CURB RAMP WITH DETECTABLE WARNINGS. SEE SHEET C-4401-1-501, BICYCLE PARKING RACKS. SEE SHEET C-4401-1 504 DETAILS 1 AND 2. EXISTING SOLID WASTE COMPACTOR. ORIENTATION AS SHOWN. SOLID WAST MAKE UP AND QUANTITY SHALL NOT CHANGE FROM EXISTING CONDITIONS. SOLID WASTE ACCESS SHALL NOT CHANGE FROM EXISTING CONDITIONS. DIMENSIONAL STANDARDS SUCH AS SETBACKS AND BUILDING HEIGHT ARE IN COMPLIANCE WITH IDO SECTION 2-5(D) NON-RESIDENTIAL - GENERAL MANUFACTURING ZONE DISTRICT (NR-GM) AND 5-1(E) NON-RESIDENTIAL PERIMETER SIDEWALKS, CLEAR SIGHT TRIANGLES, GATES, TYPE OF GATES. AND TREATMENT OF ACCESS POINTS ARE LOCATED ON ADMINISTRATIVE AMENDMENT FILE # SI-2022-00401, PROJECT # PR-2018-01252 (04/04/2022). REQUIREMENTS. SIGNS, WALLS, TREES, AND SHRUBBERY BETWEEN 3 AND 8 FEET TALL (AS MEASURED FROM THE GUTTER PAN) WILL NOT BE ACCEPTAPLE IN THE 10. ALL BROKEN OR CRACKED SIDEWALK MUST BE REPLACED WITH NEW SIDEWALK AND CURB & GUTTER IN ACCORDANCE WITH CITY OF ALBUQUERQUE STANDARD CONSULTANTS: he Favender APRIL 19, 2024


> SF SE JL curia 4401 ALEXANDER BLVD. NE ALBUQUERQUE, NEW MEXICO, 87109 440 **BUILDING 4401** TRAFFIC CIRCULATION PLAN SITE PLAN

E THE PROPERTY OF CURIA PHARMACEUTICALS MANUFACTURING AND WERE CREATED AND DEVELOPED FOR USE ON AND IN CONNECTION WITH THE ECIFIED PROJECT OR PROCESS THESE IDEAS, DESIGNS, ARRANGEMENTS, OR PLANS SHALL NOT BE USED OR REPRODUCED BY ANY PERSON, FIRM, OR

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NOTES:


1. CONCRETE PAVEMENT SHALL BE IN ACCORDANCE WITH NMDOT PORTLAND CEMENT CONCRETE : SECTION 450

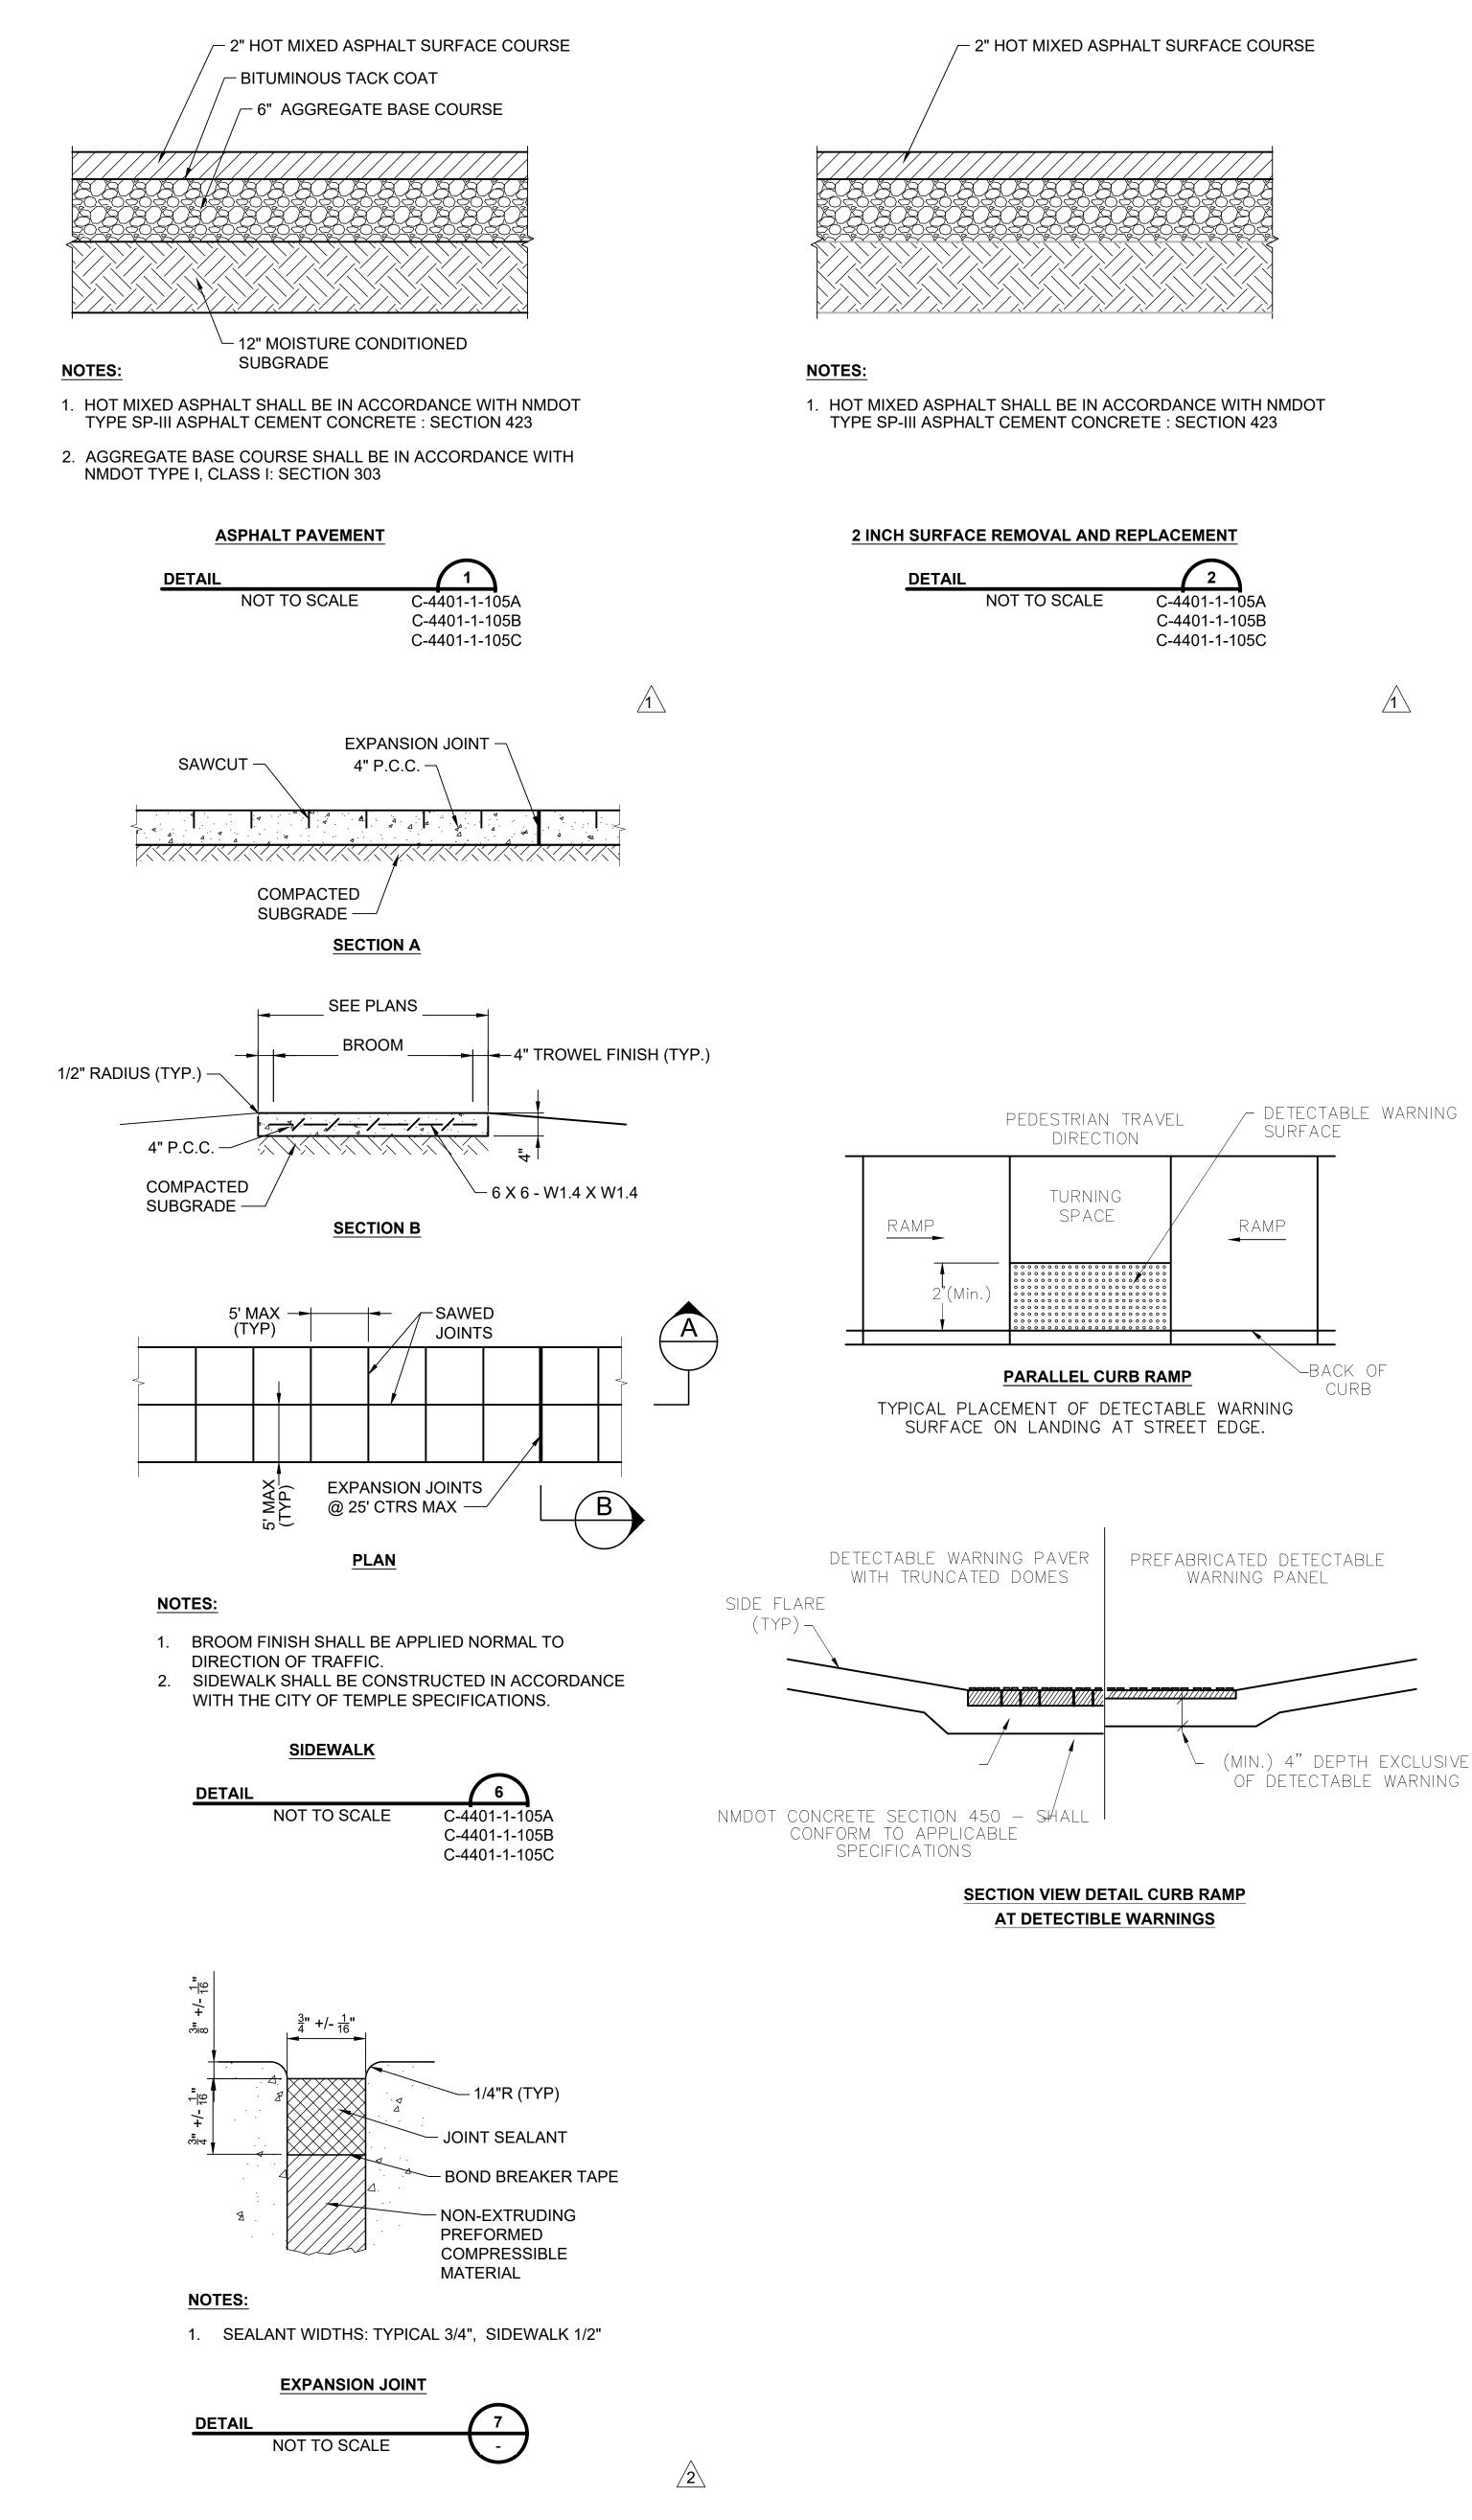SUBGRADE

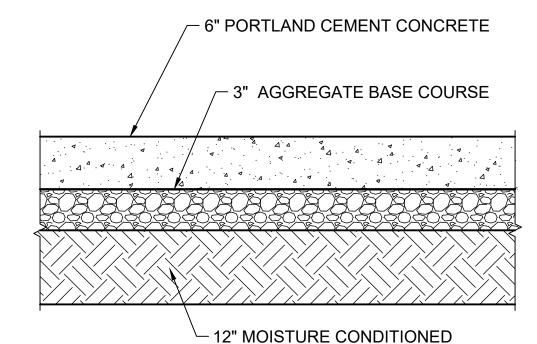2. AGGREGATE BASE COURSE SHALL BE IN ACCORDANCE WITH NMDOT TYPE I, CLASS I: SECTION 303

CONCRETE PAVEMENT

DETAIL

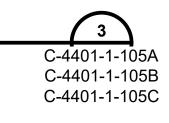


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CURB RAMPS


- 1. INSTALL A CURB RAMP OR BLENDED TRANSITION AT EACH PEDESTRIAN STREET CROSSING.
- 2. ALL SLOPES SHOWN ARE MAXIMUM ALLOWABLE. CROSS SLOPES OF 1.5% AND LESSER RUNNING SHOULD BE USED. ADJUST CURB RAMP LENGTH OR GRADE OF APPROACH SIDEWALKS AS DIRECTED.
- 3. MAXIMUM ALLOWABLE CROSS SLOPE ON SIDEWALK AND CURB RAMP SURFACES IS 2%.
- 4. TURNING SPACES SHALL BE 5'X 5' MINIMUM. CROSS SLOPE SHALL BE MAXIMUM 2%.
- 5. PROVIDE FLARED SIDES WHERE THE PEDESTRIAN CIRCULATION PATH CROSSES THE CURB RAMP. FLARED SIDES SHALL BE SLOPED AT 10% MAXIMUM, MEASURED PARALLEL TO THE CURB. RETURNED CURBS MAY BE USED ONLY WHERE PEDESTRIANS WOULD NOT NORMALLY WALK ACROSS THE RAMP, EITHER BECAUSE THE ADJACENT SURFACE IS PLANTED, SUBSTANTIALLY OBSTRUCTED, OR OTHERWISE PROTECTED.
- 6. ADDITIONAL INFORMATION ON CURB RAMP LOCATION, DESIGN, LIGHT REFLECTIVE VALUE AND TEXTURE MAY BE FOUND IN THE LATEST DRAFT OF THE PROPOSED GUIDELINES FOR PEDESTRIAN FACILITIES IN THE PUBLIC RIGHT OF WAY (PROWAG) AS PUBLISHED BY THE U.S. ARCHITECTURAL AND TRANSPORTATION BARRIERS COMPLIANCE BOARD (ACCESS BOARD).
- 7. CROSSWALK DIMENSIONS AND MARKINGS LOCATIONS SHALL BE AS SHOWN ELSEWHERE IN THE PLANS. AT INTERSECTIONS WHERE CROSSWALK MARKINGS ARE NOT REQUIRED, CURB RAMPS SHALL ALIGN WITH THEORETICAL CROSSWALKS UNLESS OTHERWISE DIRECTED.
- PROVIDE CURB RAMPS TO CONNECT THE PEDESTRIAN ACCESS ROUTE AT EACH PEDESTRIAN STREET CROSSING. HANDRAILS ARE NOT REQUIRED ON CURB RAMPS.
- 9. PLACE CONCRETE AT A MINIMUM DEPTH OF 5" FOR RAMPS, FLARES AND LANDINGS, UNLESS OTHERWISE DIRECTED.
- 10. FURNISH AND INSTALL NO. 3 REINFORCING STEEL BARS AT 18" O.C. BOTH WAYS, UNLESS OTHERWISE DIRECTED.
- 11. PROVIDE A SMOOTH TRANSITION WHERE THE CURB RAMPS CONNECT TO THE STREET.
- 12. EXISTING FEATURES THAT COMPLY WITH APPLICABLE STANDARDS MAY REMAIN IN PLACE UNLESS OTHERWISE SHOWN ON THE PLANS.

DETECTABLE WARNINGS

DETAIL NOT TO SCALE

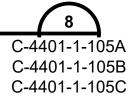


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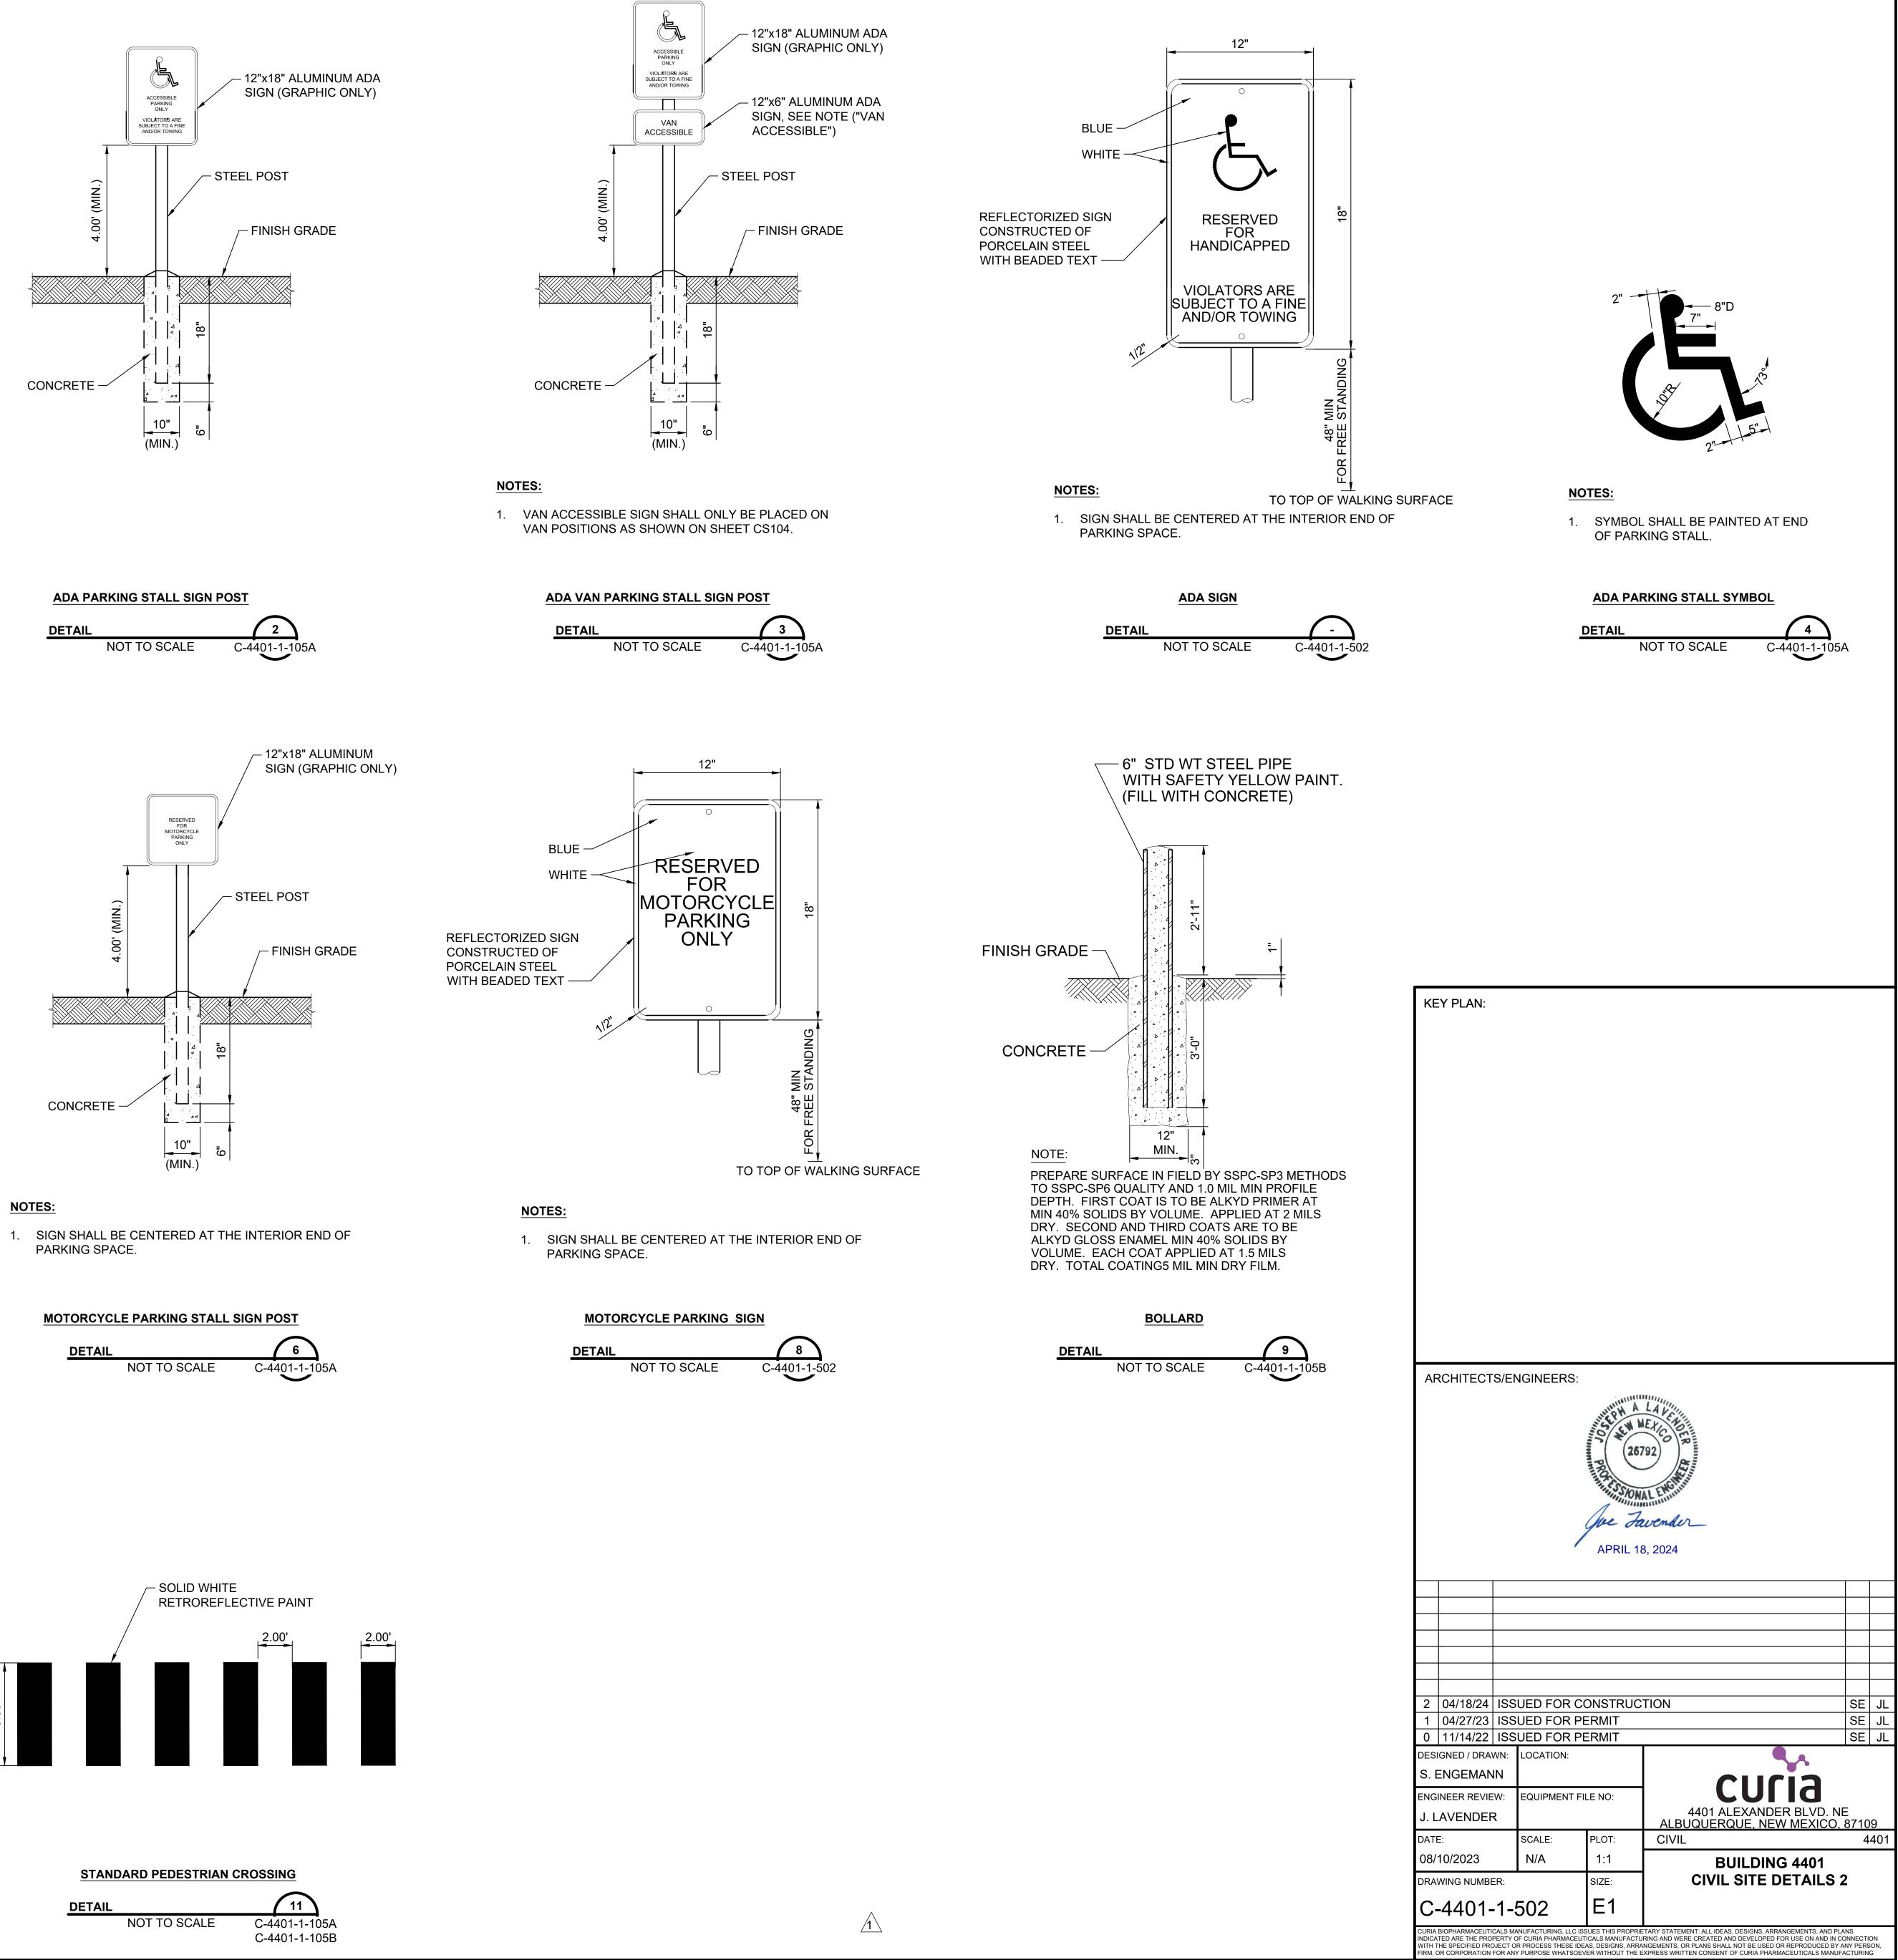


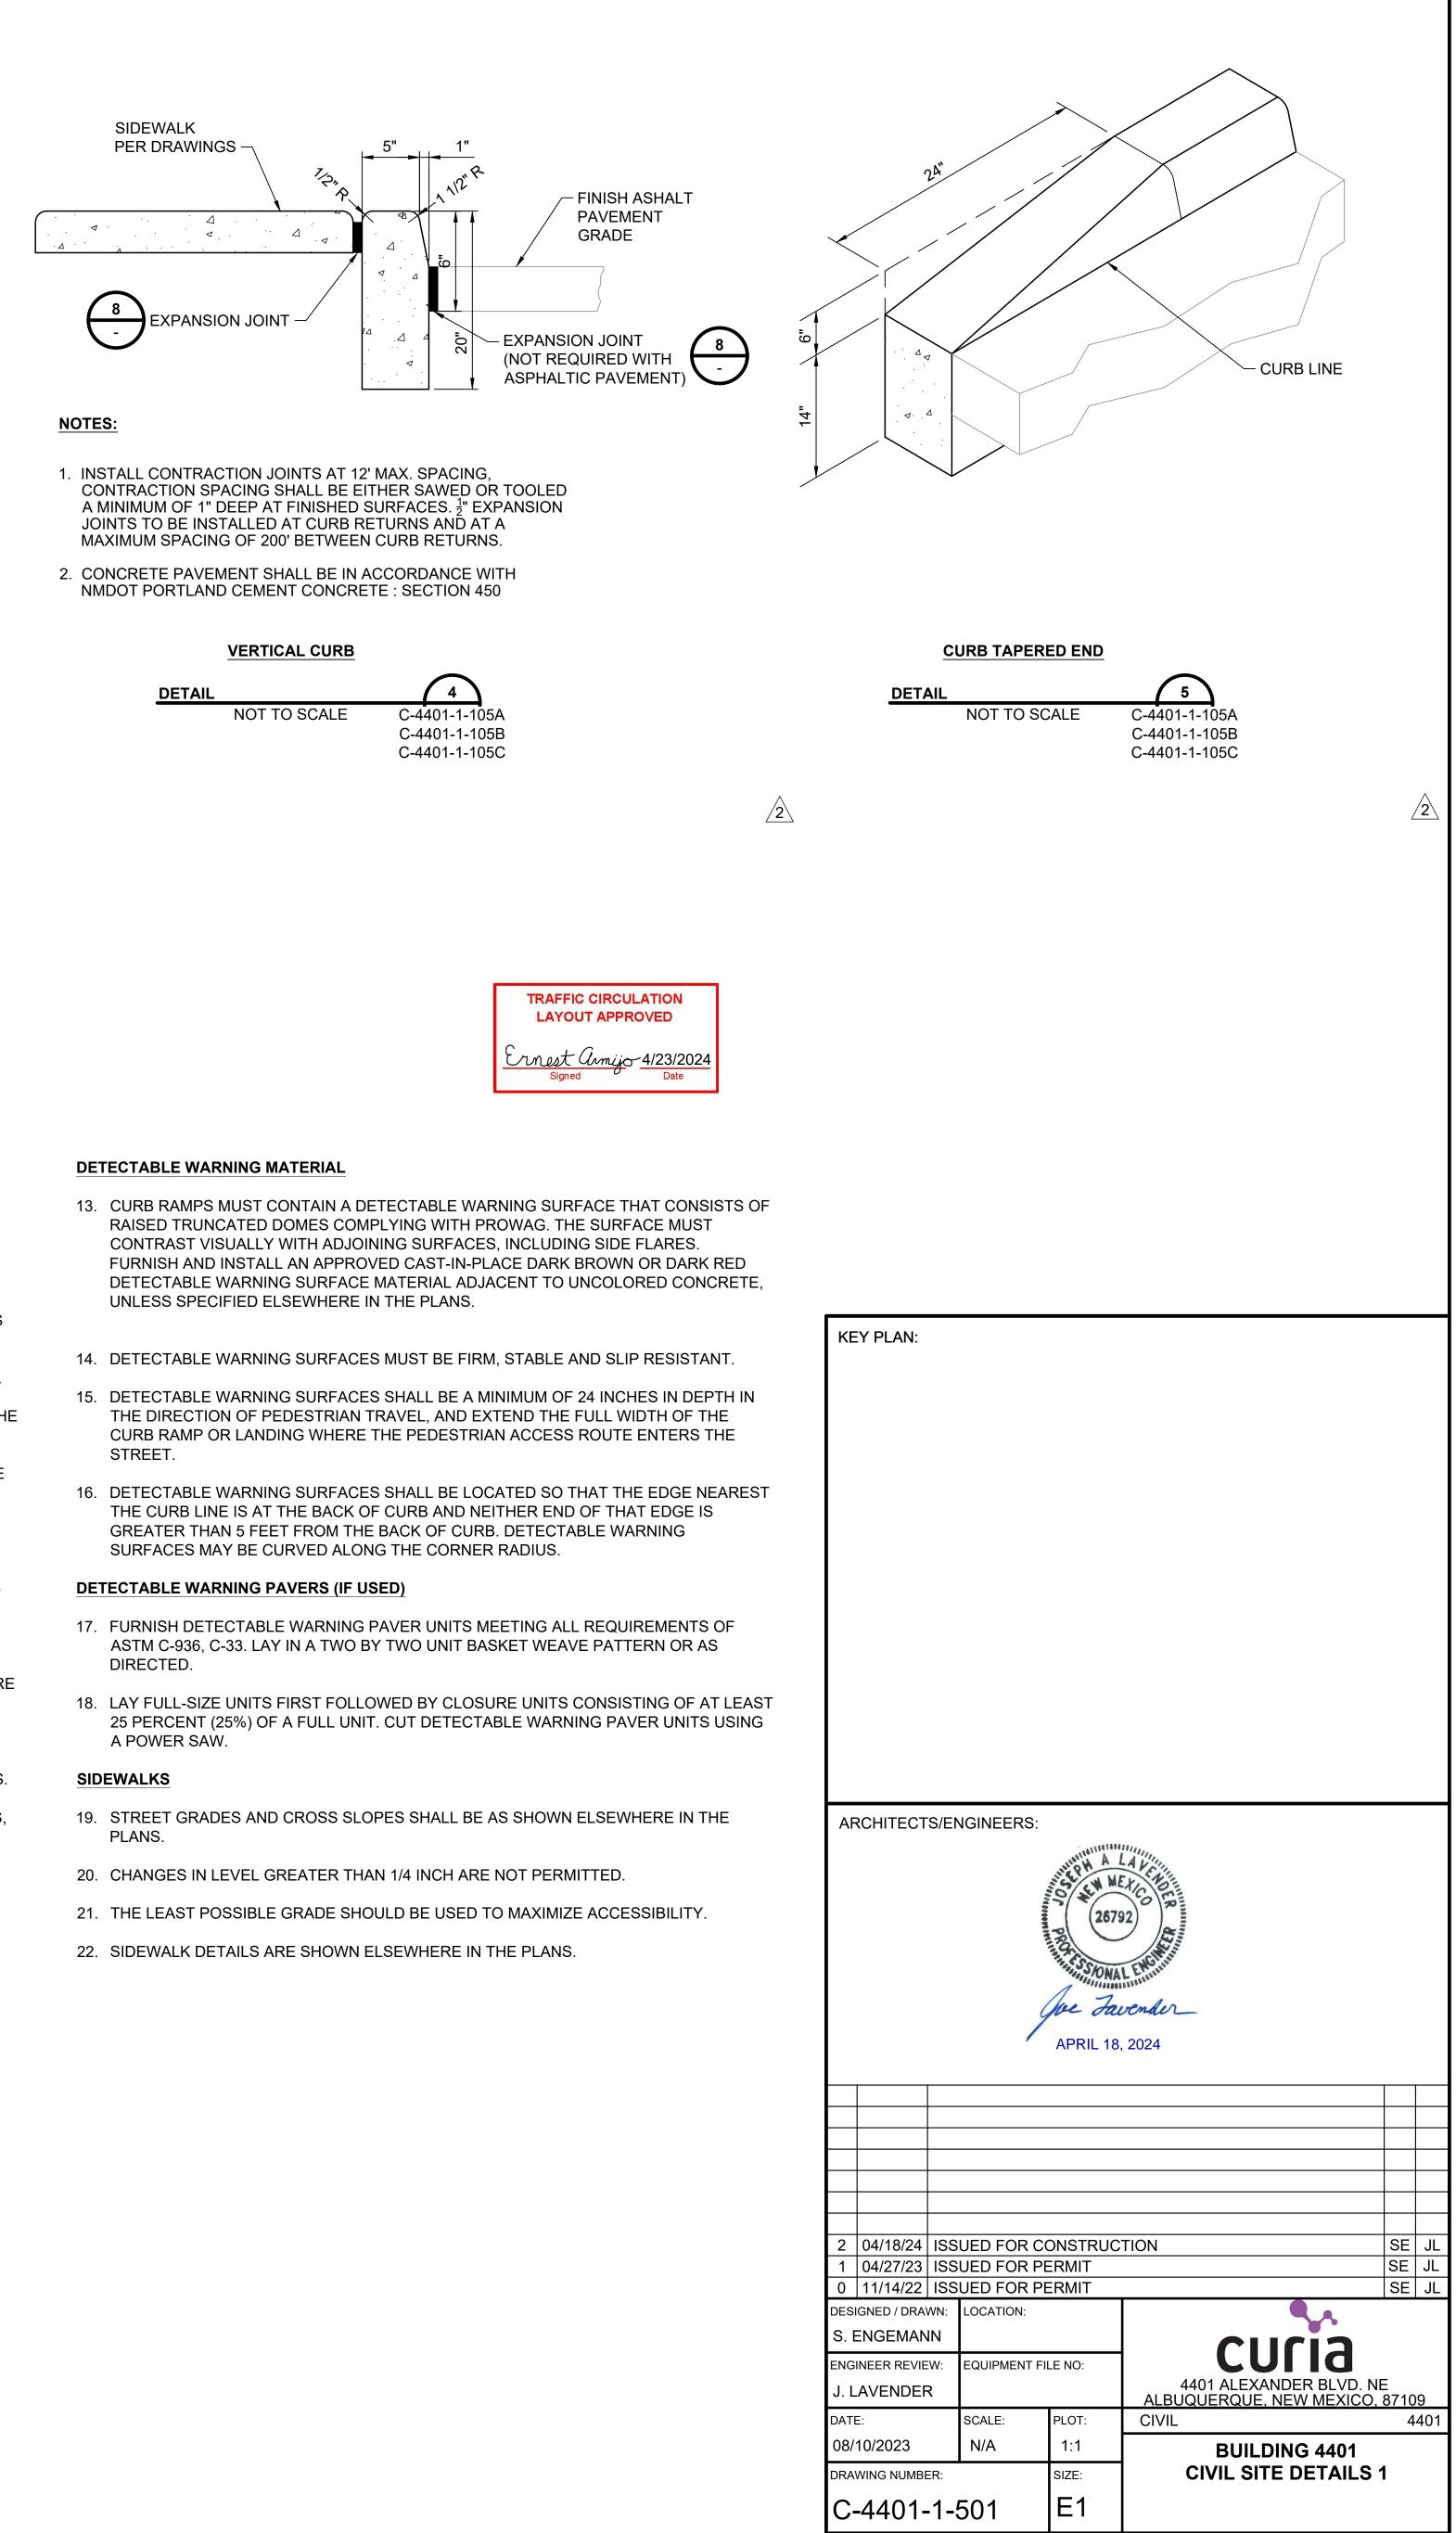
MENT: ALL IDEAS, DESIGNS, ARRANGEMENTS, AND PLA CATED ARE THE PROPERTY OF CURIA PHARMACEUTICALS MANUFACTURING AND WERE CREATED AND DEVELOPED FOR USE ON AND IN CONNECTION WITH THE SPECIFIED PROJECT OR PROCESS THESE IDEAS, DESIGNS, ARRANGEMENTS, OR PLANS SHALL NOT BE USED OR REPRODUCED BY ANY PERSON FIRM, OR CORPORATION FOR ANY PURPOSE WHATSOEVER WITHOUT THE EXPRESS WRITTEN CONSENT OF CURIA PHARMACEUTICALS MANUFACTURING


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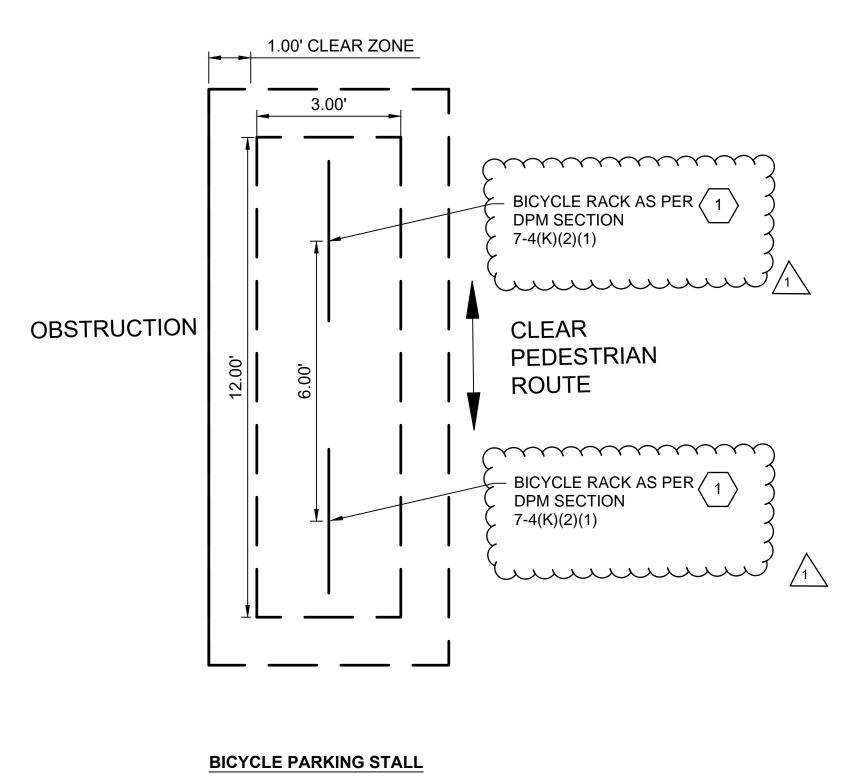




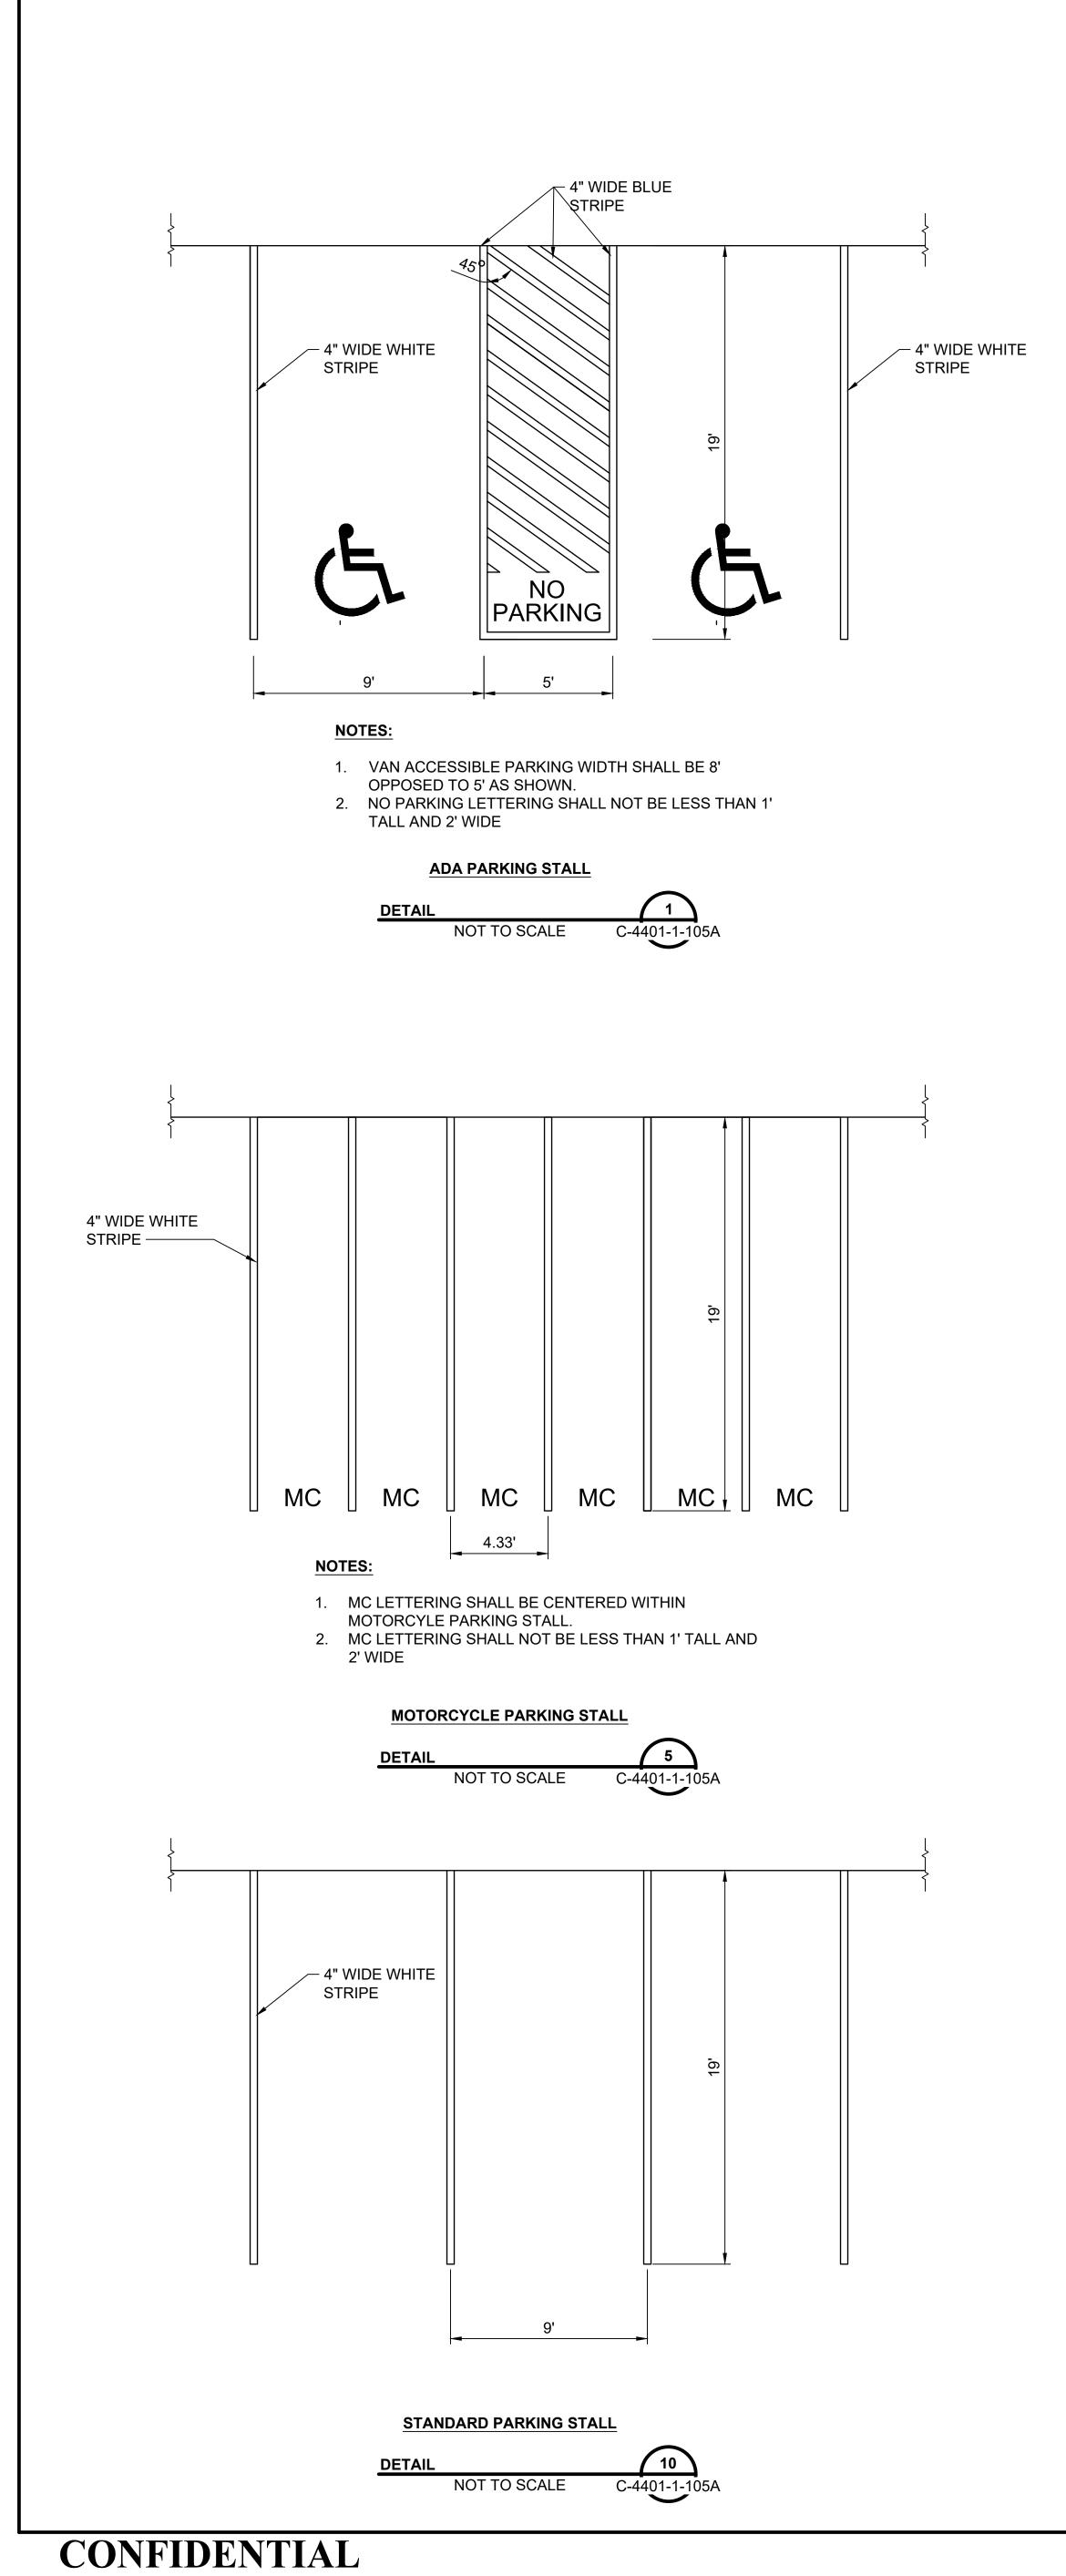

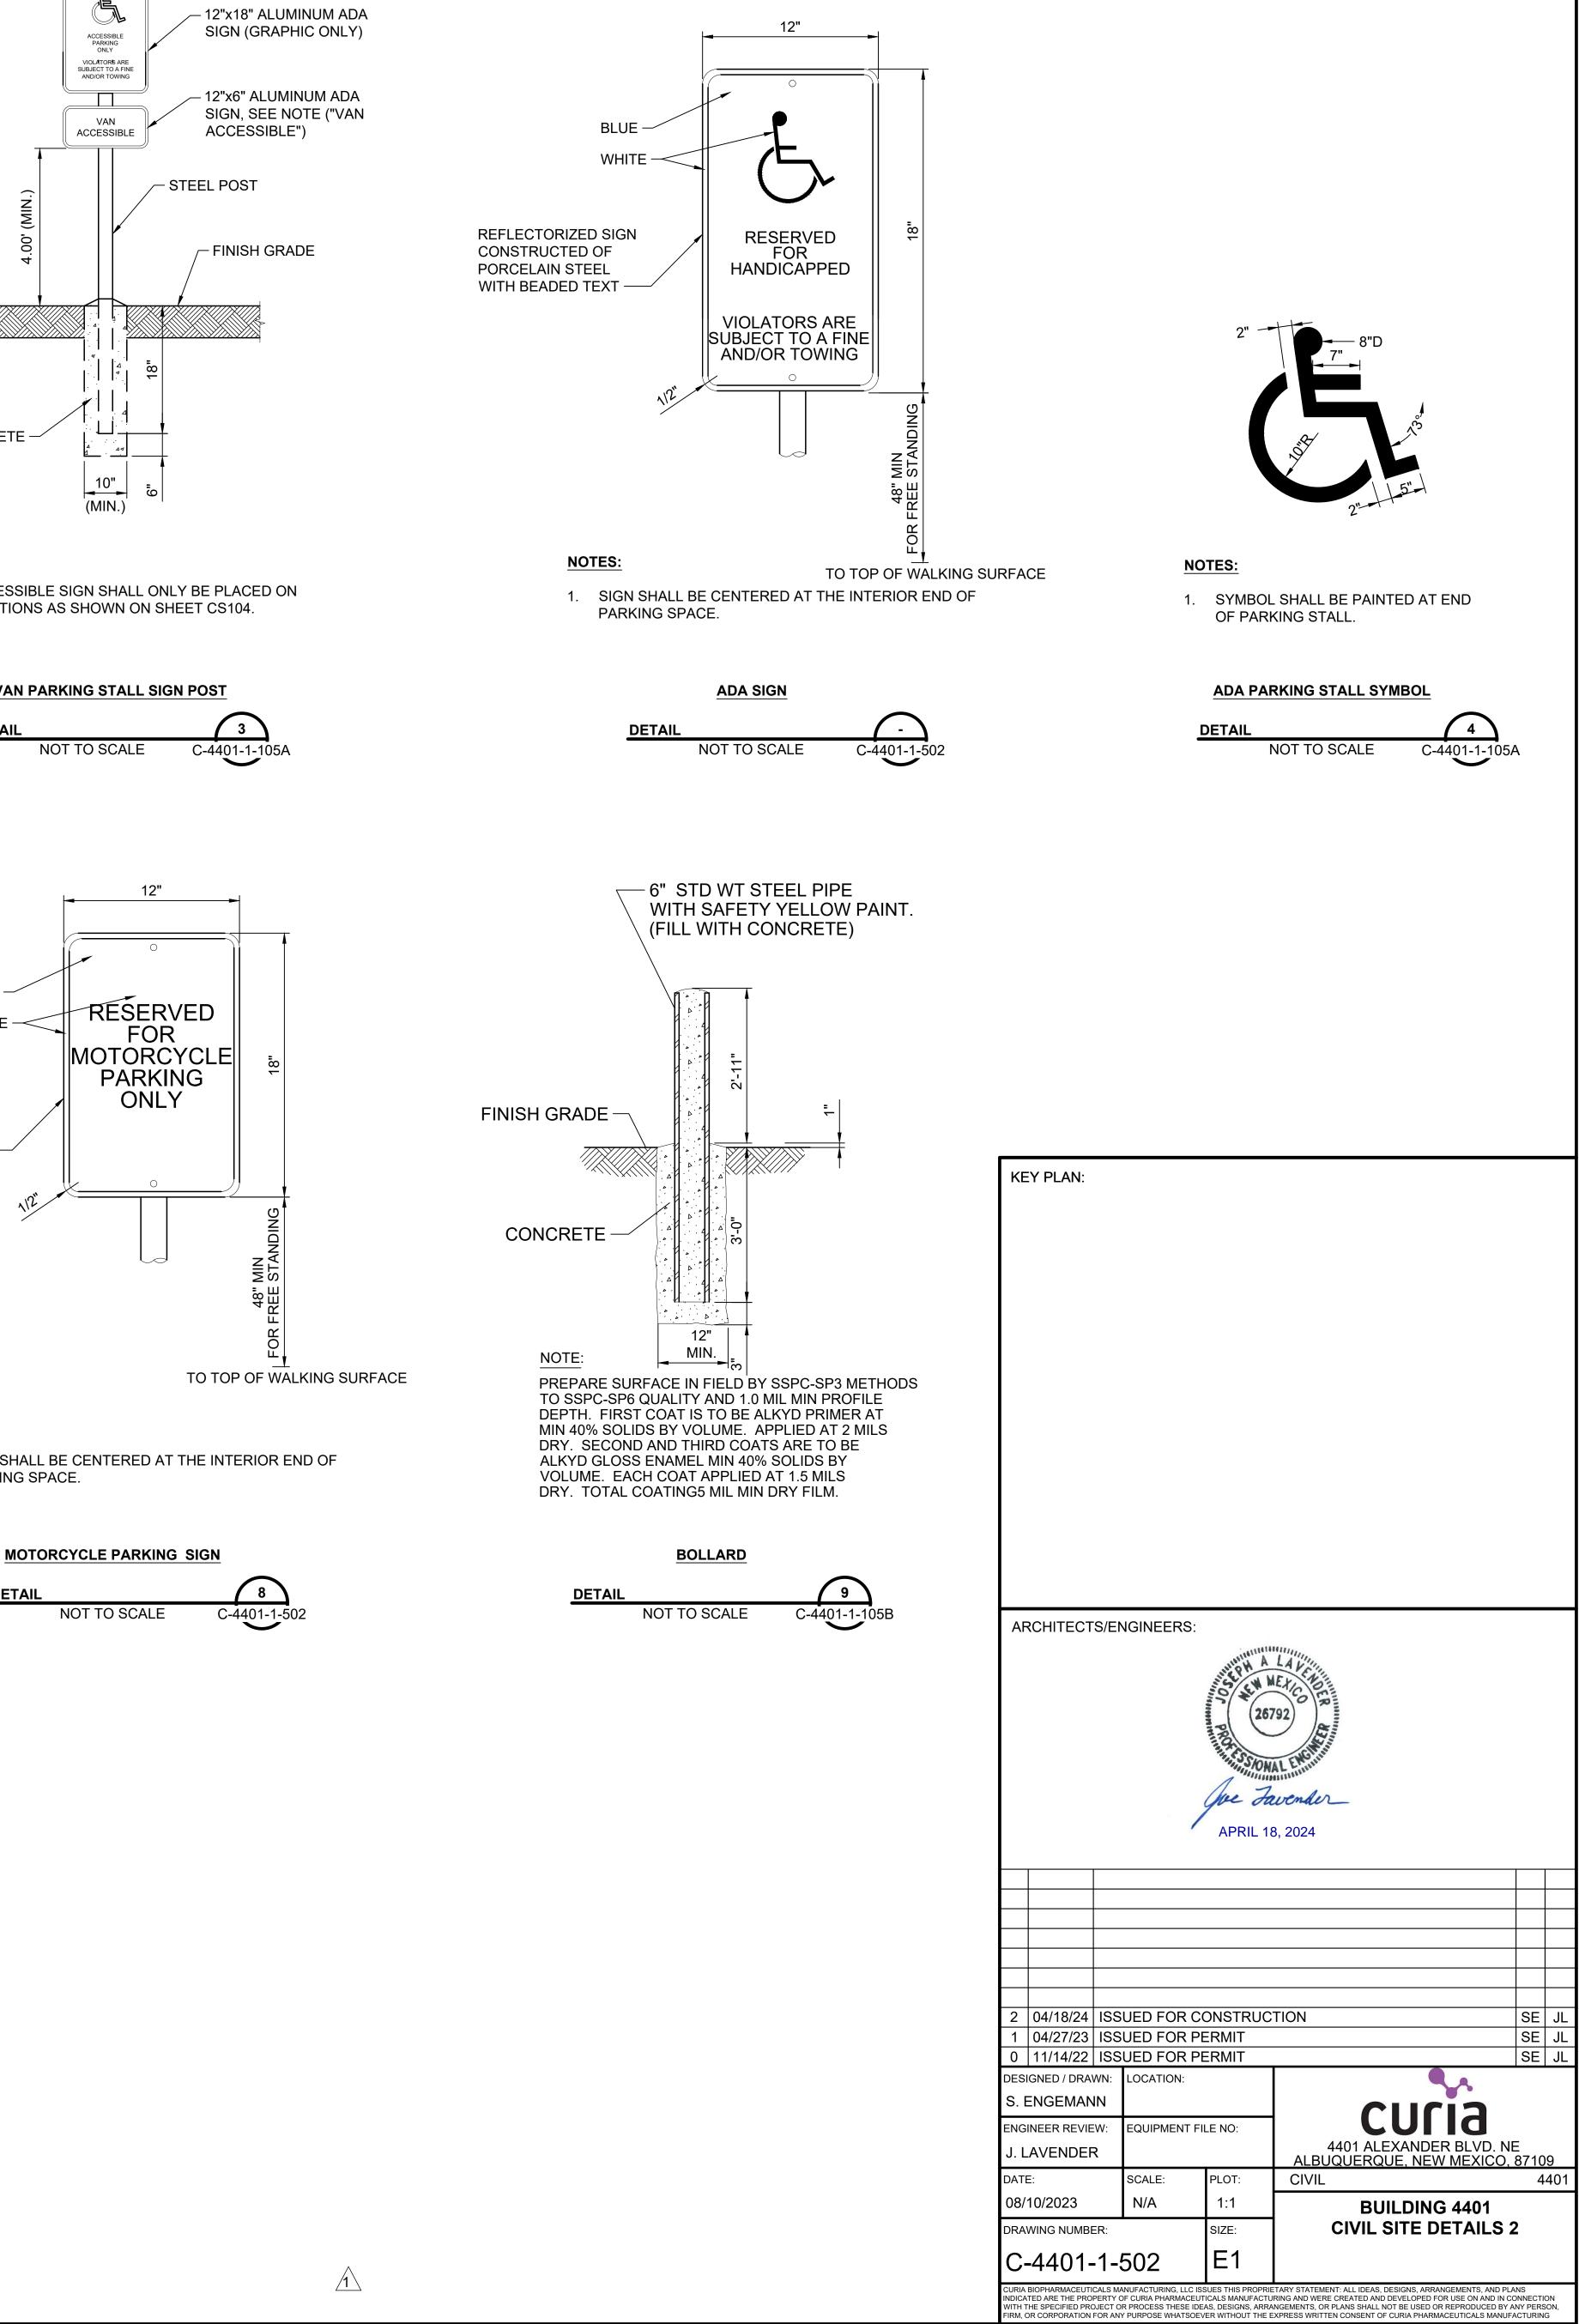

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KEYED NOTES: (#)

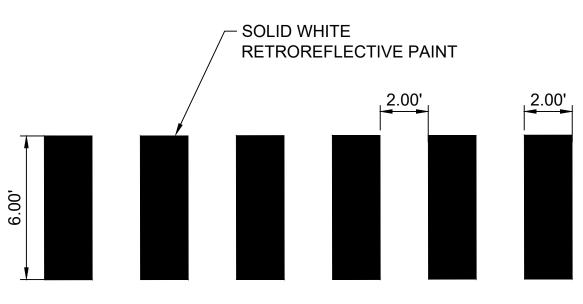
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BICYCLE RACK SHALL BE DESIGNED IN ACCORDING TO THE FOLLOWING GUIDELINES:

 A. THE RACK SHALL BE A MINIMIUM OF 30 INCHES TALL AND 18 INCHES WIDE.
 B. THE BICYCLE FREAM SHALL BE SUPPORTED HORIZONTALLY AT TWO OR MORE PLACES. COMB/TOASTER RACKS ARE NOT ALLOWED.
 C. THE RACK SHALL BE DESIGNED TO SUPPORT THE BICYCLE IN AN UPRIGHT POSITION.
 D. THE RACK ALLOWS VARYING BICYCLE FRAME SIZES AND STYLES TO BE ATTACHED.
 E. THE USER IS NOT REQUIRED TO LIFT THE BICYCLE ONTO THE BICYCLE RACK.
 F. EACH BICYCLE PARKING SPACE IS ACCESSIBLE WITHOUT MOVING ANOTHER BICYCLE.

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www.belson.com

BICYCLE RACK


DETAIL

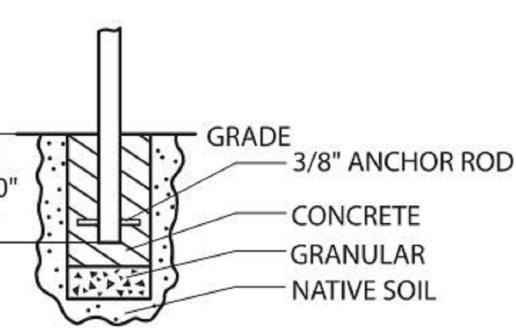NOT TO SCALE C-4401-1-105





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J	. LAVEND	ER	EQUIP F	FILE	NO.
date 0	:: 1/24/2023		SCALE: NO SCALE	-	PLOT: 1:1
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	C-440				E1
NDICAT WITH TH	BIOPHARMACEUTIC ED ARE THE PROF E SPECIFIED PRO R CORPORATION F	PERTY O	F CURIA PHARMA PROCESS THES	CEUTIC	CALS MANUF S, DESIGNS,
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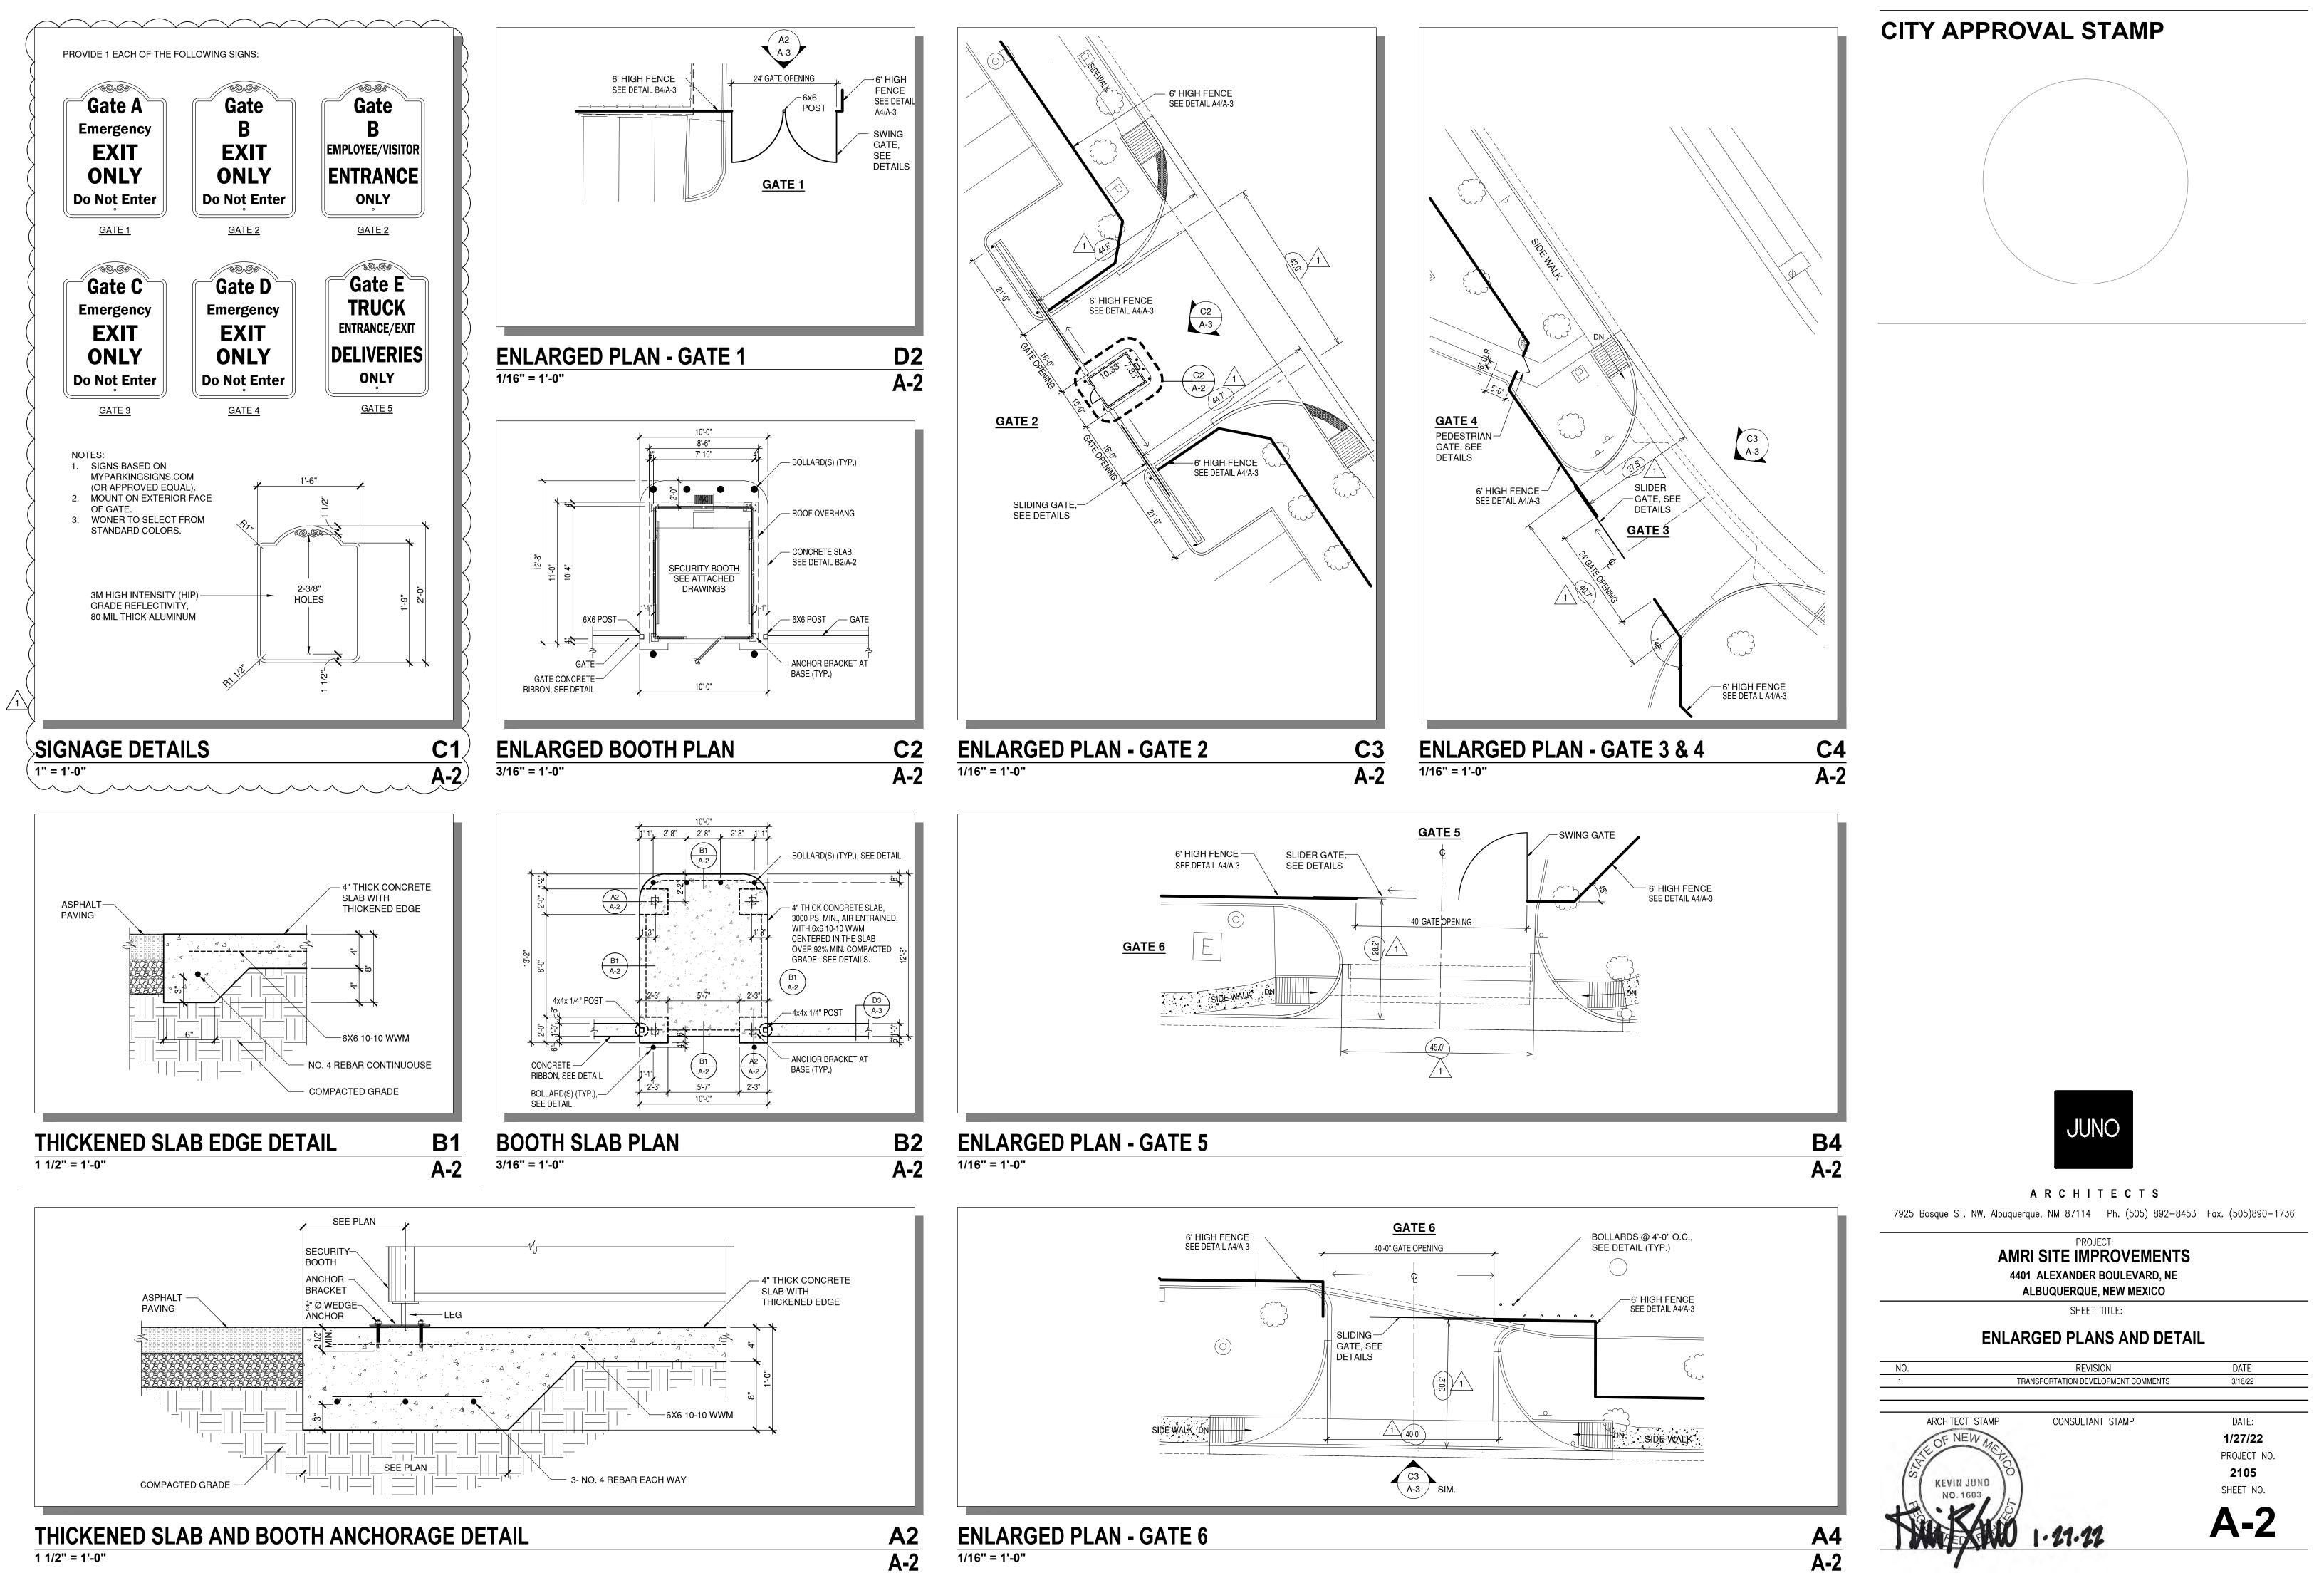
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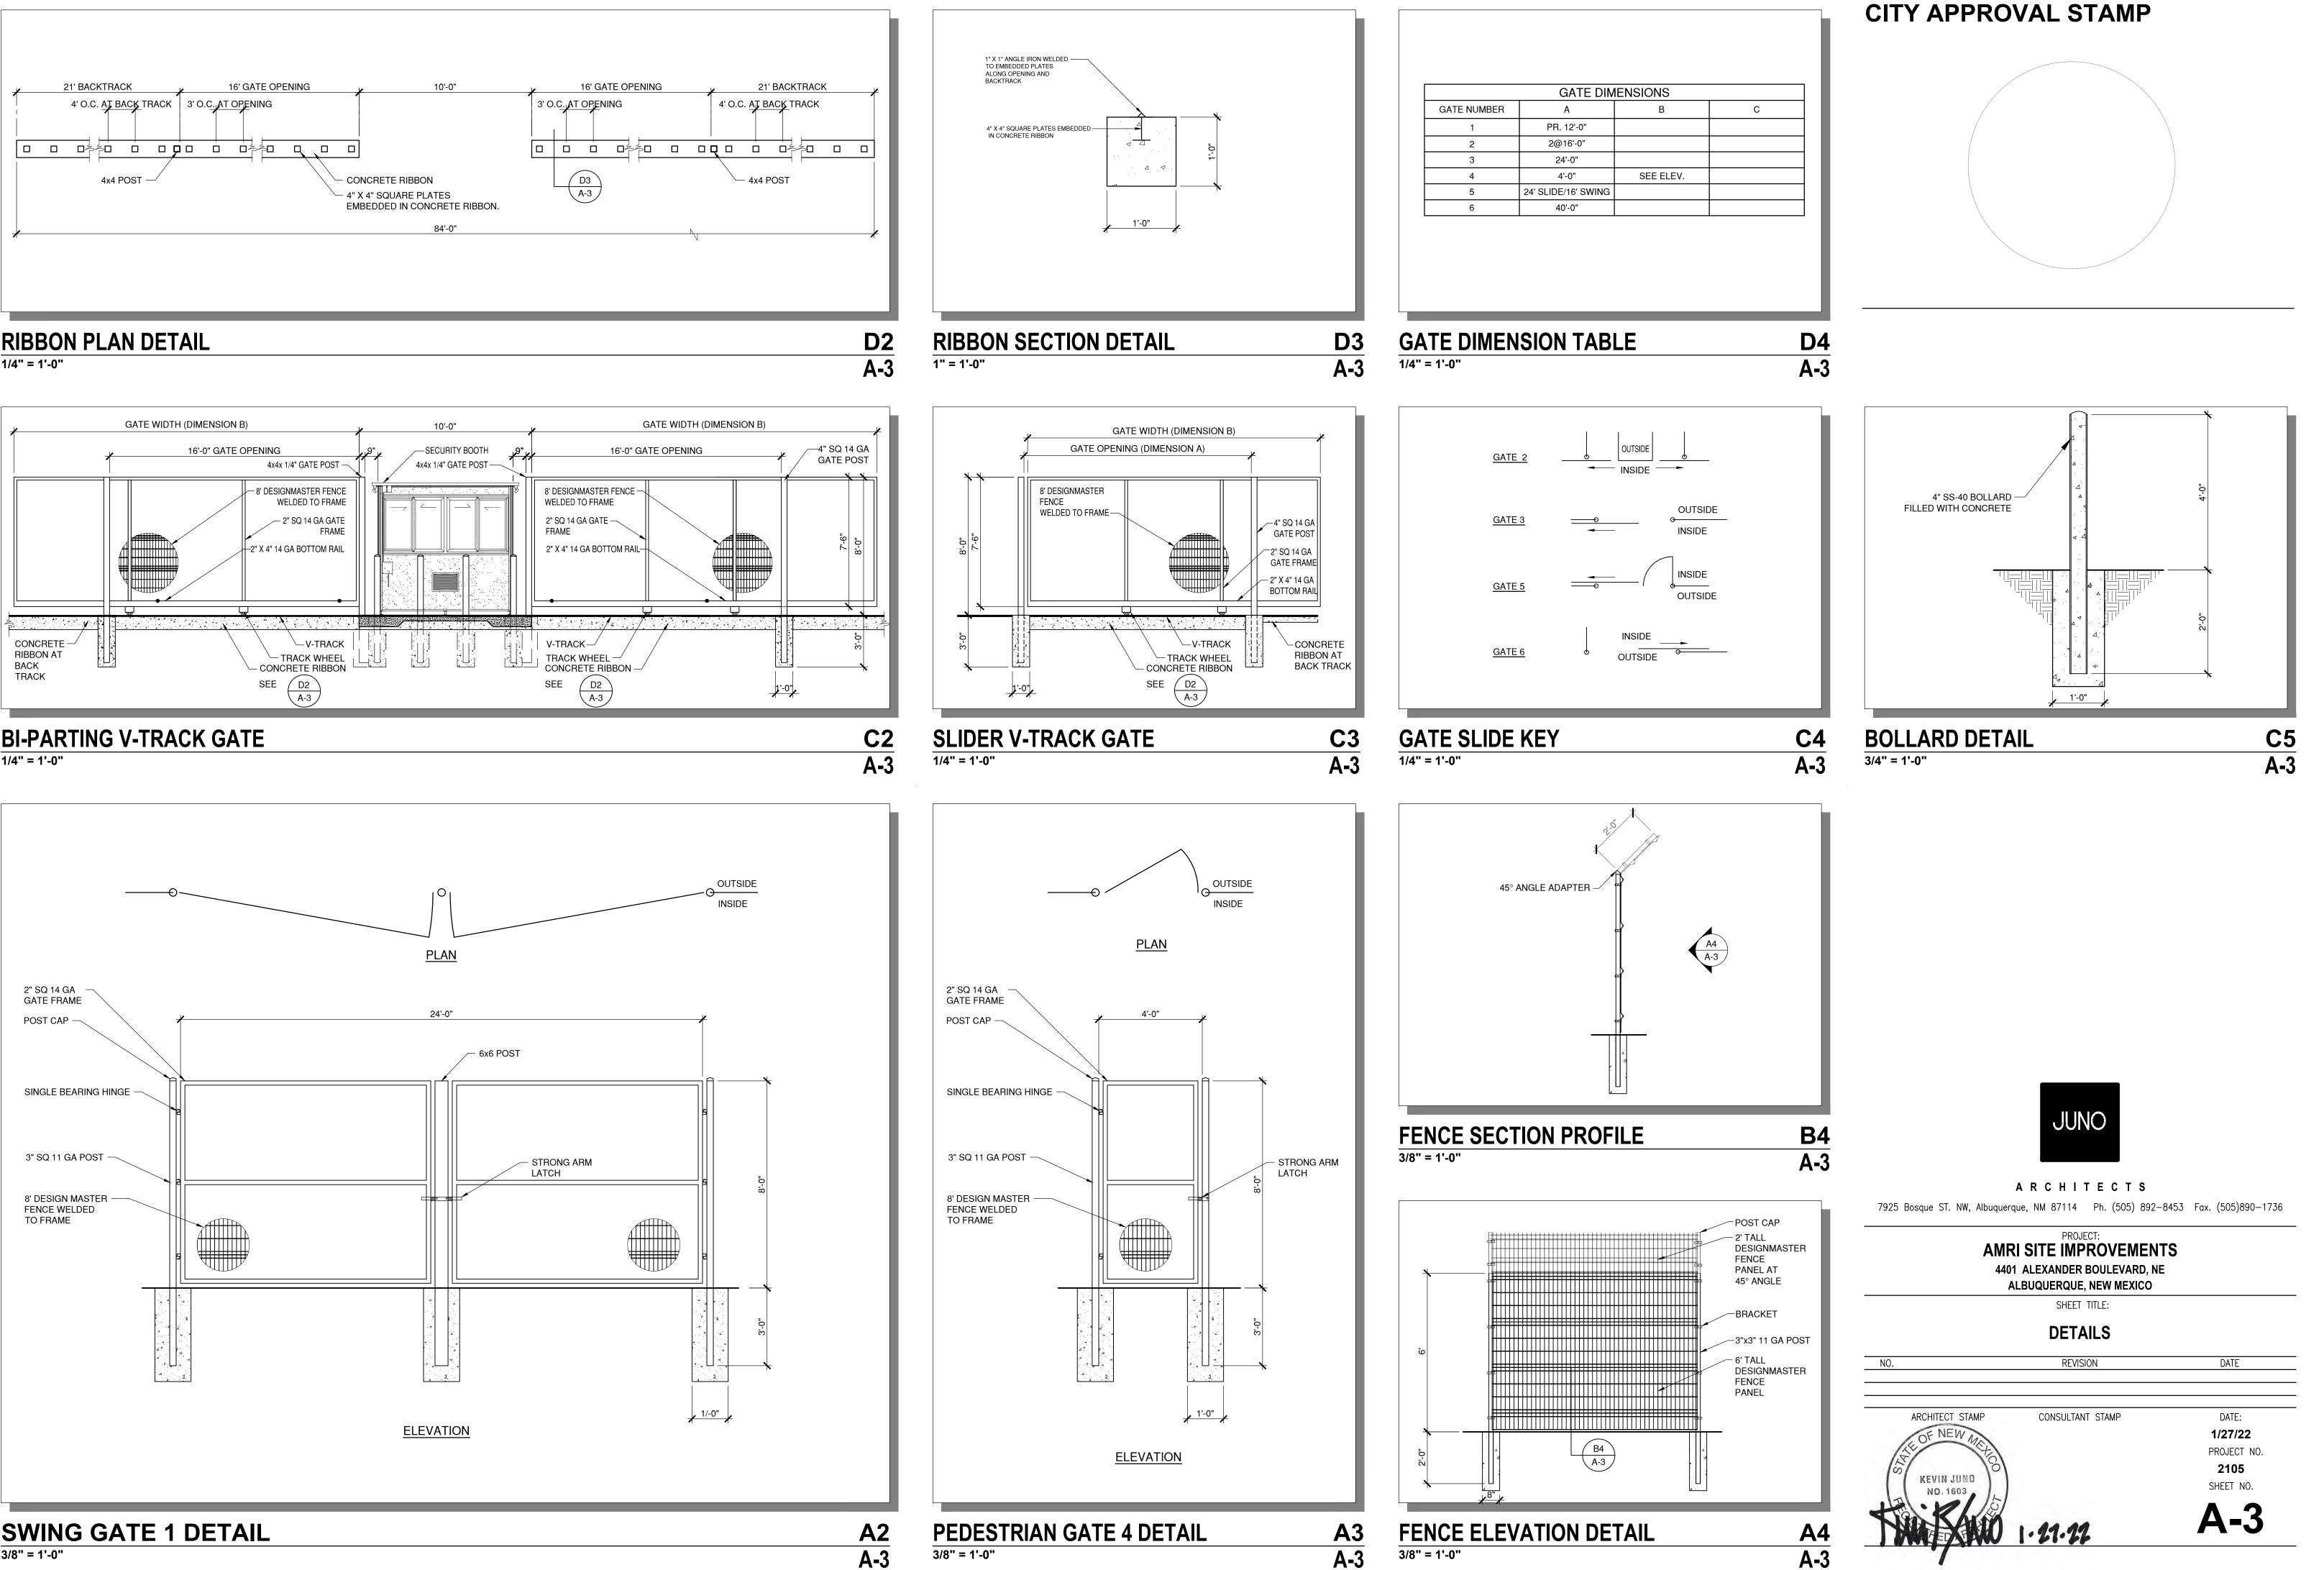
ADMINISTRATIVE AMENDMENT		
FILE #:	PROJECT #:	
APPROVED BY	DATE	




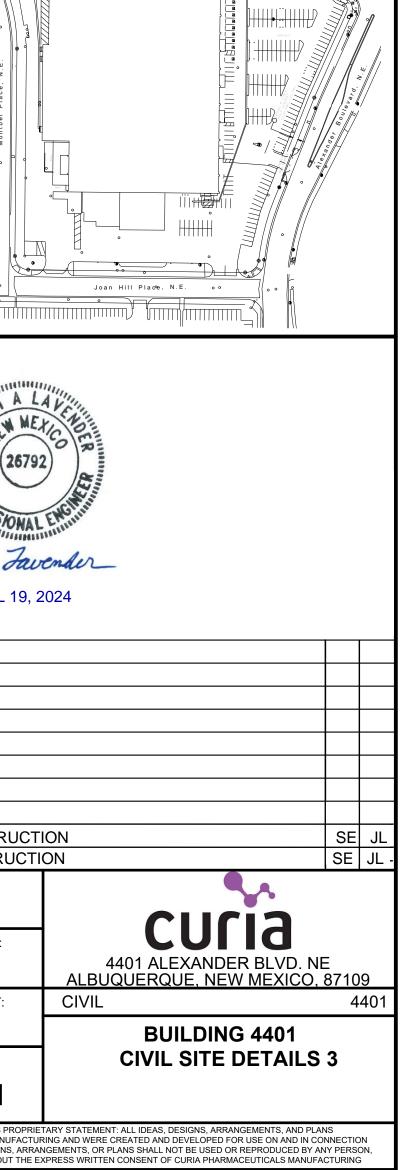




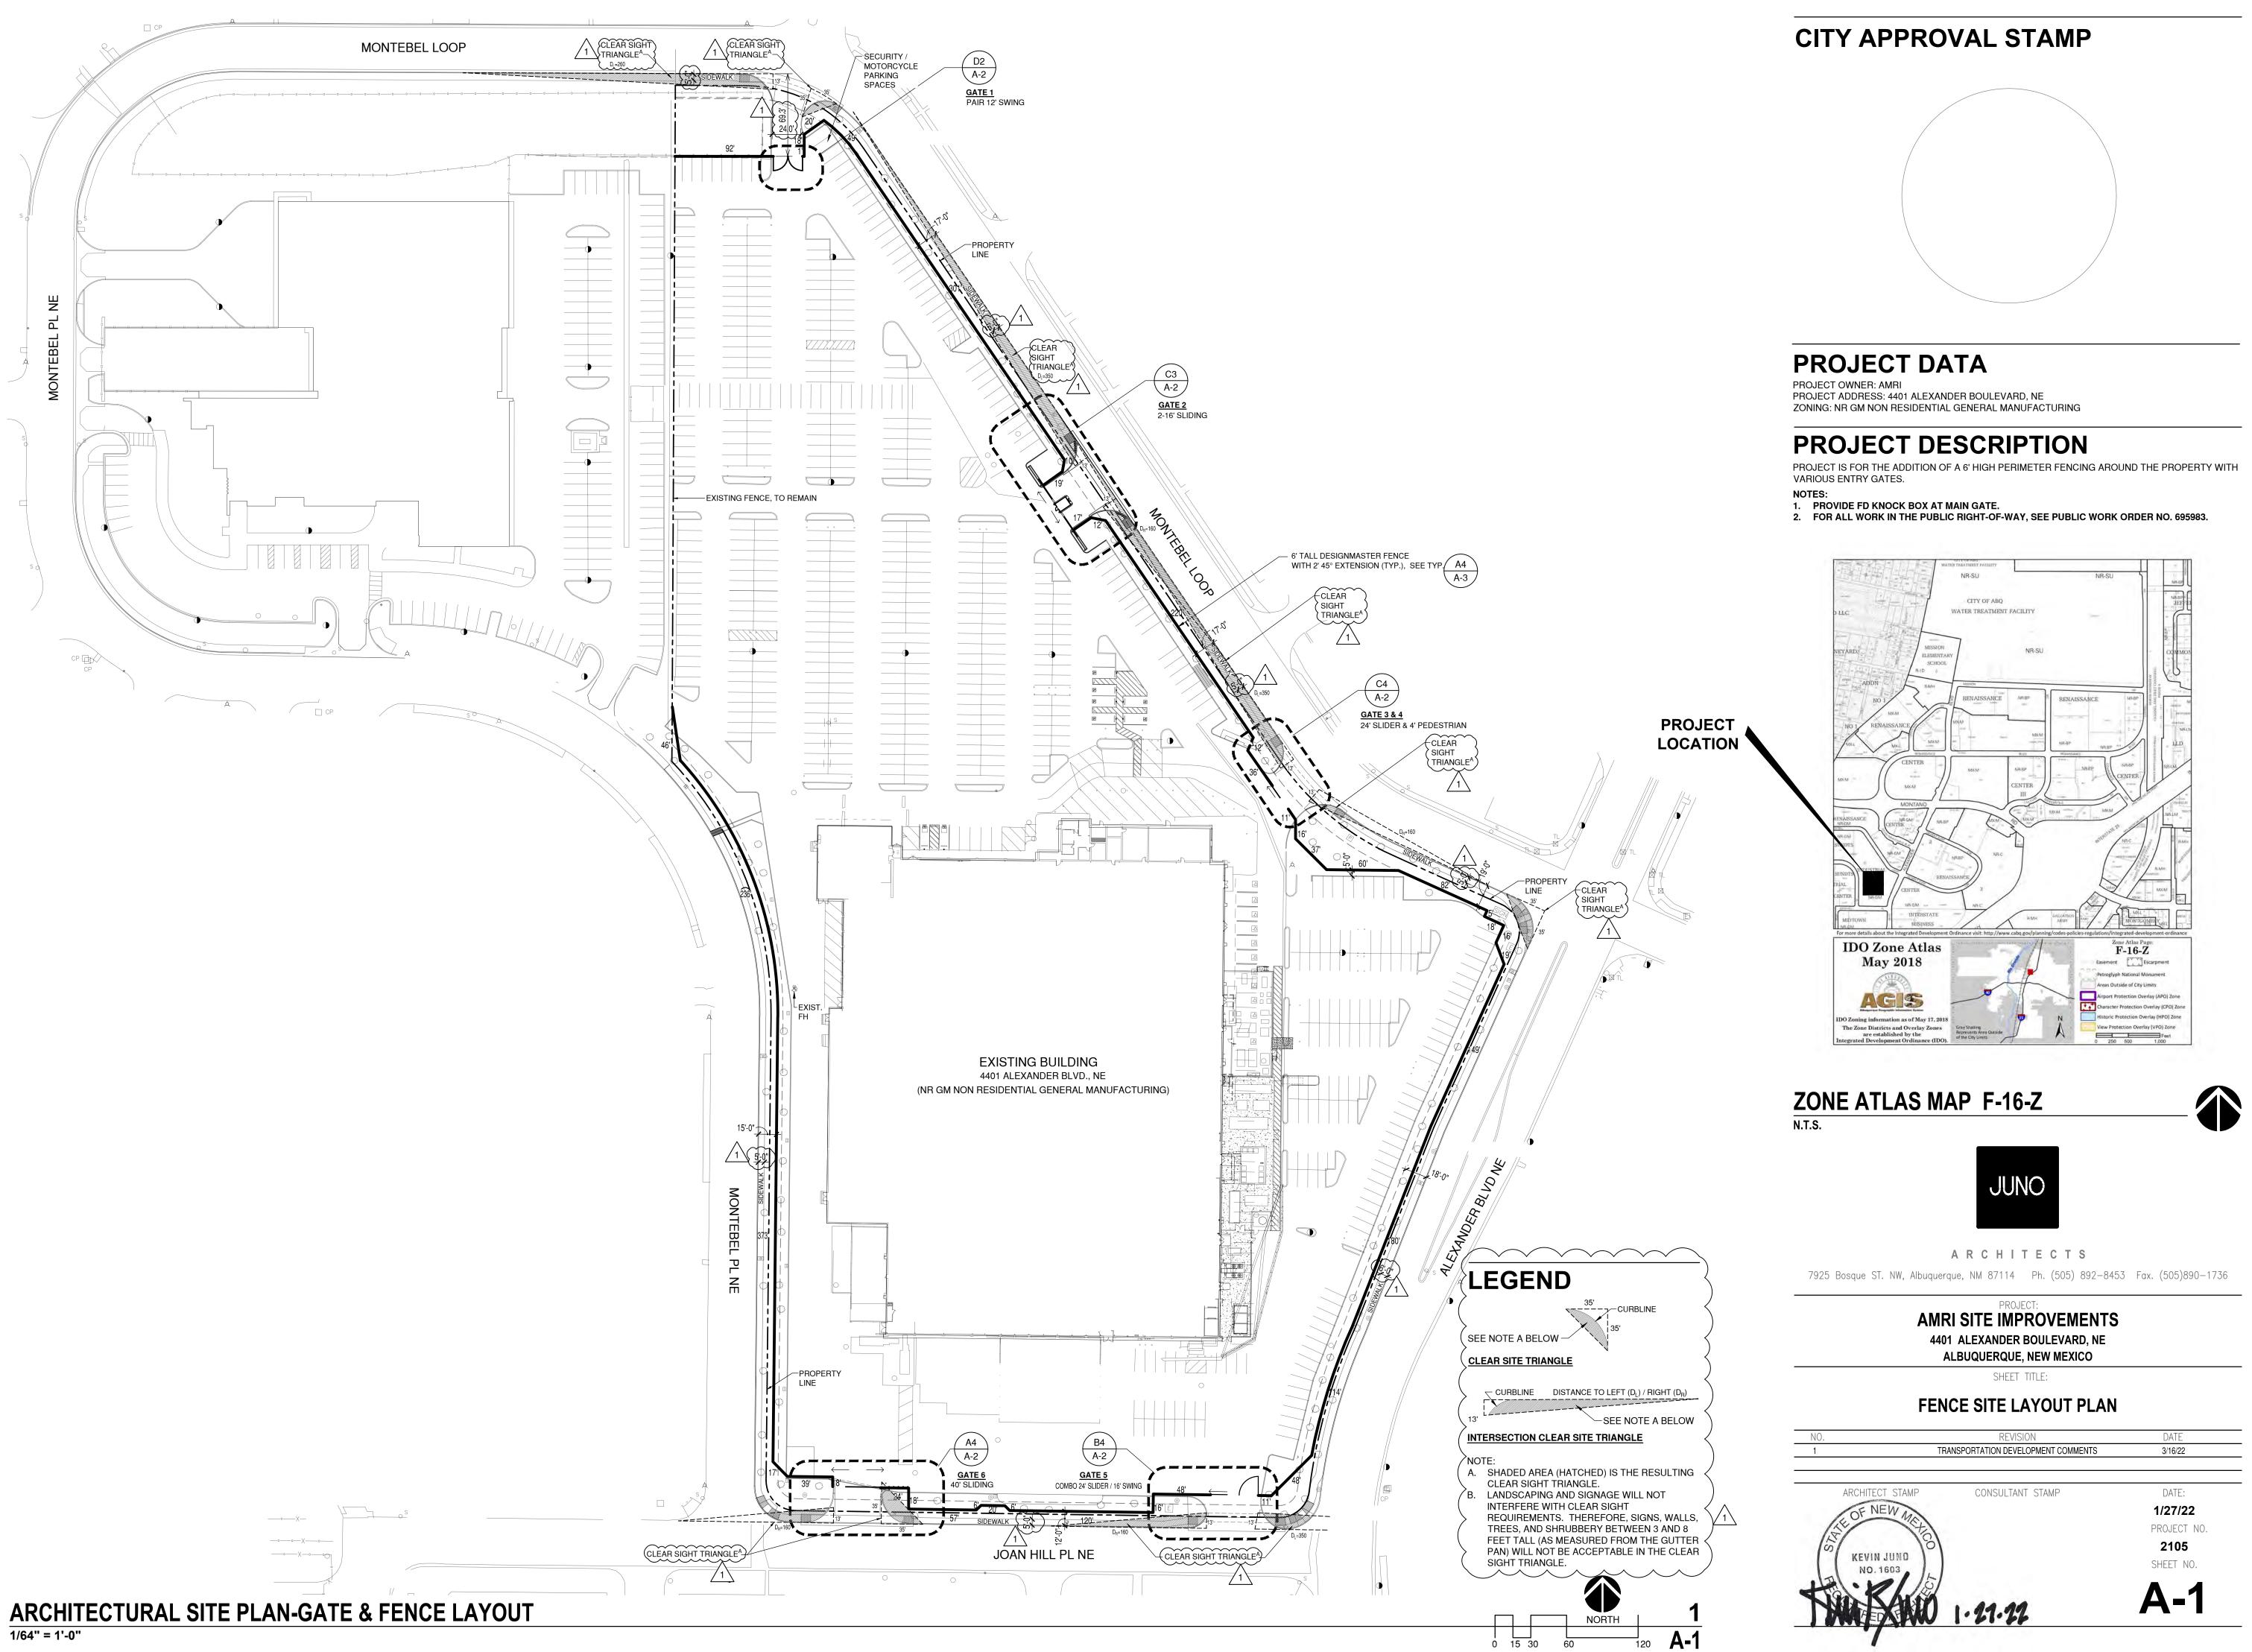

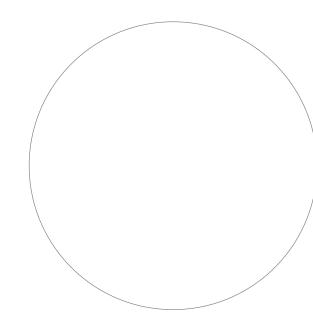

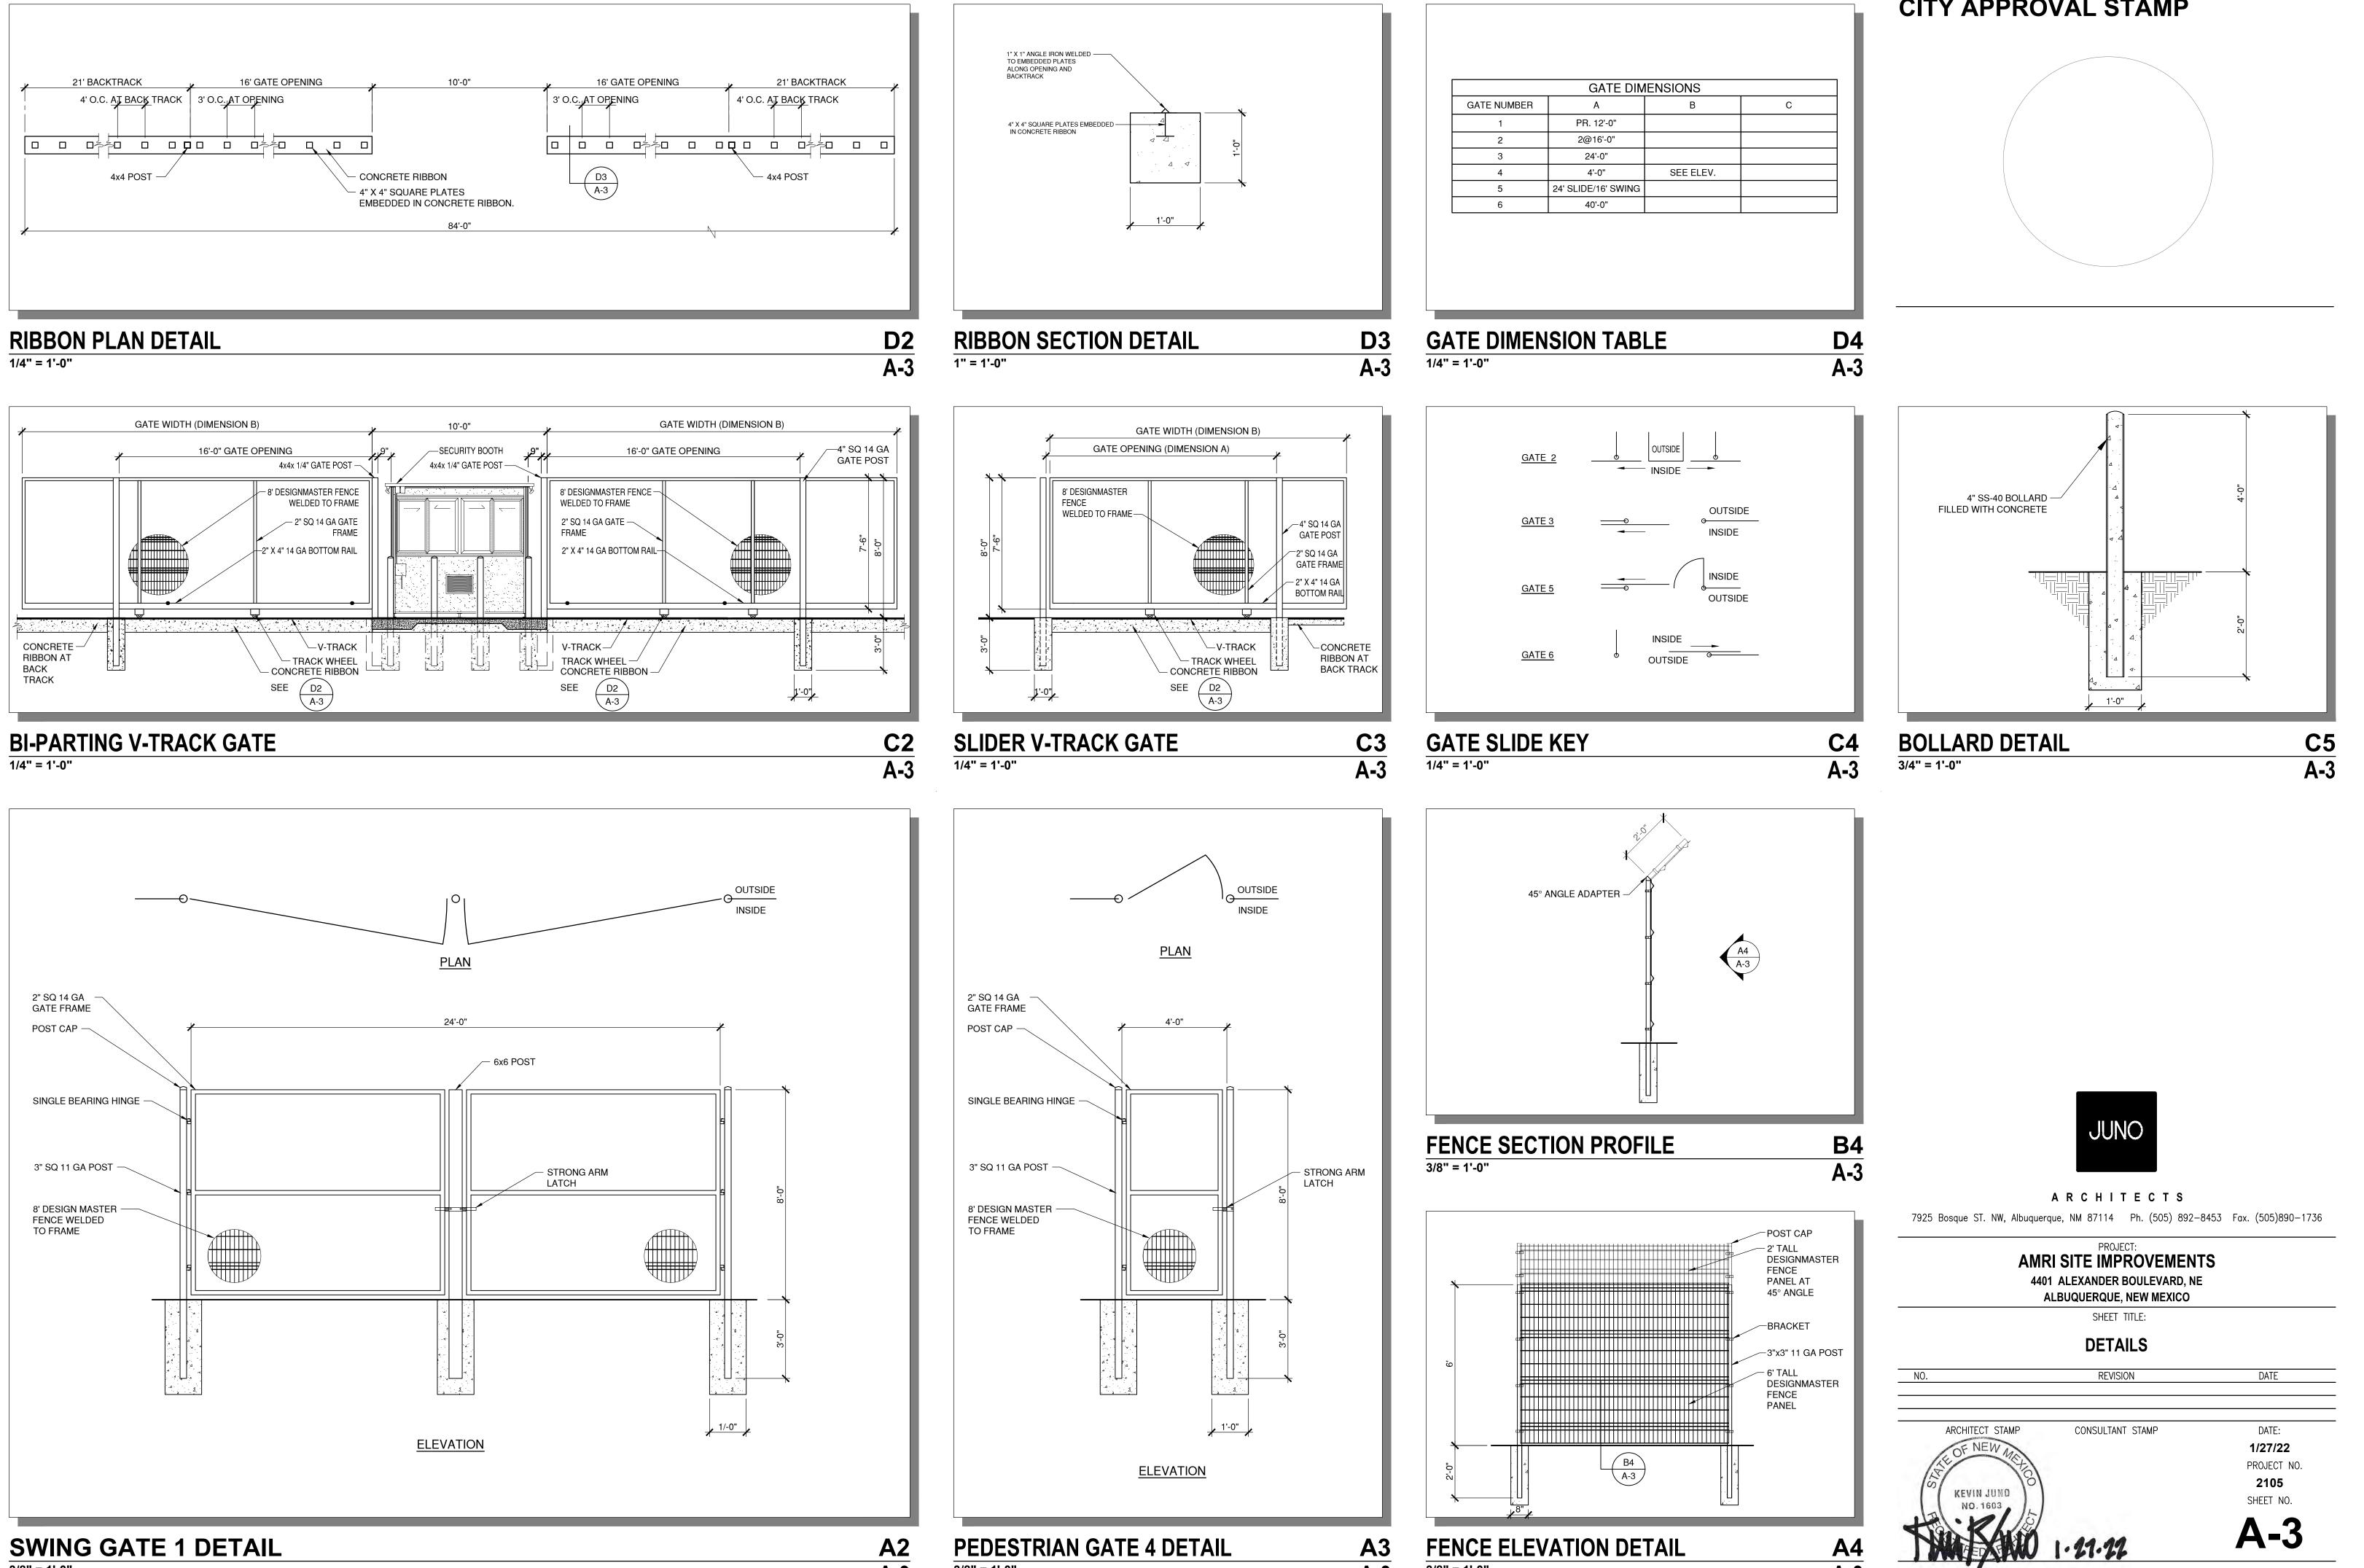



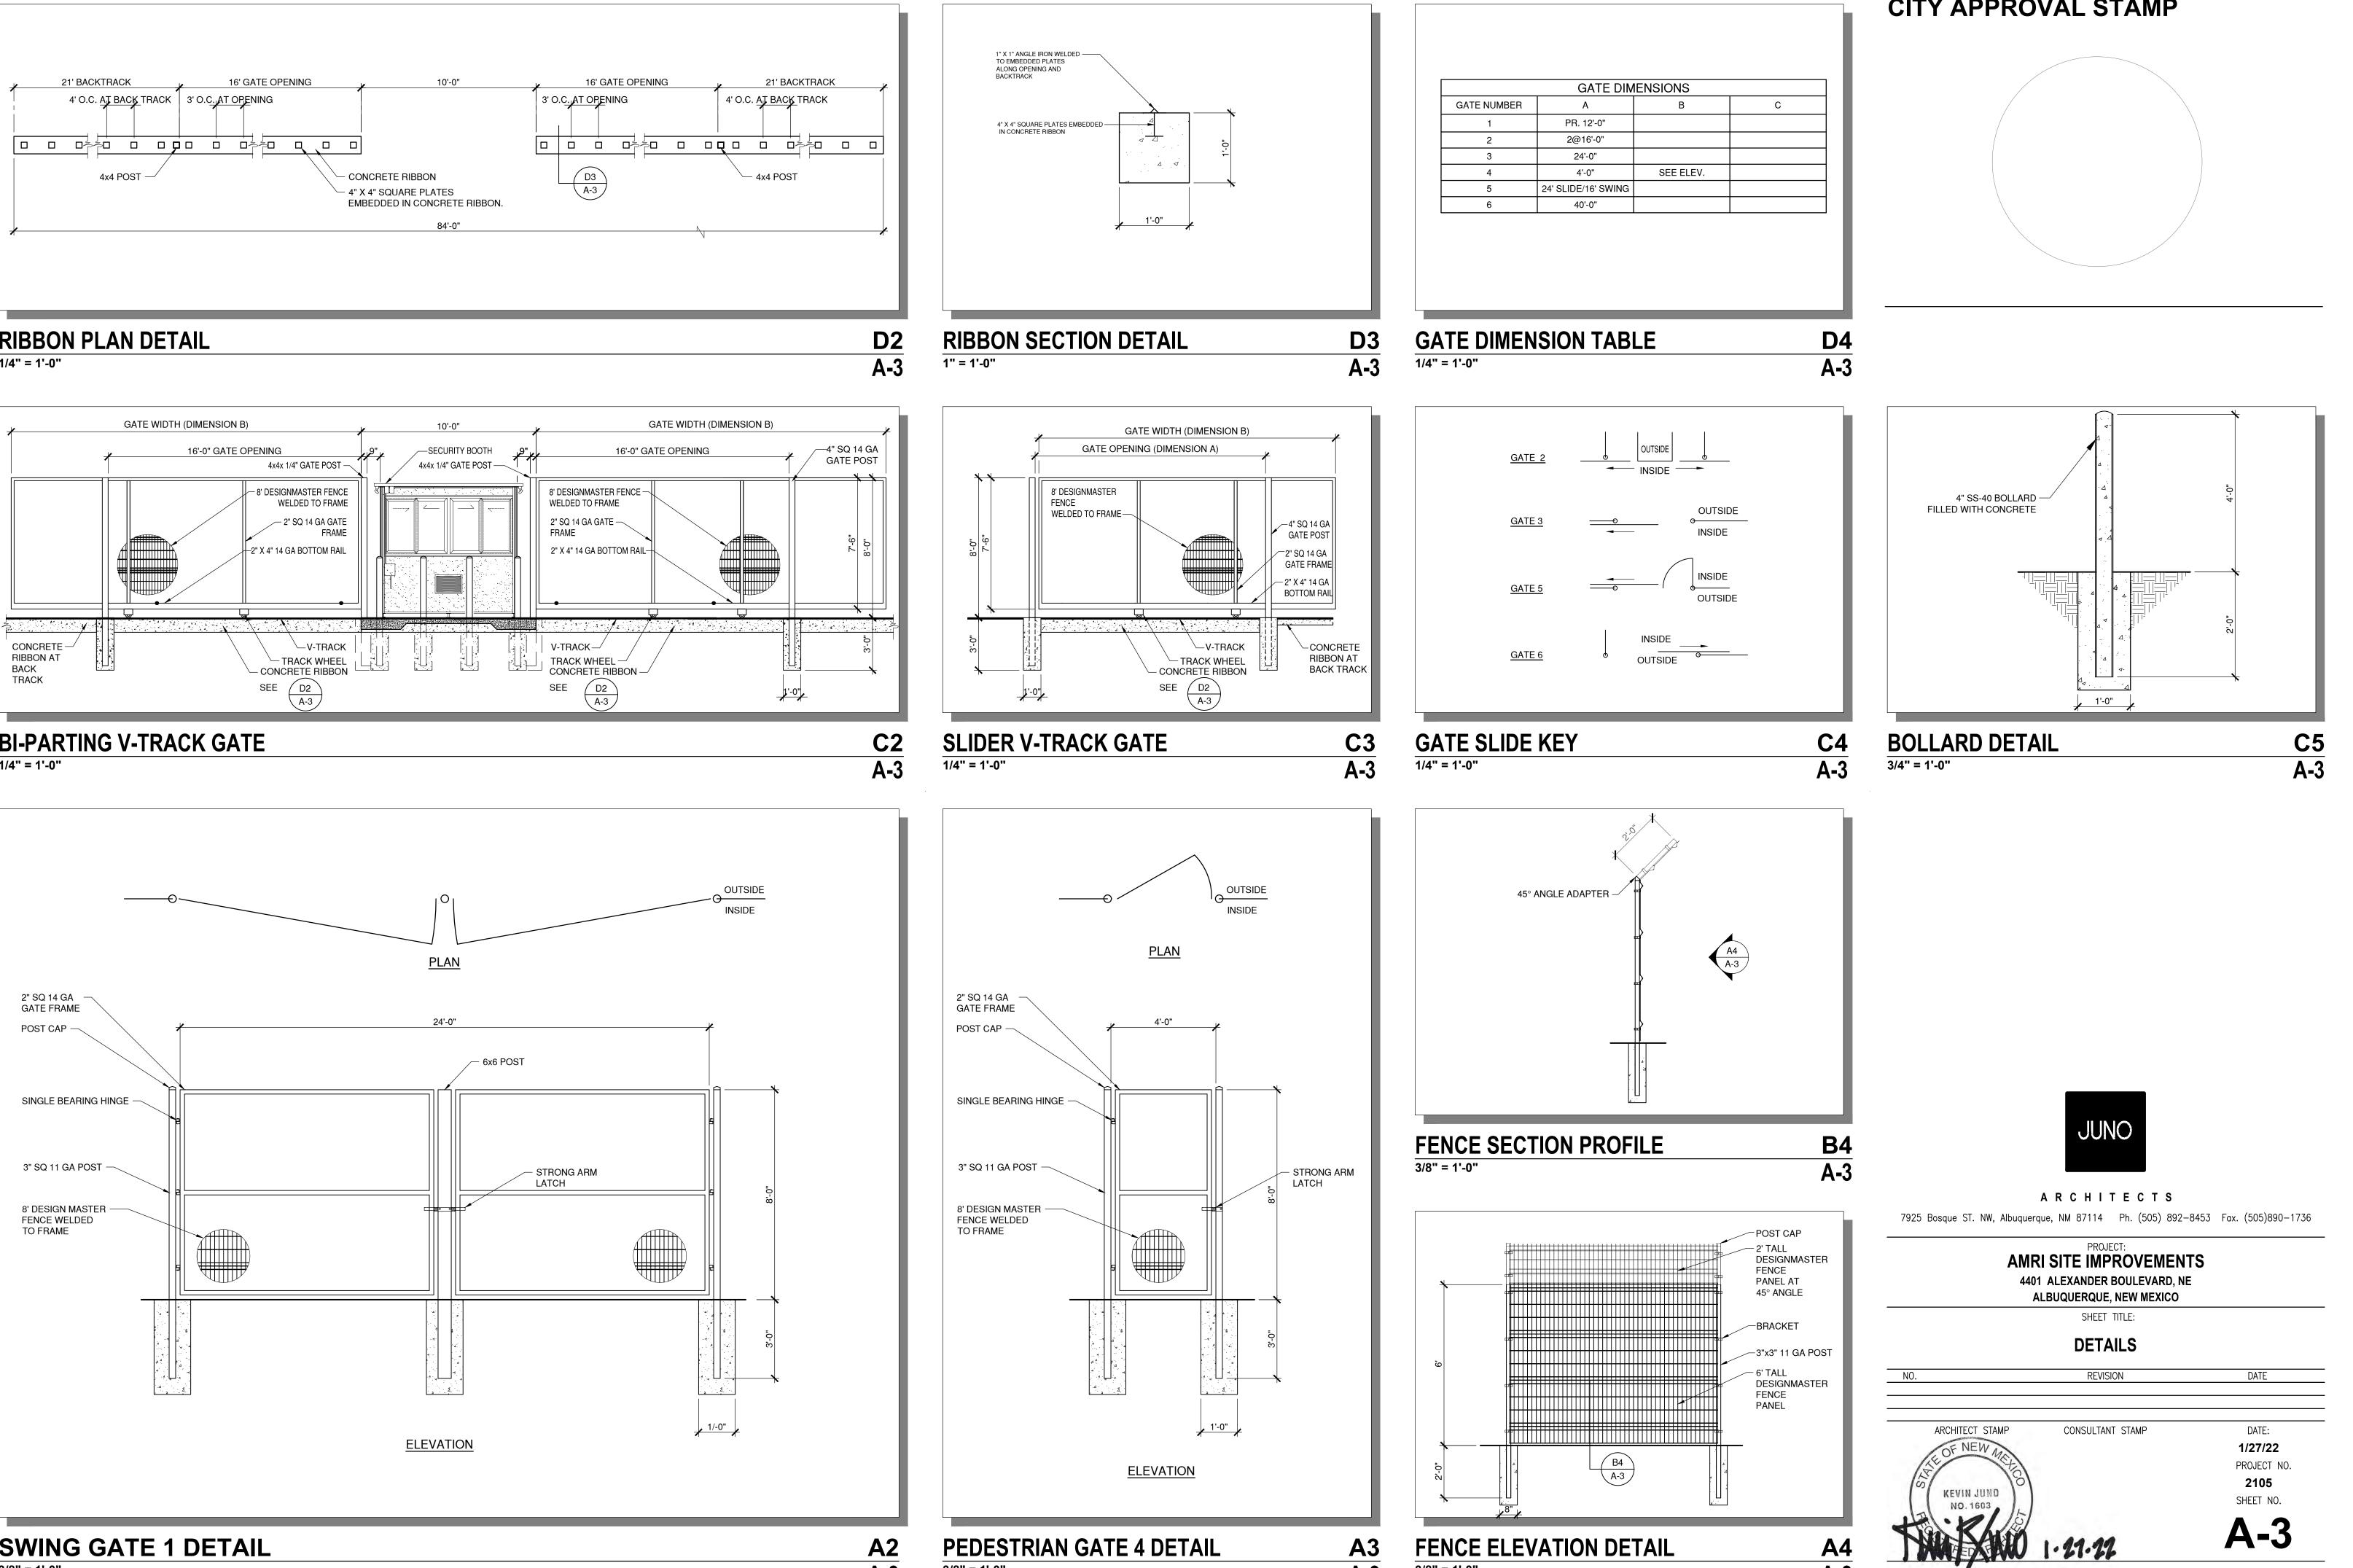



3/8" = 1'-0"

A-3

A-3


3/8" = 1'-0"

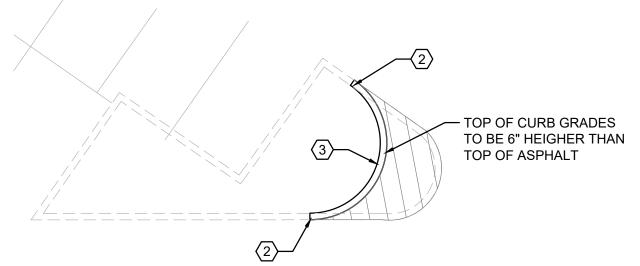

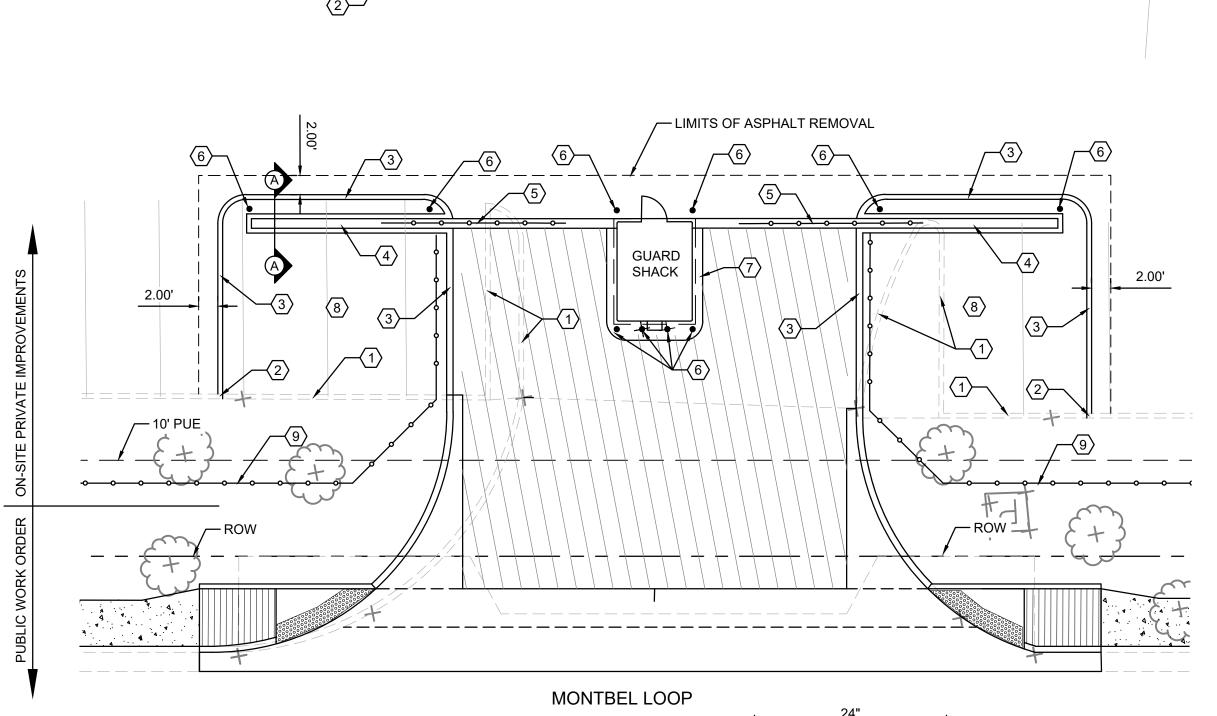



CONSTRUCTION NOTES $\langle X \rangle$ -

- 1 REMOVE & DISPOSE PCC CURB.
- 2 SAW-CUT CURB AT BACK OF NEW CURB. 3 6" WIDE PCC HEADER CURB.
- 4 GATE TRACK, SEE DETAIL THIS SHEET.
- 5 SLIDING GATE, SEE GATE PLAN.
- 6 4" DIAMETER PCC FILLED STEEL BOLLARD. 7 PCC APRON, FLUSH WITH ASPHALT PAVING.
- 8 NEW LANDSCAPING, SEE LANDSCAPING PLAN.
- 9 NEW PRIVATE FENCE, SEE FENCING PLAN.

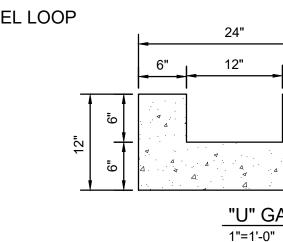


ENTRANCE "B" LAYOUT SCALE: 1"=10'

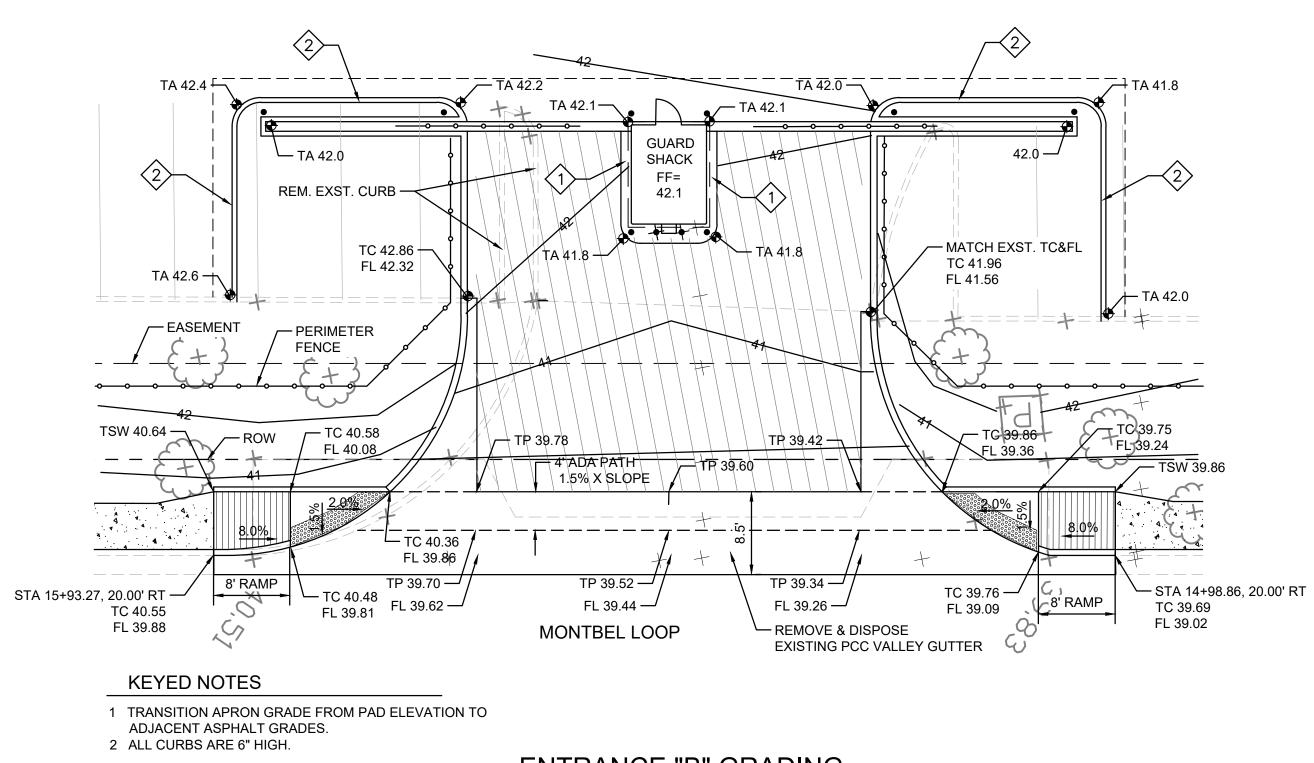

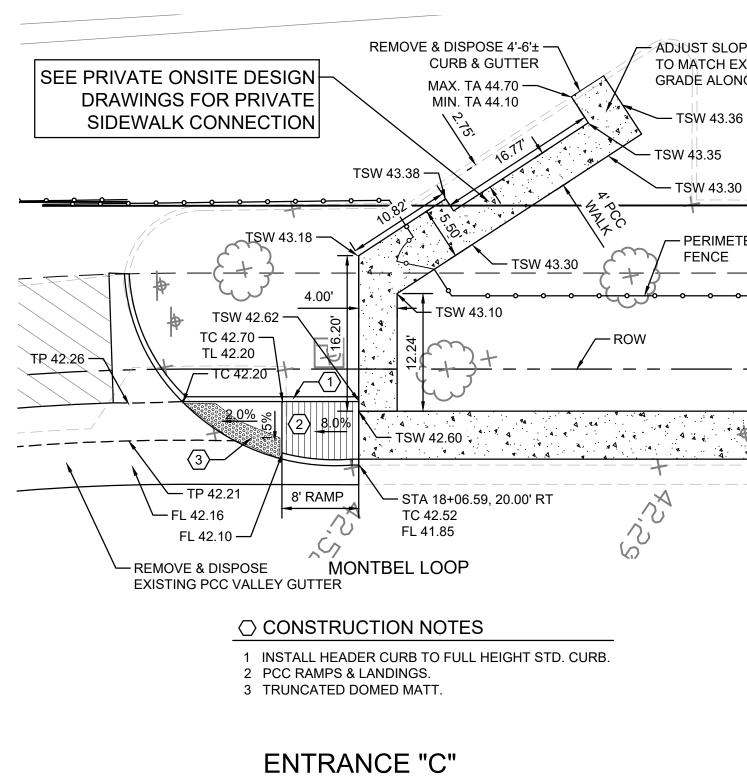

SCALE: 1"=10'



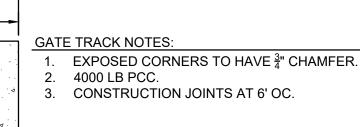

"U" GATE TRACK DETAIL A-A


CITY APPROVAL STAMP

ADJUST SLOPE OVER 6' OF SIDEWALK TO MATCH EXISTING TOP OF ASPHALT GRADE ALONG FACE OF CURB.

— TSW 43.36

— TSW 43.30

- PERIMETER FENCE ____

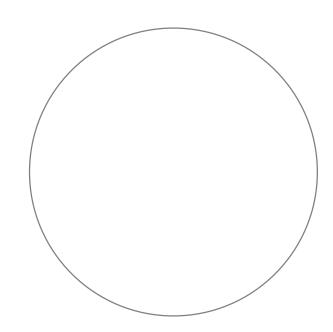







ARCHITECTS

7925 Bosque ST. NW, Albuquerque, NM 87114 Ph. (505) 892-8453 Fax. (505)890-1736

PROJECT: AMRI SITE IMPROVEMENTS 4401 ALEXANDER BOULEVARD, NE ALBUQUERQUE, NEW MEXICO


ENTRANCES B&C LAYOUT & GRADING

REVISION

DATE

ARCHITECT STAMP CONSULTANT STAMP

DATE: 1/27/22 PROJECT NO. 2105 SHEET NO.

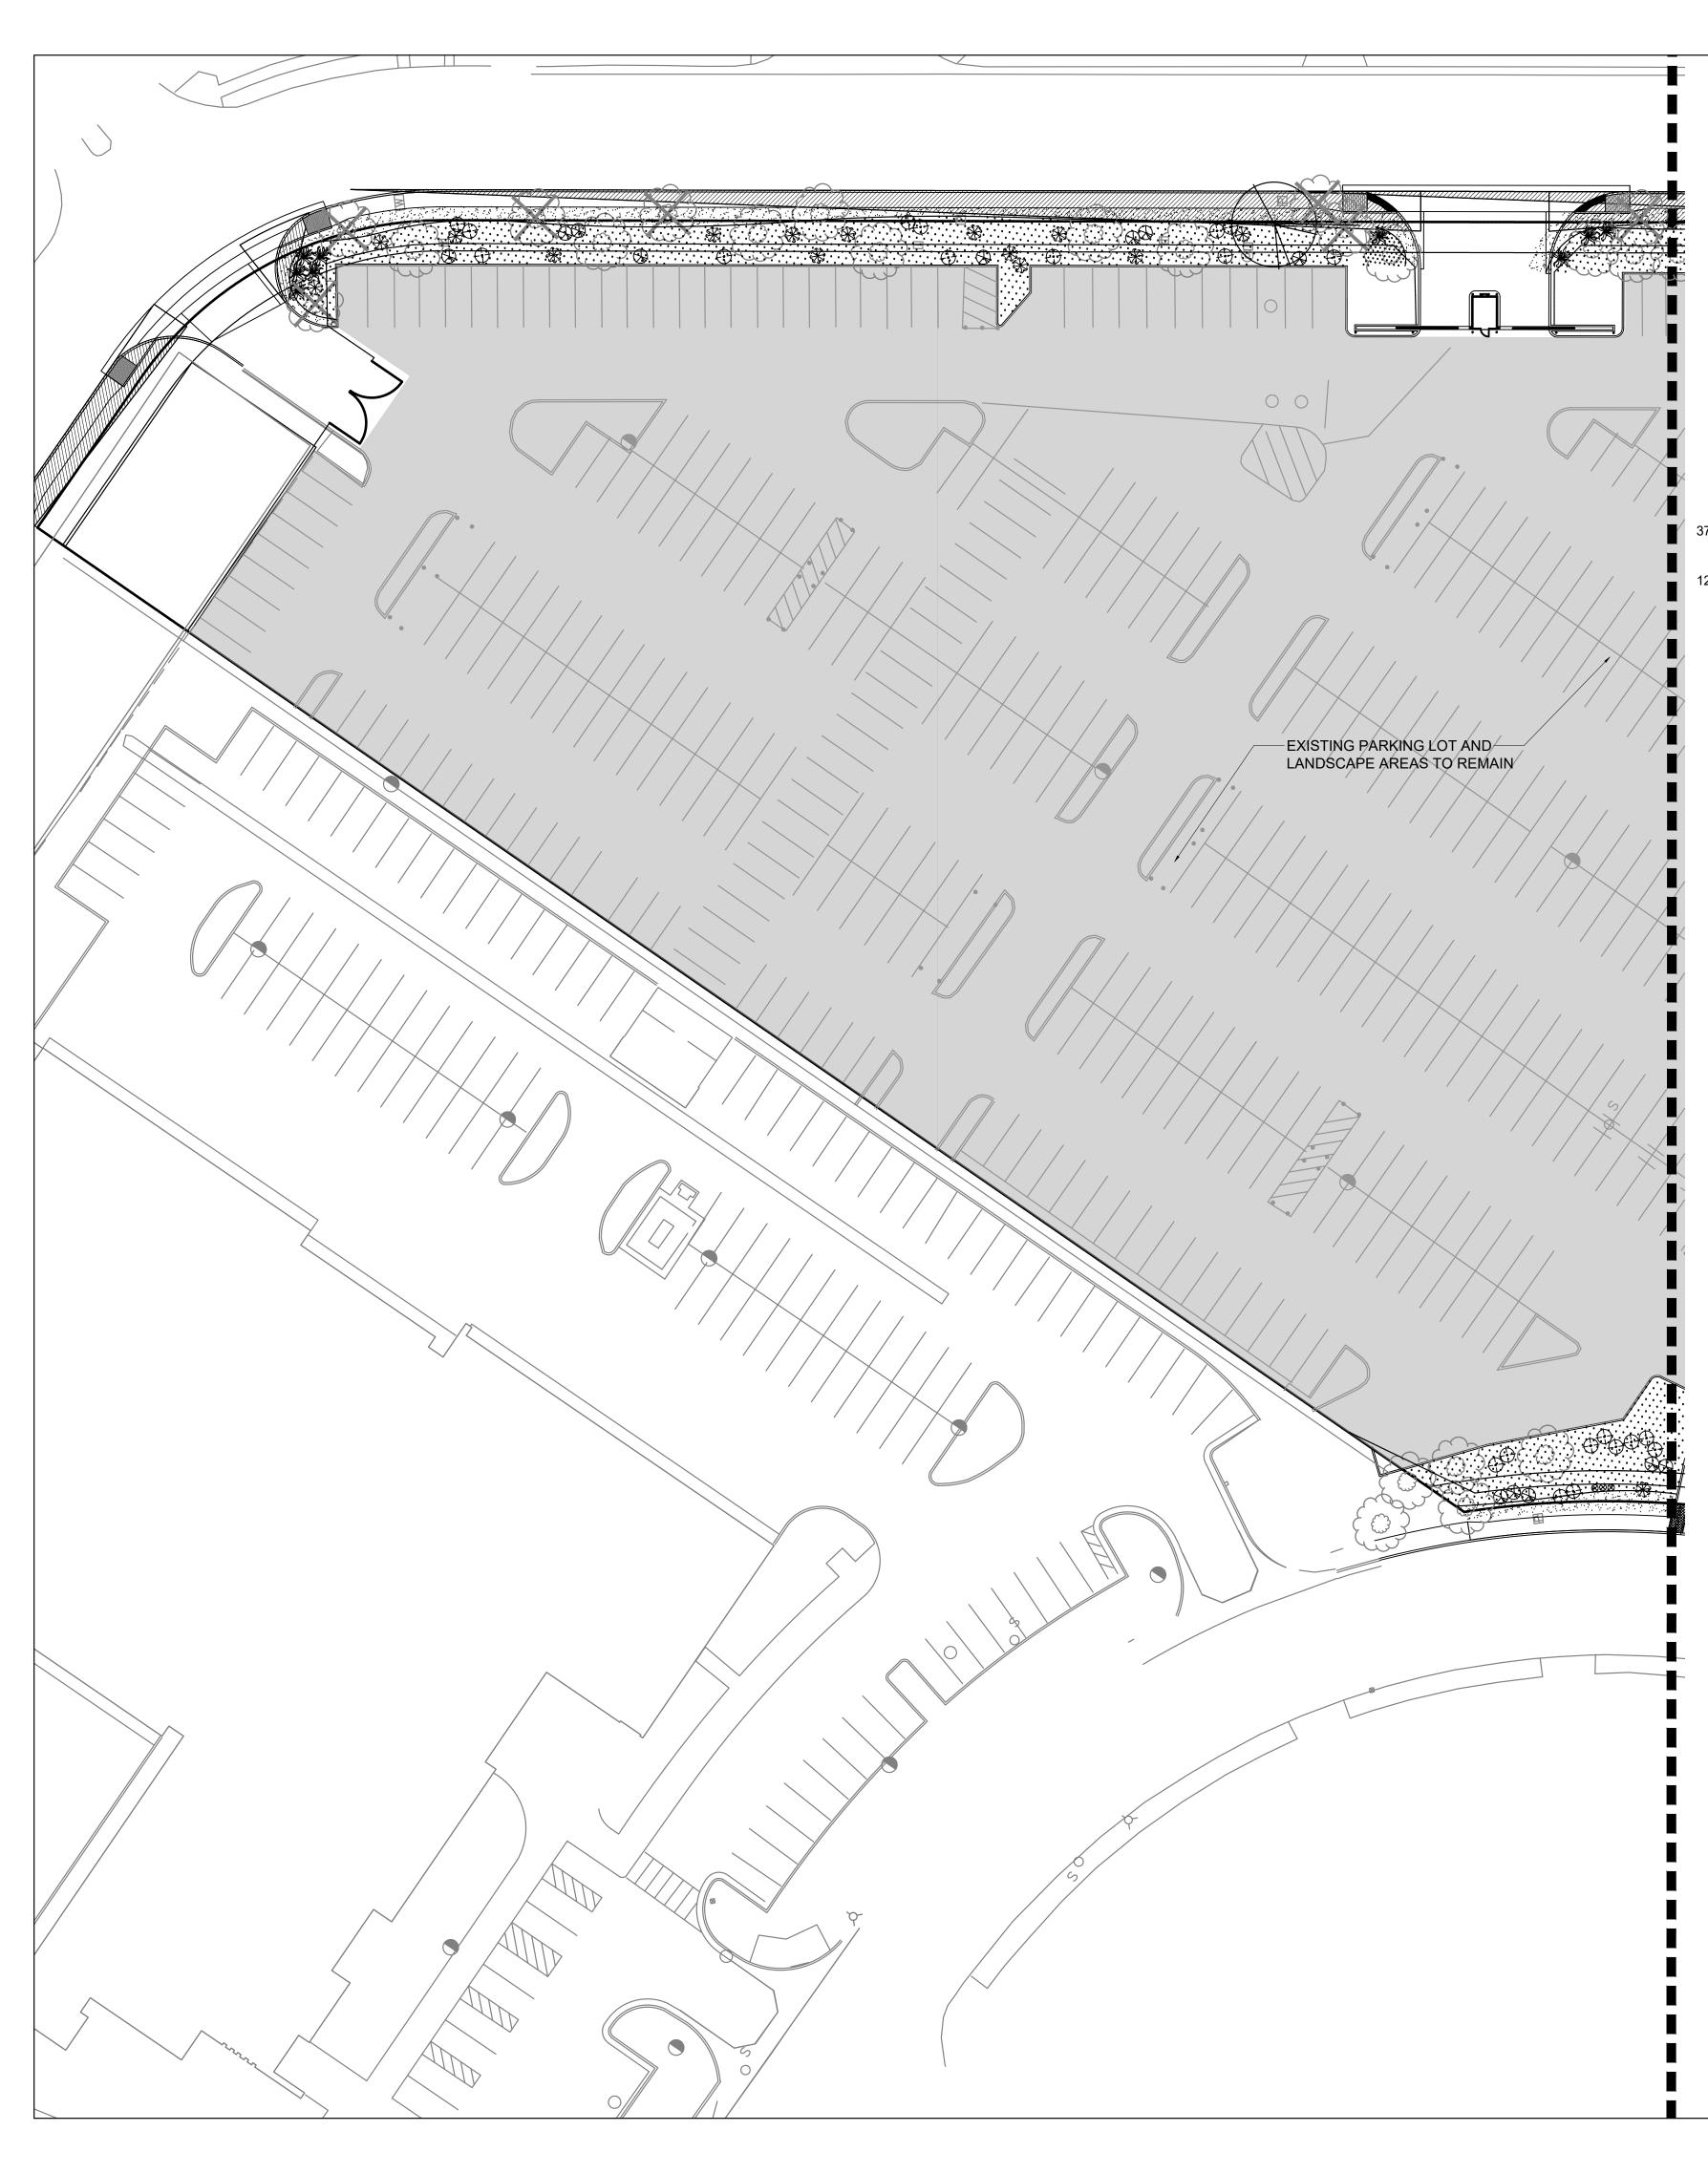

PLANT LEGEND SCIENTIFIC NAME QTY. SYMBOL COMMON NAME (WATER USE) SIZE MATURE SIZE TREES - REFERENCE DETAIL 1-2/L501 CHILOPSIS LINEARIS DESERT WILLOW 'BUBBA' (RW) 24"-BOX 20' HT. X 25' SPR. PISTACIA CHINENSIS CHINESE PISTACHE (M) 2.5" B&B 40' HT. X 30' SPR. SHRUBS AND GROUNDCOVERS - REFERENCE DETAIL 3-4/L501 ۲ UPRIGHT GERMANDER TEUCRIUM CHAMAEDRYS (L) 1-GAL 2' HT. X 2' SPR. $\langle \cdot \rangle$ 92 CYTISUS X PRAECOX 'ALLGOLD ALL GOLD SCOTCH BROOM (L) 5-GAL 5' HT. X 5' SPR. \bigcirc FALLUGIA PARADOXA APACHE PLUME (L) 78 5-GAL 5' HT. X 5' SPR. JUNIPERUS HORIZONTALIS 'BLUE CHIP' 5-GAL BLUE CHIP JUNIPER (M) 8" HT. X 8' SPR. NANDINA DOMESTICA 'MONFAR' SIENNA SUNRISE HEAVENLY BAMBOO (M 3' HT. X 2' SPR. 5-GAL 96 \bigcirc × BUDDLEJA DAVIDII 'NANHO BLUE' BUDDLEIA NANHO BLUE 5' HT. X 5' SPR. 73 5-GAL **MULCHES** 1" AMARETTO BROWN CRUSHED GRAVEL MULCH AT 3" DEPTH OVER 37,574 SF FILTER FABRIC 2"-4" COYOTE MIST COBBLE AT 4" DEPTH OVER FILTER FABRIC 12,444 SF AT HEADER CURBS OR SLOPES GREATER THAN 4:1 PLACE 4-8" COYOTE MIST COBBLE AT 8" DEPTH OVER FILTER FABRIC **EXISTING LANDSCAPE LEGEND** QTY. SYMBOL DESCRIPTION EXISTING TREES TO REMAIN WITHIN IMPROVEMENT AREA

(AVERAGE SPREAD 25' FOR CALCULATIONS) EXISTING TREE TO BE REMOVED (DUE TO HEALTH OR LOCATION) EXISTING BUILDING, SITE AND LANDSCAPE TO REMAIN (EXISTING IRRIGATION TO REMAIN AND MUST BE PROVIDED TO EXISTING LANDSCAPE AREAS TO REMAIN)

LANDSCAPE NOTES AND CALCULATIONS

IRRIGATION IRRIGATION SYSTEM STANDARDS OUTLINED IN THE WATER CONSERVATION LANDSCAPING AND WATER WASTE ORDINANCE SHALL BE STRICTLY ADHERED TO. A FULLY AUTOMATED IRRIGATION SYSTEM WILL BE USED TO IRRIGATE TREE, SHRUB AND GROUNDCOVER PLANTING AREAS. THE IRRIGATION SYSTEM SHALL BE DESIGNED TO ISOLATE PLANT MATERIAL ACCORDING TO SOLAR EXPOSURE AND WILL BE SET UP BY PLANT ZONES ACCORDING TO WATER REQUIREMENTS. THE TREES WILL BE PROVIDED WITH (6) 2 GPH EMITTERS, WITH THE ABILITY TO BE EXPANDED TO ACCOMMODATE THE GROWTH OF THE TREE. SHRUBS AND GROUNDCOVERS WILL BE PROVIDED WITH (2) 1 GPH EMITTERS. TREES, SHRUBS AND GROUNDCOVERS WILL BE GROUPED ON THE

SAME VALVE.

RESPONSIBILITY OF MAINTENANCE MAINTENANCE OF ALL PLANTING AND IRRIGATION, INCLUDING THOSE WITHIN THE PUBLIC R.O.W., SHALL BE THE RESPONSIBILITY OF THE PROPERTY OWNER.

METHOD FOR COMPLYING WITH WATER CONSERVATION

ORDINANCE THE PLANT PALETTE IS PREDOMINANTLY COMPRISED OF PLANTS WITH LOW TO MEDIUM WATER USE REQUIREMENTS. THEREBY MINIMIZING IRRIGATION NEEDS WHILE ENSURING THE VIABILITY OF THE PLANTS.

PNM COORDINATION

32


COORDINATION WITH PNM'S NEW SERVICE DELIVERY DEPARTMENT IS NECESSARY REGARDING PROPOSED TREE LOCATION AND HEIGHT, SIGN LOCATION AND HEIGHT, AND LIGHTING HEIGHT IN ORDER TO ENSURE SUFFICIENT SAFETY CLEARANCES.

SCREENING WILL BE DESIGNED TO ALLOW FOR ACCESS TO ELECTRIC UTILITIES. IT IS NECESSARY TO PROVIDE ADEQUATE

CLEARANCE OF TEN FEET IN FRONT AND AT LEAST 5 FEET ON THE REMAINING THREE SIDES SURROUNDING ALL GROUND-MOUNTED EQUIPMENT FOR SAFE OPERATION, MAINTENANCE AND REPAIR PURPOSES.

CLEAR SIGHT DISTANCE:

LANDSCAPING AND SIGNAGE WILL NOT INTERFERE WITH CLEAR SIGHT REQUIREMENTS. THEREFORE, SIGNS, WALLS, TREES, AND SHRUBBERY BETWEEN 3 AND 8 FEET TALL (AS MEASURED FROM THE GUTTER PAN) WILL NOT BE ACCEPTABLE IN THE AREA.

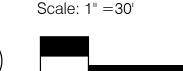



LANDSCAPE AREA COVERAGE LANDSCAPE AREA TO BE RENNOVATED:

50,018 SF (EXCLUDING BUILDING AND PARKING LOTS TO REMAIN)

CITY SUBMITTAL NOTES

GENERAL NOTES

OPERATIONS.

OR EQUAL.

TAKE PRECEDENCE.

1. THE LANDSCAPE PLAN ON FILE FOR THIS SITE

WILL BE MODIFIED TO A DRIP SYSTEM.

2. ADDITIONAL PLANTINGS WILL BE PLACED TO

ENHANCE THE EXISTING LANDSCAPE AREAS.

1. PRIOR TO BEGINNING WORK ON THE PROJECT, THE LANDSCAPE CONTRACTOR SHALL REVIEW THE

PROJECT IN THE FIELD WITH THE OWNER'S

REPRESENTATIVE. IF DISCREPANCIES OCCUR

BETWEEN THE DRAWINGS AND THE SITE, THE

LANDSCAPE CONTRACTOR SHALL NOTIFY THE

3. ALL PLANTING AREAS ARE TO HAVE WEEDS AND COMPETITIVE VEGETATION REMOVED PRIOR TO

TO REFUSE ANY PLANT MATERIAL DEEMED

TO APPROVE ANY AND ALL SUBSTITUTIONS. 5. FILTER FABRIC TO BE DEWITT PRO-5 WEED CONTROL,

6. PLANT QUANTITIES ARE PROVIDED FOR

2. IT IS THE LANDSCAPE CONTRACTOR'S

PREPARATION FOR PLANTING.

OWNER'S REPRESENTATIVE FOR CLARIFICATION PRIOR TO PROCEEDING ON THAT PORTION OF WORK.

RESPONSIBILITY TO LOCATE ALL UNDERGROUND UTILITIES PRIOR TO COMMENCEMENT OF PLANTING

4. THE OWNER'S REPRESENTATIVE SHALL APPROVE ALL

PLANT MATERIAL PRIOR TO PLANTING. IN ADDITION, THE OWNER REPRESENTATIVE RESERVES THE RIGHT

UNACCEPTABLE. THE OWNER'S REPRESENTATIVE IS

CONTRACTOR'S CONVENIENCE ONLY, PLANS SHALL

DEVELOPMENT PLAN WAS ILLEGIBLE. THE PLAN

CHANGES WILL ONLY ADDRESS REMOVAL OF TREES LOCATED WITHIN THE NEW SIDEWALK IMPROVEMENT

AND ALL OTHER EXISTING TREES WILL REMAIN. ALL EXISTING TURF GRASS HAS DIED AND WILL BE

REPLACED WITH GRAVEL OR COBBLE OVER FILTER

FABRIC. THE EXISTING SPRAY IRRIGATION SYSTEM

LANDSCAPE LIVE VEGETATIVE COVERAGE

LANDSCAPE COVERAGE REQUIREMENTS SPECIFY TREE CANOPIES AND GROUND-LEVEL PLANTS SHALL COVER A MINIMUM OF 75%. A MINIMUM OF 25% SHALL BE PROVIDED AS GROUND-LEVEL PLANTS (SHRUBS, GRASSES, ETC.) OF THE REQUIRED VEGETATIVE COVERAGE.

REQUIRED LIVE VEGETATIVE MATERIAL COVERAGE (75%)	37,514 SF
PROVIDED LIVE VEGETATIVE MATERIAL COVERAGE 88%)	44,253 SF
REQUIRED GROUND-LEVEL PLANT COVERAGE (25%)	9,378 SF
PROVIDED GROUND-LEVEL PLANT COVERAGE	9,510 SF

STREET TREES

(25%)

STREET TREE REQUIREMENTS SPECIFY THE SPACING BETWEEN STREET TREES, WITHIN THE PUBLIC RIGHT-OF-WAY, SHALL BE INSTALLED AT A FREQUENCY OF 30 FEET PER LINEAR FOOT OF STREET FRONTAGE.

MONTBEL LOOP NE: LOCAL - NO STREET TREES REQUIRED - PROVIDED TREES: 20


MONTBEL PLACE NE: LOCAL - NO STREET TREES REQUIRED - PROVIDED TREES: 11

JOAN HILL PL NE: LOCAL - NO STREET TREES REQUIRED


- PROVIDED TREES: 5

ALEXANDER BLVD - 561 LF - REQUIRED TREES: 19

- PROVIDED: 20 TREES

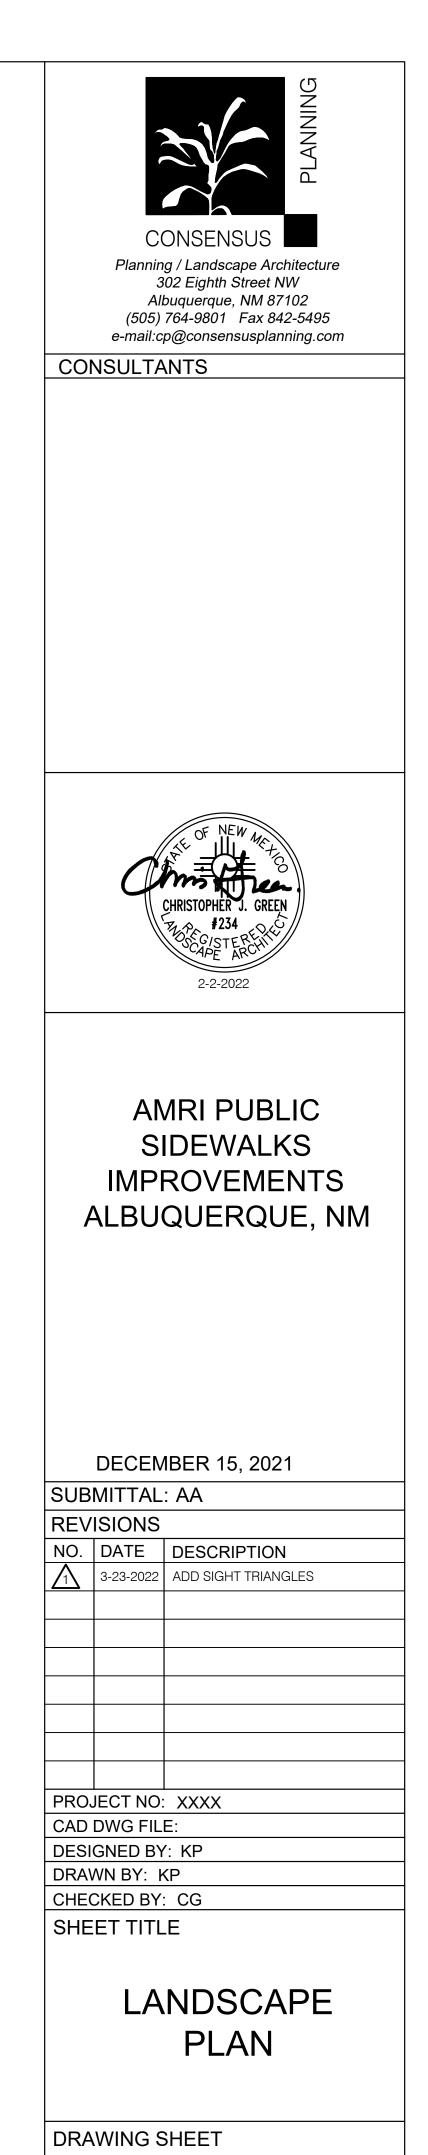

L101

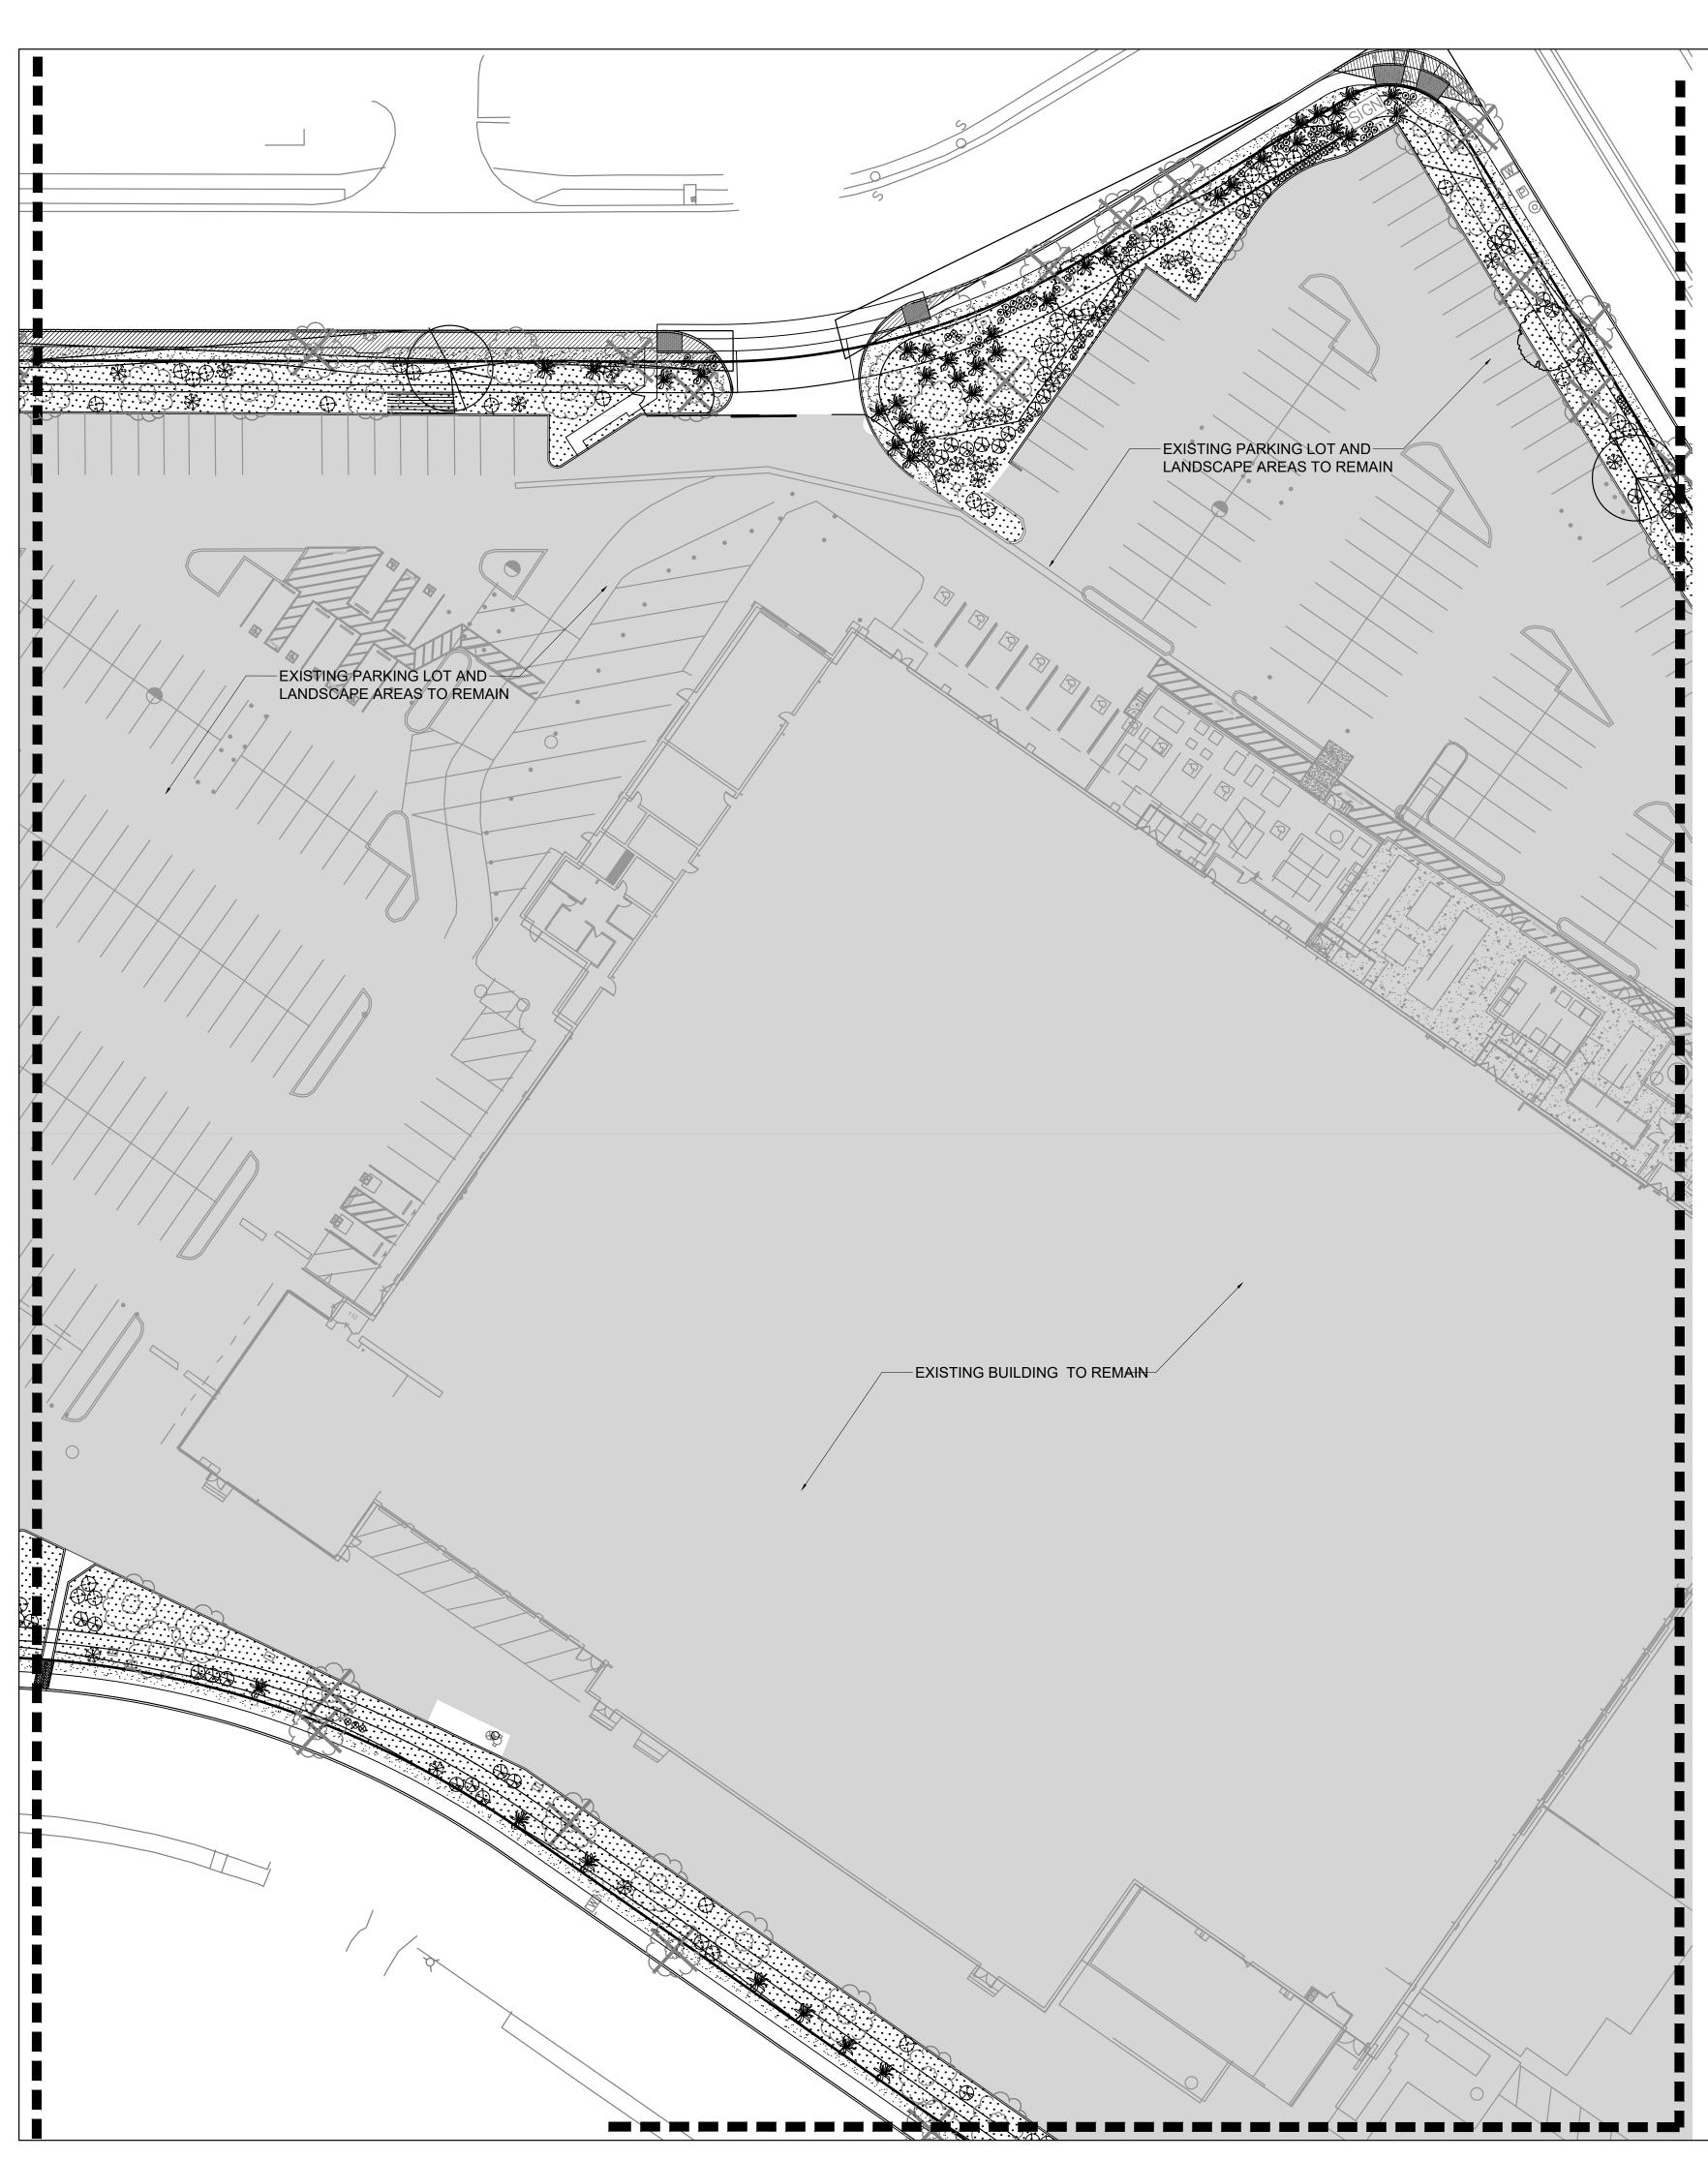

PLANT LEGEND

_	SYMBOL	SCIENTIFIC NAME COMMON NAME (WATER USE)	SIZE	MATURE SIZE
	m	TREES - REFERENCE DETAIL 1-2/L501		
/	$\left(\cdot \right)$	CHILOPSIS LINEARIS DESERT WILLOW 'BUBBA' (RW)	24"-BOX	20' HT. X 25' SPR.
		PISTACIA CHINENSIS CHINESE PISTACHE (M)	2.5" B&B	40' HT. X 30' SPR.
~				
		SHRUBS AND GROUNDCOVERS - REFER	ENCE DET	AIL 3-4/L501
	٠	UPRIGHT GERMANDER TEUCRIUM CHAMAEDRYS (L)	1-GAL	2' HT. X 2' SPR.
	(\cdot)	CYTISUS X PRAECOX 'ALLGOLD' ALL GOLD SCOTCH BROOM (L)	5-GAL	5' HT. X 5' SPR.
	\bigcirc	FALLUGIA PARADOXA APACHE PLUME (L)	5-GAL	5' HT. X 5' SPR.
	-	JUNIPERUS HORIZONTALIS 'BLUE CHIP' BLUE CHIP JUNIPER (M)	5-GAL	8" HT. X 8' SPR.
	\oplus	NANDINA DOMESTICA 'MONFAR' SIENNA SUNRISE HEAVENLY BAMBOO (M	5-GAL ⁄/)	3' HT. X 2' SPR.
	${\longrightarrow}$	BUDDLEJA DAVIDII 'NANHO BLUE' BUDDLEIA NANHO BLUE	5-GAL	5' HT. X 5' SPR.
		MULCHES		
		1" AMARETTO BROWN CRUSHED GRAVE FILTER FABRIC	L MULCH A	T 3" DEPTH OVER
		2"-4" COYOTE MIST COBBLE AT 4" DEPTH AT HEADER CURBS OR SLOPES GREATE COYOTE MIST COBBLE AT 8" DEPTH OVE	ER THAN 4:	1 PLACE 4-8"

EXISTING LANDSCAPE LEGEND


SYMBOL DESCRIPTION



EXISTING TREES TO REMAIN WITHIN IMPROVEMENT AREA (AVERAGE SPREAD 25' FOR CALCULATIONS)

EXISTING TREE TO BE REMOVED (DUE TO HEALTH OR LOCATION)

EXISTING BUILDING, SITE AND LANDSCAPE TO REMAIN (EXISTING IRRIGATION TO REMAIN AND MUST BE PROVIDED TO EXISTING LANDSCAPE AREAS TO REMAIN)

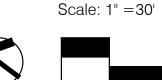

15 0

NORTH




IATURE SIZE

CITY SUBMITTAL NOTES 1. THE LANDSCAPE PLAN ON FILE FOR THIS SITE DEVELOPMENT PLAN WAS ILLEGIBLE. THE PLAN CHANGES WILL ONLY ADDRESS REMOVAL OF TREES LOCATED WITHIN THE NEW SIDEWALK IMPROVEMENT AND ALL OTHER EXISTING TREES WILL REMAIN. ALL EXISTING TURF GRASS HAS DIED AND WILL BE REPLACED WITH GRAVEL OR COBBLE OVER FILTER FABRIC. THE EXISTING SPRAY IRRIGATION SYSTEM WILL BE MODIFIED TO A DRIP SYSTEM.

2. ADDITIONAL PLANTINGS WILL BE PLACED TO ENHANCE THE EXISTING LANDSCAPE AREAS.

GENERAL NOTES

- 1. PRIOR TO BEGINNING WORK ON THE PROJECT, THE LANDSCAPE CONTRACTOR SHALL REVIEW THE PROJECT IN THE FIELD WITH THE OWNER'S REPRESENTATIVE. IF DISCREPANCIES OCCUR BETWEEN THE DRAWINGS AND THE SITE, THE LANDSCAPE CONTRACTOR SHALL NOTIFY THE OWNER'S REPRESENTATIVE FOR CLARIFICATION PRIOR TO PROCEEDING ON THAT PORTION OF WORK.
- 2. IT IS THE LANDSCAPE CONTRACTOR'S RESPONSIBILITY TO LOCATE ALL UNDERGROUND UTILITIES PRIOR TO COMMENCEMENT OF PLANTING OPERATIONS.
- 3. ALL PLANTING AREAS ARE TO HAVE WEEDS AND COMPETITIVE VEGETATION REMOVED PRIOR TO PREPARATION FOR PLANTING.
- 4. THE OWNER'S REPRESENTATIVE SHALL APPROVE ALL PLANT MATERIAL PRIOR TO PLANTING. IN ADDITION, THE OWNER REPRESENTATIVE RESERVES THE RIGHT TO REFUSE ANY PLANT MATERIAL DEEMED UNACCEPTABLE. THE OWNER'S REPRESENTATIVE IS TO APPROVE ANY AND ALL SUBSTITUTIONS.
- 5. FILTER FABRIC TO BE DEWITT PRO-5 WEED CONTROL, OR EQUAL.6. PLANT QUANTITIES ARE PROVIDED FOR CONTRACTOR'S CONVENIENCE ONLY, PLANS SHALL
- TAKE PRECEDENCE.

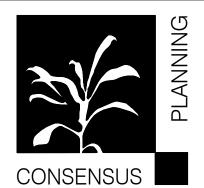

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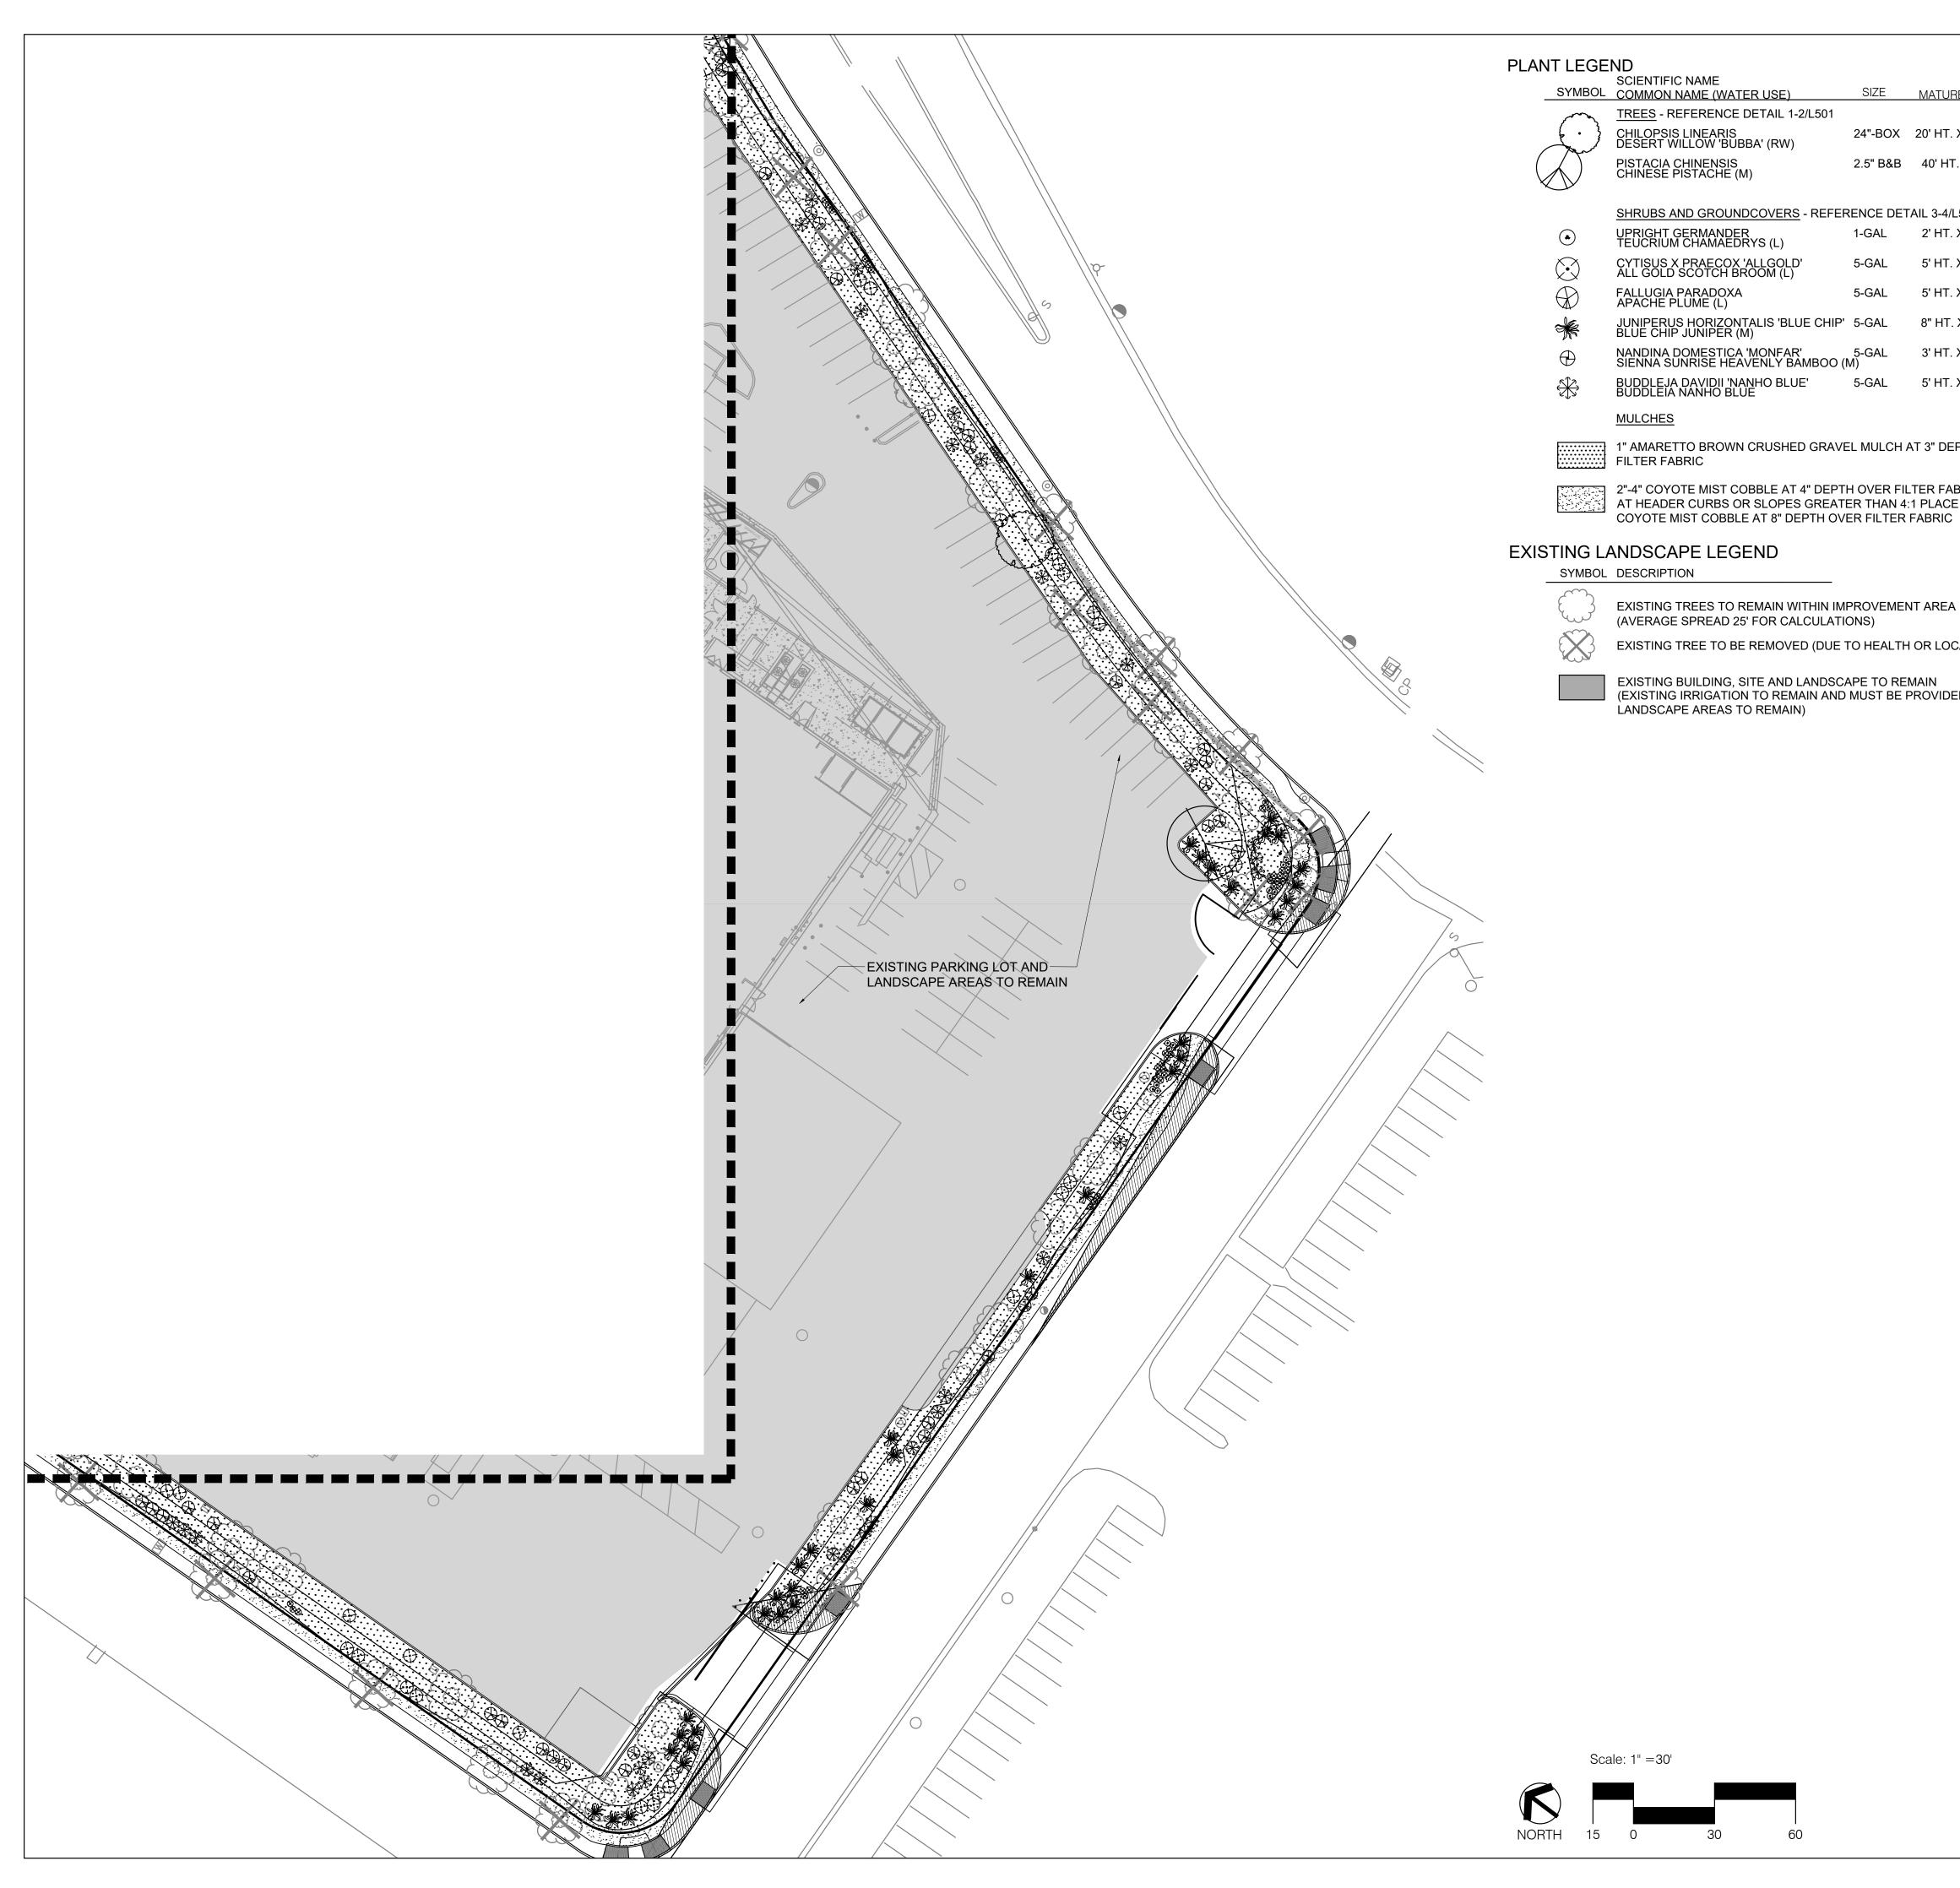


AMRI PUBLIC SIDEWALKS IMPROVEMENTS ALBUQUERQUE, NM

DECEMBER 15, 2021

SUBMITTAL: AA				
REV	REVISIONS			
NO.	DATE	DESCRIPTION		
	3-23-2022	ADD SIGHT TRIANGLES		
PRO	JECT NO:	XXXX		
CAD	CAD DWG FILE:			
DESIGNED BY: KP				
DRAWN BY: KP				
CHECKED BY: CG				
SHE	SHEET TITLE			
	ΙΑ	NDSCAPE		
		PLAN		

DRAWING SHEET



$\left\{\cdot\right\}$	CHILOPSIS LINEARIS DESERT WILLOW 'BUBBA' (RW)	24"-BOX	20' HT. X 25' SPR.
	PISTACIA CHINENSIS CHINESE PISTACHE (M)	2.5" B&B	40' HT. X 30' SPR.
	SHRUBS AND GROUNDCOVERS - REFER	RENCE DET	AIL 3-4/L501
۲	UPRIGHT GERMANDER TEUCRIUM CHAMAEDRYS (L)	1-GAL	2' HT. X 2' SPR.
(\bullet)	CYTISUS X PRAECOX 'ALLGOLD' ALL GOLD SCOTCH BROOM (L)	5-GAL	5' HT. X 5' SPR.
\bigcirc	FALLUGIA PARADOXA APACHE PLUME (L)	5-GAL	5' HT. X 5' SPR.
×	JUNIPERUS HORIZONTALIS 'BLUE CHIP' BLUE CHIP JUNIPER (M)	5-GAL	8" HT. X 8' SPR.
\oplus	NANDINA DOMESTICA 'MONFAR' SIENNA SUNRISE HEAVENLY BAMBOO (M	5-GAL M)	3' HT. X 2' SPR.
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EXISTING TREE TO BE REMOVED (DUE TO HEALTH OR LOCATION)

EXISTING BUILDING, SITE AND LANDSCAPE TO REMAIN (EXISTING IRRIGATION TO REMAIN AND MUST BE PROVIDED TO EXISTING LANDSCAPE AREAS TO REMAIN)

SIZE MATURE SIZE

R FABRIC LACE 4-8"

CITY SUBMITTAL NOTES 1. THE LANDSCAPE PLAN ON FILE FOR THIS SITE DEVELOPMENT PLAN WAS ILLEGIBLE. THE PLAN CHANGES WILL ONLY ADDRESS REMOVAL OF TREES LOCATED WITHIN THE NEW SIDEWALK IMPROVEMENT AND ALL OTHER EXISTING TREES WILL REMAIN. ALL EXISTING TURF GRASS HAS DIED AND WILL BE REPLACED WITH GRAVEL OR COBBLE OVER FILTER FABRIC. THE EXISTING SPRAY IRRIGATION SYSTEM WILL BE MODIFIED TO A DRIP SYSTEM.

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GENERAL NOTES

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CONSENSUS

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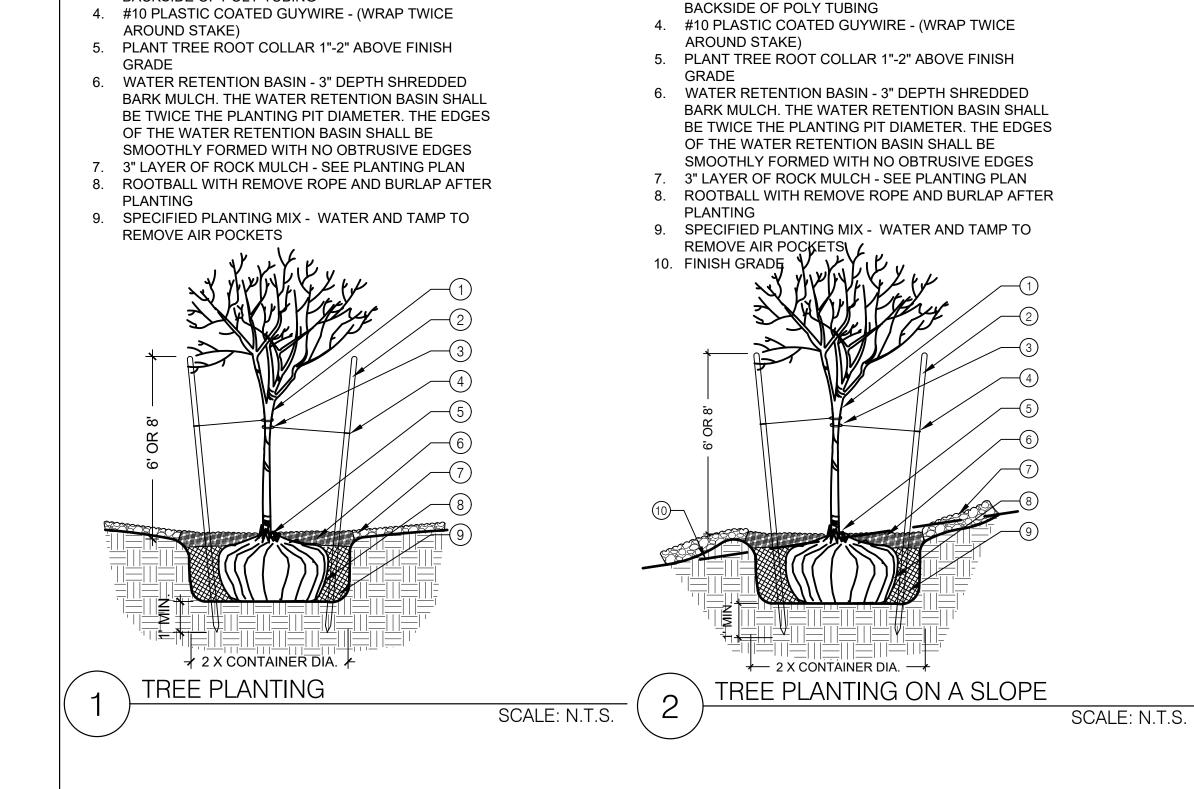


AMRI PUBLIC SIDEWALKS IMPROVEMENTS ALBUQUERQUE, NM

DECEMBER 15, 2021

SUBMITTAL: AA			
REVISIONS			
NO.	DATE	DESCRIPTION	
Λ	3-23-2022	ADD SIGHT TRIANGLES	
PRO	JECT NO:	XXXX	
CAD	CAD DWG FILE:		
	DESIGNED BY: KP		
	DRAWN BY: KP		
CHEC	CHECKED BY: CG		
SHE	SHEET TITLE		
LANDSCAPE PLAN			

DRAWING SHEET



1. STRESS POINT OF TREE

2. 8' OR 10' LODGEPOLE STAKES DRIVEN AT ANGLE (8'


3. 5/8" BLACK POLY TUBING, 12"-15" LONG MIN., NOTCH

FOR MULTI OR CANOPY, 10' FOR TALL COLUMNAR)

FOR MULTI OR CANOPY, 10' FOR TALL COLUMNAR) 3. 5/8" BLACK POLY TUBING, 12"-15" LONG MIN., NOTCH

BACKSIDE OF POLY TUBING

- 1. STRESS POINT OF TREE 2. 8' OR 10' LODGEPOLE STAKES DRIVEN AT ANGLE (8'

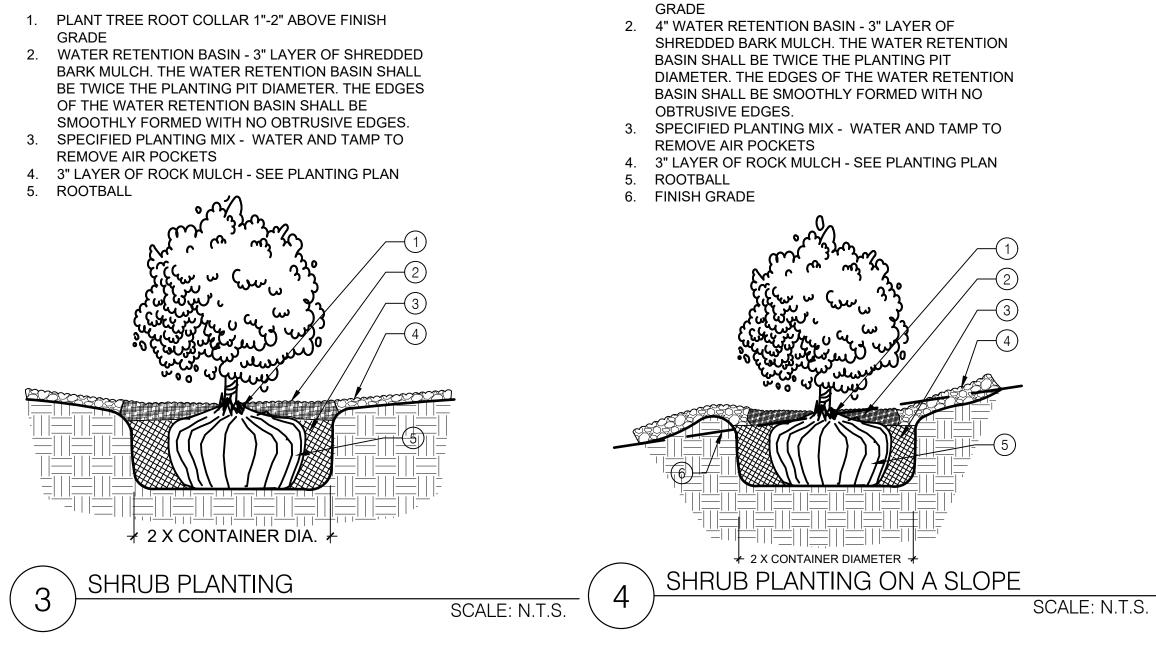

1. PLANT TREE ROOT COLLAR 1"-2" ABOVE FINISH

CONSENSUS Planning / Landscape Architecture 302 Eighth Street NW Albuquerque, NM 87102 (505) 764-9801 Fax 842-5495 e-mail:cp@consensusplanning.com
CHRISTOPHER J. GREEN 2-2-2022
AMRI PUBLIC SIDEWALKS IMPROVEMENTS ALBUQUERQUE, NM
DECEMBER 15, 2021 SUBMITTAL: AA REVISIONS NO. DATE DESCRIPTION Image: ADD SIGHT TRIANGLES ADD SIGHT TRIANGLES Image: ADD SIGHT TRIANGLES Image: ADD SIGHT TRIANGLES
PROJECT NO: XXXX CAD DWG FILE: DESIGNED BY: KP DRAWN BY: KP CHECKED BY: CG SHEET TITLE LANDSCAPE DETAILS
DRAWING SHEET