# CITY OF ALBUQUERQUE

Planning Department Alan Varela, Director



Mayor Timothy M. Keller

May 23, 2024

Alex Forrester Bowman Engineering 11475 Great Oaks Way Alpharetta, GA 30022

Re: Chick-Fil-A

5031 Montgomery Blvd. NE Traffic Circulation Layout

Engineer's Stamp 05-23-24 (F17-D034)

Dear Ms. Forrester,

The TCL submittal received 05-17-2024 is approved for Building Permit by Transportation. A copy of the stamped and signed plan will be needed for each of the building permit plans. Please keep the original to be used for certification of the site for final C.O. for Transportation.

PO Box 1293

Albuquerque

When the site construction is completed and an inspection for Certificate of Occupancy (C.O.) is requested, use the original City stamped approved TCL for certification. Redline any minor changes and adjustments that were made in the field. A NM registered architect or engineer must stamp, sign, and date the certification TCL along with indicating that the development was built in "substantial compliance" with the TCL. Submit this certification, the TCL, and a completed <u>Drainage and Transportation Information Sheet</u> to front counter personnel for log in and evaluation by Transportation.

NM 87103

Once verification of certification is completed and approved, notification will be made to Building Safety to issue Final C.O. To confirm that a final C.O. has been issued, call Building Safety at 924-3690.

www.cabq.gov


Sincerely,


Ernest Armijo, P.E.

Principal Engineer, Planning Dept. Development Review Services

Development Review Services

C: CO Clerk, File

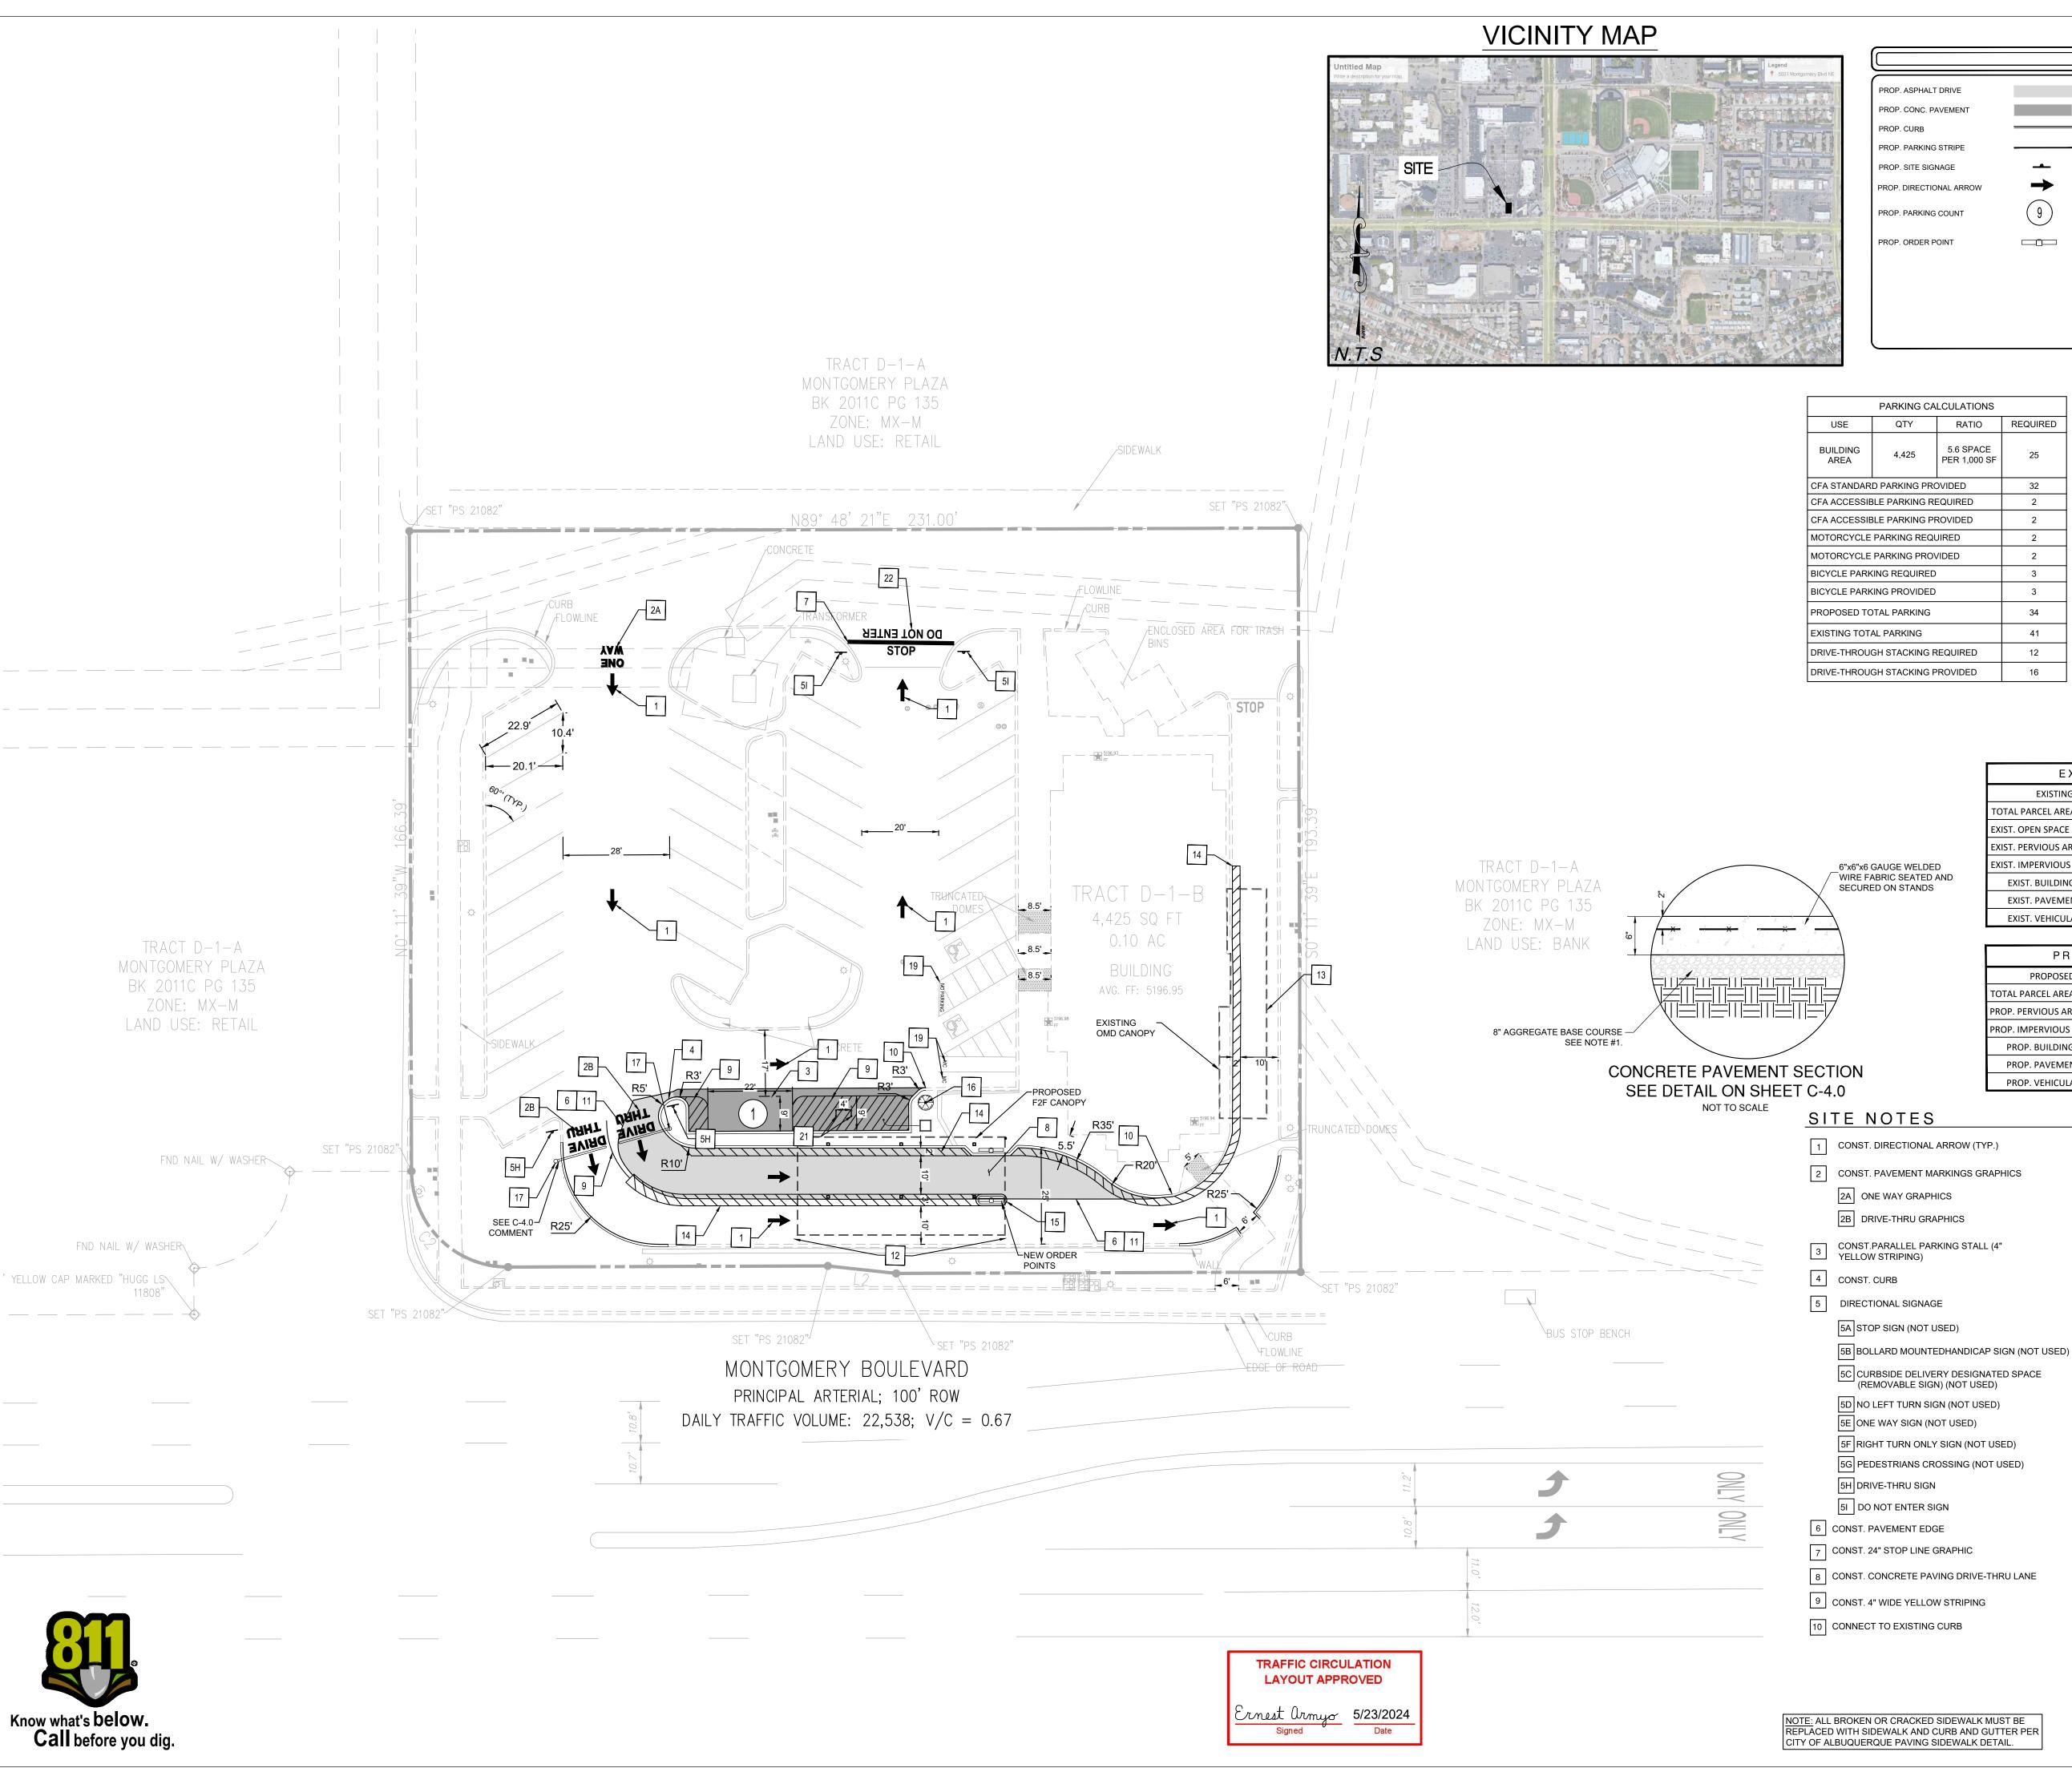

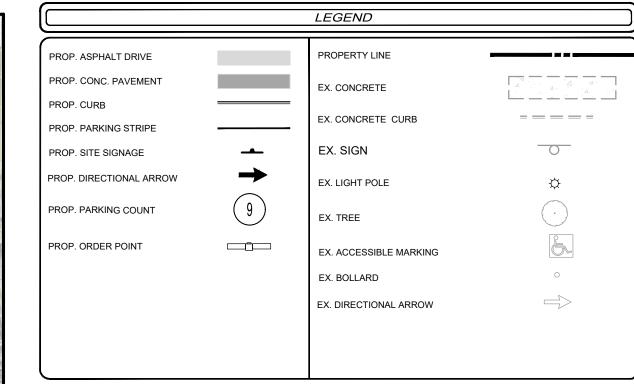

PARKING CALCULATIONS				
USE	QTY	RATIO	REQUIRED	
BUILDING AREA	4,425	5.6 SPACE PER 1,000 SF	25	
CFA STANDARD PARKING PROVIDED			32	
CFA ACCESSIBLE PARKING REQUIRED		2		
CFA ACCESSIBLE PARKING PROVIDED			2	
MOTORCYCLE PARKING REQUIRED		2		
MOTORCYCLE PARKING PROVIDED		2		
BICYCLE PARKING REQUIRED			3	
BICYCLE PARKING PROVIDED			3	
PROPOSED TOTAL PARKING		34		
EXISTING TOTAL PARKING		41		
DRIVE-THROUGH STACKING REQUIRED		12		
DRIVE-THROUGH STACKING PROVIDED		16		

SITE SUMMARY			
JURISDICTION	CITY OF ALBURQUEQUE		
ZONING	MX-M (MIXED USE MEDIUM INTENSITY ZONE DISTRICT)		
USE	FAST FOOD RESTAURANT WITH DRIVE THRU		
PARCEL ID	ABQ213744(CITY), 101706148301640115(COUNTY)		
LOT			
SIZE	44,304.52 SF (1.02 AC)		
BUILDING			
SIZE	4,425 SF		
PARKING			
SIZE	9' X 19' (60°) ; 9' X 22' (PARALLEL)		

BUILDING SETBACKS				
SETBACKS	REQUIRED	PROVIDED		
FRONT (SOUTH)	5'	28.79'		
REAR (NORTH)	15'	58.94'		
SIDE (WEST	0'	166.33'		
SIDE (EAST)	0'	19.04'		

EXISTING SITE CALCULATIONS					
EXISTING AREA	SF	ACRES	%		
TOTAL PARCEL AREA	44,304	1.02	100.00%		
EXIST. OPEN SPACE AREA	7,135	0.16	16.10%		
EXIST. PERVIOUS AREA	7,135	0.16	16.10%		
EXIST. IMPERVIOUS AREA	37,169	0.85	83.90%		
EXIST. BUILDING AREA	4,425	0.10	9.99%		
EXIST. PAVEMENT AREA	32,744	0.75	73.91%		
EXIST. VEHICULAR USE AREA	26,516	0.61	59.85%		

PROPOSED SITE CALCULATIONS						
PROPOSED AREA	SF	ACRES	%			
TOTAL PARCEL AREA	44,304	1.02	100.00%			
PROP. PERVIOUS AREA	6,994	0.16	15.79%			
PROP. IMPERVIOUS AREA	37,310	0.86	84.21%			
PROP. BUILDING AREA	4,425	0.10	9.99%			
PROP. PAVEMENT AREA	32,885	0.75	74.23%			
PROP. VEHICULAR USE AREA	27,284	0.63	61.58%			

11 CONNECT TO EXISTING EDGE OF PAVEMENT

12 CONST. DOUBLE LANE F2F ORDER CANOPY

EXISTING SINGLE ORDER MEAL DELIVERY CANOPY TO REMAIN

CONST. SOLID 4" YELLOW STRIPING ON ENDS W/ 4" WIDE STRIPES @ 3' O.C., YELLOW REFLECTIVE PAINT WITH ANTI-SLIP ADHESIVE

15 NEW ORDER POINT

16 RELOCATED FLAG POLE AND BASE

17 CONST. CLEARANCE BAR

EXISTING BUILDING MOUNTED ACCESSIBLE
PARKING SIGN TO REMAIN - INSTALL PENALTY
SIGN IF NECESSARY

19 "NO PARKING" PAVEMENT MARKING

20 "MC" MOTORCYCLE PAVEMENT MARKING

21 BICYCLE RACKS 22 "DO NOT ENTER" PAVEMENT MARKING

GRAPHIC SCALE (IN FEET)

SCALE: 1'' = 20'

produced for above named project may not be reproduced in any manner without express written or verbal consent from

C-2.0







KAI BURK PE #28466 0

FSU#02793

NO. DATE DESCRIPTION

REVISION SCHEDULE

CONSULTANT PROJECT #010014-01-217 ISSUED FOR

PERMIT DATE May 23, 2024 DRAWN BY Information contained on this drawing and in all digital files


SITE PLAN

SHEET NUMBER


NOTE:

1. GENERAL CONTRACTOR SHALL REFERENCE GEOTECHNICAL

TOTAL SECTION REQUIREMENTS REPORT FOR PAVEMENT SECTION REQUIREMENTS.

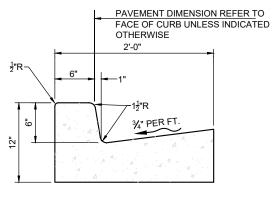

A TYPE "B" CURB & GUTTER

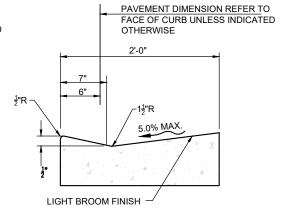

(B) TYPE "H" MOUNTABLE CURB & GUTTER

NOTES:


1. CONC. FOR CURBING SHALL HAVE A MIN. COMPRESSIVE STRENGTH OF 3,500 PSI @ 28 DAYS


2. CONTRACTION JOINTS @ 1-'0" O.C. TOOLED ¼" (± ½,6", -0) WIDE, 1" OR MAX. D/4 DEPTH WHICHEVER IS GREATER. EXPANSION JOINTS @ 40'-0" MAX. UNLESS NOTED OTHERWISE ON PLANS

3. IF NEEDED, DOWEL INTO ADJACENT CONC. SLAB PER THE EXPANSION JOINT DETAIL

4. GUTTER SLOPE TO MATCH ADJACENT PAVEMENT, TRAVERSE &

26 CONCRETE PAVEMENT DRIVE-THRU LANE
C2.0 NOT TO SCALE

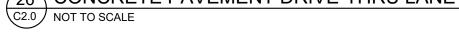

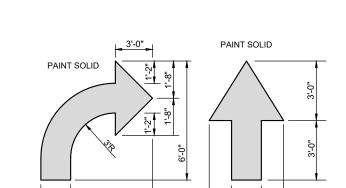

NOT TO SCALE


NOTES:

1. GENERAL CONTRACTOR SHALL REFER TO PARKING LOT STRIPING SPECIFICATIONS, SEE DETAIL 2. PAVEMENT MARKINGS SHALL BE APPLIED ACCORDING TO REQUIREMENTS AS OUTLINED IN SECTION 3B OF THE

CODES DIFFER, IN WHICH CASE THESE CODES SHALL GOVERN.

CURRENT MANUAL ON UNIFORM TRAFFIC CONTROL DEVICES


3. CONTRACTOR SHALL USE WHITE REFLECTIVE PAINT ON ASPHALT & YELLOW REFLECTIVE PAINT ON CONCRETE, UNLESS UPON VERIFICATION BY THE GENERAL CONTRACTOR IT IS DETERMINED THAT LOCAL, STATE, OR ADA 1 PAVEMENT MARKINGS - 1 C2.0 NOT TO SCALE

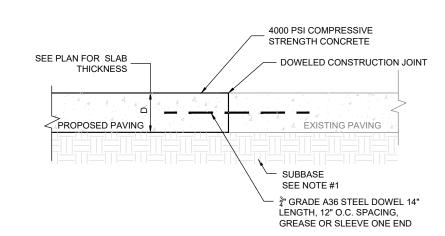

NOTE:

1. GENERAL CONTRACTOR SHALL REFERENCE GEOTECHNICAL REPORT

TRANSVERSE AND

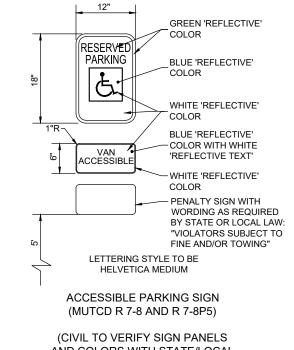


6 ACCESIBLE PARKING SIGN C4.0 NOT TO SCALE

AND COLORS WITH STATE/LOCAL REQUIREMENTS)

22 LONGITUDINAL DOWELED CONSTRUCTION JOINT NOT TO SCALE

TRAFFIC CIRCULATION LAYOUT APPROVED Ernest armyo 5/23/2024

11 CONCRETE CURB & GUTTER C2.0 NOT TO SCALE

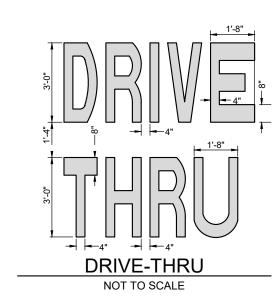

NOTES:

1. GENERAL CONTRACTOR SHALL REFER TO PARKING LOT STRIPING SPECIFICATIONS, SEE DETAIL 2. PAVEMENT MARKINGS SHALL BE APPLIED


ACCORDING TO REQUIREMENTS AS OUTLINED IN SECTION 3B OF THE CURRENT MANUAL ON UNIFORM TRAFFIC CONTROL DEVICES

CONTRACTOR SHALL USE WHITE REFLECTIVE PAINT ON ASPHALT & YELLOW REFLECTIVE PAINT ON CONCRETE, UNLESS UPON VERIFICATION BY THE GENERAL CONTRACTOR IT IS DETERMINED THAT LOCAL, STATE, OR ADA CODES DIFFER, IN WHICH CASE THESE CODES SHALL GOVERN. 4. IF STOP SIGNS ARE PROPOSED, "STOP" LETTERING ON STOP BAR DETAIL IS NOT REQUIRED.

EDGE OF PAVEMENT OR FACE OF CURB STOP BAR-1'-8" 1'-8" 1'-8" 5 1/2" 10"

STOP BAR NOT TO SCALE

2 PAVEMENT MARKINGS - 2 C2.0 NOT TO SCALE

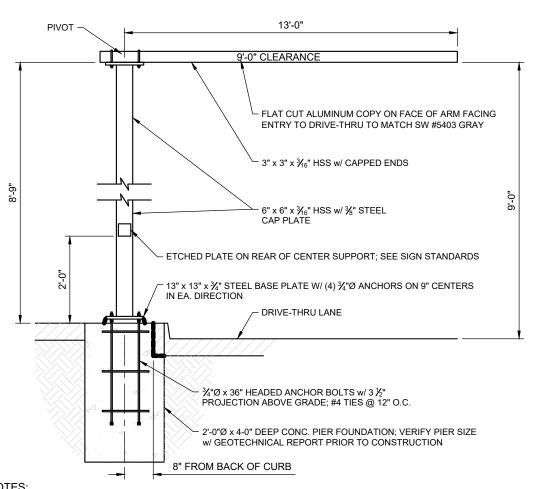

NOTES:

1. ENTIRE CLEARANCE BAR & HARDWARE TO BE POWDER COATED QPC P-820 MATTE BLACK FINISH 2. CLEARANCE BAR ARM TO ROTATE WHEN STRUCK & RETURN TO ORIGINAL POSITION 3. COORDINATE w/ THE ARCHITECT & STRUCTURAL ENGINEER

5 DRIVE-THRU CLEARANCE BAR C2.0 NOT TO SCALE





Chick-fil-A 5200 Buffington Rd Atlanta, GA 30349-2998



FSU#02793

REVISION SCHEDULE NO. DATE DESCRIPTION

CONSULTANT PROJECT #010014-01-217 ISSUED FOR PERMIT DATE May 23, 2024 DRAWN BY Information contained on this drawing and in all digital files

produced for above named project may not be reproduced in any manner without express written or verbal consent from

CFA STANDARD

SHEET NUMBER

Know what's below.

Call before you dig.

7-137 **dpm** 

#### **Section 7-4(J)(7) Entrance and Gate Requirements for Private Ways and Streets**

- 1. All gated communities must include a turnaround for visitors at the gate so
- that the vehicle does not stand in or back into the City right-of-way. 2. Where a single gate is provided, the minimum width shall be 20 feet. For divided streets, the minimum width shall be 12 feet.
- 3. Additional entrance and gate requirements may be required by the Fire

### Part 7-4(K) Off-street Parking and Site Design

This section provides guidance on site design and off-street parking layout. The overall site design shall accommodate all modes of transportation including automobiles, pedestrians, bicyclists, and motorcyclists. To facilitate efficient parking operations, the designer shall also consider the interface of the site with adjacent development areas.

#### Section 7-4(K)(1) General Provisions

- 1. All sites and off-street parking areas shall be designed to comply with ADA/ PROWAG standards.
- 2. The number of off-street, vehicle, bicycle and motorcycle parking spaces shall be provided as established in the <u>IDO Section 14-16-5-5 Parking and</u>
- 3. Site design shall comply with design requirements and landscape buffers established by the <u>IDO Part 14-16-5 Dimensional Standards</u>.
- 4. Parking and site layout shall be designed such that vehicles do not back into the City right-of-way, except single-family dwellings may back into local streets.

### Section 7-4(K)(2) Bicycle Parking

Off-street bicycle parking location, layout and rack options vary widely. The following guidelines shall be considered when placing and designing bicycle parking areas and choosing rack options. Alternative rack design, placement, or installation methods not meeting the guidelines below may be considered and are reviewed on a case-by-case basis by the City Engineer.

- 1. All bicycle racks shall be designed according to the following guidelines: a. The rack shall be a minimum of 30 inches tall and 18 inches wide.
- b. The bicycle frame shall be supported horizontally at two or more places. Comb/toaster racks are not allowed.
- c. The rack shall be designed to support the bicycle in an upright position. See the <u>IDO Section 14-16-5-5(E)</u> for additional information.
- d. The rack allows varying bicycle frame sizes and styles to be attached. e. The user is not required to lift the bicycle onto the bicycle rack.

requirements. (See *FIGURE 7.4.115* for direction on bicycle stall layout.)


f. Each bicycle parking space is accessible without moving another bicycle. 2. Bicycle parking spaces shall be located in a well-lit area, visible from and, where feasible, located within 50 feet of the primary pedestrian entrance it serves. Bicycle rack placement shall meet the following placement

LAST PRINTED: SEPTEMBER 4, 2020

#### / TRANSPORTATION DESIGN/

- a. Bicycle parking shall be separated from vehicle parking areas and driveways by a barrier, such as a curb, rail, or bollard, or be located to
- minimize the possibility of vehicles striking parked bicycles. b. Bicycle racks shall be placed in a designated area and shall not infringe upon the width of the required clear pedestrian access route. (See <u>Part</u>
- c. Bicycle racks shall not be placed directly in front of entrances or in locations that impede pedestrian flow.
- 3. Bicycle racks shall be sturdy and anchored to a concrete pad.
- 4. A 1-foot clear zone around the bicycle parking stall shall be provided. 5. Bicycle parking spaces shall be at least 6 feet long and 2 feet wide.

## FIGURE 7.4.115 Bicycle Parking Stall Layout Options

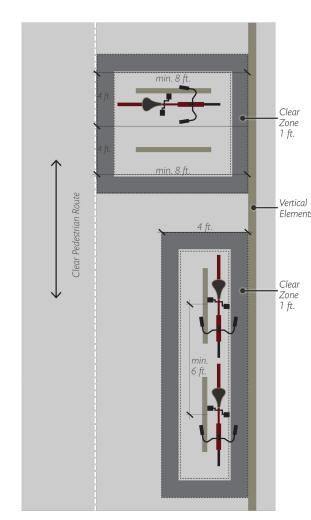



# Section 7-4(K)(3) Motorcycle Parking

- 1. Motorcycle parking shall be a minimum of 4 feet wide and 8 feet long. (See
- <u>TABLE 7.4.77</u> and <u>FIGURE 7.4.116</u>.) 2. Motorcycle parking spaces shall be located in a well-lit area that is visible
- from the primary building entrance on the site.

7-138 **dPm** 

LAST PRINTED: SEPTEMBER 4, 2020

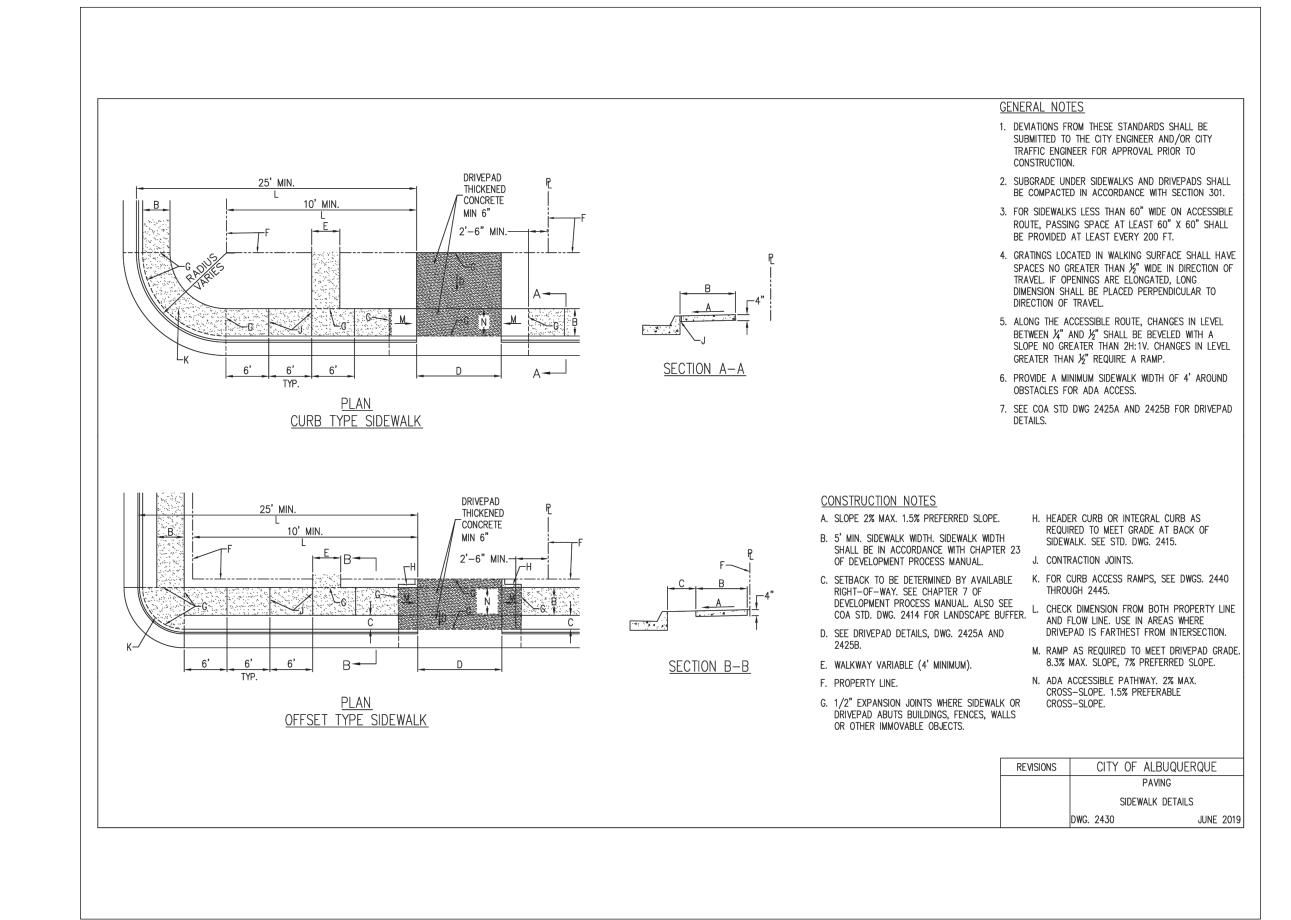

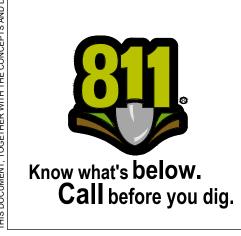



5200 Buffington Rd Atlanta, GA 30349-2998





MO

FSU#02793

REVISION SCHEDULE

NO. DATE DESCRIPTION

CONSULTANT PROJECT #010014-01-217 ISSUED FOR PERMIT May 23, 2024 DRAWN BY

Information contained on this drawing and in all digital files any manner without express written or verbal consent from

STANDARD