

CITY OF ALBUQUERQUE

Planning Department
Alan Varela, Director



Mayor Timothy M. Keller

May 25, 2022

Verlyn Miller, P.E.
Miller Engineering Consultants, Inc
3500 Comanche NE Bldg. F
Albuquerque, NM 87107

**RE: Enterprise Rent-A-Car
5700 San Mateo NE
Grading & Drainage Plans
Engineer's Stamp Date: 05/04/22
Hydrology File: F18D052**

Dear Mr. Miller:

PO Box 1293

Based upon the information provided in your submittal received 05/04/2022, the Grading & Drainage Plans **are not** approved for Building Permit. The following comments need to be addressed for approval of the above referenced project:

Albuquerque

Sheet C-101

NM 87103

1. Stormwater Quality Ponds cannot be built within the City's R.O.W. Either relocate the ponds on-site or use the Waiver of Management Onsite form and request a Payment in Lieu for the required Stormwater Quality Volume.

www.cabq.gov

Sheet C-102


2. Please provide the Benchmark information (location, description and elevation) for the survey contour information provided.
3. Overlaying the latest aerial with the site plan and there are several discrepancies such as the existing landscape areas along the north of the property, and the relocation of the existing ADA spaces. Please verify that an actual topographic survey was done on this site.

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4. Question – Is the southern property also owned by the property owner of 5700 San Mateo? If so, then are they planning to do an updated plat to remove the property line? If not, then Hydrology will need a written permission to grade and do work on that Tract.

As a reminder, if the project total area of disturbance (including the staging area and any work within the adjacent Right-of-Way) is 1 acre or more, then an Erosion and Sediment Control (ESC) Plan and Owner's certified Notice of Intent (NOI) is required to be submitted to the Stormwater Quality Engineer (Doug Hughes, PE, jhughes@cabq.gov, 924-3420) 14 days prior to any earth disturbance.

CITY OF ALBUQUERQUE

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If you have any questions, please contact me at 924-3995 or rbrissette@cabq.gov.

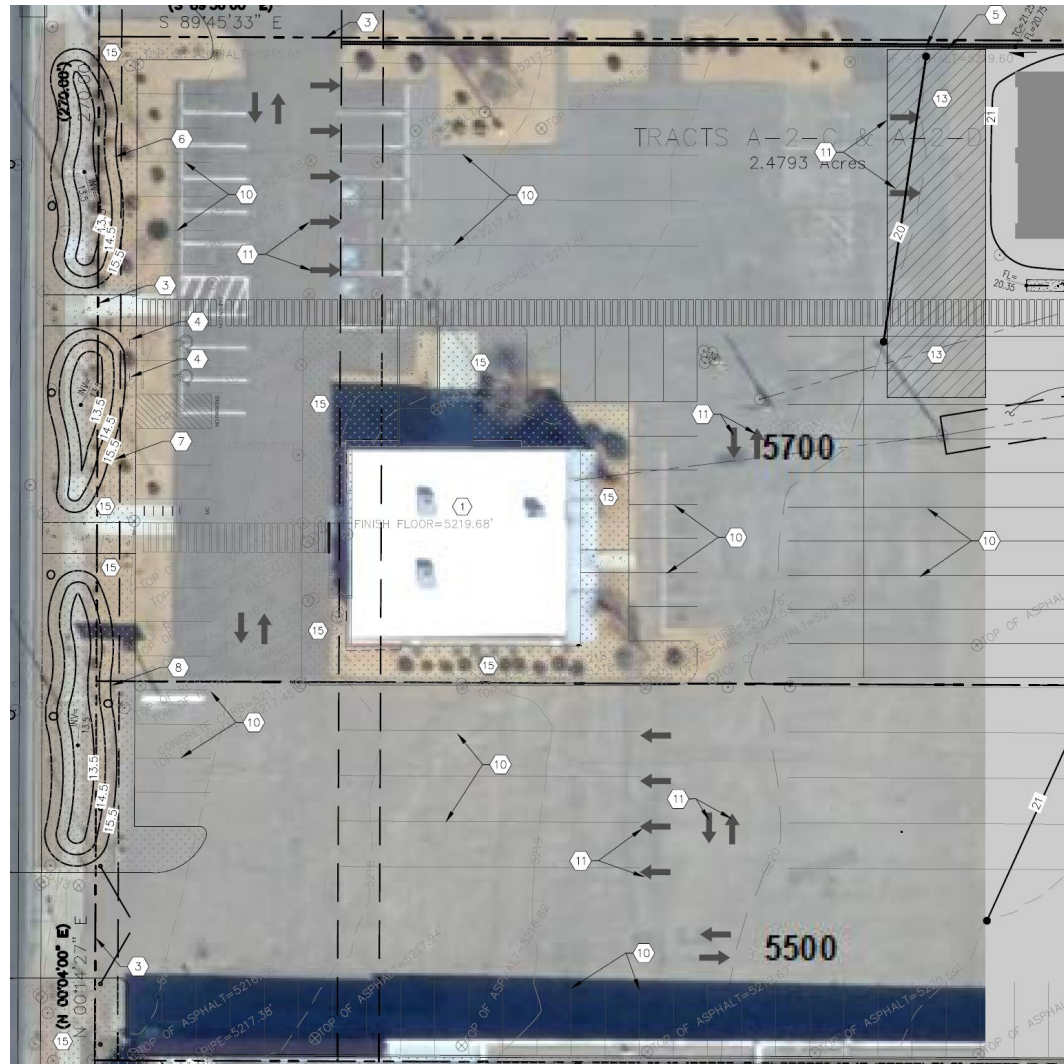Sincerely,

Renée C. Brissette

Renée C. Brissette, P.E. CFM
Senior Engineer, Hydrology
Planning Department

PO Box 1293

Albuquerque

NM 87103

www.cabq.gov



City of Albuquerque

Planning Department
Development & Building Services Division

DRAINAGE AND TRANSPORTATION INFORMATION SHEET (REV 6/2018)

Project Title: Enterprise Rent-A-Car Building Permit #: _____ Hydrology File #: _____
DRB#: _____ **EPC#:** _____ **Work Order#:** _____
Legal Description: TR A2C PLAT OF TRS A2A, A2B, A2C & A2D A REPL OF TRS A2A & A 2B SPANISH LAND CO SUBD CONT 1.5611 AC M/L
City Address: 5700 San Mateo NE, Albuquerque, NM 87109

Applicant: Scott C Anderson, AIA And Associates LLC **Contact:** Scott Anderson
Address: 7604 Rio Penasco Court NW, Albuquerque, NM 87120
Phone#: 505-401-7575 **Fax#:** _____ **E-mail:** scott@scaarchitects.com

Other Contact: Miller Engineering Consultants, Inc. **Contact:** Verlyn Miller
Address: 3500 Comanche NE, Bldg. F
Phone#: 505-888-7500 **Fax#:** _____ **E-mail:** vmiller@mecnm.com

TYPE OF DEVELOPMENT: _____ PLAT (# of lots) _____ RESIDENCE _____ DRB SITE ☒ ADMIN SITE

IS THIS A RESUBMITTAL? _____ Yes ☒ No

DEPARTMENT _____ TRANSPORTATION ☒ HYDROLOGY/DRAINAGE

Check all that Apply:

TYPE OF SUBMITTAL:

- ☐ ENGINEER/ARCHITECT CERTIFICATION
- ☐ PAD CERTIFICATION
- ☐ CONCEPTUAL G & D PLAN
- ☒ GRADING PLAN
- ☐ DRAINAGE REPORT
- ☐ DRAINAGE MASTER PLAN
- ☐ FLOODPLAIN DEVELOPMENT PERMIT APPLIC
- ☐ ELEVATION CERTIFICATE
- ☐ CLOMR/LOMR
- ☐ TRAFFIC CIRCULATION LAYOUT (TCL)
- ☐ TRAFFIC IMPACT STUDY (TIS)
- ☐ STREET LIGHT LAYOUT
- ☐ OTHER (SPECIFY) _____
- ☐ PRE-DESIGN MEETING?

TYPE OF APPROVAL/ACCEPTANCE SOUGHT:

- ☐ BUILDING PERMIT APPROVAL
- ☐ CERTIFICATE OF OCCUPANCY
- ☐ PRELIMINARY PLAT APPROVAL
- ☐ SITE PLAN FOR SUB'D APPROVAL
- ☐ SITE PLAN FOR BLDG. PERMIT APPROVAL
- ☐ FINAL PLAT APPROVAL
- ☐ SIA/ RELEASE OF FINANCIAL GUARANTEE
- ☐ FOUNDATION PERMIT APPROVAL
- ☒ GRADING PERMIT APPROVAL
- ☐ SO-19 APPROVAL
- ☐ PAVING PERMIT APPROVAL
- ☐ GRADING/ PAD CERTIFICATION
- ☐ WORK ORDER APPROVAL
- ☐ CLOMR/LOMR
- ☐ FLOODPLAIN DEVELOPMENT PERMIT
- ☐ OTHER (SPECIFY) _____

DATE SUBMITTED: 5-4-2022 **By:** Verlyn Miller

COA STAFF:

ELECTRONIC SUBMITTAL RECEIVED: _____

FEE PAID: _____

HYDROLOGY REPORT

SITE LOCATION

The existing site is an approximate 2.5-acre site located 5700 San Mateo Boulevard NE in Albuquerque. The site is located on the east side of San Mateo north of Montgomery Boulevard and can be accessed via San Mateo and south of Central Avenue (see vicinity map this sheet).

EXISTING CONDITIONS

The existing site is estimated at 2.5 acres and is mostly developed with a building and asphalt paving. There is a portion of land on the east side of the site that is currently base course. The site currently slopes from the east to west at a mild slope. The site does not lie within a 100-year FEMA floodplain (see FEMA panel on this sheet).

PROPOSED CONDITIONS

The proposed project will consist of a new wash bay facility to be located on the site and new asphalt paving of the eastern base course area of the site. The existing building will remain for the new facility. Storm water quality pond areas will be provided along the western portion of the site. The drainage calculations for proposed conditions are indicated on this sheet.

CONCLUSIONS

When fully developed as indicated on the grading and drainage plan, the increased runoff from the site is estimated at 1.37 cfs and 0.114 acre-feet during the 100-year, 24-hour event. Storm water runoff from the site will discharge into the proposed storm water quality pond. The storm water quality volume for this site is estimated at 3385 cubic feet. The storm water quality pond has a volume of 3547 cubic feet which is greater than the storm water quality volume of 3385 cubic feet. Overflow from the pond will spill to its historical location in San Mateo Boulevard.

GENERAL NOTES:

1. EXISTING TOPOGRAPHIC DATA SHOWN ON THESE PLANS WAS PROVIDED BY HARRIS SURVEYING, INC., CORRALES, NEW MEXICO. MILLER ENGINEERING CONSULTANTS HAS UNDERTAKEN NO FIELD VERIFICATION OF THIS INFORMATION.

2. ACS STA "12-F18" THE BENCHMARK IS LOCATED 5.1 MILES NORTHEAST OF DOWNTOWN ALBUQUERQUE. THE BENCHMARK IS LOCATED AT THE INTERSECTION OF SAN MATEO BLVD. AND MCLEOD RD. NE. THE BENCHMARK IS A 1 3/4" METALLIC DISK EPOXIED TO THE TOP OF CONCRETE STORM DRAIN INLET LOCATED IN THE SOUTHEAST QUADRANT OF THE INTERSECTION, STAMPED "ACS BM 12-F18" THE GROUND ELEV. 5215.969 (NAVD 1988)

3. THE CONTRACTOR IS RESPONSIBLE FOR ALL TEMPORARY SEDIMENT AND EROSION CONTROL DEVICES DURING THE CONSTRUCTION PHASE.

4. CONTRACTOR SHALL OBTAIN A GRADING PERMIT FROM THE CITY OF ALBUQUERQUE, PRIOR TO ANY GRADING OR CONSTRUCTION.

5. TWO WORKING DAYS PRIOR TO ANY EXCAVATION CONTRACTOR MUST CONTACT LINE LOCATING SERVICE 260-1990 FOR LOCATION OF EXISTING UTILITIES.

6. ALL EMBANKMENTS SHALL BE PLACED AND COMPACTED IN LIFTS OF MAXIMUM OF 8". THE EMBANKMENTS SHALL BE WETTED AND COMPACTED TO 95% OPTIMUM DENSITY PER ASTM D1557 AND 95% UNDER ALL STRUCTURES INCLUDING DRIVEWAYS AND PARKING LOTS.

7. MAINTENANCE OF THESE FACILITIES SHALL BE THE RESPONSIBILITY OF THE OWNER(S) OF THE PROPERTY SERVED.

8. THE CONTRACTOR SHALL FIELD VERIFY LOCATION AND SIZE OF ALL UTILITIES PRIOR TO CONSTRUCTION.

9. THE SUBJECT PROPERTY IS LOCATED WITHIN ZONE X (500 YEAR) DESIGNATING AREAS DETERMINED TO BE OUTSIDE THE 100-YEAR FLOOD PLANE ACCORDING TO THE FLOOD INSURANCE RATE MAP, ALBUQUERQUE, NEW MEXICO AND UNINCORPORATED AREAS PER MAP NO 35001C 0139G.
10. ALL WORK PERFORMED SHALL COMPLY WITH THE REQUIREMENTS OF THE CITY OF ALBUQUERQUE STORM DRAINAGE REGULATIONS. ALL WORK PERFORMED SHALL COMPLY WITH THE REQUIREMENTS OF THE CITY OF ALBUQUERQUE "GRADING AND DRAINAGE DESIGN REQUIREMENTS AND POLICIES FOR LAND DEVELOPMENT."

11. THE OWNER, CONTRACTOR AND/OR BUILDER SHALL COMPLY WITH ALL APPROPRIATE LOCAL, STATE AND FEDERAL REGULATIONS AND REQUIREMENTS.

12. THE CONTRACTOR SHALL TAKE ALL APPROPRIATE AND REASONABLE MEASURES TO PREVENT SEDIMENT OR POLLUTANT LADEN STORM WATER FROM EXITING THE SITE DURING CONSTRUCTION. STORMWATER MAY BE DISCHARGED IN A MANNER, WHICH COMPLIES WITH THE APPROVED GRADING AND DRAINAGE PLAN.

13. THE CONTRACTOR SHALL TAKE ALL APPROPRIATE MEASURES TO PREVENT THE MOVEMENT OF CONSTRUCTION RELATED SEDIMENT, DUST, MUD, POLLUTANTS, DEBRIS, WASTE, ETC FROM THE SITE BY WIND, STORM FLOW OR ANY OTHER METHOD EXCLUDING THE INTENTIONAL, LEGAL TRANSPORTATION OF SAME IN A MANNER ACCEPTABLE BY THE CITY.

14. THE CONTRACTOR SHALL NOT DISTURB AREAS OUTSIDE THE AREAS SHOWN AS "SLOPE LIMITS" ON THE GRADING AND DRAINAGE PLAN.

15. SEE ARCHITECTURAL DRAWINGS FOR SIDEWALK AND HANDICAPPED RAMPS, DETAILS AROUND THE BUILDING.

16. THE CONTRACTOR SHALL CONTACT THE PROJECT ENGINEER FOR CLARIFICATION IF THERE ARE ANY SPOT ELEVATIONS ON THE GRADING AND DRAINAGE PLAN WHICH APPEAR TO BE AMBIGUOUS OR DO NOT MEET THE INTENT OF THE GRADING AND DRAINAGE PLAN.

17. THE CONTRACTOR SHALL CONTACT THE PROJECT ENGINEER FOR CLARIFICATION IF THERE ARE SIDEWALKS OR CONCRETE FLATWORK WHICH DOES NOT MEET ADA ACCESSIBILITY REQUIREMENTS. ALL SIDEWALKS SHALL HAVE A MAXIMUM CROSS SLOPE OF 2.0%, ALL SIDEWALKS SHALL HAVE A MAXIMUM LONGITUDINAL SLOPE OF 5.0%, AND ALL RAMPS SHALL HAVE A MAXIMUM LONGITUDINAL SLOPE OF 15:1.

18. ALL SIDEWALKS AND CONCRETE FLATWORK SHALL HAVE A MINIMUM OF 0.5% SLOPE. CONTRACTOR SHALL CONTACT PROJECT ENGINEER IF THERE ARE SIDEWALKS OR CONCRETE FLATWORK WHICH DO NOT MEET THIS REQUIREMENT.

19. THE CONTRACTOR SHALL SUBMIT MATERIAL SUBMITTALS, CUT SHEETS AND SHOP DRAWINGS FOR ALL CIVIL RELATED ITEMS FOR REVIEW PRIOR TO CONSTRUCTION.

20. THIS PROJECT SHALL BE CONSTRUCTED IN ACCORDANCE WITH THE CITY OF ALBUQUERQUE STANDARD SPECIFICATIONS (UPDATE 8, AMENDMENT 1)

21. ALL EXISTING MANHOLES, VALVES AND METERS SHALL BE ADJUSTED TO NEW FINISH GRADE.

DPM HYDROLOGY CALCULATIONS

HYDROLOGY										
Precipitation Zone 3 - 100-year Storm			P(360) =		2.6 in		P(1440) =		3.1 in	
Basin	Basin Area (Ac)	Land Treatment Factors				Ew (in)	V(100-6) (af)	V(100-24) (af)	Q(100) (cfs)	
		A	B	C	D					
(Acres)										
Existing Conditions										
Site	2.50	0.00	0.00	1.15	1.35	1.87	0.389	0.445	10.74	
Total	2.50								10.74	
Proposed Conditions										
Site	2.50	0.00	0.00	0.28	2.22	2.24	0.467	0.559	12.11	
Total	2.50								12.11	

POND RATING TABLE

Pond Rating Table			
WATER HARVEST AREA #1			
Pond Rating Table		Spillway Crest = 5216	
Side Slope	2:1		
Depth (ft)	Area (sq ft)	Volume (cubic fet)	Cum Volume (cubic feet)
5213.5	224	0	0
5214.5	575	400	400
5215.5	983	779	1179

Pond Invert	5213.5
Spillway Crest	5215.5
WSE (First Flush)	.
WSE (100-year)	.

Pond Rating Table			
WATER HARVEST AREA #2			
Pond Rating Table		Spillway Crest = 5216	
Side Slope	2:1		
Depth (ft)	Area (sq ft)	Volume (cubic fet)	Cum Volume (cubic feet)
5213.5	162	0	0
5214.5	417	290	290
5215.5	734	576	865

Pond Invert	5213.5
Spillway Crest	5215.5
WSE (First Flush)	.
WSE (100-year)	.

Pond Rating Table			
Pond #3			
Pond Rating Table		Spillway Crest = 5216	
Side Slope	2:1		
Depth (ft)	Area (sq ft)	Volume (cubic fet)	Cum Volume (cubic feet)
5213.5	300	0	0
5214.5	737	519	519
5215.5	1232	985	1503

Pond Invert	5213.5
Spillway Crest	5215.5
WSE (First Flush)	.
WSE (100-year)	.

ME

MILLER ENGINEERING CONSULTANTS

Engineers • Planners

3500 COMANCHE, NE
BUILDING F
ALBUQUERQUE, NM 87107
(505)888-7500
(505)888-3800 (FAX)



B1 VICINITY MAP

SCALE: NOT TO SCALE

National Flood Hazard Layer FIRMette



Legend

SEE FIS REPORT FOR DETAILED LEGEND AND INDEX MAP FOR FIRM PANEL LAYOUT

SPECIAL FLOOD HAZARD AREAS

Without Base Flood Elevation (BFE)
Zone A, V, VE, VE1
With BFE or Depth Zone AE, AO, AH, VE, VE1
Regulatory Floodway

OTHER AREAS OF FLOOD HAZARD

0.2% Annual Chance Flood Hazard, Areas of 1% annual chance flood with average depth less than one foot or with drainage areas of less than one square mile (Zone A)
Future Conditions 1% Annual Chance Flood Hazard (Zone A)
Area with Reduced Flood Risk due to Levee. See Notes. (Zone V)
Area with Flood Risk due to Levee (Zone D)

OTHER AREAS

no SCREEN: Area of Minimal Flood Hazard (Zone X)
Effective LOMRs
Area of Undetermined Flood Hazard (Zone D)

GENERAL STRUCTURES

Channel, Culvert, or Storm Sewer
Levee, Dike, or Floodwall

Cross Sections with 1% Annual Chance Water Surface Elevation
Coastal Transect
Base Flood Elevation Line (BFE)
Limit of Study
Jurisdiction Boundary

OTHER FEATURES

Coastal Transect Baseline
Profile Baseline
Hydrographic Feature

MAP PANELS

Digital Data Available
No Digital Data Available
Unmapped

The pin displayed on the map is an approximate point selected by the user and does not represent an authoritative property location.

This map complies with FEMA's standards for the use of digital flood maps if it is not void as described below. The basemap shown complies with FEMA's basemap accuracy standards.

The flood hazard information is derived directly from the authoritative NFHL web services provided by FEMA. This map was exported on 4/27/2022 at 12:46 PM and does not reflect changes or amendments subsequent to this date and time. The NFHL and effective information may change or become superseded by new data over time.

This map image is void if the one or more of the following map elements do not appear: basemap imagery, flood zone labels, legend, scale bar, map creation date, community identifiers, FIRM panel number, and FIRM effective date. Map images for unmapped and unmodernized areas cannot be used for regulatory purposes.

SWQV CALCULATIONS

FIRST FLUSH =(0.42/12" * 96,703 SF) = 3385 CF > 3547

A1 FLOOD ZONE MAP

FLOOD ZONE MAP: 35001C0139G

No

Revision

Item

Date

SCOTT C. ANDERSON & associates architects

4419 4th St. NW, apt. B
ALBUQUERQUE, NM 87107
scott@scottcanderson.com
505.401.7575

ENTERPRISE RENT-A-CAR

5700 SAN MATEO BLVD. NE

ALBUQUERQUE, NEW MEXICO 87109

DRAWING TITLE

HYDROLOGY PLAN

SEAL

VERLYN A. MILLER II

NEW MEXICO

14507

REGISTERED PROFESSIONAL ENGINEER

5/4/22

DESIGNED MEC

PROJECT NO

DRAWN MEC

SCALE NOTED

CHECKED VAM


DRAWING NO

REVIEWED

DATE 4/27/22

C-101

OF

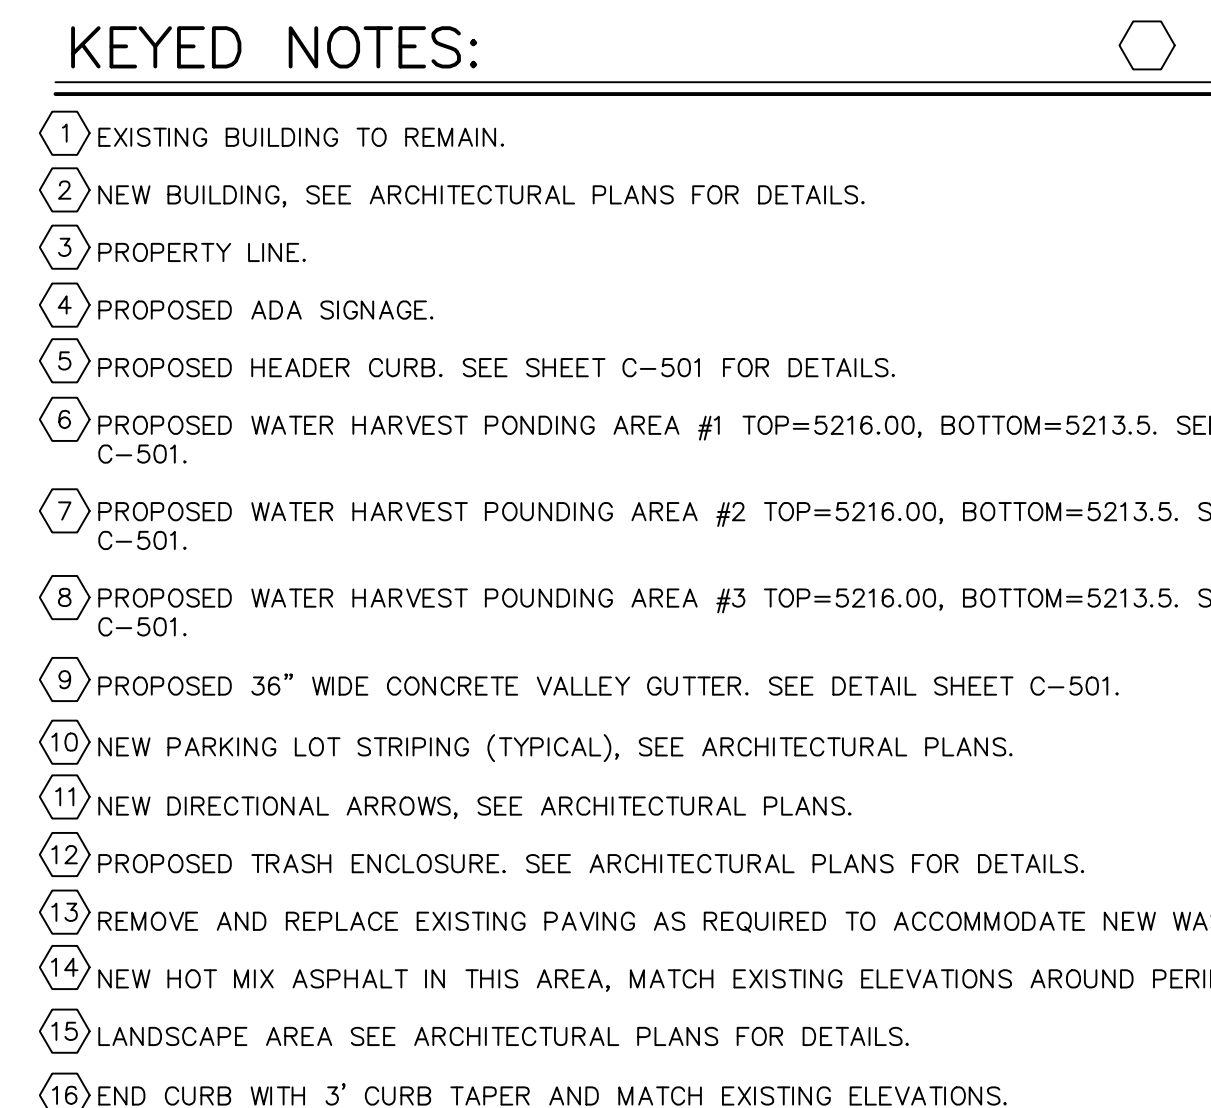

 **MILLER ENGINEERING CONSULTANTS**
Engineers • Planners
3500 COMANCHE, NE
BUILDING F
ALBUQUERQUE, NM 87107
(505) 888-7500
(505) 888-3800 (FAX)



6"x36" CONCRETE VALLEY GUTTER DETAIL
SCALE: NONE



A3 TYPICAL WATER HARVEST AREA SECTION
SCALE: NOT TO SCALE



TYPICAL CURB TAPER DETAIL
SCALE: NONE



C2 HEADER CURB DETAIL
SCALE: NOT TO SCALE



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Engineers • Planners
3500 COMANCHE, NE
BUILDING F
ALBUQUERQUE, NM 87107
(505)888-7500
(505)888-3800 (FAX)

No	Revision	Item	Date



SCOTT C. ANDERSON
& associates architects
4419 4th St. n.w. apt. B
albuquerque, nm 87107
scott@scottandersonarchitects.com
505.401.7975

ENTERPRISE RENT-A-CAR
5700 SAN MATEO BLVD. NE
ALBUQUERQUE, NEW MEXICO 87109

DRAWING TITLE
MISCELLANEOUS DETAILS

SEAL	DESIGNED	MEC	PROJECT NO
	DRAWN	MEC	SCALE NOTED
	CHECKED	VAM	DRAWING NO
	REVIEWED		C-501 ____ OF ____
	DATE	8/2/21	