

CITY OF ALBUQUERQUE

Planning Department
Alan Varela, Interim Director



Mayor Timothy M. Keller

June 27, 2022

Verlyn Miller, P.E.
Miller Engineering Consultants, Inc
3500 Comanche NE Bldg. F
Albuquerque, NM 87107

**RE: Enterprise Rent-A-Car
5700 San Mateo Blvd NE
Grading and Drainage Plans
Engineer's Stamp Date: 05/04/22
Hydrology File: F18D052**

Dear Mr. Miller:

Based upon the information provided in your submittal received 06/14/2022, the Grading & Drainage Plans are approved for Building Permit. Please attach a copy of this approved plan in the construction sets for Building Permit processing along with a copy of this letter.

PO Box 1293

PRIOR TO CERTIFICATE OF OCCUPANCY:

Albuquerque

1. Engineer's Certification, per the DPM Part 6-14 (F): *Engineer's Certification Checklist For Non-Subdivision* is required.

NM 87103

2. Please pay the Payment-in-Lieu of \$ **16,760.00** using the attached approved On-site SWQ Waiver. Please email this form to PLNDRS@cabq.gov. Once this is received, a receipt will then produce and email back with instructions on how to pay online. Once paid, please email me proof of payment.

www.cabq.gov

As a reminder, if the project total area of disturbance (including the staging area and any work within the adjacent Right-of-Way) is 1 acre or more, then an Erosion and Sediment Control (ESC) Plan and Owner's certified Notice of Intent (NOI) is required to be submitted to the Stormwater Quality Engineer (Doug Hughes, PE, jhughes@cabq.gov, 924-3420) 14 days prior to any earth disturbance.

If you have any questions, please contact me at 924-3995 or rbrissette@cabq.gov.

Sincerely,

Renée C. Brissette, P.E. CFM
Senior Engineer, Hydrology
Planning Department



City of Albuquerque

Planning Department
Development & Building Services Division

DRAINAGE AND TRANSPORTATION INFORMATION SHEET (REV 6/2018)

Project Title: Enterprise Rent-A-Car Building Permit #: _____ Hydrology File #: _____
DRB#: _____ **EPC#:** _____ **Work Order#:** _____
Legal Description: TR A2C PLAT OF TRS A2A, A2B, A2C & A2D A REPL OF TRS A2A & A 2B SPANISH LAND CO SUBD CONT 1.5611 AC M/L
City Address: 5700 San Mateo NE, Albuquerque, NM 87109

Applicant: Scott C Anderson, AIA And Associates LLC **Contact:** Scott Anderson
Address: 7604 Rio Penasco Court NW, Albuquerque, NM 87120
Phone#: 505-401-7575 **Fax#:** _____ **E-mail:** scott@scaarchitects.com

Other Contact: Miller Engineering Consultants, Inc. **Contact:** Verlyn Miller
Address: 3500 Comanche NE, Bldg. F
Phone#: 505-888-7500 **Fax#:** _____ **E-mail:** vmiller@mecnm.com

TYPE OF DEVELOPMENT: _____ PLAT (# of lots) _____ RESIDENCE _____ DRB SITE ☒ ADMIN SITE

IS THIS A RESUBMITTAL? ☒ Yes _____ No

DEPARTMENT _____ TRANSPORTATION ☒ HYDROLOGY/DRAINAGE

Check all that Apply:

TYPE OF SUBMITTAL:

- ☐ ENGINEER/ARCHITECT CERTIFICATION
- ☐ PAD CERTIFICATION
- ☐ CONCEPTUAL G & D PLAN
- ☒ GRADING PLAN
- ☐ DRAINAGE REPORT
- ☐ DRAINAGE MASTER PLAN
- ☐ FLOODPLAIN DEVELOPMENT PERMIT APPLIC
- ☐ ELEVATION CERTIFICATE
- ☐ CLOMR/LOMR
- ☐ TRAFFIC CIRCULATION LAYOUT (TCL)
- ☐ TRAFFIC IMPACT STUDY (TIS)
- ☐ STREET LIGHT LAYOUT
- ☐ OTHER (SPECIFY) _____
- ☐ PRE-DESIGN MEETING?

TYPE OF APPROVAL/ACCEPTANCE SOUGHT:

- ☐ BUILDING PERMIT APPROVAL
- ☐ CERTIFICATE OF OCCUPANCY
- ☐ PRELIMINARY PLAT APPROVAL
- ☐ SITE PLAN FOR SUB'D APPROVAL
- ☐ SITE PLAN FOR BLDG. PERMIT APPROVAL
- ☐ FINAL PLAT APPROVAL
- ☐ SIA/ RELEASE OF FINANCIAL GUARANTEE
- ☐ FOUNDATION PERMIT APPROVAL
- ☒ GRADING PERMIT APPROVAL
- ☐ SO-19 APPROVAL
- ☐ PAVING PERMIT APPROVAL
- ☐ GRADING/ PAD CERTIFICATION
- ☐ WORK ORDER APPROVAL
- ☐ CLOMR/LOMR
- ☐ FLOODPLAIN DEVELOPMENT PERMIT
- ☐ OTHER (SPECIFY) _____

DATE SUBMITTED: 6-15-2022 **By:** Verlyn Miller

COA STAFF:

ELECTRONIC SUBMITTAL RECEIVED: _____

FEE PAID: _____

△△ HYDROLOGY REPORT

SITE LOCATION

The existing site is an approximate 2.5-acre site located 5700 San Mateo Boulevard NE in Albuquerque. The site is located on the east side of San Mateo north of Montgomery Boulevard and can be accessed via San Mateo and south of Central Avenue (see vicinity map this sheet).

EXISTING CONDITIONS

The existing site is estimated at 2.5 acres and is mostly developed with a building and asphalt paving. There is a portion of land on the east side of the site that is currently base course. The site currently slopes from the east to west at a mild slope. The site does not lie within a 100-year FEMA floodplain (see FEMA panel on this sheet).

PROPOSED CONDITIONS

The proposed project will consist of a new wash bay facility to be located on the site and new asphalt paving of the eastern base course area of the site. The existing building will remain for the new facility. Since the existing western portion of the site is currently developed and there is no room for a new water quality pond the owner will be requesting a payment in lieu of this project. The drainage calculations for proposed conditions are indicated on this sheet.


CONCLUSIONS

When fully developed as indicated on the grading and drainage plan, the increased runoff from the site is estimated at 1.37 cfs and 0.114 acre-feet during the 100-year, 24-hour event. Storm water runoff from the site will discharge to its historical location west into San Mateo. Based on the redevelopment of this site, The storm water quality volume for this site is estimated at 2095 cubic feet. The owner is requesting to make payment in lieu of storm water quality ponding for this project. The water quality payment calculation is provided on this sheet below.

DPM HYDROLOGY CALCULATIONS

HYDROLOGY											
Precipitation Zone 3 - 100-year Storm				P(360) =		2.6 in		P(1440) =		3.1 in	
Basin	Basin Area (Ac)	Land Treatment Factors				Ew (in)	V(100-6) (af)	V(100-24) (af)	Q(100) (cfs)		
		A	B	C	D						
		(Acres)									
Existing Conditions											
Site	2.50	0.00	0.00	1.15	1.35	1.87	0.389	0.445	10.74		
Total	2.50								10.74		
Proposed Conditions											
Site	2.50	0.00	0.00	0.28	2.22	2.24	0.467	0.559	12.11		
Total	2.50								12.11		

△

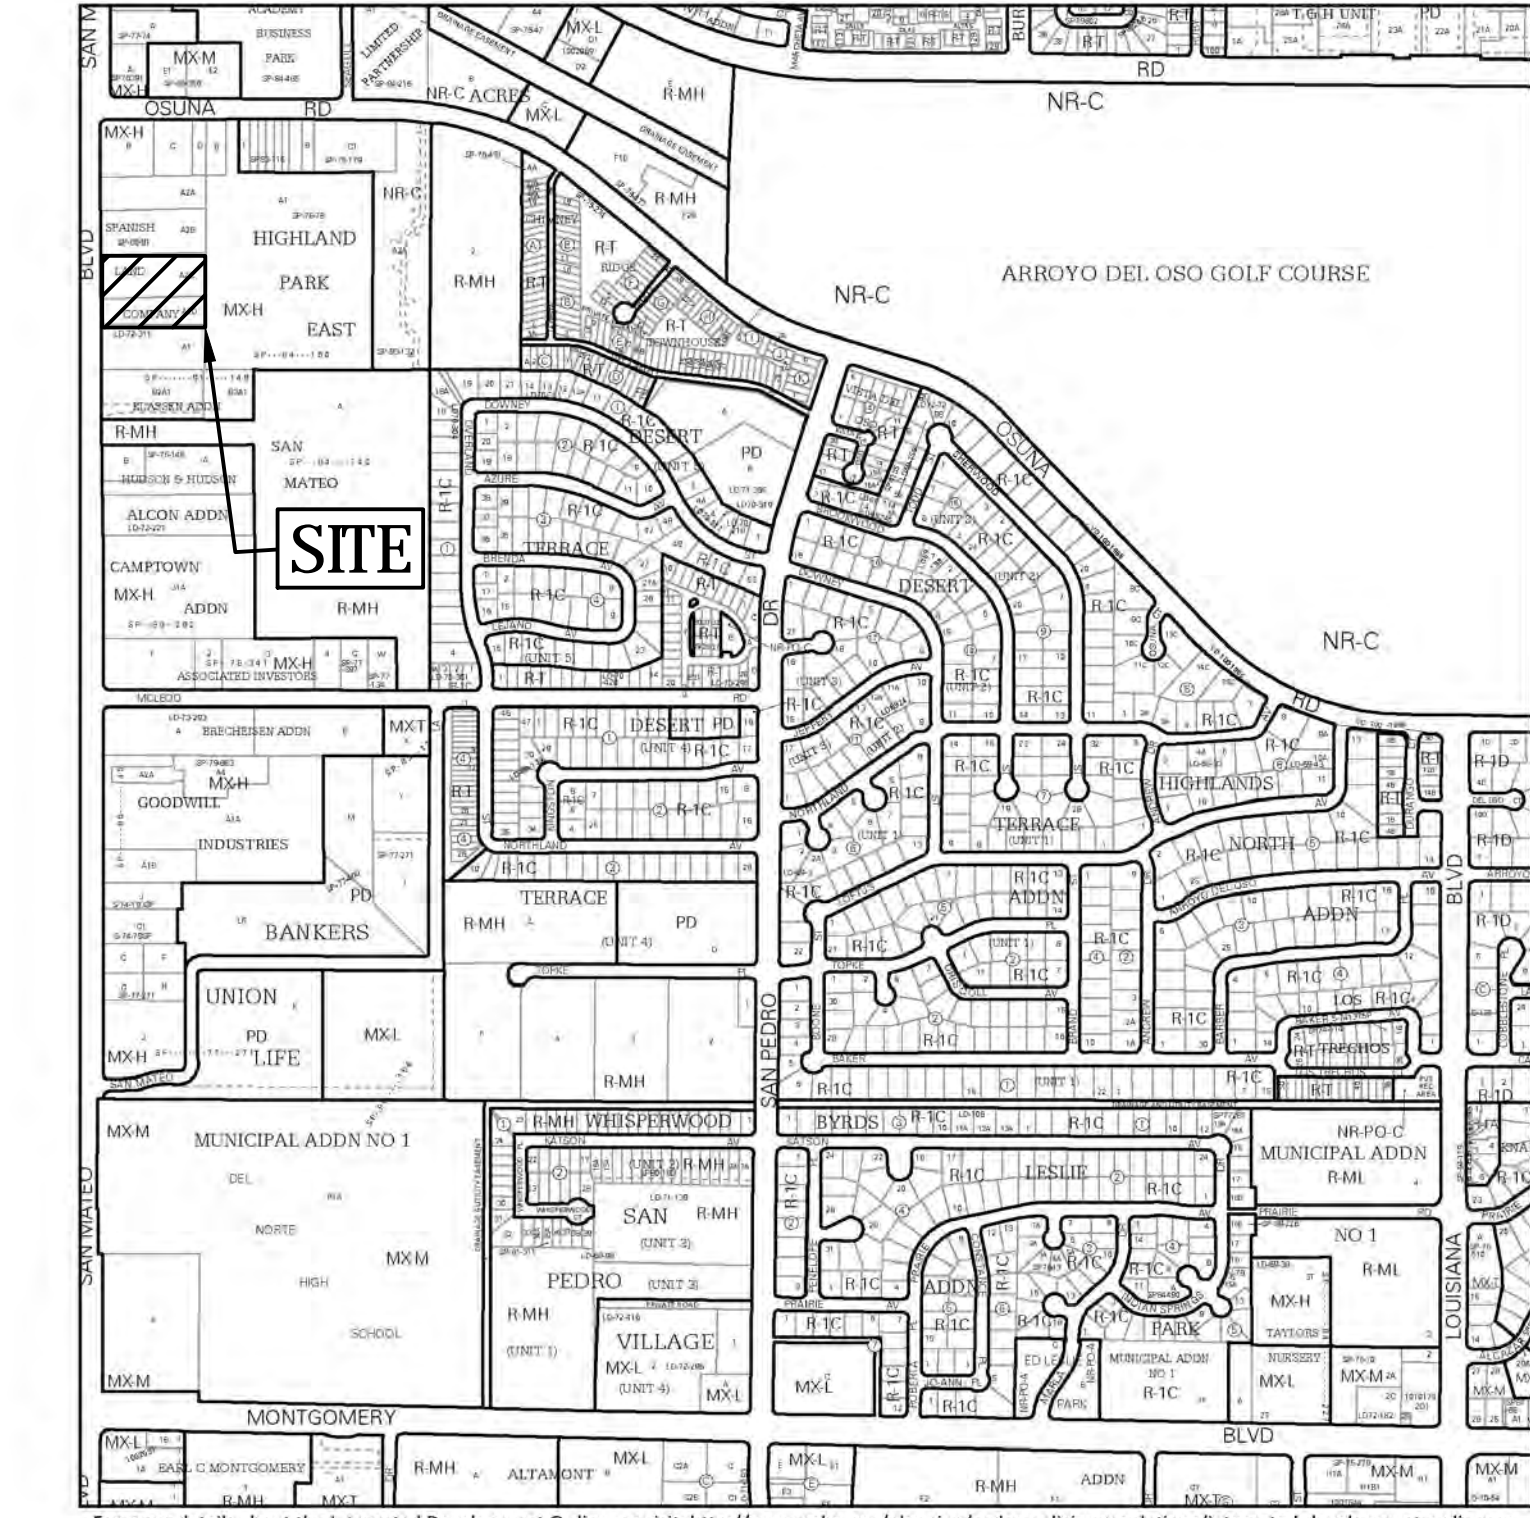

B1 VICINITY MAP
SCALE: NOT TO SCALE

National Flood Hazard Layer FIRMette



Legend

SEE FIS REPORT FOR DETAILED LEGEND AND INDEX MAP FOR FIRM PANEL LAYOUT

SPECIAL FLOOD HAZARD AREAS

- Without Base Flood Elevation (BFE)
- With BFE or Depth Zone AE, AO, AH, VE, AR
- Regulatory Floodway

OTHER AREAS OF FLOOD HAZARD

- 0.2% Annual Chance Flood Hazard, Areas of 1% annual chance flood with average depth less than one foot or with drainage areas of less than one square mile (Zone X)
- Future Conditions 1% Annual Chance Flood Hazard (Zone A)
- Area with Reduced Flood Risk due to Levee. See Notes. (Zone V)
- Area with Flood Risk due to Levee (Zone D)

OTHER AREAS

- Area of Minimal Flood Hazard (Zone X)
- Effective LOMRs
- Area of Undetermined Flood Hazard (Zone D)

GENERAL STRUCTURES

- Channel, Culvert, or Storm Sewer
- Levee, Dike, or Floodwall

OTHER FEATURES

- Cross Sections with 1% Annual Chance Water Surface Elevation
- Coastal Tract
- Base Flood Elevation Line (BFE)
- Limit of Study
- Jurisdiction Boundary
- Coastal Tract Baseline
- Profile Baseline
- Hydrographic Feature

MAP PANELS

- Digital Data Available
- No Digital Data Available
- Unmapped

The pin displayed on the map is an approximate point selected by the user and does not represent an authoritative property location.

This map complies with FEMA's standards for the use of digital flood maps if it is not void as described below. The basemap shown complies with FEMA's basemap accuracy standards.

The flood hazard information is derived directly from the authoritative NFHL web services provided by FEMA. This map was exported on 4/27/2022 at 12:46 PM and does not reflect changes or amendments subsequent to this date and time. The NFHL and effective information may change or become superseded by new data over time.


This map image is void if the one or more of the following map elements do not appear: basemap imagery, flood zone labels, legend, scale bar, map creation date, community identifiers, FIRM panel number, and FIRM effective date. Map images for unmapped and unmodernized areas cannot be used for regulatory purposes.

SWQV CALCULATIONS

FIRST FLUSH = (0.26 / 12" * 96,703 SF) = 2095 CF

PAYMENT-IN-LIEU = 2095 CF * \$8 / CF = \$16,760.00

△△

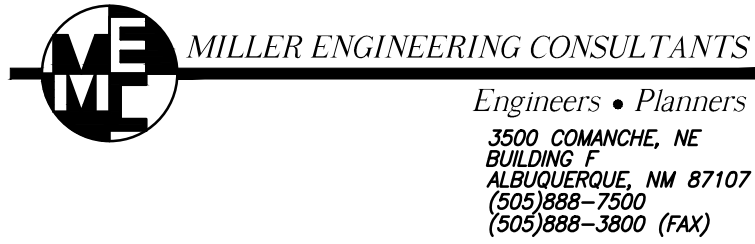

No	Revision	Item	Date
△	CHANGE SWQV NOTES; REMOVE POND RATING TABLES		
	UPDATE HYDROLOGY REPORT		5/31/2022
△	CHANGE SWQV NOTES; UPDATE HYDROLOGY REPORT		6/27/2022
ENTERPRISE RENT-A-CAR 5700 SAN MATEO BLVD. NE ALBUQUERQUE, NEW MEXICO 87109			
DRAWING TITLE HYDROLOGY PLAN			
SEAL 	DESIGNED MEC	PROJECT NO	
	DRAWN MEC	SCALE NOTED	
	CHECKED VAM	DRAWING NO	
	REVIEWED		
	DATE 4/27/22		
		C-101	OF

