

File Path: E\MIN\CON\AMBINA\RS\ Piot Date: 11-18-201 File Name: 9006106-101_RS.DWC Piot Time: 06:11 am

CONSTRUCTION NOTES

- 1. TWO (2) WORKING DAYS PRIOR TO ANY EXCAVATION, CONTRACTOR MUST CONTACT NEW MEXICO ONE CALL SYSTEM 260-1990 (ALBUQUERQUE AREA), 1-800-321-ALERT(2537) (STATEWIDE), FOR LOCATION OF EXISTING UTILITIES, AND ABASTO UTILITY LOCATING COMPANY (889-3341) FOR LOCATION OF EXISTING PRIVATE UTILITIES ON APS PROPERTY.
- PRIOR TO CONSTRUCTION, THE CONTRACTOR SHALL EXCAVATE AND VERIFY THE HORIZONTAL AND VERTICAL LOCATION OF ALL POTENTIAL OBSTRUCTIONS, SHOULD A CONFLICT EXIST, THE CONTRACTOR SHALL NOTIFY THE ENGINEER IN WRITING SO THAT THE CONFLICT CAN BE RESOLVED WITH A MINIMUM AMOUNT OF DELAY. THE CONTRACTOR SHALL BE RESPONSIBLE FOR ALL INTERPRETATIONS IT MAKES WITHOUT FIRST CONTACTING THE ENGINEER AS REQUIRED ABOVE.
- 3. ALL WORK ON THIS PROJECT SHALL BE PERFORMED IN ACCORDANCE WITH APPLICABLE FEDERAL, STATE AND LOCAL LAWS, RULES AND REGULATIONS CONCERNING CONSTRUCTION SAFETY AND HEALTH.
- 4. ALL WORK DETAILED ON THESE PLANS TO BE PERFORMED, EXCEPT AS OTHERWISE STATED OR PROVIDED FOR HEREON, SHALL BE CONSTRUCTED IN ACCORDANCE WITH THE CITY OF ALBUQUERQUE STANDARD SPECIFICATIONS FOR PUBLIC WORKS CONSTRUCTION, 1986 EDITION AS REVISED THROUGH UPDATE \$7, AMENDMENT 1
- 5. IF ANY UTILITY LINES, PIPELINES, OR UNDERGROUND UTILITY LINES ARE SHOWN ON THESE DRAWINGS, THEY ARE SHOWN IN AN APPROXIMATE MANNER ONLY, AND SUCH LINES MAY EXIST WHERE NONE ARE SHOWN. IF ANY SUCH EXISTING LINES ARE SHOWN, THE LOCATION IS BASED UPON INFORMATION PROVIDED BY THE OWNER OF SAID UTILITY, AND THE INFORMATION MAY BE INCOMPLETE, OR MAY BE OBSOLETE BY THE TIME CONSTRUCTION COMMENCES. THE ENGINEER HAS CONDUCTED ONLY PRELIMINARY INVESTIGATION OF THE LOCATION, DEPTH, SIZE, OR TYPE OF EXISTING UTILITY UNES.
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AVOID ANY PONDING ADJACENT TO THE STRUCTURE, FOR

- 1. THE CONTRACTOR SHALL ENSURE THAT NO SOIL ERODES FROM THE SITE INTO PUBLIC RIGHT-OF-WAY OR ONTO PRIVATE PROPERTY. 2. THE CONTRACTOR SHALL PROMPTLY CLEAN UP ANY MATERIAL EXCAMATED WITHIN THE PUBLIC RIGHT-OF-WAY SO THAT THE EXCAMATED MATERIAL IS NOT SUSCEPTIBLE TO BEING WASHED DOWN
- 3. WHEN APPLICABLE CONTRACTOR SHALL SECURE "TOPSOIL DISTURBANCE PERMIT" FROM THE CITY AND/OR FILE A NOTICE OF INTENT (N.O.I.) WITH THE EPA PRIOR TO BEGINNING CONSTRUCTION.
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SHEET KEYED NOTES

SLOPE AND SIZE AS NOTED

- (1) NEW 24° SIDEWALK CULVERT PER D5/CG-301 NEW 24° GRATE STORM INLET PER D1/CG-301 INSTALL HOPE (SMOOTH INTERIOR) STORM DRAIN WITH WATER TIGHT JOINTS AND WATER STOPS AT INLET AND MANHOLE CONNECTIONS -
- (4) ROOF DRAINS TO TIE TO NEW STORM DRAIN NEW TYPE "A" STORM INLET PER A5/CG-301
- NEW CONCRETE PAVEMENT PER 04/CP-301 MATCH EXISTING ELEVATION
- NEW 4' DIA. STORM DRAIN MANHOLE PER D1/CG-102 PROVIDE MINIMUM B" WIDE X 6" HIGH OPENING FOR DRAINAGE NEW CONCRETE RUNDOWN PER D3/CG-301
- INSTALL 24" HOPE PLUG FOR FUTURE EXTENSION CONNECT TO BUILDING ROOF DRAIN, PROVIDE DOUBLE CLEANOUT PER A5/CU-301 AND EXTEND 10 CAST IRON SOIL PIPE LINE TO MAIN. INSTALL HOPE TEE AT MAIN WITH HOPE TO C.I.S.P. ADAPTER.

PROPOSED SPOT ELEVATION EXISTING FLOWLINE ELEVATION PROPOSED CONTOUR ____37____ _ - - 5008 - - -EXISTING CONTOUR PROPOSED FLOWLINE PROPOSED DIRECTION OF FLOW PROPOSED CONCRETE

LEED SUBMITTAL NOTES

PROPOSED ASPHALT PAVEMENT

PROPOSED HIGH POINT

LEED SUBMITTALS: • PROVIDE THE OVERALL COST OF MATERIALS (IF ANY) ON LEED WORKSHEETS. PROVIDE SEPARATE COST BREAKOUT FOR MATERIALS THAT CONTRIBUTE TO MATERIALS AND MRC5 - REGIONAL MATERIALS (IF ANY): FOR EACH REGIONAL MATERIAL PROVIDE THE DISTANCE BETWEEN TH POINT OF EXTRACTION AND THE PROJECT SITE, AGGREGATES ARE EXPECTED TO CONTRIBUTE TO THIS CREDIT.

NO CHANGES REVISE STORM DRAIN SIZES FROM 24" ADD RETAINING WALL & PAVING BEHIND SHOP

FOR TEN CO.

A RECORD DRAMING & CERT.

A RISCORD DRAWING & CERT.

orchitecture

inferiors

landscape

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ARCHITECT

ENGINEER

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NEW TECH

HIGH SCHOOL

5325 MONTGOMERY NE

ALBUQUERQUE, NM

JLP/BLEJ.Y.R.

GRADING PLAN (SOUTH) RECORD DRAWING

MESA Conculting Group 6010-B MIDWAY PARK BLVD. NE . ALBUQUERQUE, NEW MEXICO 87109 PHONE: 505.345.4250 . FAX: 505.345.4254 . www.highmesacg.com 20082052 2008:606.1 °CG-101

RECORD INFORMATION FROM AS-BUILT SURVEY RECORD INFORMATION FROM AS-BUILT SURVEY RECORD INFORMATION PROM AS-BUILT SURVEY

A RECORD DRAWING LEGEND

AS-CONSTRUCTED = AS-DESIGNED (VERIFIED BY AS-BUILT SURVEY)

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'. Contractor shall contact engineer to schedule grading INSPECTION PRIOR TO LANDSCAPING TO VERIFY GRADED FLOWLINES. 8. AN EXCAVATION/CONSTRUCTION PERMIT WILL BE REQUIRED BEFORE

BEGINNING ANY WORK WITHIN CITY RICHT-OF-WAY. AN APPROVED COPY OF THESE PLANS MUST BE SUBMITTED AT THE TIME OF APPLICATION FOR THIS PERMIT. BACKFILL COMPACTION SHALL BE ACCORDING TO ARTERIAL

10. MAINTENANCE OF THESE FACILITIES SHALL BE THE RESPONSIBILITY OF THE OWNER OF THE PROPERTY SERVED.

APPROVALS	NAME	DATE
HYDROLOGY		
SIDEWALK INSPECTOR		
STORM DRAIN MAINTENANCE		

EROSION CONTROL MEASURES

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SHEET KEYNOTES

NEW DOUBLE "D" STORM INLET PER B3/CG-301 INV. OUT 21 25 23 TG25 25 60

(2) NEW 30" PREFABRICATED HOPE END SECTION NEW CHANNEL PENETRATION PER CG-303. SO §19 PERMIT REQUIRED, SEE CONST. NOTE 7

(4) NEW 4' DIA SDIMH PER D1/CG-302 INSTALL 18" RCP STORM DRAIN, SLOPE AS NOTED

INSTALL 30° HDPE (SMOOTH INTERIOR) STORM DRAIN WITH WATER TIGHT JOINTS AND WATER STOPS AT INLET AND MANHOLE CONNECTIONS — SLOPE AS NOTED (7) CONSTRUCT BEEHIVE INLET PER B5/CG-301. INVERT AND GRATE ELEVATION AS NOTED.

B INSTALL 18" HDPE (SMOOTH INTERIOR) STORM DRAIN WITH WATER TIGHT JOINTS AND WATER STOPS AT INLET AND MANHOLE CONNECTIONS @ S=0.0200

(9) NEW 18" PREFABRICATED HDPE END SECTION (0) CONSTRUCT 10'x10' RIP-RAP APRON PER B1/CG-301 REVECETATE DISTURBED AREA PER EROSION CONTROL MEASURE #4

LEGEND

PROPOSED SPOT ELEVATION EXISTING FLOWLINE ELEVATION PROPOSED CONTOUR EXISTING CONTOUR

PROPOSED FLOWLINE ROOF DIRECTION OF FLOW PROPOSED CONCRETE

A RECORD DRAWING & CERT

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PROJECT NO. GRADING PLAN (NORTH)

RECORD DRAWING FOR CERTIFICATION, SEE SHEET CG-101



CG-102

GRADING PLAN (NORTH)

SCALE: 1" = 20"

BANKER'S UNION LIFE (FILED 05-26-1977, D7-177)

DIRT

⁺27.8

20° P.N.M. EASEMENT GRANTED BY

DOCUMENT FILED 01-15-1959,

BOOK D459, PAGE 335

---*--6'CLF -----E/PM -* END 9'CLF

⁺27.3

CONCRETE

GRASS BASEBALL FIELD

50' DRAINAGE EASEMENT GRANTEL

20' P.N.M. EASEMENT GRANTED BY

DOCUMENT FILED 01-15-1959,/
BOOK D459, PAGE 335

DETENTION POND x24.1

BOTTOM 0 24.0

⁺29.5

BY PLAT C12-118

EMERGENCY OVERFLOW

GRASS BASEBALL FIELD,

⁺28.5

FOR CONTINUATION, V SEE SHEET CG-101

*28.53

⁺30.**6**

INV IN /26.00 (18") 25.40 INV OUT 24.90 25.00

+31.3

5' UTILITY EASEMENT GRANTED

ELEV.=5230.31

× 24.1

30' DRAINAGE EASEMENT GRANTED

= 10' CITY OF ALBUQUERQUE WATERLINE

_PAGE 107 BETWEEN C.O.A. AND P.N.M.

EASEMENT REFERENCED BY AGREEMENT FILED 04-05-1963, BOOK D688,

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interiors

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ARCHITECT

PROJECT

NEW TECH

HIGH SCHOOL

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ALBUQUERQUE, NM

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SHEET KEYNOTES

CONSTRUCT CONCRETE SIDEWALK PER D5/CP-301. REFER TO ARCHITECTURAL PLANS FOR PATTERN, TEXTURE & COLOR. (2) CONSTRUCT 2'-0" CONCRETE RUNDOWN PER D3/CG-301. CONSTRUCT 6" CURB AND GUTTER PER D1/CP-301. CONSTRUCT DEPRESSED CURB AND GUTTER PER C3/CP-301. CONSTRUCT ASPHALT PAVEMENT PER D3/CP-301. (6) CONSTRUCT 24" SIDEWALK CULVERT PER D5/CG-301. CONSTRUCT MOUNTABLE CURB PER C1/CP-301. CONSTRUCT 6° CONCRETE PAVEMENT PER D4/CP-301. REFER TO ARCHITECTURAL PLANS FOR REFUSE SLAB & ENCLOSURE. (10) INSTALL CONCRETE WHEEL STOP PER C4/CP-301. 11) NEW RETAINING WALL - SEE STRUCTURAL.

LEGEND

PROPOSED CONCRETE PROPOSED ASPHALT PAVEMENT


COORDINATE LAYOUT POINTS

SHEET CO-101	FUR CONTROL	POINTS)
NORTHING	EASTING	DESCRIPTION
1503866.92	1541365.44	PC/FACE OF CURB
1504033.92	1541337.91	ANGLE POINT/FACE OF CURB
1503851.92	1541286.56	PC/FACE OF CURB
1504006.95	1541260.41	ANGLE POINT/FACE OF CURB
1503875.92	1540912.58	END/FACE OF CURB
1506875.92	1541260.41	ANGLE POINT/FACE OF CURB
1503900.66	1540987.07	grid intersection (A) - (
1504025.99	1541242.24	GRID INTERSECTION (L) - (
1504051.99	1541241.98	STORM DRAIN MANHOLE
1504051.99	1540941.58	STORM DRAIN MANHOLE
1503913.78	1540941.58	STORM DRAIN MANHOLE
	NORTHING 1503866.92 1504033.92 1503851.92 1504006.95 1503875.92 1506875.92 1503900.66 1504025.99 1504051.99	1503866.92 1541365.44 1504033.92 1541337.91 1503851.92 1541286.56 1504006.95 1541260.41 1503875.92 1540912.58 1506875.92 1541260.41 1503900.66 1540987.07 1504025.99 1541242.24 1504051.99 1540941.58

ALL WHEELCHAIR RAMPS LOCATED WITHIN THE PUBLIC RIGHT OF WAY MUST HAVE TRUNCATED DOMES.

Public Infrastructure shown on these plans for information on these plans for internation only and not part of approval.

Separate DRC/Permit approval and Work Order required.

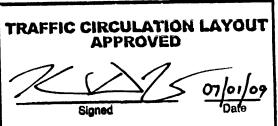

RECEIVED (SOUTH) JUN 2 9 2009

HYDROLOGY SECTION

HIGH MESA Consulting Group

6010-B MIDWAY PARK BLVD. NE • ALBUQUERQUE, NEW MEXICO 87109 PHONE: 505.345.4250 • FAX: 505.345.4254 • www.highmesacg.com -2009:006:1 2008,205.2



CP-101

DRAWN BY

REVIEWED BY

PROJECT NO.

DRAWING NAME PAVING PLAN

A ENGINEER'S CERT.

JLP/JYR/CFA/BLE

06-29-2009

2009.006.1

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NEW TYPE "A" STORM INLET PER A5/CG-301 NEW CONCRETE PAVEMENT PER D4/CP-301

NEW CONCRETE RUNDOWN PER D3/CG-301

MATCH EXISTING ELEVATION NEW 4' DIA STORM DRAIN MANHOLE PER D1/CG-102 PROVIDE MINIMUM 8" WIDE X 6" HIGH OPENING FOR DRAINAGE

INSTALL 24" HOPE PLUG FOR FUTURE EXTENSION CONNECT TO BUILDING ROOF DRAIN, PROVIDE DOUBLE CLEANOUT PER A5/CU-301 AND EXTEND 10° CAST IRON SOIL PIPE LINE TO MAIN. INSTALL HDPE TEE AT MAIN WITH HDPE TO C.I.S.P. ADAPTER.

LEGEND

25.41 PROPOSED SPOT ELEVATION + 24.86 EXISTING FLOWLINE ELEVATION PROPOSED CONTOUR _ - 5008 - _ . EXISTING CONTOUR PROPOSED FLOWLINE PROPOSED DIRECTION OF FLOW PROPOSED CONCRETE PROPOSED ASPHALT PAVEMENT

> SUBMITTAL NOTES


PROPOSED HIGH POINT

LEED SUBMITTALS: . PROVIDE THE OVERALL COST OF MATERIALS (IF ANY) ON LEED WORKSHEETS. PROVIDE SEPARATE COST BREAKOUT FOR MATERIALS THAT CONTRIBUTE TO MATERIALS AND RESOURCES CREDITS. MRC5 - REGIONAL MATERIALS (IF ANY): FOR EACH REGIONAL MATERIAL PROVIDE THE DISTANCE BETWEEN THE POINT OF EXTRACTION AND THE PROJECT SITE. AGGREGATES ARE EXPECTED TO CONTRIBUTE TO THIS CREDIT. NO CHANGES REVISE STORM DRAIN SIZES FROM 24"
TO 30"; ADD LEED SUBMITTAL NOTES ADD RETAINING WALL & PAYING BEHIND SHOP

JLP/BLE/J.Y.R. 06-29-2009 08-0041 PROJECT NO. HADBOTOGA DRAWING NAME ecop o z non GRADING PLAN (SOUTH)

MESA Consulting Group 6010-B MIDWAY PARK BLVD. NE • ALBUQUERQUE, NEW MEXICO 87109 PHONE: 505.345.4250 • FAX: 505.345.4254 • www.highmesacg.com

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C--001

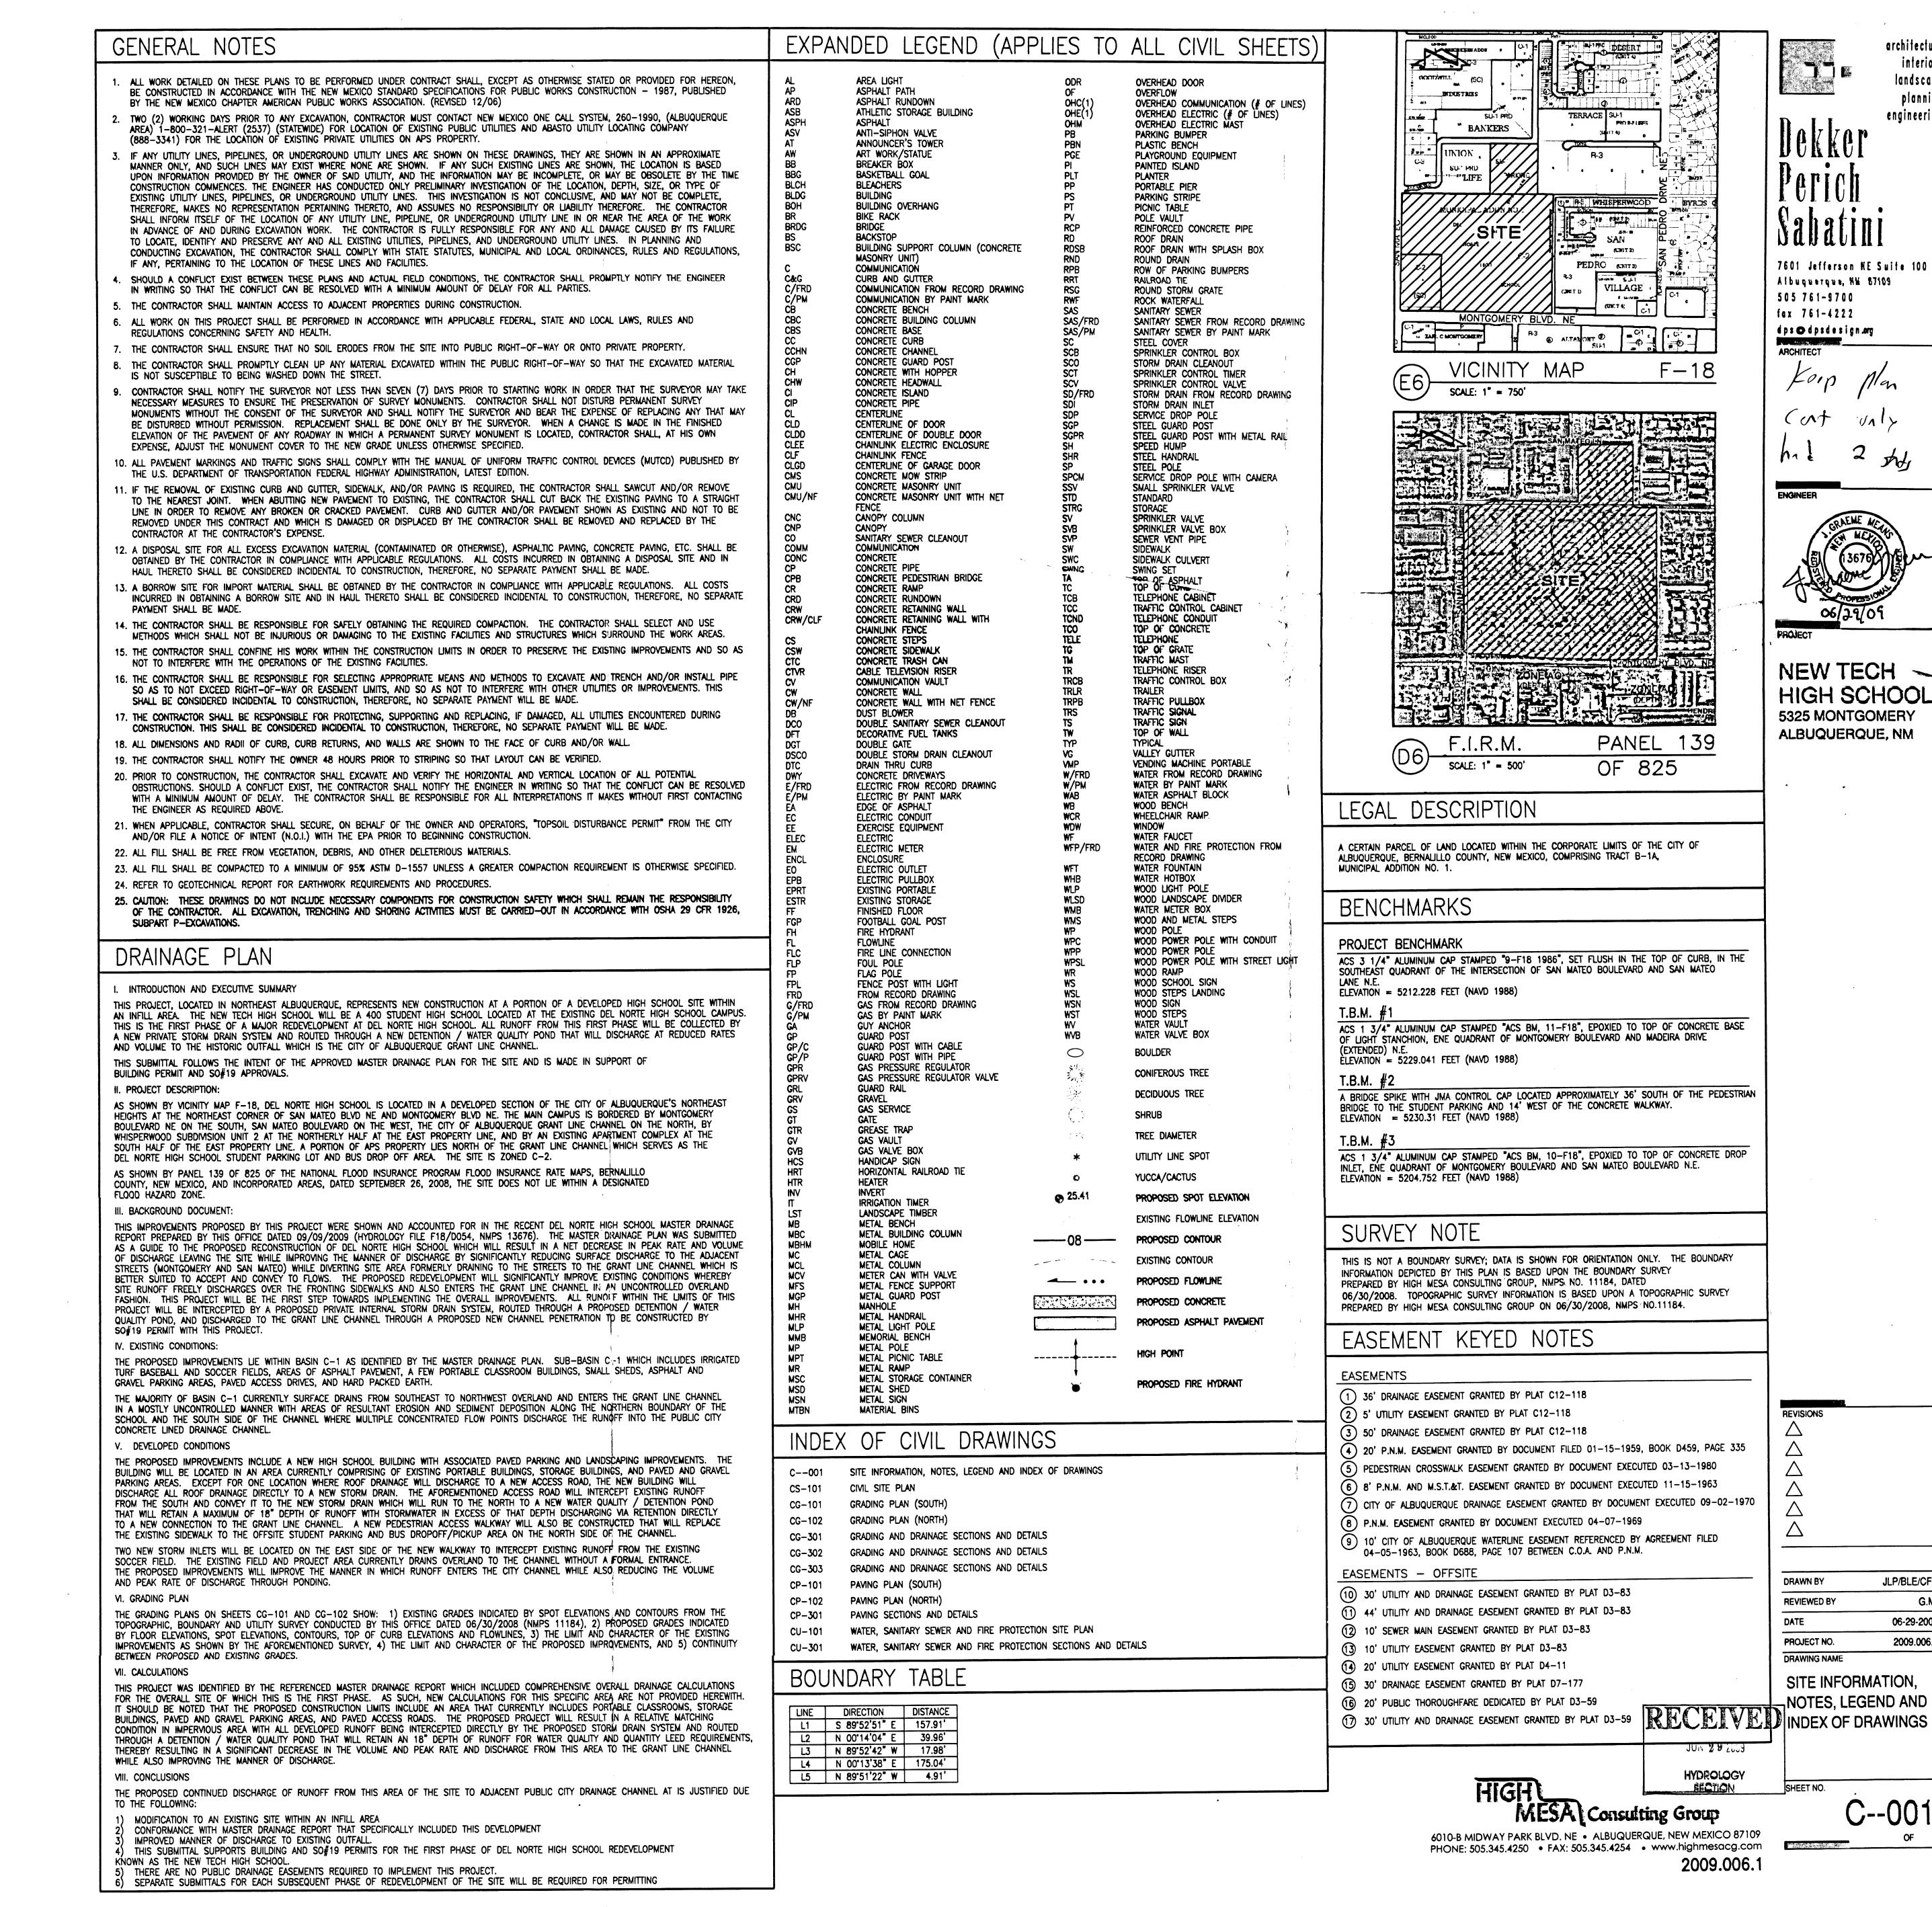JLP/BLE/CFA

06-29-2009

2009.006.1

G.M.

architecture

landscape

engineering

planning

BENCHMARKS

PROJECT BENCHMARK

ACS 3 1/4" ALUMINUM CAP STAMPED "9-F18 1986", SET FLUSH IN THE TOP OF CURB, IN THE SOUTHEAST QUADRANT OF THE INTERSECTION OF SAN MATEO BOULEVARD AND SAN MATEO LANE N.E., AS SHOWN.

T.B.M. #1

ACS 1 3/4" ALUMINUM CAP STAMPED "ACS BM, 11-F18", EPOXIED TO TOP OF CONCRETE BASE OF LIGHT STANCHION, ENE QUADRANT OF MONTGOMERY BOULEVARD AND MADEIRA DRIVE (EXTENDED) N.E., AS SHOWN.
ELEVATION = 5229.041 FEET (NAVD 1988)

A BRIDGE SPIKE WITH JMA CONTROL CAP LOCATED APPROXIMATELY 36' SOUTH OF THE PEDESTRIAN BRIDGE TO THE STUDENT PARKING AND 14' WEST OF THE CONCRETE WALKWAY, AS SHOWN. ELEVATION = 5230.31 FEET (NAVD 1988)

ACS 1 3/4" ALUMINUM CAP STAMPED "ACS BM, 10-F18", EPOXIED TO TOP OF CONCRETE DROP INLET, ENE QUADRANT OF MONTGOMERY BOULEVARD AND SAN MATEO BOULEVARD N.E.,

THIS IS NOT A BOUNDARY SURVEY; DATA IS SHOWN FOR ORIENTATION ONLY. THE BOUNDARY INFORMATION DEPICTED BY THIS PLAN IS BASED UPON THE BOUNDARY SURVEY PREPARED BY HIGH MESA CONSULTING GROUP, NMPS NO. 11184, DATED 06/30/2008. TOPOGRAPHIC SURVEY INFORMATION IS BASED UPON A TOPOGRAPHIC SURVEY PREPARED BY HIGH MESA CONSULTING GROUP ON 06/30/2008, NMPS NO.11184.

EASEMENT KEYNOTES

EASEMENTS

(1) 36' DRAINAGE EASEMENT GRANTED BY PLAT C12-118

2) 5' UTILITY EASEMENT GRANTED BY PLAT C12-118 (3) 50' DRAINAGE EASEMENT GRANTED BY PLAT C12-118

4 20' P.N.M. EASEMENT GRANTED BY DOCUMENT FILED 01-15-1959, BOOK 0459, PAGE 335

5 PEDESTRIAN CROSSWALK EASEMENT GRANTED BY DOCUMENT EXECUTED 03-13-1980 6 8' P.N.M. AND M.S.T.&T. EASEMENT GRANTED BY DOCUMENT EXECUTED 11-15-1963

7 CITY OF ALBUQUEROUE DRAINAGE EASEMENT GRANTED BY DOCUMENT EXECUTED 09-02-1970 8 P.N.M. EASEMENT GRANTED BY DOCUMENT EXECUTED 04-07-1969

9 10' CITY OF ALBUQUERQUE WATERLINE EASEMENT REFERENCED BY AGREEMENT FILED 04-05-1963, BOOK DEER, PAGE 107 BETWEEN C.O.A. AND P.N.M.

EASEMENTS - OFFSITE

(10) 30' UTILITY AND DRAINAGE EASEMENT GRANTED BY PLAT D3-83

(1) 44' UTILITY AND DRAINAGE EASEMENT GRANTED BY PLAT D3-83 (12) 10' SEWER MAIN EASEMENT GRANTED BY PLAT D3-83

13 10' UTILITY EASEMENT GRANTED BY PLAT, D3-83

14 20' UTILITY EASEMENT GRANTED BY PLAT D4-11

(15) 30' DRAINAGE EASEMENT GRANTED BY PLAT D7-177 16 20' PUBLIC THOROUGHFARE DEDICATED BY PLAT D3-59

17) 30' UTILITY AND DRAINAGE EASEMENT GRANTED BY PLAT D3-59

architecture

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engineering Dekker

7601 lefferson RE Su Albuquerque, NM 8710 505 761-9700 fax 761-4222 dps O dpsdesign.org ARCHITECT

NEW TECH HIGH SCHOOL 5325 MONTGOMERY NE ALBUQUERQUE, NM

JLP/BLE/DMH 06-29-2009 DRAWING NAME CIVIL SITE PLAN

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HYDROLOGY

2009.006.1

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CS-101

CONSTRUCTION NOTES

1. TWO (2) WORKING DAYS PRIOR TO ANY EXCAVATION, CONTRACTOR MUST CONTACT NEW MEXICO ONE CALL SYSTEM 260-1990 (ALBUQUERQUE AREA), 1-800-321-ALERT(2537) (STATEWIDE), FOR LOCATION OF EXISTING UTILITIES, AND ABASTO UTILITY LOCATING

COMPANY (889-3341) FOR LOCATION OF EXISTING PRIVATE UTILITIES ON APS PRÓPERTY. 2. PRIOR TO CONSTRUCTION, THE CONTRACTOR SHALL EXCAVATE AND VERIFY THE HORIZONTAL AND VERTICAL LOCATION OF ALL POTENTIAL OBSTRUCTIONS. SHOULD A CONFLICT EXIST, THE CONTRACTOR SHALL NOTIFY THE ENGINEER IN WRITING SO THAT THE CONFLICT CAN BE

interiors

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fax 761-4222

ARCHITECT

ENGINEER

dps @ dpsdesign.org

NEW TECH

HIGH SCHOOL

5325 MONTGOMERY NE

ALBUQUERQUE, NM

RESOLVED WITH A MINIMUM AMOUNT OF DELAY. THE CONTRACTOR SHALL BE RESPONSIBLE FOR ALL INTERPRETATIONS IT MAKES WITHOUT FIRST CONTACTING THE ENGINEER AS REQUIRED ABOVE. 3. ALL WORK ON THIS PROJECT SHALL BE PERFORMED IN ACCORDANCE WITH APPLICABLE FEDERAL, STATE AND LOCAL LAWS, RULES AND

REGULATIONS CONCERNING CONSTRUCTION SAFETY AND HEALTH. 4. ALL WORK DETAILED ON THESE PLANS TO BE PERFORMED, EXCEPT AS OTHERWISE STATED OR PROVIDED FOR HEREON, SHALL BE CONSTRUCTED IN ACCORDANCE WITH THE CITY OF ALBUQUERQUE STANDARD SPECIFICATIONS FOR PUBLIC WORKS CONSTRUCTION, 1986 EDITION AS REVISED THROUGH UPDATE #7, AMENDMENT 1

5. IF ANY UTILITY LINES, PIPELINES, OR UNDERGROUND UTILITY LINES ARE SHOWN ON THESE DRAWINGS, THEY ARE SHOWN IN AN APPROXIMATE MANNER ONLY, AND SUCH LINES MAY EXIST WHERE NONE ARE SHOWN. IF ANY SUCH EXISTING LINES ARE SHOWN, THE LOCATION IS BASED UPON INFORMATION PROVIDED BY THE OWNER OF SAID UTILITY, AND THE INFORMATION MAY BE INCOMPLETE, OR MAY BE OBSOLETE BY THE TIME CONSTRUCTION COMMENCES. THE ENGINEER HAS CONDUCTED ONLY PRELIMINARY INVESTIGATION OF THE LOCATION, DEPTH, SIZE, OR TYPE OF EXISTING UTILITY LINES, PIPELINES, OR UNDERGROUND UTILITY LINES. THIS INVESTIGATION IS NOT CONCLUSIVE, AND MAY NOT BE COMPLETE, THEREFORE, MAKES NO REPRESENTATION PERTAINING THERETO, AND ASSUMES NO RESPONSIBILITY OR LIABILITY THEREFOR. THE CONTRACTOR SHALL INFORM ITSELF OF THE LOCATION OF ANY UTILITY LINE, PIPELINE, OR UNDERGROUND UTILITY LINE IN OR NEAR THE AREA OF THE WORK IN ADVANCE OF AND DURING EXCAVATION WORK, THE CONTRACTOR IS FULLY RESPONSIBLE FOR ANY AND ALL DAMAGE CAUSED BY ITS FAILURE TO LOCATE, IDENTIFY AND PRESERVE ANY AND ALL EXISTING UTILITIES, PIPELINES, AND UNDERGROUND UTILITY LINES. IN PLANNING AND CONDUCTING EXCAVATION, THE CONTRACTOR SHALL COMPLY WITH STATE STATUTES, MUNICIPAL AND LOCAL ORDINANCES, RULES AND REGULATIONS, IF ANY, PERTAINING TO THE LOCATION OF THESE LINES AND FACILITIES.

6. THE DESIGN OF PLANTERS AND LANDSCAPED AREAS IS NOT PART (THIS PLAN. ALL PLANTERS AND LANDSCAPED AREAS ADJACENT TO THE BUILDING (5) SHALL BE PROVIDED WITH POSITIVE DRAINAGE TO AVOID ANY PONDING ADJACENT TO THE STRUCTURE. FOR CONSTRUCTION DETAILS, REFER TO LANDSCAPING PLAN. 7. CONTRACTOR SHALL CONTACT ENGINEER TO SCHEDULE GRADING INSPECTION PRIOR TO LANDSCAPING TO VERIFY GRADED FLOWLINES.

EROSION CONTROL MEASURES

I. THE CONTRACTOR SHALL ENSURE THAT NO SOIL ERODES FROM THE SITE INTO PUBLIC RIGHT-OF-WAY OR ONTO PRIVATE PROPERTY. 2. THE CONTRACTOR SHALL PROMPTLY CLEAN UP ANY MATERIAL EXCAVATED WITHIN THE PUBLIC RIGHT-OF-WAY SO THAT THE EXCAVATED MATERIAL IS NOT SUSCEPTIBLE TO BEING WASHED DOWN

3. WHEN APPLICABLE, CONTRACTOR SHALL SECURE PTOPSOIL DISTURBANCE PERMIT" FROM THE CITY AND/OR FILE A NOTICE OF INTENT (N.O.I.) WITH THE EPA PRIOR TO BEGINNING CONSTRUCTION.

4. UNLESS FINAL STABILIZATION IS OTHERWISE PROVIDED FOR, ANY AREAS OF EXCESS DISTURBANCE (TRAFFIC ACCESS, STORAGE YARD, EXCAVATED MATERIAL, ETC.) SHALL BE RE-SEEDED ACCORDING TO C.O.A. SPECIFICATION 1012 "NATIVE GRASS SEEDING". THIS WILL BE CONSIDERED INCIDENTAL TO CONSTRUCTION, THEREFORE, NO SEPARATE PAYMENT WILL BE MADE.

SHEET KEYED NOTES

1) NEW 24" SIDEWALK CULVERT PER D5/CG-301 NEW 24" GRATE STORM INLET PER D1/CG-301

INSTALL HDPE (SMOOTH INTERIOR) STORM DRAIN WITH WATER TIGHT JOINTS AND WATER STOPS AT INLET AND MANHOLE CONNECTIONS -SLOPE AND SIZE AS NOTED

(4) ROOF DRAINS TO TIE TO NEW STORM DRAIN (5) NEW TYPE "A" STORM INLET PER A5/CG-301

NEW CONCRETE PAVEMENT PER D4/CP-301 MATCH EXISTING ELEVATION NEW 4' DIA. STORM DRAIN MANHOLE PER D1/CG-102

PROVIDE MINIMUM 8" WIDE X 6" HIGH OPENING FOR DRAINAGE NEW CONCRETE RUNDOWN PER D3/CG-301 INSTALL 24" HDPE PLUG FOR FUTURE EXTENSION

CONNECT TO BUILDING ROOF DRAIN, PROVIDE DOUBLE CLEANOUT PER A5/CU-301 AND EXTEND 10" CAST IRON SOIL PIPE LINE TO MAIN. INSTALL HDPE TEE AT MAIN WITH HDPE TO C.I.S.P. ADAPTER.

LEGEND

æ 25.41 +24.86

PROPOSED SPOT ELEVATION EXISTING FLOWLINE ELEVATION PROPOSED CONTOUR EXISTING CONTOUR

PROPOSED FLOWLINE PROPOSED DIRECTION OF FLOW PROPOSED CONCRETE PROPOSED ASPHALT PAVEMENT

PROPOSED HIGH POINT

JLP/BLE/J.Y.R. REVIEWED BY 06-29-2009 08-0041 PROJECT NO. GRADING PLAN

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2009.006.1

(SOUTH)

GRADING PLAN (SOUTH)

1. TWO (2) WORKING DAYS PRIOR TO ANY EXCAVATION, CONTRACTOR MUST CONTACT NEW MEXICO ONE CALL SYSTEM 260-1990 (ALBUQUERQUE AREA), 1-800-321-ALERT(2537) (STATEWIDE), FOR LOCATION OF EXISTING UTILITIES, AND ABASTO UTILITY LOCATING COMPANY (889-3341) FOR LOCATION OF EXISTING PRIVATE

UTILITIES ON APS PROPERTY. 2. PRIOR TO CONSTRUCTION, THE CONTRACTOR SHALL EXCAVATE AND VERIFY THE HORIZONTAL AND VERTICAL LOCATION OF ALL POTENTIAL OBSTRUCTIONS. SHOULD A CONFLICT EXIST, THE CONTRACTOR SHALL NOTIFY THE ENGINEER IN WRITING SO THAT THE CONFLICT CAN BE RESOLVED WITH A MINIMUM AMOUNT OF DELAY. THE CONTRACTOR

SHALL BE RESPONSIBLE FOR ALL INTERPRETATIONS IT MAKES WITHOUT FIRST CONTACTING THE ENGINEER AS REQUIRED ABOVE. 3. ALL WORK ON THIS PROJECT SHALL BE PERFORMED IN ACCORDANCE WITH APPLICABLE FEDERAL, STATE AND LOCAL LAWS, RULES AND

REGULATIONS CONCERNING CONSTRUCTION SAFETY AND HEALTH. 4. ALL WORK DETAILED ON THESE PLANS TO BE PERFORMED, EXCEPT AS OTHERWISE STATED OR PROVIDED FOR HEREON, SHALL BE CONSTRUCTED IN ACCORDANCE WITH THE CITY OF ALBUQUERQUE STANDARD SPECIFICATIONS FOR PUBLIC WORKS CONSTRUCTION, 1986 EDITION AS REVISED THROUGH UPDATE #7, AMENDMENT 1

5. IF ANY UTILITY LINES, PIPELINES, OR UNDERGROUND UTILITY LINES ARE SHOWN ON THESE DRAWINGS, THEY ARE SHOWN IN AN APPROXIMATE MANNER ONLY, AND SUCH LINES MAY EXIST WHERE NONE ARE SHOWN. IF ANY SUCH EXISTING LINES ARE SHOWN, THE LOCATION IS BASED UPON INFORMATION PROVIDED BY THE OWNER OF SAID UTILITY, AND THE INFORMATION MAY BE INCOMPLETE, OR MAY BE OBSOLETE BY THE TIME CONSTRUCTION COMMENCES. THE ENGINEER HAS CONDUCTED ONLY PRELIMINARY INVESTIGATION OF THE LOCATION, DEPTH, SIZE, OR TYPE OF EXISTING UTILITY LINES, PIPELINES, OR UNDERGROUND UTILITY LINES. THIS INVESTIGATION IS NOT CONCLUSIVE, AND MAY NOT BE COMPLETE, THEREFORE, MAKES NO REPRESENTATION PERTAINING THERETO, AND ASSUMES NO RESPONSIBILITY OR LIABILITY THEREFOR. THE CONTRACTOR SHALL INFORM ITSELF OF THE LOCATION OF ANY UTILITY LINE, PIPELINE OR UNDERGROUND UTILITY LINE IN OR NEAR THE AREA OF THE WORK IN ADVANCE OF AND DURING EXCAVATION WORK. THE CONTRACTOR IS FULLY RESPONSIBLE FOR ANY AND ALL DAMAGE CAUSED BY ITS FAILURE TO LOCATE, IDENTIFY AND PRESERVE ANY AND ALL EXISTING UTILITIES, PIPELINES, AND UNDERGROUND UTILITY LINES. IN PLANNING AND CONDUCTING EXCAVATION, THE CONTRACTOR SHALL COMPLY WITH STATE STATUTES, MUNICIPAL AND LOCAL ORDINANCES, RULES AND REGULATIONS, IF ANY, PERTAINING TO THE LOCATION OF THESE LINES AND FACILITIES.

6. THE DESIGN OF PLANTERS AND LANDSCAPED AREAS IS NOT PART OF THIS PLAN. ALL PLANTERS AND LANDSCAPED AREAS ADJACENT TO THE BUILDING(S) SHALL BE PROVIDED WITH POSITIVE DRAINAGE TO AVOID ANY PONDING ADJACENT TO THE STRUCTURE. FOR CONSTRUCTION DETAILS, REFER TO LANDSCAPING PLAN.

7. CONTRACTOR SHALL CONTACT ENGINEER TO SCHEDULE GRADING INSPECTION PRIOR TO LANDSCAPING TO VERIFY GRADED FLOWLINES. 8. AN EXCAVATION/CONSTRUCTION PERMIT WILL BE REQUIRED BEFORE BEGINNING ANY WORK WITHIN CITY RIGHT-OF-WAY. AN APPROVED COPY OF THESE PLANS MUST BE SUBMITTED AT THE TIME OF APPLICATION FOR THIS PERMIT.

9. BACKFILL COMPACTION SHALL BE ACCORDING TO ARTERIAL STREET USE.

10. MAINTENANCE OF THESE FACILITIES SHALL BE THE RESPONSIBILITY OF THE OWNER OF THE PROPERTY SERVED.

		•
APPROVALS	NAME	DATE
HYDROLOGY		
SIDEWALK INSPECTOR		
STORM DRAIN MAINTENANCE		

EROSION CONTROL MEASURES

1. THE CONTRACTOR SHALL ENSURE THAT NO SOIL ERODES FROM THE SITE INTO PUBLIC RIGHT-OF-WAY OR ONTO PRIVATE PROPERTY. 2. THE CONTRACTOR SHALL PROMPTLY CLEAN UP ANY MATERIAL EXCAVATED WITHIN THE PUBLIC RIGHT-OF-WAY SO THAT THE EXCAVATED MATERIAL IS NOT SUSCEPTIBLE TO BEING WASHED DOWN THE STREET.

3. WHEN APPLICABLE, CONTRACTOR SHALL SECURE "TOPSOIL DISTURBANCE PERMIT" FROM THE CITY AND/OR FILE A NOTICE OF INTENT (N.O.I.) WITH THE EPA PRIOR TO BEGINNING CONSTRUCTION.

4. UNLESS FINAL STABILIZATION IS OTHERWISE PROVIDED FOR, ANY AREAS OF EXCESS DISTURBANCE (TRAFFIC ACCESS, STORAGE YARD, EXCAVATED MATERIAL, ETC.) SHALL BE RE-SEEDED ACCORDING TO C.O.A. SPECIFICATION 1012 "NATIVE GRASS SEEDING". THIS WILL BE CONSIDERED INCIDENTAL TO CONSTRUCTION, THEREFORE, NO SEPARATE PAYMENT WILL BE MADE.

SHEET KEYNOTES

- NEW DOUBLE "D" STORM INLET PER B3/CG-301 INV. OUT 21.85 TG 24,5
- (2) NEW 30" PREFABRICATED HDPE END SECTION (3) NEW CHANNEL PENETRATION PER CG-303. SO #19 PERMIT
- REQUIRED, SEE CONST. NOTE 7 (4) NEW 4' DIA SDMH PER D1/CG-302
- INSTALL 18" RCP STORM DRAIN, SLOPE AS NOTED
- install 30" hdpe (smooth interior) storm drain with water tight joints and water stops at inlet and manhole CONNECTIONS - SLOPE AS NOTED (7) CONSTRUCT BEEHIVE INLET PER B5/CG-301. INVERT AND GRATE
- ELEVATION AS NOTED. (B) INSTALL 18" HDPE (SMOOTH INTERIOR) STORM DRAIN WITH WATER TIGHT JOINTS AND WATER STOPS AT INLET AND MANHOLE
- 9 NEW 18" PREFABRICATED HDPE END SECTION

CONNECTIONS ● S=0.0200

(10) CONSTRUCT 10'x10' RIP-RAP APRON PER B1/CG-301 (11) REVEGETATE DISTURBED AREA PER EROSION CONTROL MEASURE #4

LEGEND

25.41

PROPOSED SPOT ELEVATION EXISTING FLOWLINE ELEVATION PROPOSED CONTOUR EXISTING CONTOUR

PROPOSED FLOWLINE

ROOF DIRECTION OF FLOW PROPOSED CONCRETE

PROPOSED ASPHALT PAVEMENT

DRAWN BY JLP/BLE/DMH/CFA REVIEWED BY G.M. 06-29-2009 PROJECT NO. 08-0041

REVISIONS

DRAWING NAME **GRADING PLAN**

JUN 2 9 2069



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2009.006.1

File Path: E\DATA\ACAD14\2009.006.1\ | Plot Date: | 06-26 | File Name: 90061CG-102.DWG | Plot Time: | 1:18 | E

GRADING PLAN (NORTH)

Albuquerque, NM 87109

7601 Jefferson NE Suite 100

505 761-9700

fax 761-4222

ARCHITECT


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engineering


ENGINEER




NEW TECH HIGH SCHOOL 5325 MONTGOMERY NE ALBUQUERQUE, NM

TYPICAL 24" X24" STORM INLET SECTION

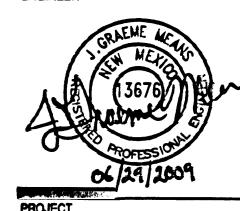
SCALE: 1" = 1'-0"

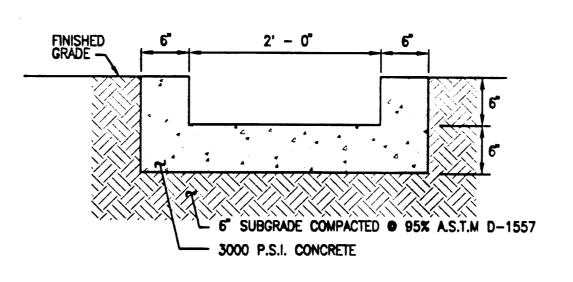


TYPICAL CONCRETE RUNDOWN SECTION

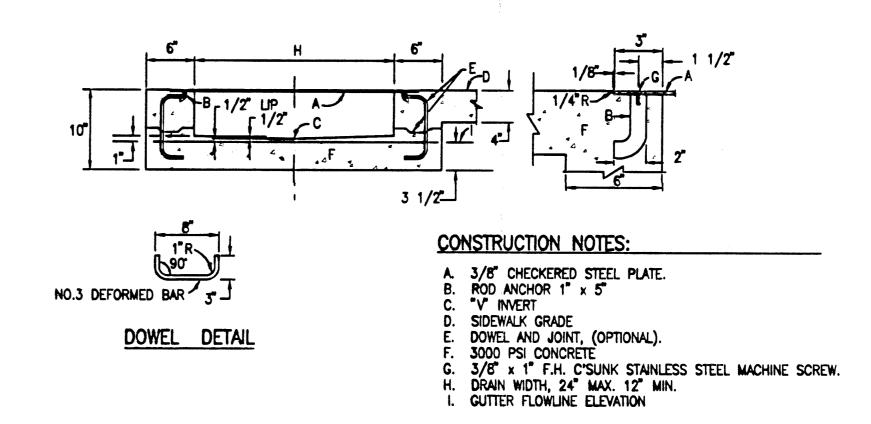


TYPICAL SIDEWALK CULVERT DETAILS

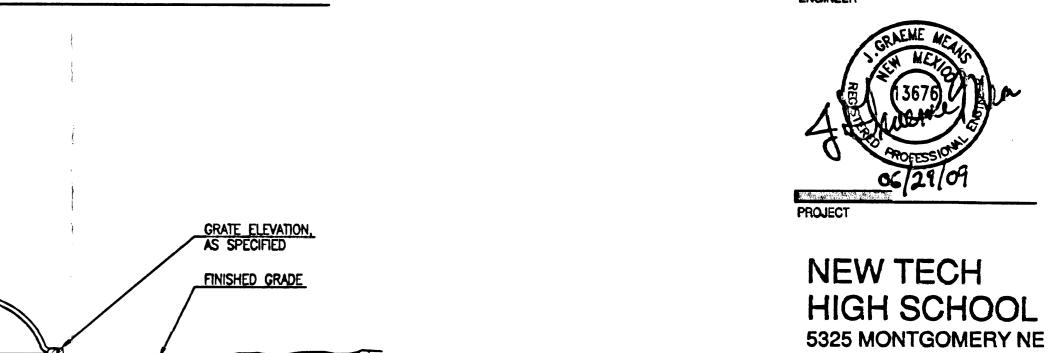

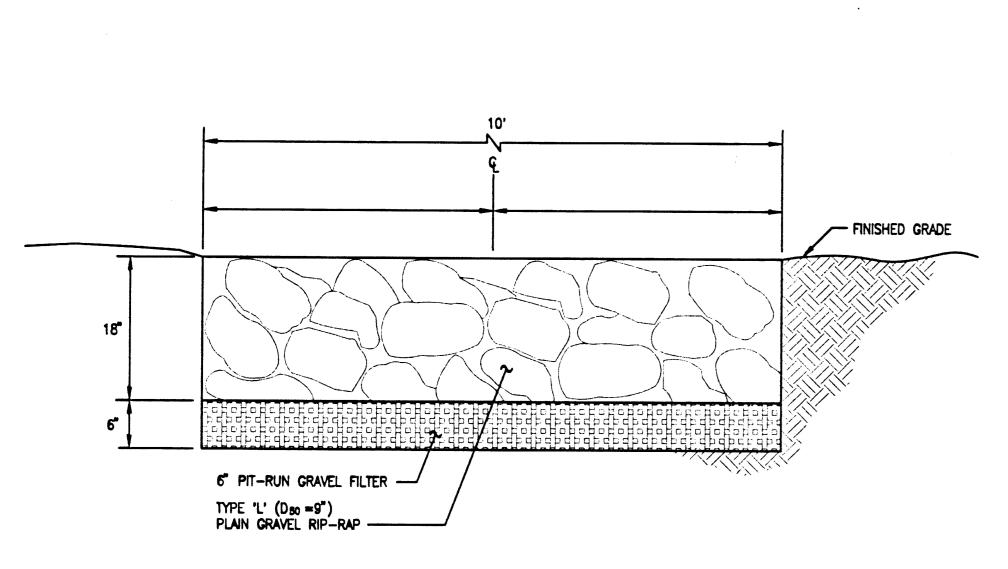


B1 TYPICAL RIP-RAP APRON SECTION


SCALE: 1" = 1'-0"

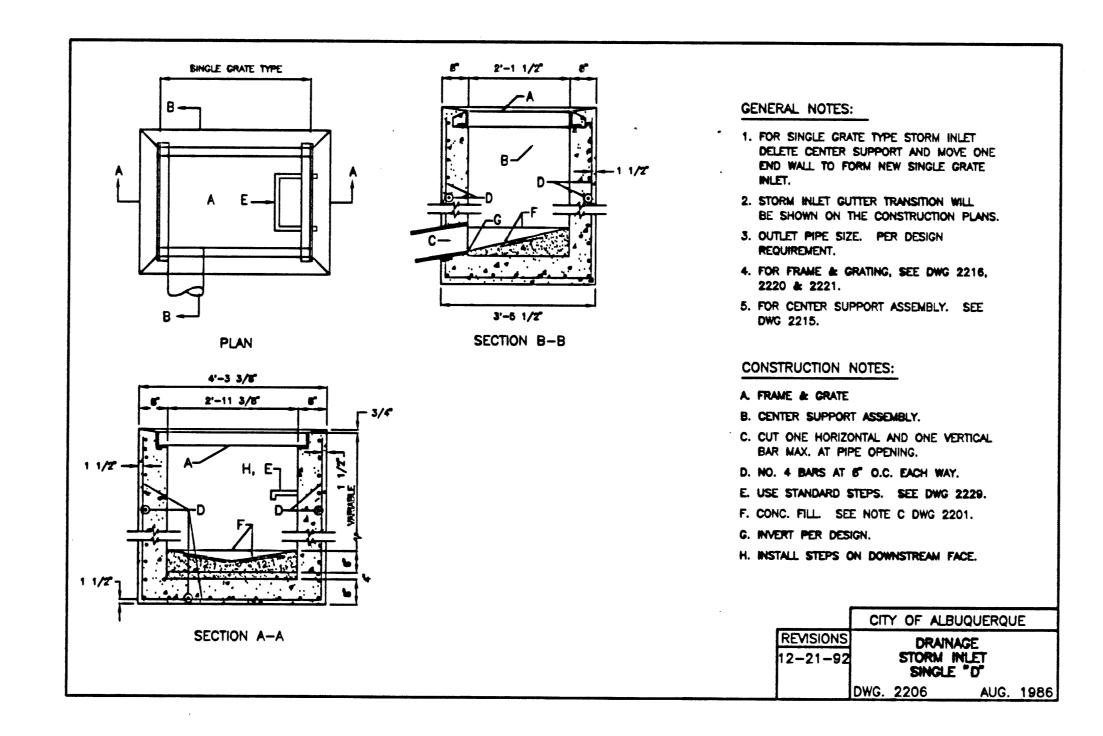

TYPICAL 'D' INLET

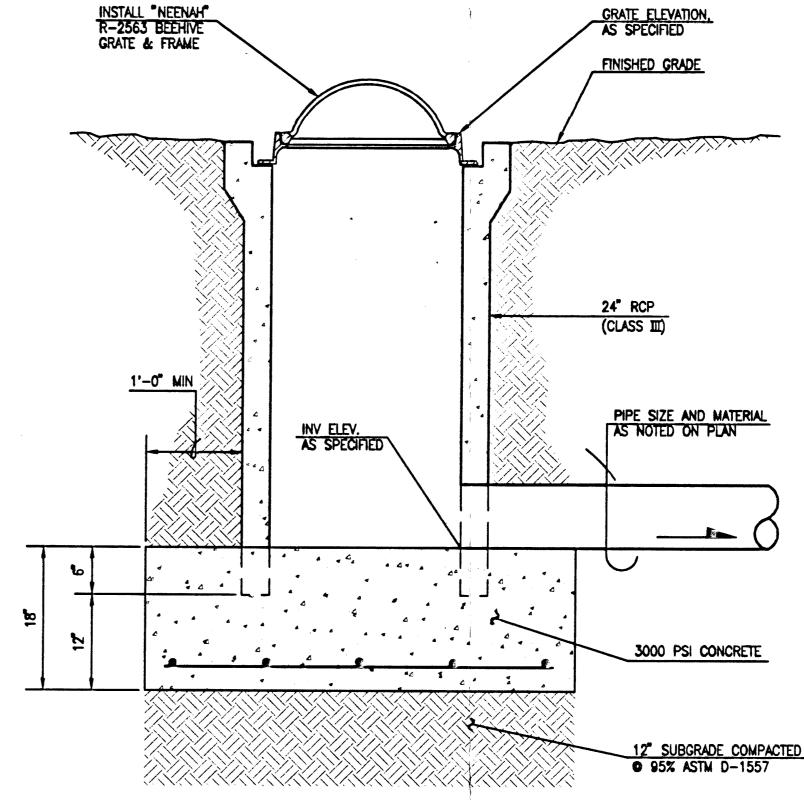

BEEHIVE INLET SECTION NOTE:
IN LIEU OF THE BEEHIVE INLET DETAILED ABOVE, CONTRACTOR MAY SUBSTITUTE A NYLOPLAST 24-INCH DRAIN BASIN WITH DOMED GRATE.

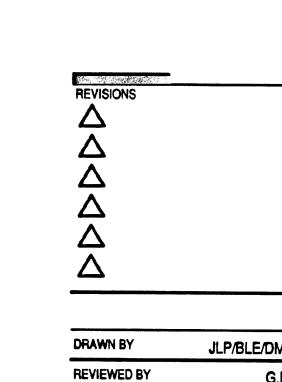

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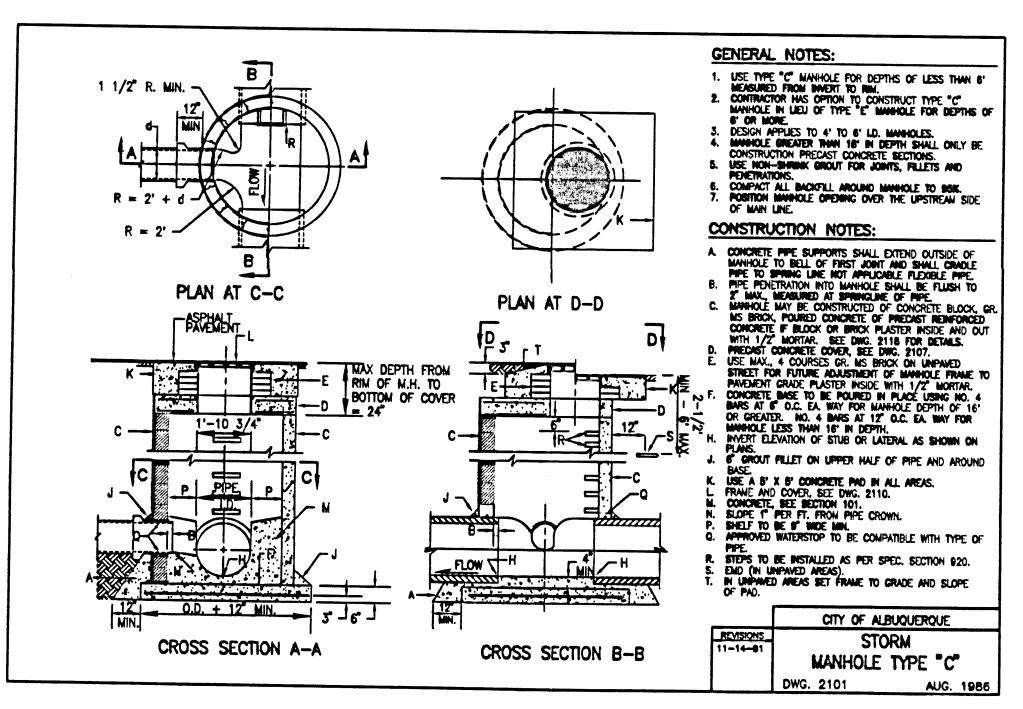
ALBUQUERQUE, NM

JLP/BLE/DMH G.M. 06-29-2009 PROJECT NO. 08-0041 DRAWING NAME


GRADING AND

CG-301


RECEIVED PRAINAGE SECTIONS DETAILS JUN 29 2003 MESA Consulting Group 6010-B MIDWAY PARK BLVD. NE • ALBUQUERQUE, NEW MEXICO 87109 PHONE: 505.345.4250 • FAX: 505.345.4254 • www.highmesacg.com 2009.006.1






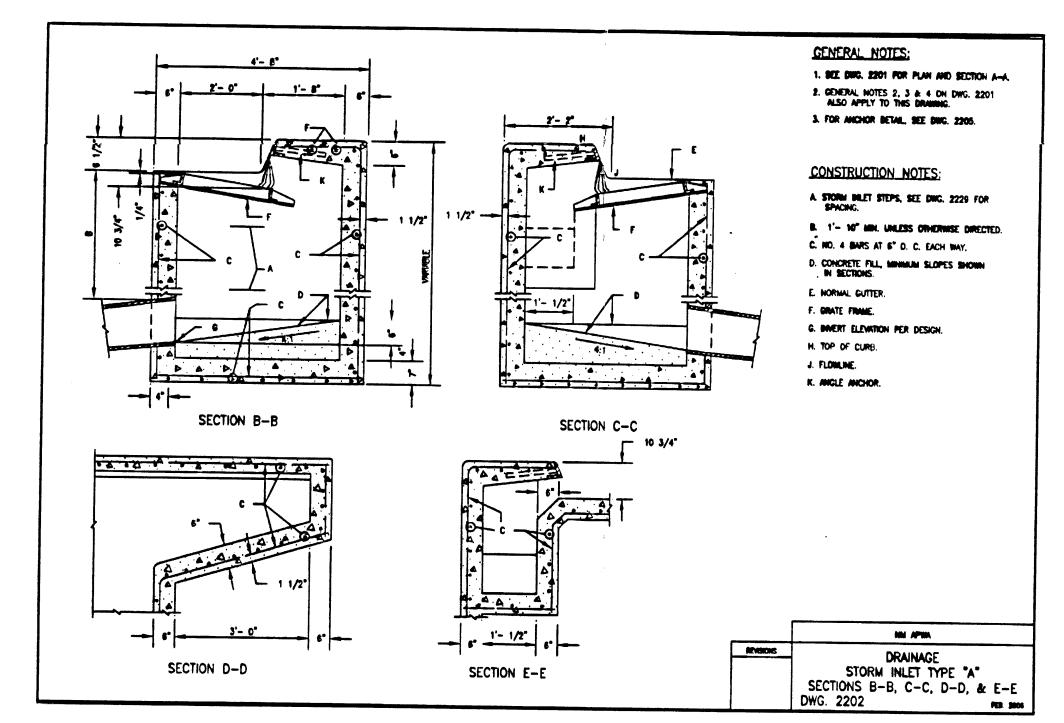


DRAINAGE STORM INLET TYPE "A"

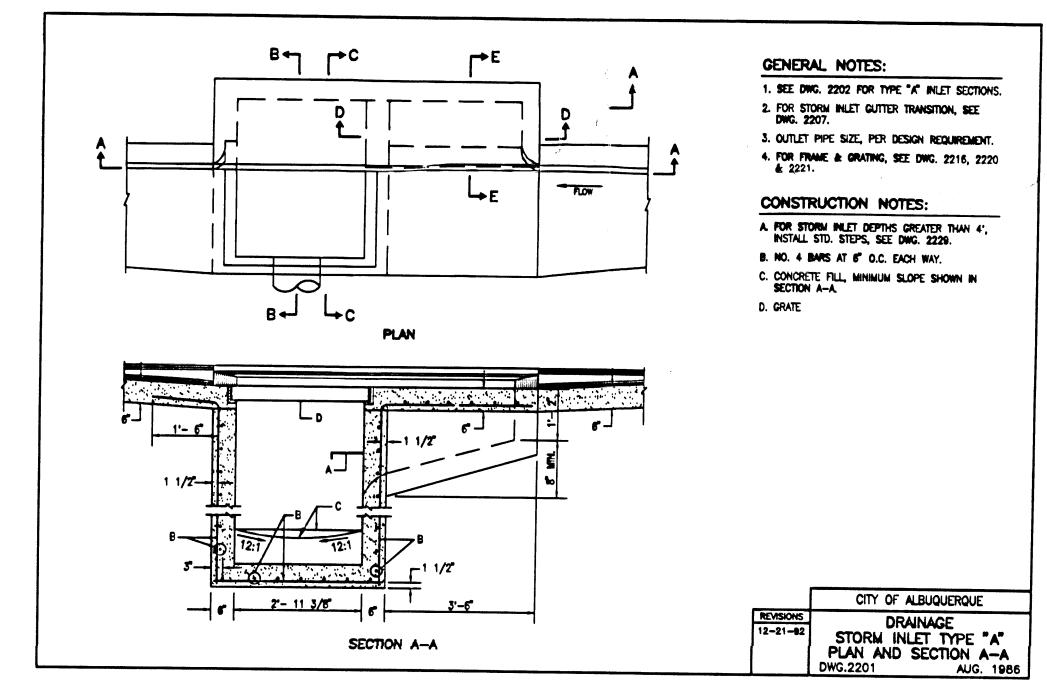


DRAINAGE STORM INLET TYPE "A"

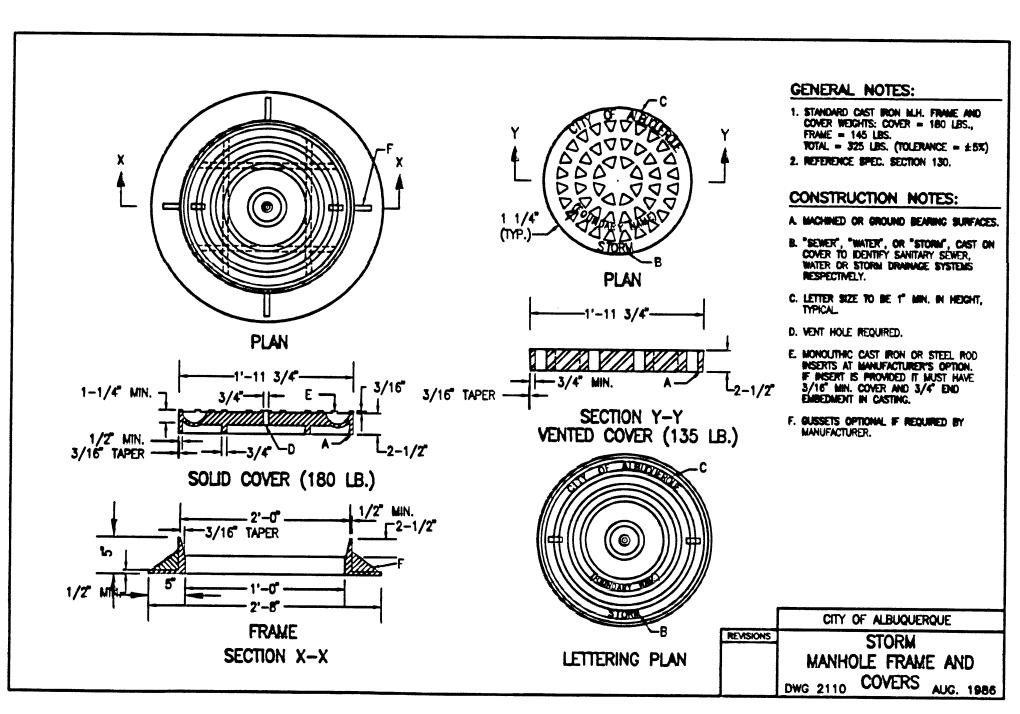


STORM MANHOLE FRAME AND COVERS

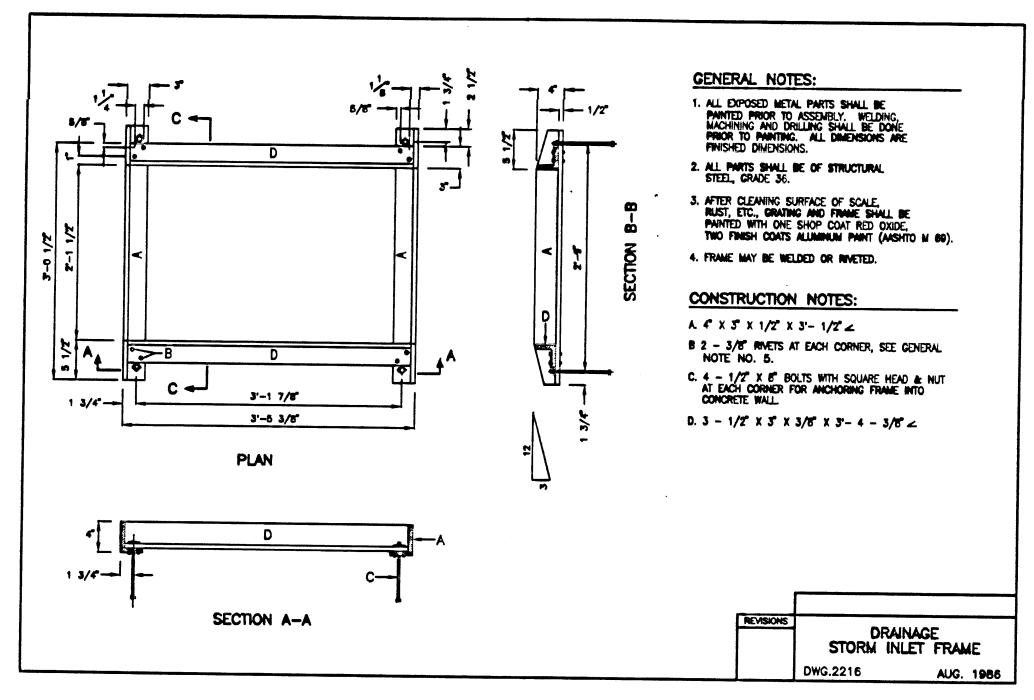


STORM INLET FRAME (FOR TYPES A, C & D)
NOT TO SCALE

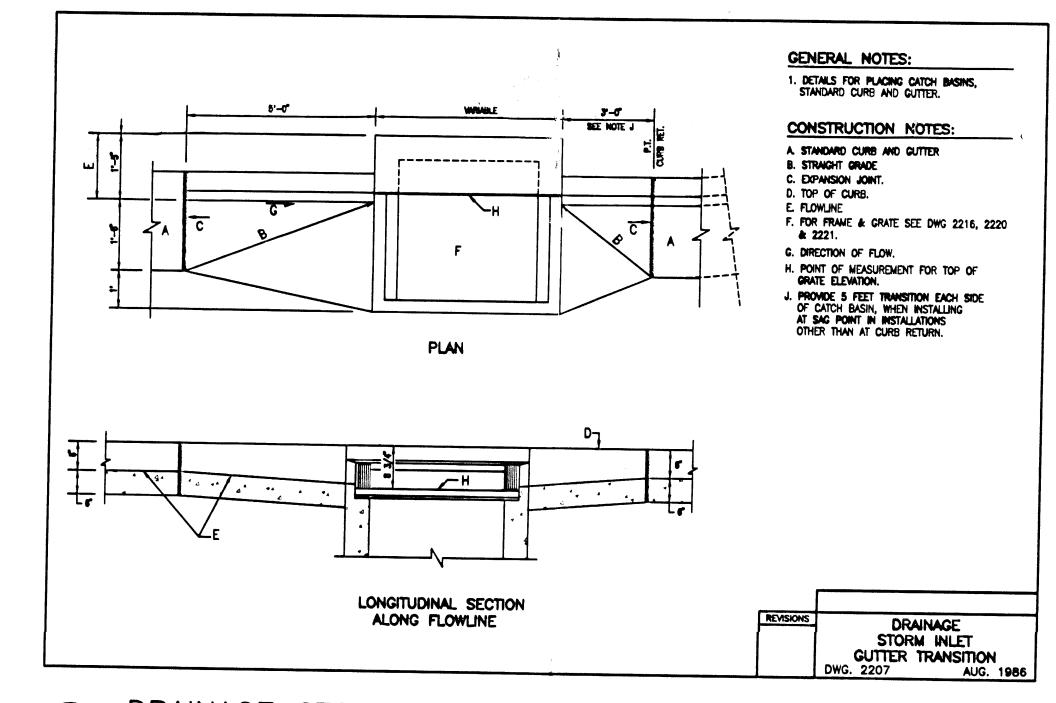


DRAINAGE STORM INLET GUTTER TRANSITION

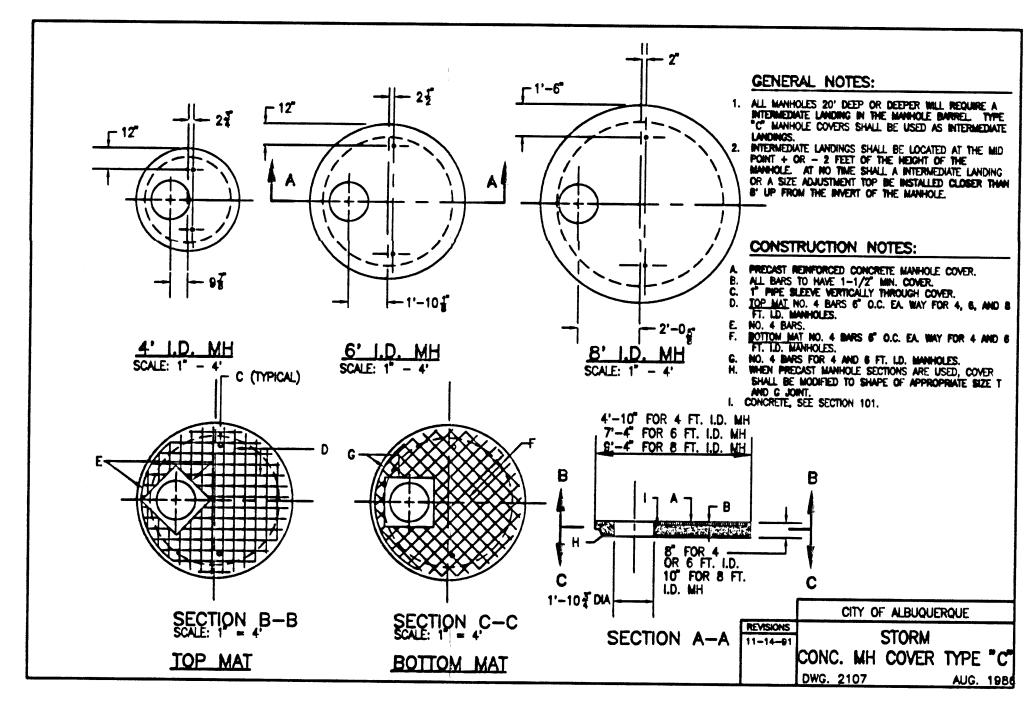


STORM CONCRETE MANHOLE COVER TYPE "C"

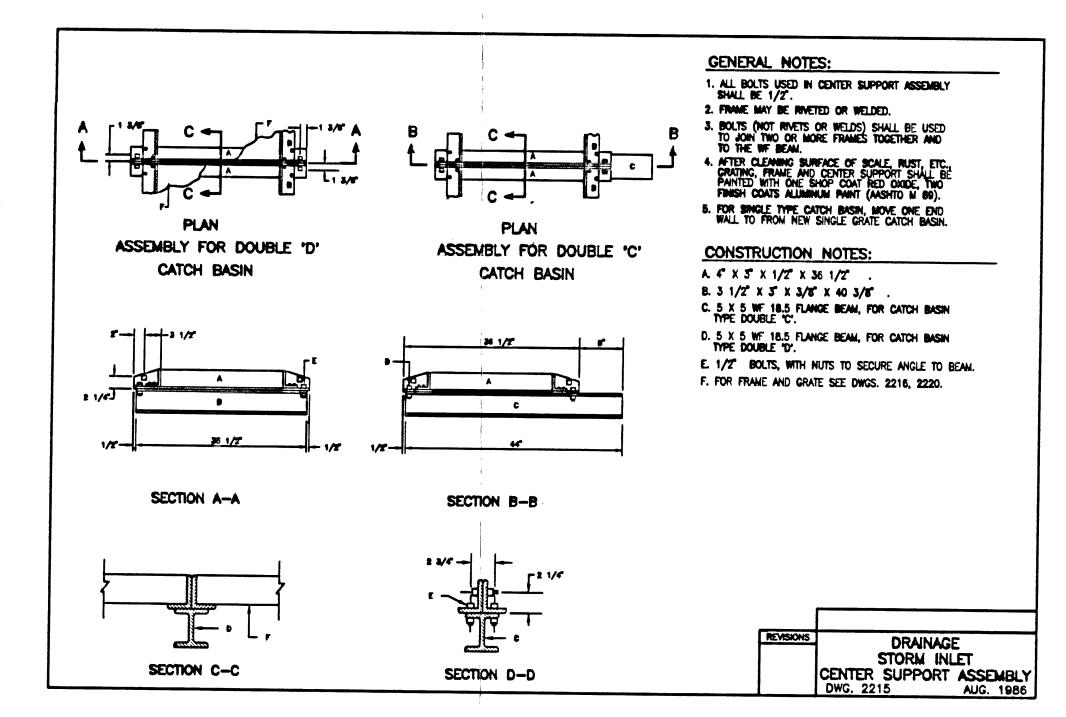

STORM INLET CENTER SUPPORT (FOR TYPES A, C & D)

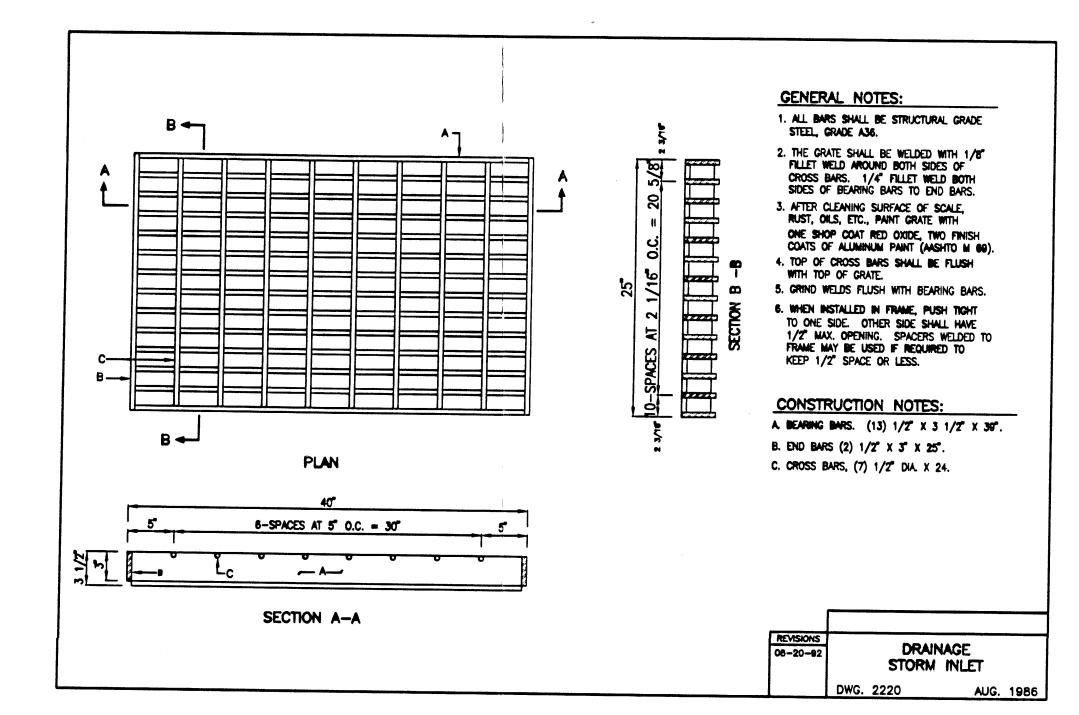


STORM INLET GRATE (FOR TYPES A, C & D)

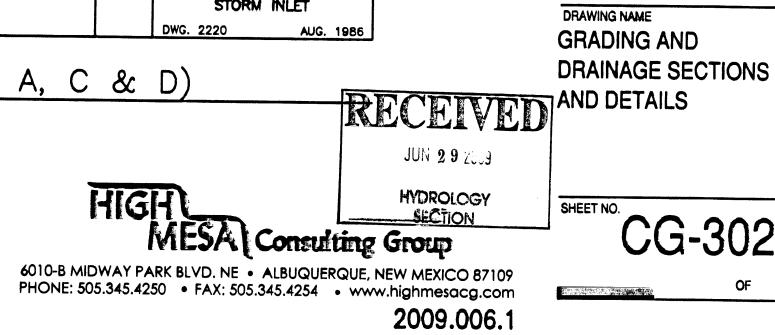

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architecture

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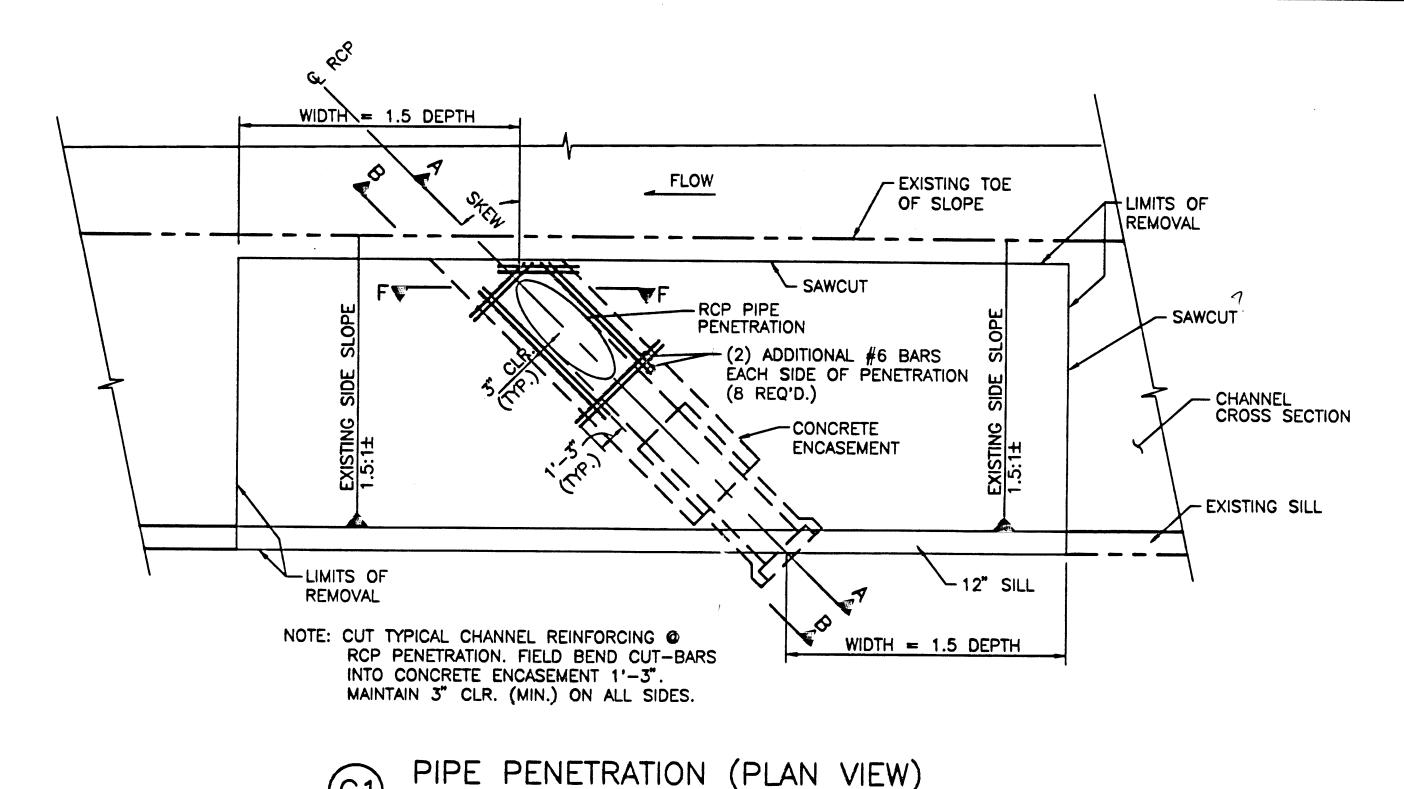



NEW TECH HIGH SCHOOL **5325 MONTGOMERY NE** ALBUQUERQUE, NM

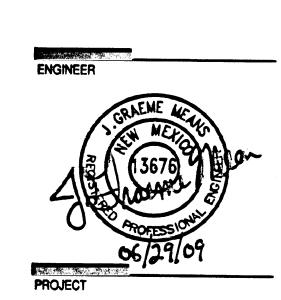JLP/BLE/DMH REVIEWED BY G.M. 06-29-2009 PROJECT NO. 08-0041

CG-302

	DIMENSION "A" FOR 2:1 SIDE SLOPE							
SKEW ANGLE				PIPE HI	EIGHT (INCH	HES)		· .
(DEGREES)	24	30	36	42	48	54	60	72
0-10	5'-9"	6'-9"	7'-10"	8 10	9'-10"	10'-10"	11'-11"	13'-11"
>10-20	5'-11"	7'-0"	8'-1"	9'-2"	10'-3	11'-3"	12'-4"	14'-6"
>20-30	6'-4"	7'-6"	8'-7"	9'-9"	10'-11"	12'-1"	13'-3"	15'-7"
>30-45	7'-4"	8'-9"	10'-2"	11'-7"	13'-0"	14'-5"	15'-10"	18-9"



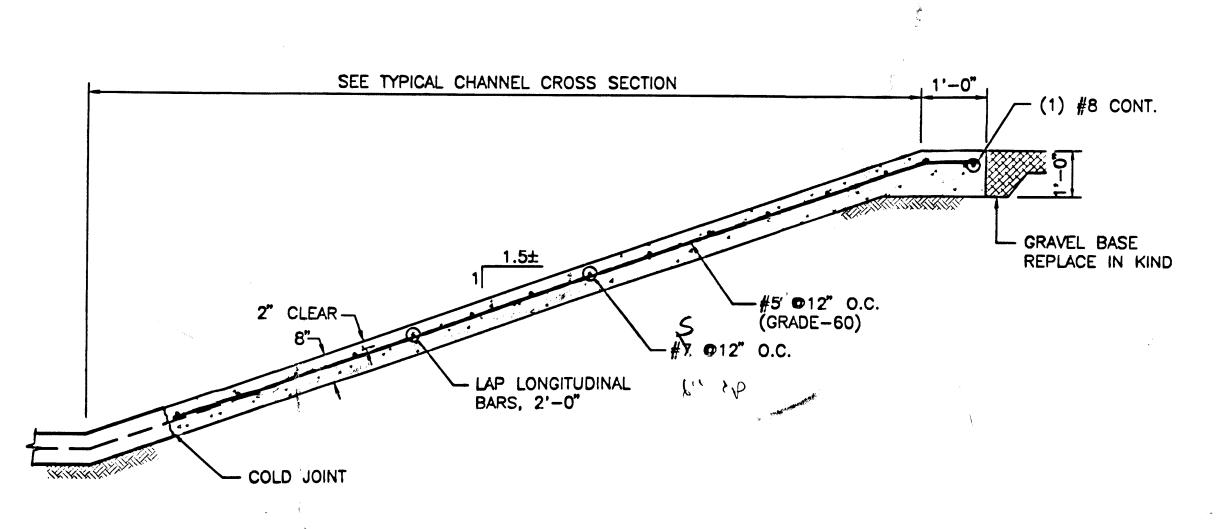

CONCRETE SLOPE PAVEMENT


SEE TYP. CHANNEL CROSS SECTION -REINFORCED CONCRETE CHANNEL LINING ERMISSIBLE CONSTRUCTION 1 1/2" RADIUS ---3" MIN-5221.00 MATCH GRADE OF RCP 2%, TYP. CONSTRUCTION JOINT-- PERMISSIBLE CONSTRUCTION "A" MIN. DIMENSION PARALLEL TO & RCP


SECTION A-A


4 3" CLR

SECTION C-C

-#4 BARS @ 12"O.C.

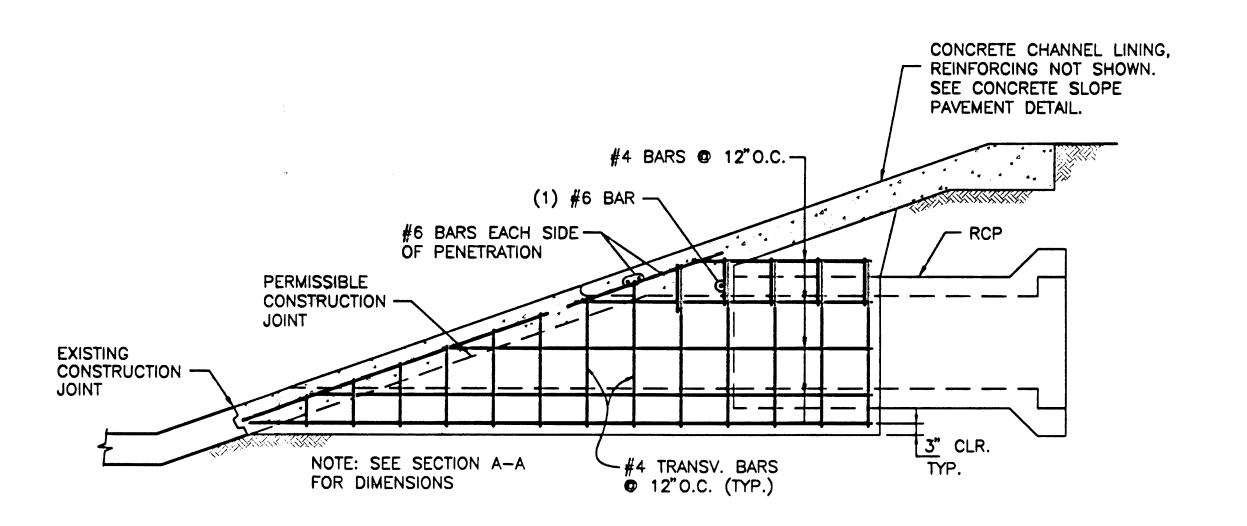

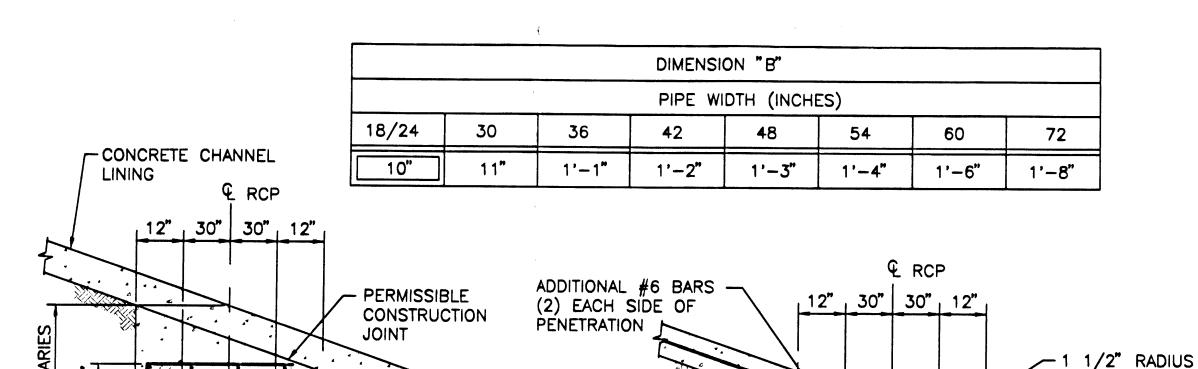

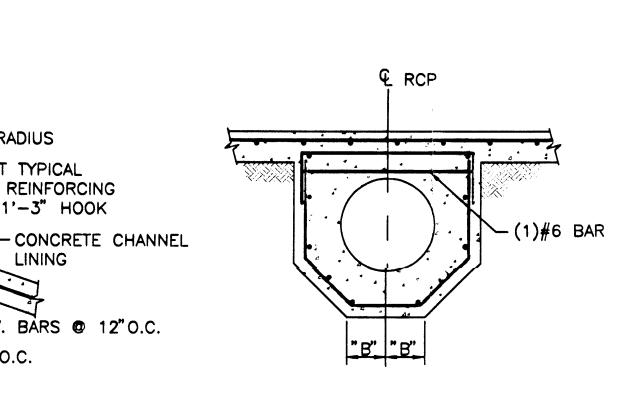

- FIELD CUT TYPICAL

-#4 BARS ♥ 12"O.C.


SECTION D-D

NOT TO SCALE

CHANNEL REINFORCING

PROVIDE 1'-3" HOOK

#4 TRANSV. BARS @ 12"O.C.

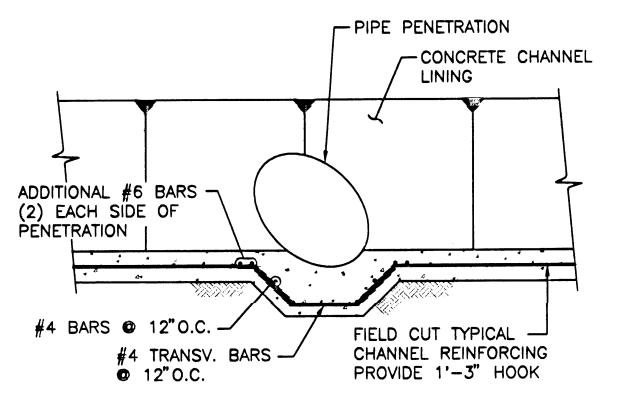

SECTION E-E

NOT TO SCALE





- 1. TWO (2) WORKING DAYS PRIOR TO ANY EXCAVATION, CONTRACTOR MUST CONTACT NEW MEXICO ONE CALL SYSTEM 260-1990 (ALBUQUERQUE AREA), 1-800-321-ALERT(2537) (STATEWIDE), FOR LOCATION OF EXISTING UTILITIES, AND ABASTO UTILITY LOCATING COMPANY (889-3341) FOR LOCATION OF EXISTING PRIVATE UTILITIES ON APS PRÓPERTY.
- 2. PRIOR TO CONSTRUCTION, THE CONTRACTOR SHALL EXCAVATE AND VERIFY THE HORIZONTAL AND VERTICAL LOCATION OF ALL POTENTIAL OBSTRUCTIONS. SHOULD A CONFLICT EXIST, THE CONTRACTOR SHALL NOTIFY THE ENGINEER IN WRITING SO THAT THE CONFLICT CAN BE RESOLVED WITH A MINIMUM AMOUNT OF DELAY. THE CONTRACTOR SHALL BE RESPONSIBLE FOR ALL INTERPRETATIONS IT MAKES

architecture interiors

landscape

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ARCHITECT

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NEW TECH

HIGH SCHOOL

5325 MONTGOMERY NE

ALBUQUERQUE, NM

dps O dpsdesign.org

planning

- WITHOUT FIRST CONTACTING THE ENGINEER AS REQUIRED ABOVE. 3. ALL WORK ON THIS PROJECT SHALL BE PERFORMED IN ACCORDANCE WITH APPLICABLE FEDERAL, STATE AND LOCAL LAWS, RULES AND REGULATIONS CONCERNING CONSTRUCTION SAFETY AND HEALTH.
- 4. ALL WORK DETAILED ON THESE PLANS TO BE PERFORMED, EXCEPT AS OTHERWISE STATED OR PROVIDED FOR HEREON, SHALL BE CONSTRUCTED IN ACCORDANCE WITH THE CITY OF ALBUQUERQUE STANDARD SPECIFICATIONS FOR PUBLIC WORKS CONSTRUCTION, 1986 EDITION AS REVISED THROUGH UPDATE #7, AMENDMENT 1
- 5. IF ANY UTILITY LINES, PIPELINES, OR UNDERGROUND UTILITY LINES ARE SHOWN ON THESE DRAWINGS, THEY ARE SHOWN IN AN APPROXIMATE MANNER ONLY, AND SUCH LINES MAY EXIST WHERE NONE ARE SHOWN. IF ANY SUCH EXISTING LINES ARE SHOWN, THE LOCATION IS BASED UPON INFORMATION PROVIDED BY THE OWNER OF SAID UTILITY, AND THE INFORMATION MAY BE INCOMPLETE. OR MAY BE OBSOLETE BY THE TIME CONSTRUCTION COMMENCES. THE ENGINEER HAS CONDUCTED ONLY PRELIMINARY INVESTIGATION OF THE LOCATION, DEPTH, SIZE, OR TYPE OF EXISTING UTILITY LINES. PIPELINES, OR UNDERGROUND UTILITY LINES. THIS INVESTIGATION IS NOT CONCLUSIVE, AND MAY NOT BE COMPLETE, THEREFORE, MAKES NO REPRESENTATION PERTAINING THERETO, AND ASSUMES NO RESPONSIBILITY OR LIABILITY THEREFOR. THE CONTRACTOR SHALL INFORM ITSELF OF THE LOCATION OF ANY UTILITY LINE, PIPELINE, OR UNDERGROUND UTILITY LINE IN OR NEAR THE AREA OF THE WORK IN ADVANCE OF AND DURING EXCAVATION WORK, THE CONTRACTOR IS FULLY RESPONSIBLE FOR ANY AND ALL DAMAGE CAUSED BY ITS FAILURE TO LOCATE, IDENTIFY AND PRESERVE ANY AND ALL EXISTING UTILITIES, PIPELINES, AND UNDERGROUND UTILITY LINES. IN PLANNING AND CONDUCTING EXCAVATION, THE CONTRACTOR SHALL COMPLY WITH STATE STATUTES, MUNICIPAL AND LOCAL ORDINANCES, RULES AND REGULATIONS, IF ANY, PERTAINING TO THE LOCATION OF THESE LINES AND FACILITIES.
- 6. THE DESIGN OF PLANTERS AND LANDSCAPED AREAS IS NOT PART OF THIS PLAN. ALL PLANTERS AND LANDSCAPED AREAS ADJACENT TO THE BUILDING(S) SHALL BE PROVIDED WITH POSITIVE DRAINAGE TO AVOID ANY PONDING ADJACENT TO THE STRUCTURE. FOR CONSTRUCTION DETAILS, REFER TO LANDSCAPING PLAN. 7. CONTRACTOR SHALL CONTACT ENGINEER TO SCHEDULE GRADING
- INSPECTION PRIOR TO LANDSCAPING TO VERIFY GRADED FLOWLINES. 8. AN EXCAVATION/CONSTRUCTION PERMIT WILL BE REQUIRED BEFORE BEGINNING ANY WORK WITHIN CITY RIGHT-OF-WAY. AN APPROVED COPY OF THESE PLANS MUST BE SUBMITTED AT THE TIME OF APPLICATION FOR THIS PERMIT.
- 9. BACKFILL COMPACTION SHALL BE ACCORDING TO _____
- 10. MAINTENANCE OF THESE FACILITIES SHALL BE THE RESPONSIBILITY OF THE OWNER OF THE PROPERTY SERVED.

APPROVALS	NAME	DATE
HYDROLOGY		
SIDEWALK INSPECTOR		
STORM DRAIN MAINTENANCE		

EROSION CONTROL MEASURES

- 1. THE CONTRACTOR SHALL ENSURE THAT NO SOIL ERODES FROM THE SITE INTO PUBLIC RIGHT-OF-WAY OR ONTO PRIVATE PROPERTY. 2. THE CONTRACTOR SHALL PROMPTLY CLEAN UP ANY MATERIAL EXCAVATED WITHIN THE PUBLIC RIGHT-OF-WAY SO THAT THE EXCAVATED MATERIAL IS NOT SUSCEPTIBLE TO BEING WASHED DOWN
- 3. WHEN APPLICABLE, CONTRACTOR SHALL SECURE "TOPSOIL DISTURBANCE PERMIT" FROM THE CITY AND/OR FILE A NOTICE OF INTENT (N.O.I.)
- WITH THE EPA PRIOR TO BEGINNING CONSTRUCTION. 4. UNLESS FINAL STABILIZATION IS OTHERWISE PROVIDED FOR, ANY AREAS OF EXCESS DISTURBANCE (TRAFFIC ACCESS, STORAGE YARD, EXCAVATED MATERIAL, ETC.) SHALL BE RE-SEEDED ACCORDING TO C.O.A. SPECIFICATION 1012 "NATIVE GRASS SEEDING". THIS WILL BE CONSIDERED INCIDENTAL TO CONSTRUCTION, THEREFORE, NO SEPARATE PAYMENT WILL BE MADE.

GENERAL NOTES

- . ALL WORK ON THE CHANNEL LINING SHALL BE COMPLETED BETWEEN OCTOBER 15 AND MAY 15, WITH COMPLETE PROTECTION FROM INFILTRATION OF WATER TO THE SUBGRADE.
- 2. COMPLETE ARMORING OF THE CHANNEL SHALL BE IN PLACE BETWEEN MAY 15 AND OCTOBER 15. THE CONTRACTOR SHALL BE ALLOWED TO WORK WITHIN THE CHANNEL AT HIS OWN RISK, BUT SHALL NOT EXPOSE CHANNEL SUBGRADE DURING THIS TIME.
- 3. ALL EXPOSED CHANNEL SUBGRADE SHALL BE PROTECTED WITH TEMPORARY BACKFILL AND PLASTIC TO PREVENT STANDING WATER AND INFILTRATION INTO THE EXPOSED SUBGRADE PRIOR TO REPLACEMENT OF CHANNEL LINING.
- 4. THE PIPE PENETRATION DETAILED HEREIN SHALL BE PAID FOR LUMP SUM AND SHALL BE COMPENSATION FOR THE PENETRATION COMPLETE AND IN-PLACE. INCLUDED IN THIS WORK (BUT NOT LIMITED TO) IS GRADING, SUBGRADE PREPARATION, REINFORCED CONCRETE SLOPE PAVEMENT, REINFORCING, CONSTRUCTION JOINTS, CONCRETE PLACEMENT
- 5. SEE CONCRETE SLOPE PAYING REPLACEMENT DETAILS FOR NEW TO EXISTING CONSTRUCTION JOINT DETAILS

6. PLACE ALL FILL @ 95% MODIFIED PROCTOR DENSITY.

- 7. WIDTH AS SHOWN IN PLAN SHALL BE 1.5 x CHANNEL DEPTH UNLESS SPECIAL PROVISIONS FOR A LESSER WIDTH ARE MADE.
- T DIDE DI ACED LINDER THE CHANNEL LINING OR WITHIN

8.	ALL CULVE CITY RIGHT						OR	WITH
9.	CONCRETE	WITHIN C	CITY RIGH	T-OF-WAY	SHALL BE	4,000	PSI	

REVISIONS	
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DRAWN BY	JLP/BLE/DMH
REVIEWED BY	G.M.
DATE	06-29-2009
PROJECT NO.	08-0041
DRAWING NAME	
GRADING AND	

SHEET NO.

DRAINAGE SECTIONS RECEIVED AND DETAILS JUN 29 2009

HYDROLOGY SECTION

HIGH SECTION
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