### CITY OF ALBUQUERQUE

Planning Department Alan Varela, Director



Mayor Timothy M. Keller

December 13, 2023

Genevieve Donart Isaacson and Arfman, Inc. 128 Monroe St NE Albuquerque, NM 87108

Re: **Natural Grocers Retail** 

4625 Wyoming Blvd NE

Request for Certificate of Occupancy- 30 Day Temp

**Transportation Development Final Inspection** 

Engineer's Stamp dated 2-1-23 (F19D013E)

Certification dated 12-12-23

Dear Ms. Donart;

Based upon the information provided in your submittal received 12-13-23, Transportation Development has no objection to a 30-Day Temporary Certificate of Occupancy. This letter serves as a "green tag" from Transportation Development for a 30-Day Temporary Certificate of Occupancy to be issued by the Building and Safety Division.

PO Box 1293

Prior to issuance of a Permanent Certificate of Occupancy, the following items are to be addressed:

Albuquerque

- 1. The holes in the parking lot where the collars need to be installed, if not filled by COB today, must be barricaded.
- 2. 7 bicycle spaces are required, the plan specifies 8, but only 4 were constructed. Provide bicycle parking per the approved plan.

NM 87103

3. Complete the sidewalk at the northwest corner of the site.

www.cabq.gov

If you have any questions, please contact me at ccherne@cabq.gov or (505) 924-3986.

Sincerely.

Curtis Cherne, P.E.

Cute a che

Senior Engineer, Planning Dept.

**Development Review Services** 

C: Laurie Elliot, Yvette Lucero, Desiree Gonzales, Wendi Alcala, James Broomfield, Dustin Campbell, Joe Oram



# City of Albuquerque Planning Department

Development & Building Services Division

### DRAINAGE AND TRANSPORTATION INFORMATION SHEET (DTIS)

Project Title:	Hydrology File #
Applicant/Agent:	Contact:
	Phone:
Email:	
Applicant/Owner:	Contact:
	Phone:
Email:	
(Please note that a DFT SITE is one that needs Si	ite Plan Approval & ADMIN SITE is one that does not need it.)
TYPE OF DEVELOPMENT: PLAT (#c	of lots) RESIDENCE
DFT SITI	E ADMIN SITE
RE-SUBMITTAL: YES NO	
<b>DEPARTMENT:</b> TRANSPORTATIO	N HYDROLOGY/DRAINAGE
Check all that apply under Both the Type of S	ubmittal and the Type of Approval Sought:
TYPE OF SUBMITTAL:	TYPE OF APPROVAL SOUGHT:
ENGINEER/ARCHITECT CERTIFICATION	N BUILDING PERMIT APPROVAL
PAD CERTIFICATION	CERTIFICATE OF OCCUPANCY TEMPORARY
CONCEPTUAL G&D PLAN	CONCEPTUAL TCL DFT APPROVAL
GRADING & DRAINAGE PLAN	PRELIMINARY PLAT APPROVAL
DRAINAGE REPORT	FINAL PLAT APPROVAL
DRAINAGE MASTER PLAN	SITE PLAN FOR BLDG PERMIT DFT
CLOMR/LOMR	APPROVAL
TRAFFIC CIRCULATION LAYOUT (TCL)	SIA/RELEASE OF FINANCIAL GUARANTEE
ADMINISTRATIVE	FOUNDATION PERMIT APPROVAL
TRAFFIC CIRCULATION LAYOUT FOR I APPROVAL	OFT GRADING PERMIT APPROVAL
TRAFFIC IMPACT STUDY (TIS)	SO-19 APPROVAL
STREET LIGHT LAYOUT	PAVING PERMIT APPROVAL
OTHER (SPECIFY)	GRADING PAD CERTIFICATION
311121 (32 2 5 1 3 <u>)</u>	WORK ORDER APPROVAL
	CLOMR/LOMR
	OTHER (SPECIFY)
DATE SUBMITTED:	

REV. 09/13/23

128 Monroe Street NE Albuquerque, NM 87108 505-268-8828 | www.iacivil.com

Date: December 12, 2023

Project: Natural Grocers (F19D013E)Subject: TCL Certification: Phase 6

#### TRAFFIC CERTIFICATION

I, Genevieve L. Donart, PE, NMPE No. 15088, of the firm Isaacson & Arfman, P.A., hereby certify that this project is in substantial compliance with and in accordance with the design intent of the DRB approved plan dated 02/01/2023. I further certify that I or someone under my direct supervision visited the project site on December 13, 2023 and have determined by visual inspection that the site conditions are as expected.

This certification is submitted in support of a request for Temporary Certificate of Occupancy.

The record information presented hereon is not necessarily complete and intended only to verify substantial compliance of the traffic aspects of this project. Those relying on the record document are advised to obtain independent verification of its accuracy before using it for any other purpose.

1

Sincerely,

Isaacson & Arfman, Inc.

Genevieve L Donart, NMPE No. 15088

Jeneviere &

# CITY OF ALBUQUERQUE

Planning Department Alan Varela, Director



Mayor Timothy M. Keller

February 16, 2023

Fred C. Arfman, P.E Isaacson & Arfman, Inc. 128 Monroe St. NE Albuquerque, NM 87108

Re: Natural Grocers Retail

4625 Wyoming Blvd. NE Traffic Circulation Layout

Engineer's Stamp 02-01-23 (F19-D013E)

Dear Mr. Arfman,

The TCL submittal received 02-03-2023 is approved for Building Permit by Transportation. A copy of the stamped and signed plan will be needed for each of the building permit plans. Please keep the original to be used for certification of the site for final C.O. for Transportation.

PO Box 1293

Albuquerque

When the site construction is completed and an inspection for Certificate of Occupancy (C.O.) is requested, use the original City stamped approved TCL for certification. Redline any minor changes and adjustments that were made in the field. A NM registered architect or engineer must stamp, sign, and date the certification TCL along with indicating that the development was built in "substantial compliance" with the TCL. Submit this certification, the TCL, and a completed <a href="mailto:Drainage and Transportation Information Sheet">Drainage and Transportation Information Sheet</a> to the <a href="mailto:PLNDRS@cabq.gov">PLNDRS@cabq.gov</a> for log in and evaluation by Transportation. An approved/accepted sidewalk easement needs to be provided as a condition for issuing a final CO.

NM 87103

Once verification of certification is completed and approved, notification will be made to Building Safety to issue Final C.O. To confirm that a final C.O. has been issued, call Building Safety at 924-3690.


www.cabq.gov


Sincerely,

Ernest Armijo, P.E.

Principal Engineer, Planning Dept. Development Review Services

C: CO Clerk, File

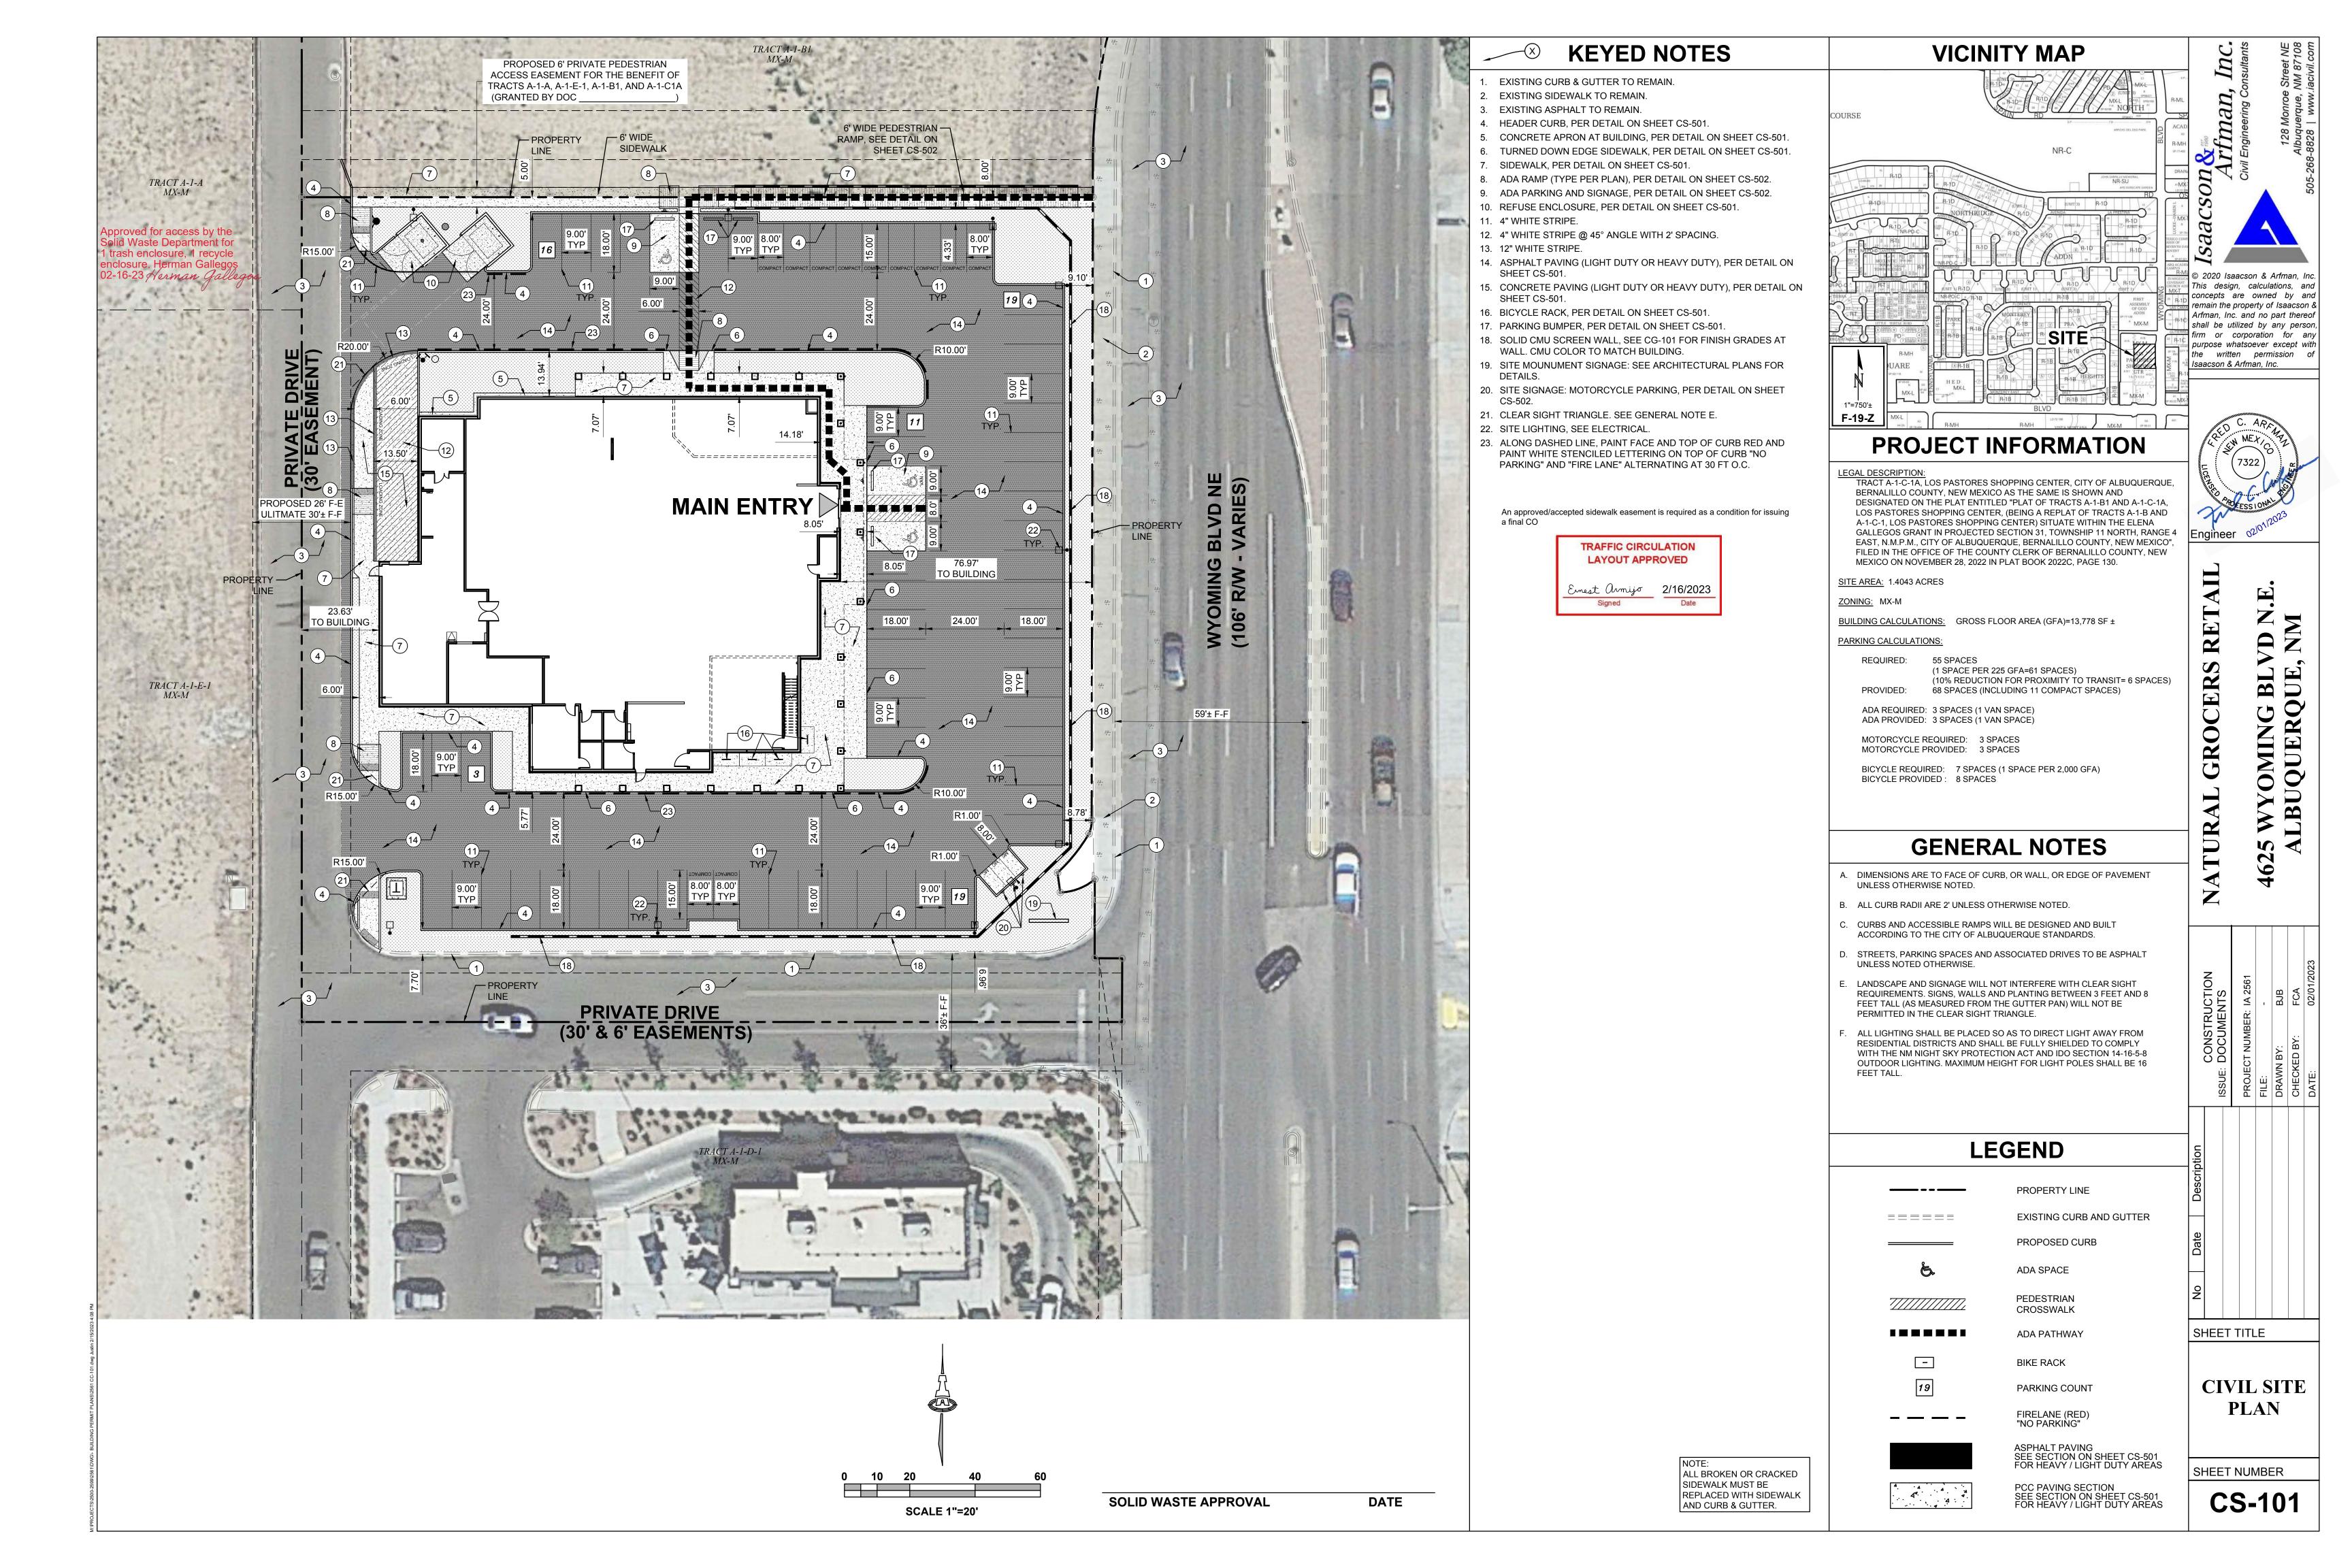

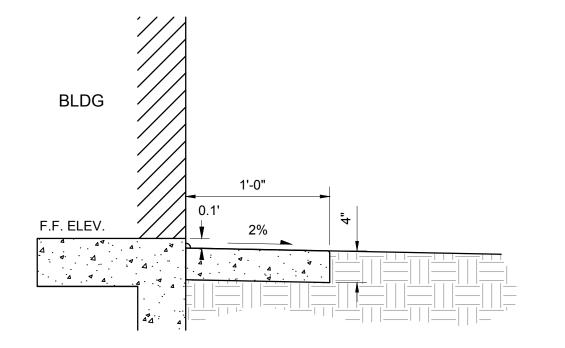

### **GENERAL NOTES**

- 1. SEALED CONTRACTION / CONTROL JOINTS @ 6' MAX.
- 2. 1/2" SEALED EXPANSION JOINTS 36' O.C.
- 3. 3/8" RADII AT ALL EXPOSED EDGES.
- 4. PROVIDE  $\frac{1}{2}$ " EXPANSION JOINT MATERIAL (FULL DEPTH) WITH SEALANT AT SURFACE BETWEEN BLDG. AND CONCRETE APRON.

### **CONCRETE APRON AT BUILDING**

ROUND CONC. TOP

PAINT SAFETY YELLOW

- 6"Ø STEEL PIPE FILLED

W/CONCRETE

**BITUMINOUS JOINT** FILLER (CONC.

PAVEMENT ONLY)

- FINISHED GRADE OR

3,500 PSI CONCRETE

SCALE: N.T.S.

SCALE: N.T.S.

PAVEMENT


FOUNDATION

1'-8"

**CONCRETE FILLED BOLLARD** 

**ASPHALT PAVING SECTIONS** 

SCALE: N.T.S.

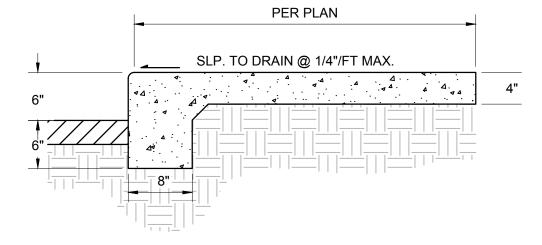


### GENERAL NOTES

- CONTRACTION / CONTROL JOINTS @ 6' O.C. MAX.
- 2. 1/2" EXPANSION JOINTS @ 24' O.C., CURB RETURNS AND EACH SIDE OF DRIVES.
- 3. REQUIRES FULL FORM ON ALL FACES.
- 4. 3/8" RADII AT ALL EXPOSED EDGES.

# SIDEWALK - TURNED DOWN EDGE

SCALE: N.T.S.

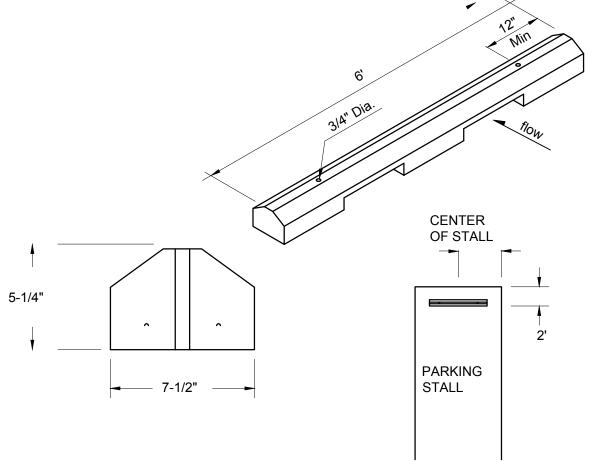

### **CONSTRUCTION NOTES**

- WHEEL STOPS TO BE PLACED 2' BACK, CENTERED IN THE PARKING STALL WHEEL STOPS CAN BE PAINTED IN A CONTRASTING COLOR SUCH AS GRAY, YELLOW OR BLACK.
- 2. BLUE SHALL BE USED FOR HANDICAP PARKING STALLS.
- 3. INSTALL EACH WITH TWO DOWELS PER MANUFACTURERS SPECIFICATIONS.


## **CONCRETE WHEEL STOP**

SCALE: N.T.S.

SCALE: N.T.S.

#### LIGHT DUTY **HEAVY DUTY** (PARKING SPACES) (DRIVE AISLES) LIGHT DUTY **HEAVY DUTY** (PARKING SPACES) (LOADING & REFUSE AREAS) 2" RESIDENTIAL 3" RESIDENTIAL ASPHALT SP-III ASPHALT SP-III 10'X13' CONSTRUCTION -2 1/2" RESIDENTIAL JOINT PATTERN. 6" COMPACTED -ASPHALT SP-III 5.5" PCC W/ #4 BARS -5.5" PCC W/ #4 BARS AGGREGATE BASE 6" COMPACTED 44 4 ...4 EACH WAY @ 12" O.C. EACH WAY @ 12" O.C. COURSE AGGREGATE BASE COURSE 12" SUBGRADE SOIL, R-VALUE >50 - 12" SUBGRADE SOIL 12" SUBGRADE SOIL, 12" SUBGRADE SOIL, COMPACTED TO 95% R-VALUE >50 R-VALUE >50 R-VALUE >50 COMPACTED TO 95% COMPACTED TO 95% COMPACTED TO 95% SUBGRADE -- SUBGRADE SUBGRADE -COMPACTED TO 90% COMPACTED TO 90% SUBGRADE COMPACTED TO 90% COMPACTED TO 90% ALL EARTHWORK, OVER-EXCAVATION, COMPACTION, SUBGRADE PREPARATION ETC. TO BE PER THE GEOTECHNICAL ENGINEERING REPORT CONTRACTION / CONTROL JOINT: PREPARED BY TERRACON CONSULTANTS, INC. DATED JANUARY 23, 2023. TROWELED 3 RADII EDGES 3 DEEP

# **CONCRETE PAVEMENT SECTION**

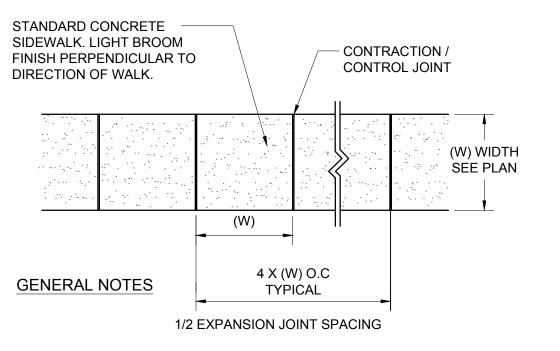

### **GENERAL NOTES**

- 1. 4000 PSI COMPRESSIVE STRENGTH CONCRETE
- 2. SEE CONCRETE JOINTS DETAIL
- 3. FINISHED EDGE OF ASPHALT PAVING TO BE 1/2" ABOVE EDGE OF CONCRETE (TYP).
- 4. 3/8" RADII AT ALL EXPOSED EDGES.


### **CONCRETE WALK**

CONC. FOOTING.

A 1-FOOT CLEAR ZONE MUST

BE PROVIDED AROUND

BICYCLE PARKING STALL

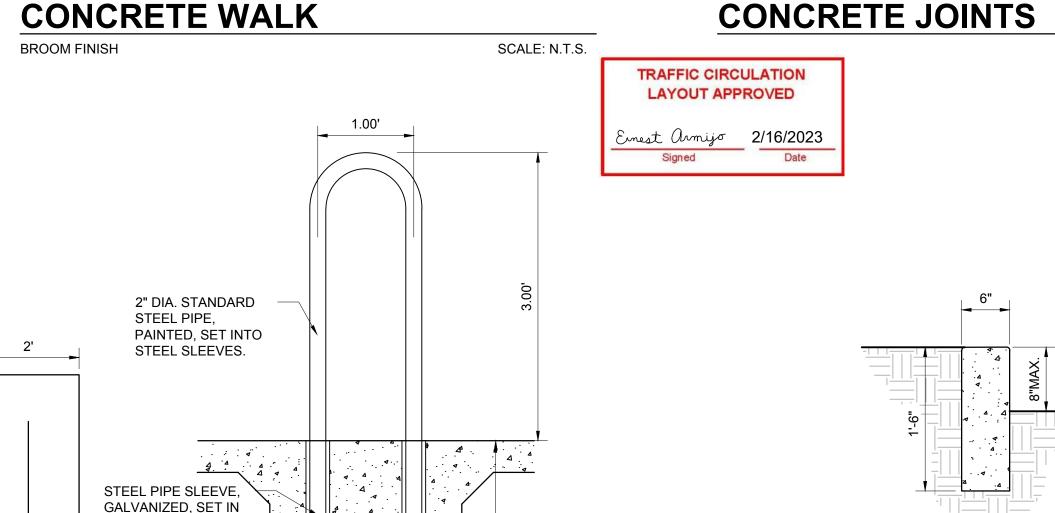

### **GENERAL NOTES**

1. CONTRACTION / CONTROL JOINTS @ 6' MAX.

CONSTRUCTION JOINT

1. ODD-SHAPED AREAS OF PAVEMENT SHOULD BE AVOIDED TO MINIMIZE

3. TRANSVERSE JOINT SPACING SHALL BE AT REGULAR INTERVALS OF 15'

2. LONGITUDINAL JOINT SPACING SHALL NOT EXCEED 12.5'

4. OFFSETS AT RADIUS POINTS SHALL BE AT LEAST 1.5' WIDE

— 1/4" TOOLED JOINT

SCALE: N.T.S.

W/ 1/8" RADII.

CONTRACTION / CONTROL

**JOINT** 

- 1/2" PREMOLDED

**EXPANSION JOINT** 

CONSTRUCTION NOTES

RANDOM CRACKING

**EXPANSION JOINT** 

MATERIAL. 1/4" RADII

- 2. 1/2" EXPANSION JOINTS 24' O.C.
- 3. REQUIRES FULL FORM ON ALL FACES
- 4. 3/8" RADII AT ALL EXPOSED EDGES.

### **BICYCLE RACK**

PLAN VIEW

SCALE: N.T.S.

4 4 4


0.50'

1.00'

DIAMETER

### **HEADER CURB**


SCALE: N.T.S.

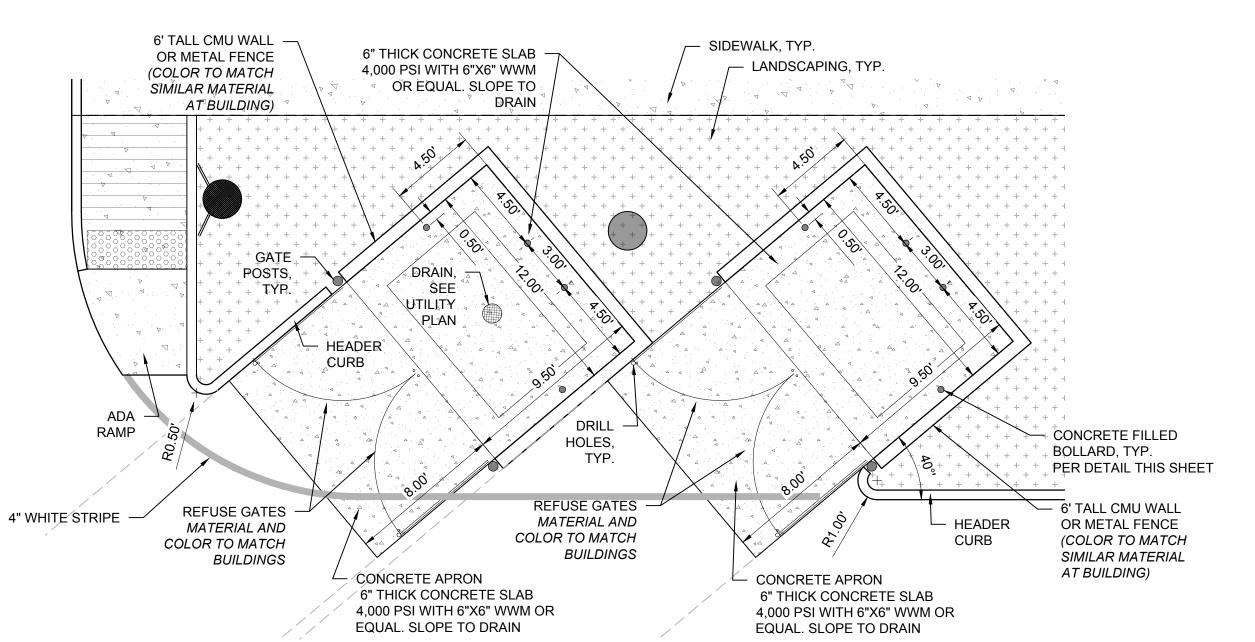

### REFUSE ENCLOSURE

SCALE: N.T.S.

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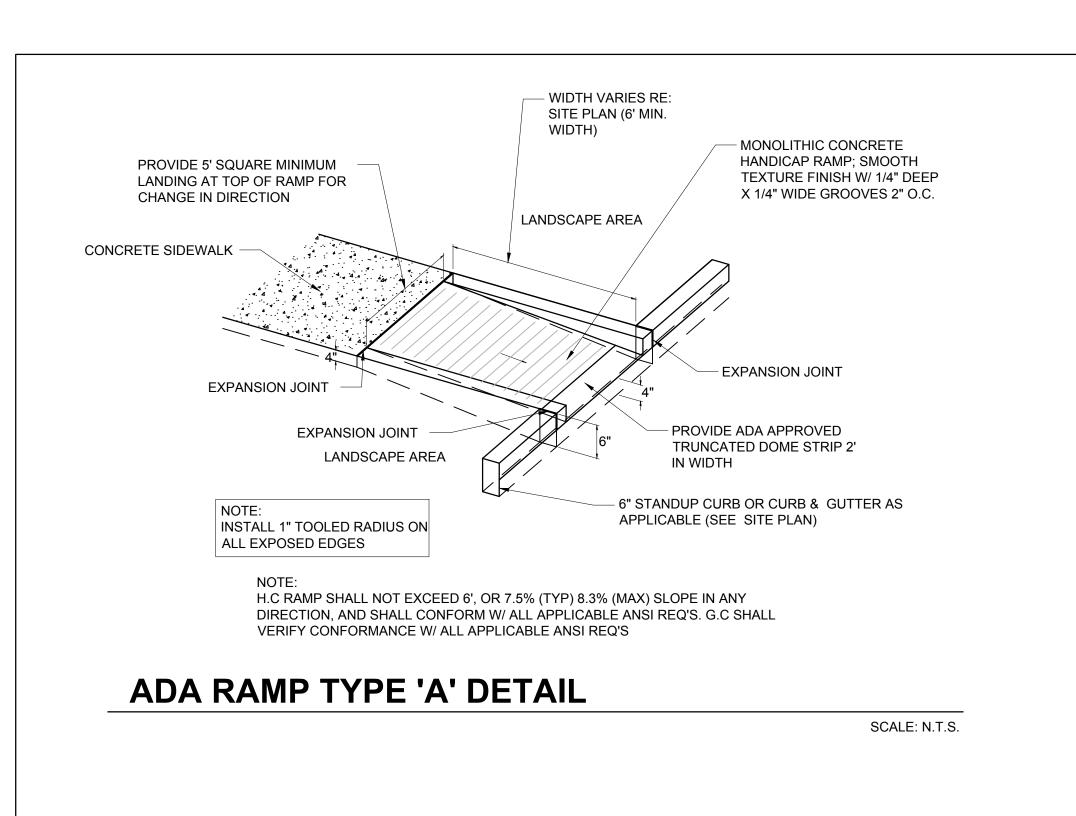
462

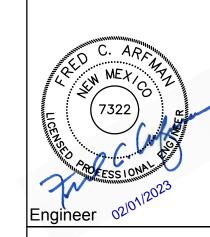
SHEET TITLE

**CIVIL SITE DETAILS** 

SHEET NUMBER

**CS-501** 



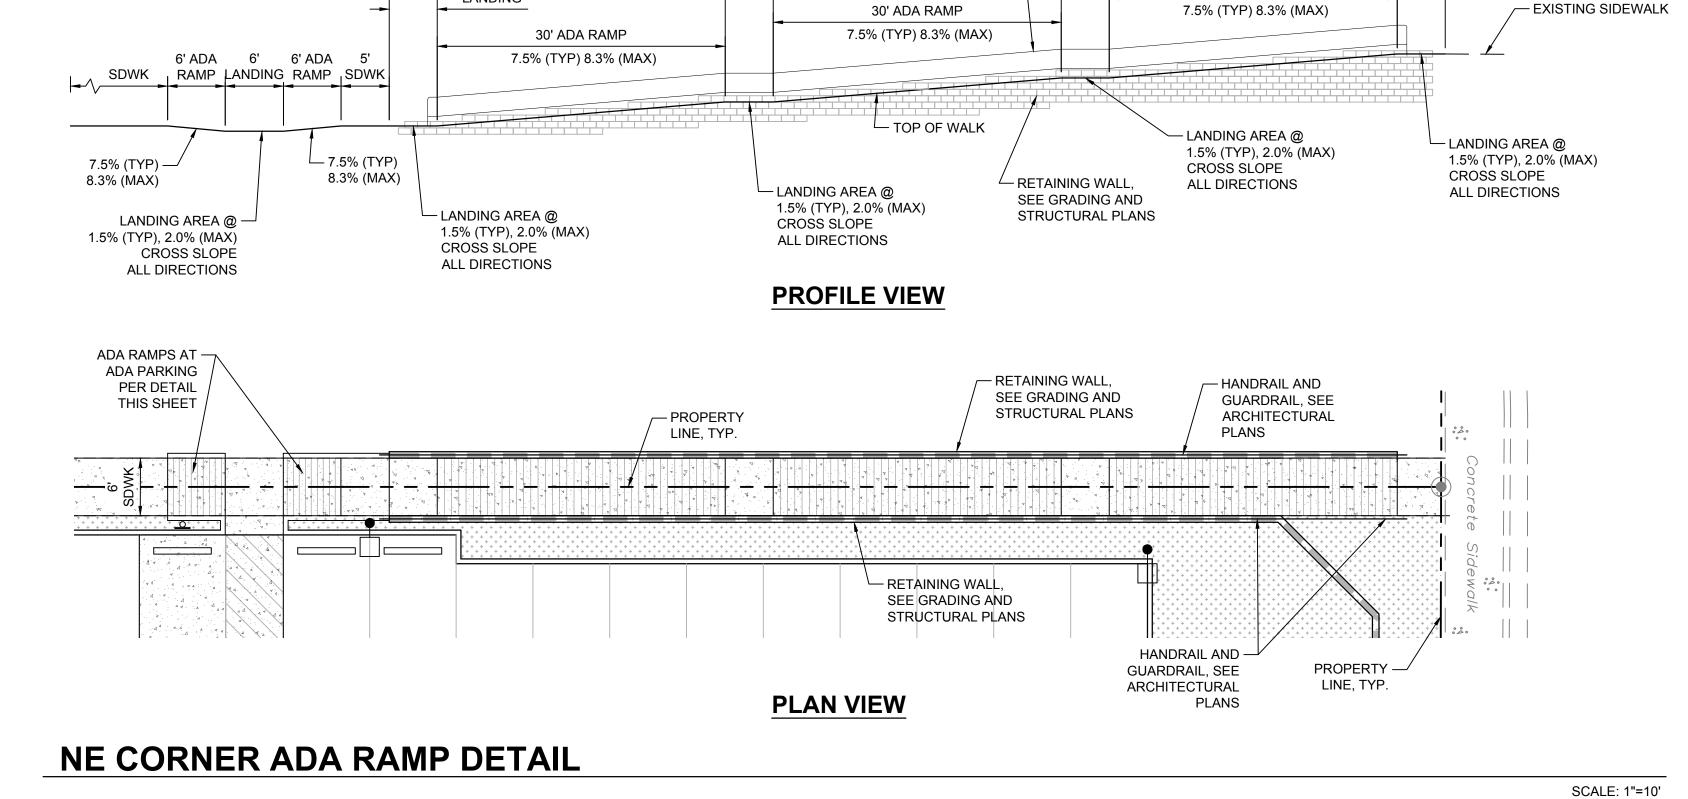

HANDRAIL AND GUARDRAIL, -

LANDING

LANDING


SEE ARCHITECTURAL

**PLANS** 

LANDING

30' ADA RAMP

LANDING

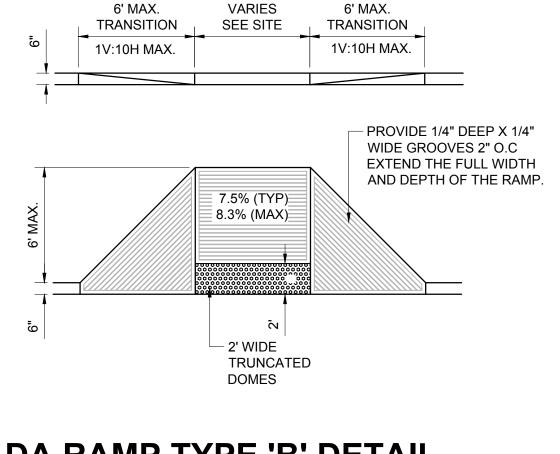







**SIGNAGE** 

# **ADA RAMP TYPE 'B' DETAIL**

SCALE: N.T.S.

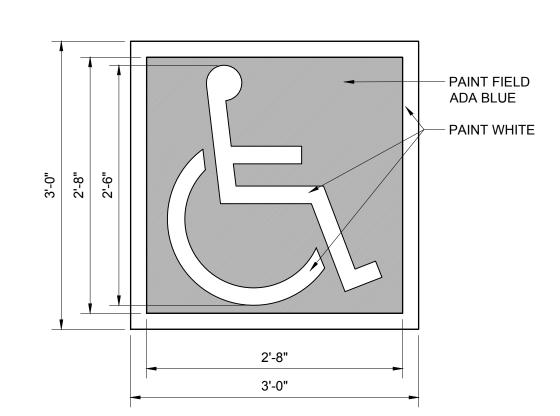



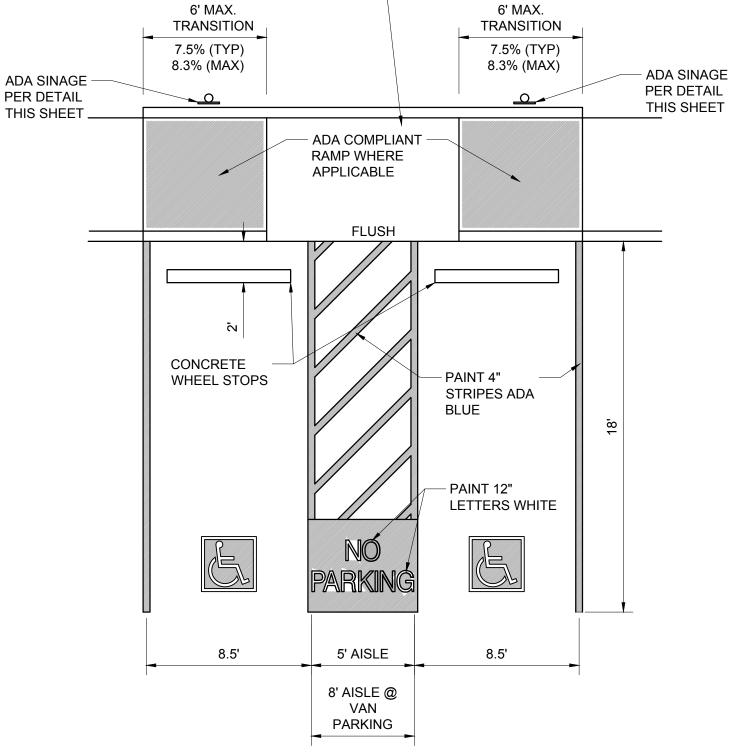

**ADA PARKING DETAIL** 

WIDE


STROKES

LANDING AREA @ -

CROSS SLOPE


**ALL DIRECTIONS** 

1.5% (TYP), 2.0% (MAX)

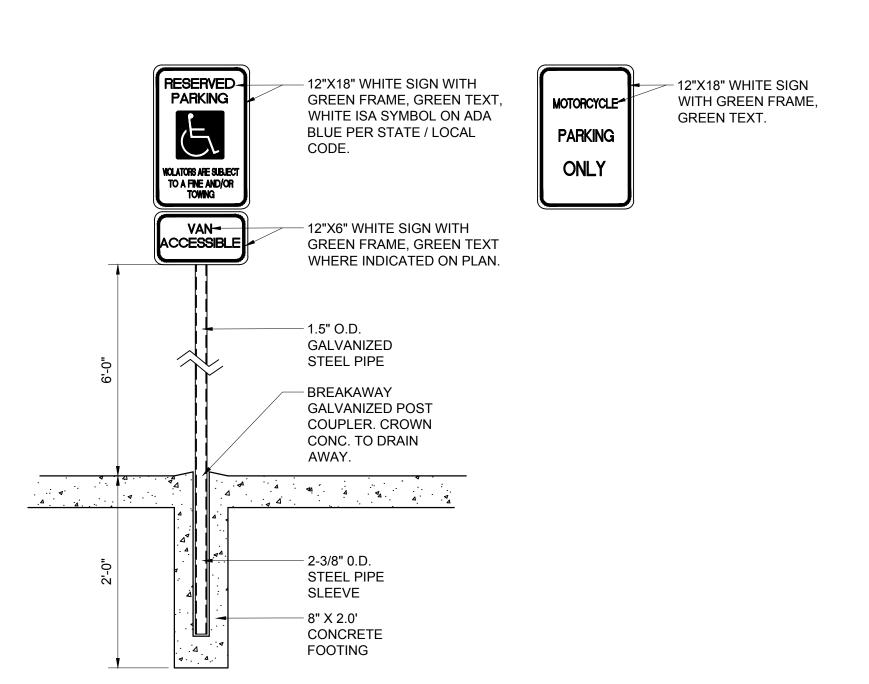

# **ACCESSIBILITY SYMBOL**

SCALE: N.T.S.

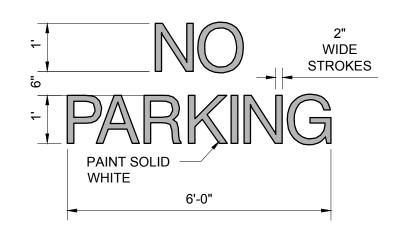

**PANTED 'NO PARKING'** 

SCALE: N.T.S.

PAINTED 'COMPACT'

SCALE: N.T.S.

PAINT SOLID

SCALE: N.T.S.

SCALE: N.T.S.

S.

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4625 A

SHEET TITLE

**CIVIL SITE DETAILS** CONT.

SHEET NUMBER

**CS-502**