

# CITY OF ALBUQUERQUE

*Planning Department*  
Brennon Williams, Director



*Mayor Timothy M. Keller*

October 30, 2020

Ryan Morrissey  
Burkhardt Engineering Company  
28 N. Cherry St.  
Germantown, OH 45327

**Re: 4516 Wyoming NE**  
**Request Permanent C.O.**  
**Engineer's Stamp dated: 6-10-19 (F20D005)**  
**Certification dated: 10-15-2020**

Dear Mr. Morrissey,

Based upon the information provided in your submittal received 10/15/2020 and site visit on 10/30/20, this plan is approved for Certificate of Occupancy by Hydrology.

PO Box 1293

Albuquerque

If you have any questions, you can contact me at 924-3986 or [earmijo@cabq.gov](mailto:earmijo@cabq.gov).

Sincerely,

NM 87103

Ernest Armijo, P.E.  
Principal Engineer, Planning Dept.  
Development Review Services

[www.cabq.gov](http://www.cabq.gov)



# City of Albuquerque

Planning Department

Development & Building Services Division

## DRAINAGE AND TRANSPORTATION INFORMATION SHEET (REV 10/2018)

**Project Title:** Champion Xpress Car Wash **Building Permit #:** BP-2019-00083 **Hydrology File #:** F20D005  
**DRB#:** PR-2019-001951 **EPC#:**  **Work Order#:** 436680  
**Legal Description:** Portion of Tract 11-N, Block 11 of Ofimiano J. Gutierrez Lower Terrace, City of Albuquerque, Bernalillo County, New Mexico  
**City Address:** 4516 Wyoming Blvd. N. E., Albuquerque, NM 8711

**Applicant:** VIA Real Estate, LLC. **Contact:** Derrick Merchant  
**Address:** 13105 Dover Ave., Lubbock, TX 79424  
**Phone#:** 806-368-7843 **Fax#:**  **E-mail:** derrick@7bdev.com

**Other Contact:** Burkhardt Engineering Company **Contact:** Ryan Morrissey  
**Address:** 28 N. Cherry St., Germantown, OH 45327  
**Phone#:** 937-388-0060 **Fax#:**  **E-mail:** rmorrissey@burkhardtinc.com

**TYPE OF DEVELOPMENT:**  PLAT (# of lots)  RESIDENCE X DRB SITE  ADMIN SITE

IS THIS A RESUBMITTAL?  Yes X No

**DEPARTMENT:** X TRAFFIC/TRANSPORTATION X HYDROLOGY/DRAINAGE

Check all that Apply:

### TYPE OF SUBMITTAL:

X ENGINEER/ARCHITECT CERTIFICATION  
 PAD CERTIFICATION  
 CONCEPTUAL G & D PLAN  
 GRADING PLAN  
 DRAINAGE MASTER PLAN  
 DRAINAGE REPORT  
 FLOODPLAIN DEVELOPMENT PERMIT APPLIC  
 ELEVATION CERTIFICATE  
 CLOMR/LOMR  
 TRAFFIC CIRCULATION LAYOUT (TCL)  
 TRAFFIC IMPACT STUDY (TIS)  
 OTHER (SPECIFY)   
 PRE-DESIGN MEETING?

### TYPE OF APPROVAL/ACCEPTANCE SOUGHT:

BUILDING PERMIT APPROVAL  
X CERTIFICATE OF OCCUPANCY  
 PRELIMINARY PLAT APPROVAL  
 SITE PLAN FOR SUB'D APPROVAL  
 SITE PLAN FOR BLDG. PERMIT APPROVAL  
 FINAL PLAT APPROVAL  
 SIA/ RELEASE OF FINANCIAL GUARANTEE  
 FOUNDATION PERMIT APPROVAL  
 GRADING PERMIT APPROVAL  
 SO-19 APPROVAL  
 PAVING PERMIT APPROVAL  
 GRADING/ PAD CERTIFICATION  
 WORK ORDER APPROVAL  
 CLOMR/LOMR  
 FLOODPLAIN DEVELOPMENT PERMIT  
 OTHER (SPECIFY)


**DATE SUBMITTED:** 10-14-2020 **By:** Burkhardt Engineering

COA STAFF:

ELECTRONIC SUBMITTAL RECEIVED:

FEE PAID:



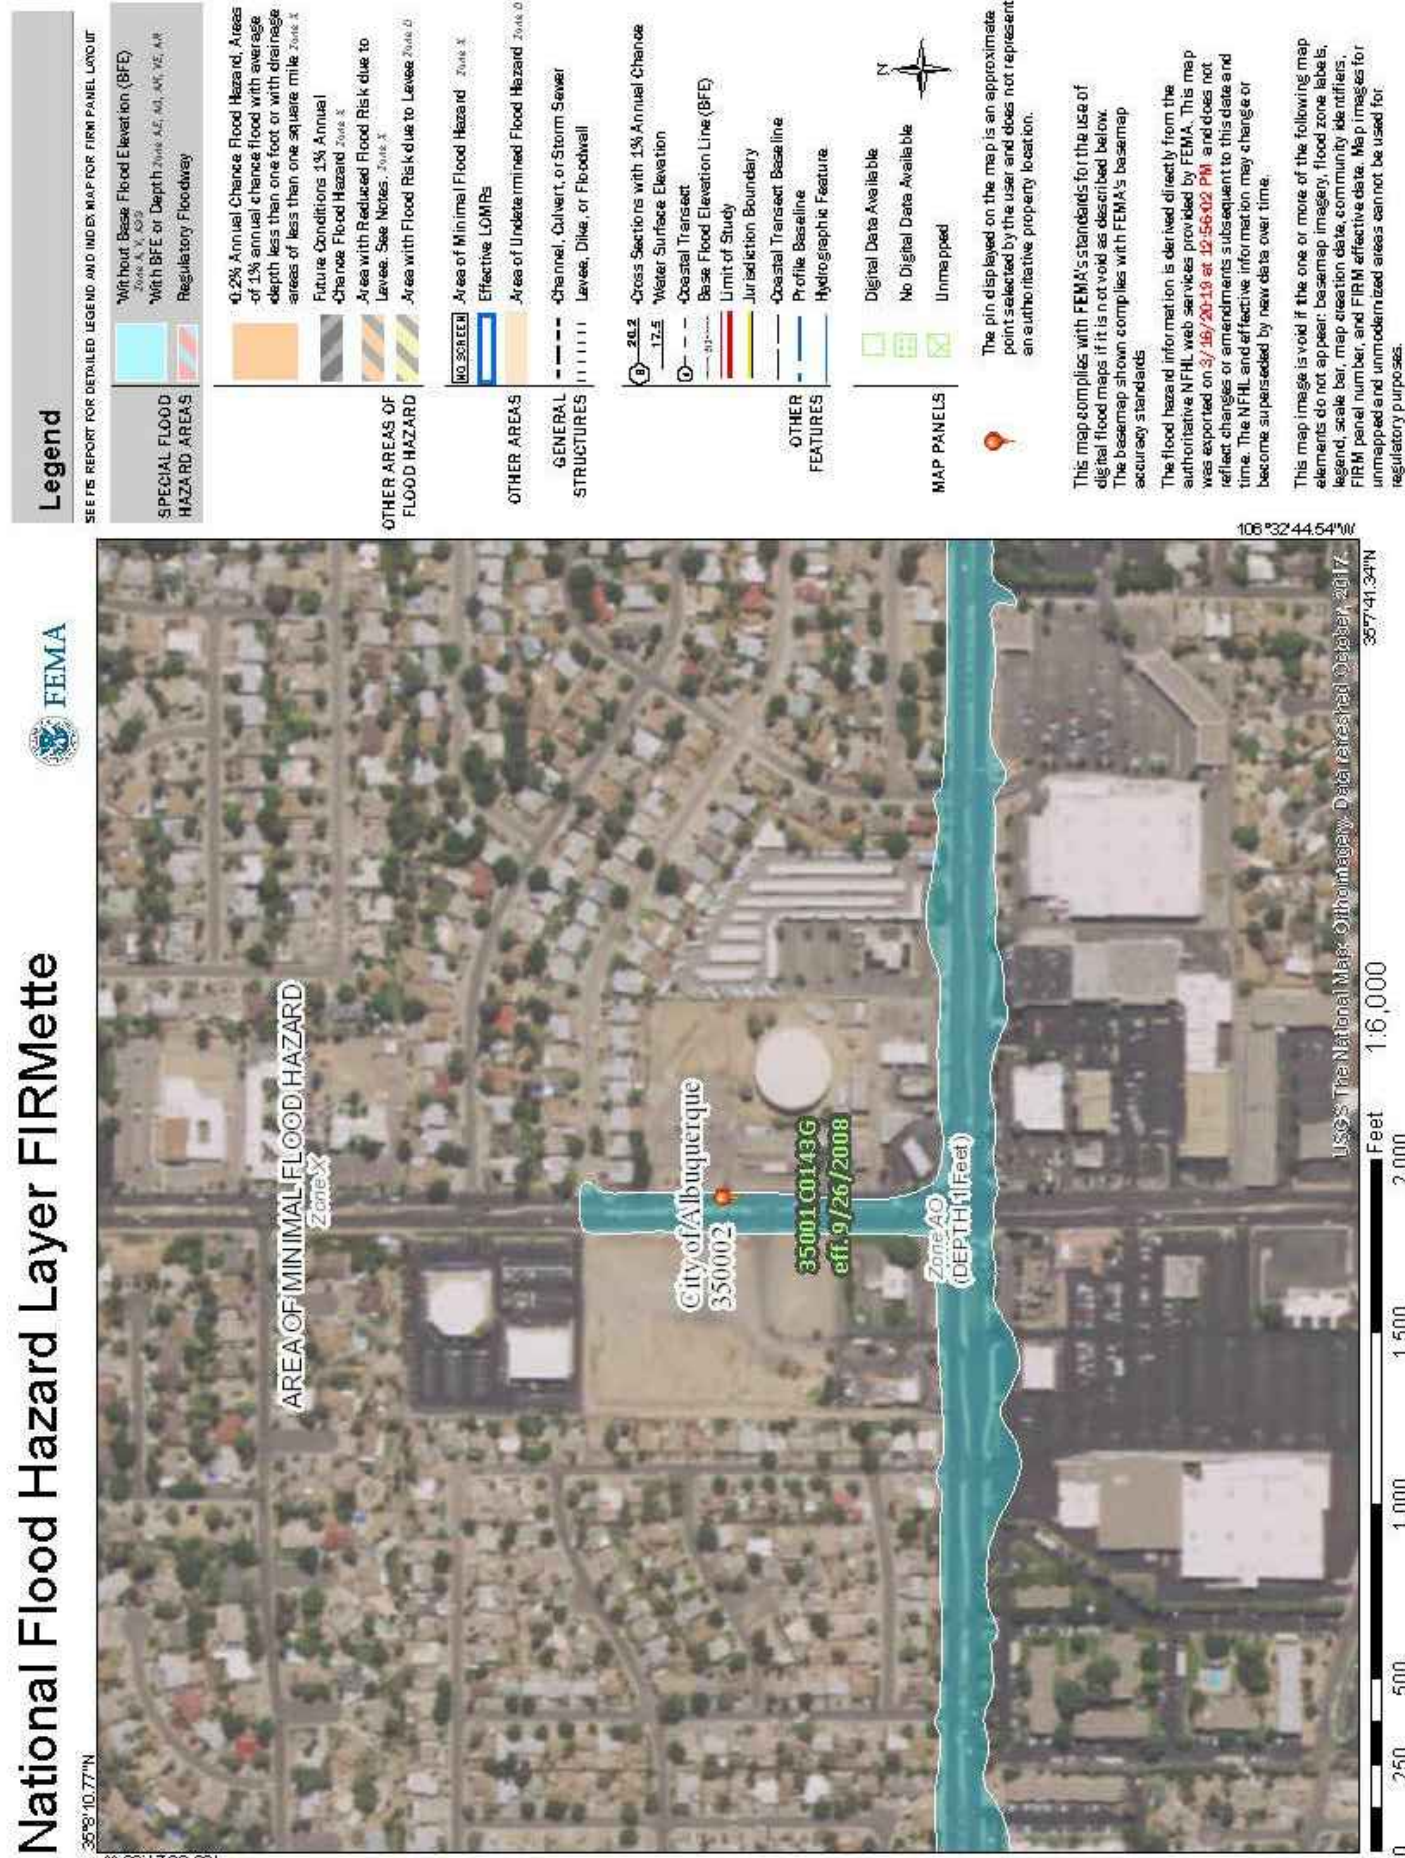

**TAKE CAUTION DURING EXCAVATION:**  
THERE ARE UNDERGROUND UTILITY LINES IN THE PROJECT AREA WHICH WERE NOT LOCATED BY THE SURVEYOR. NOTIFY "811" IN ADVANCE OF DIGGING TO HAVE LINES MARKED.

**PERMITTING CONTACT INFORMATION:**  
PLANNING / ZONING / BUILDING  
City of Albuquerque - Planning Department  
Contact: David Campbell  
Telephone: 505.924.3860  
Email: dscampbell@cabq.gov

**UTILITY CONTACT INFORMATION:**  
SANITARY SEWER / WATER  
Albuquerque Water Utility Authority  
Contact: Customer Service  
Telephone: 505.842.9287

**GAS**  
New Mexico Gas Company  
Contact: Customer Service  
Telephone: 505.697.3335

**ELECTRIC**  
PNM (Public Service Company of New Mexico)  
Contact: Michael Moyer  
Telephone: 505.241.3697  
Email: mmoyer@pnm.com

**TELECOM**  
CenturyLink  
Contact: Customer Service  
Telephone: 865.465.2313

#### DRAINAGE CERTIFICATION

I, RYAN JOSEPH MORRISSEY, NMPE 25323, OF THE FIRM BURKHARDT ENGINEERING COMPANY, HEREBY CERTIFY THAT THIS PROJECT HAS BEEN GRADDED AND WILL DRAIN IN SUBSTANTIAL COMPLIANCE WITH AND IN ACCORDANCE WITH THE DESIGN INTENT OF THE APPROVED PLAN DATED 6/10/2019. THE RECORD INFORMATION EDITED ONTO THE ORIGINAL DESIGN DOCUMENT HAS BEEN OBTAINED BY STEVEN JOHN SANDOVAL, NMPS 12315, OF THE FIRM CONSTRUCTION SURVEYING SERVICES.

I FURTHER CERTIFY THAT I HAVE PERSONALLY REVIEWED PHOTOGRAPHY AND HAVE DETERMINED BY VISUAL INSPECTION THAT THE SURVEY DATA PROVIDED IS REPRESENTATIVE OF ACTUAL SITE CONDITIONS AND IS TRUE AND CORRECT TO THE BEST OF MY KNOWLEDGE AND BELIEF.



THIS CERTIFICATION IS SUBMITTED IN SUPPORT OF A REQUEST FOR CERTIFICATE OF OCCUPANCY.

THE RECORD INFORMATION PRESENTED HEREON IS NOT NECESSARILY COMPLETE AND INTENDED ONLY TO VERIFY SUBSTANTIAL COMPLIANCE OF THE GRADING AND DRAINAGE ASPECTS OF THIS PROJECT.

THOSE RELYING ON THIS RECORD DOCUMENT ARE ADVISED TO OBTAIN INDEPENDENT VERIFICATION OF ITS ACCURACY BEFORE USING IT FOR ANY OTHER PURPOSE.





WYOMING BOULEVARD, N. E.  
(RIGHT-OF-WAY WIDTH VARIES)

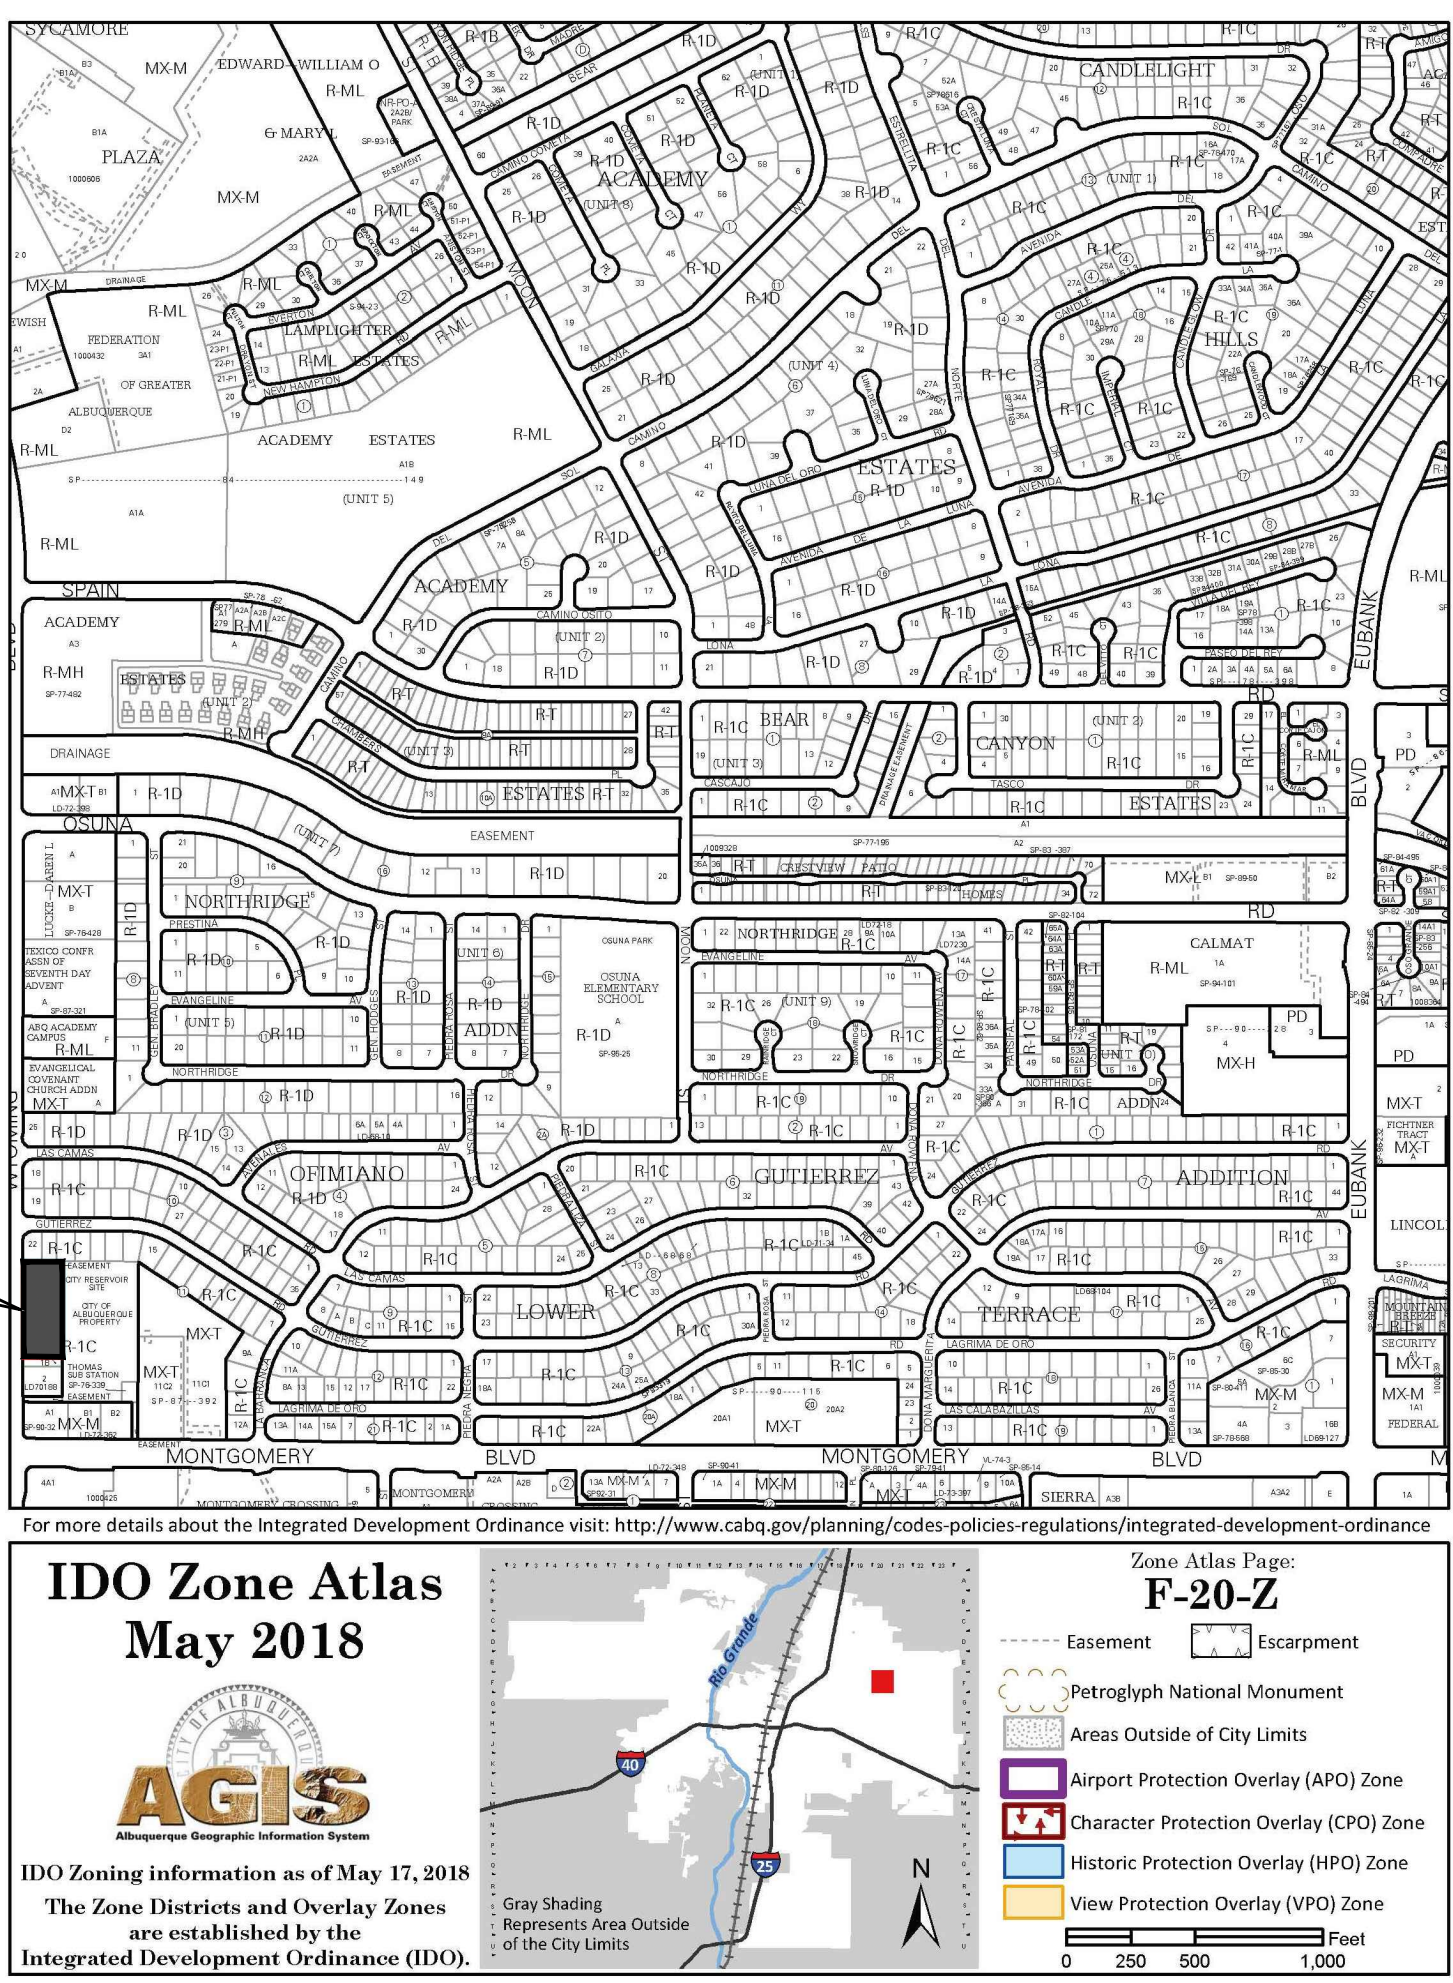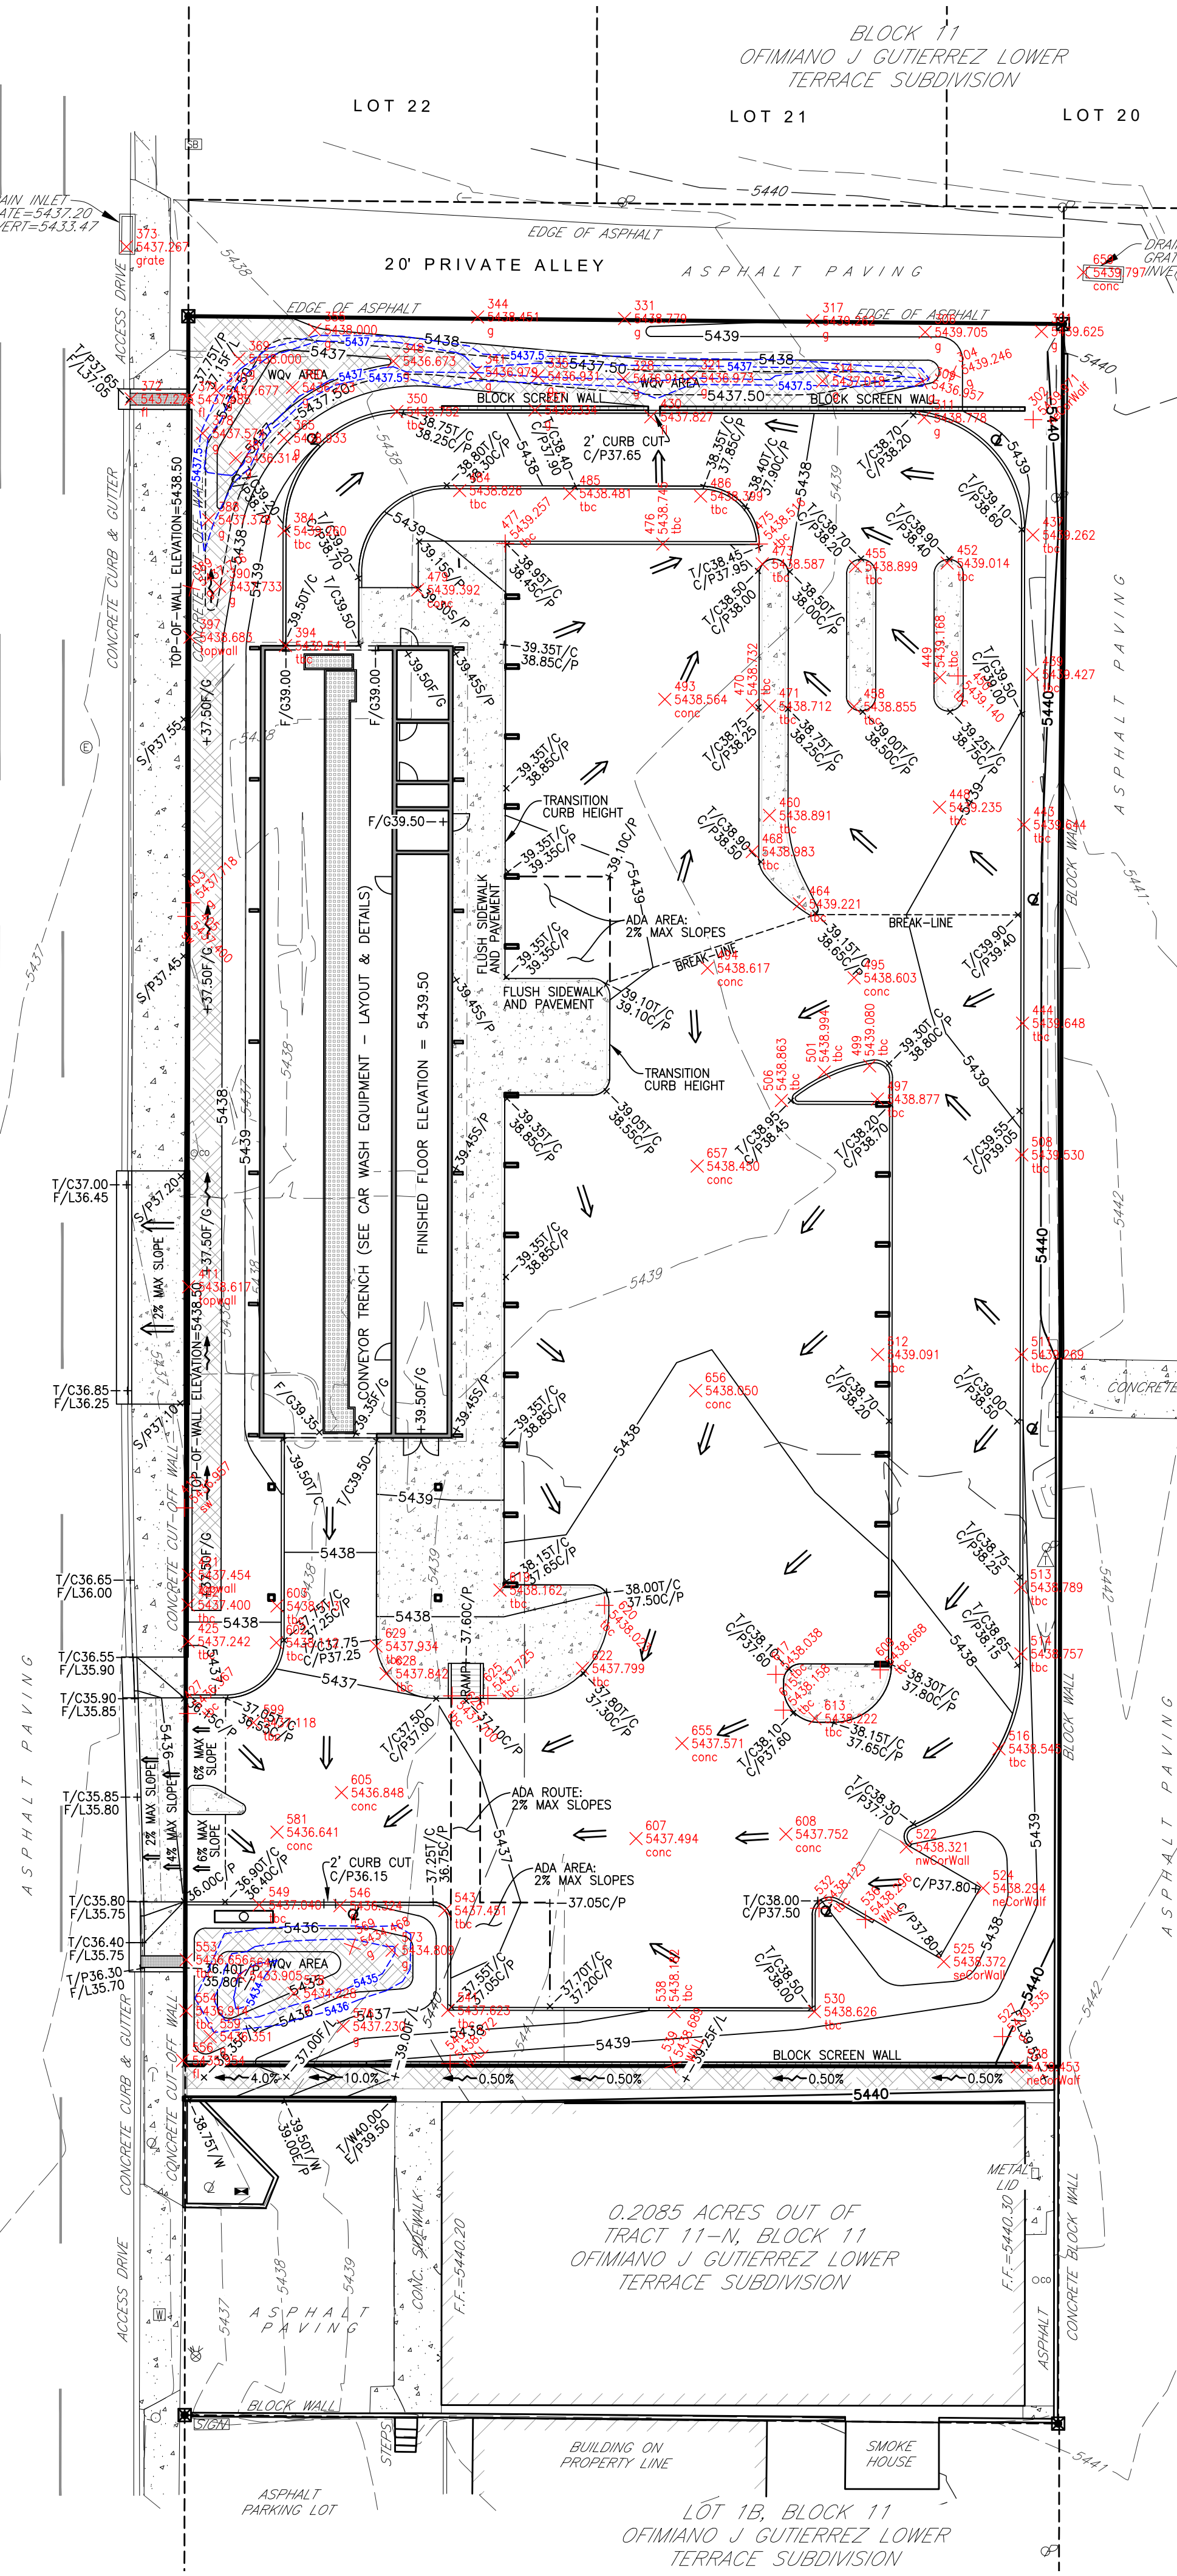

**PROPERTY INFORMATION**  
Address: 4516 Wyoming Blvd. N.E., Albuquerque, NM 87111  
Legal Description: Portion of Tract 11-N, Block 11 of Ofimiano J. Gutierrez Lower Terrace, City of Albuquerque, Bernalillo County, New Mexico.  
Area: 1.0307 acres  
Zoning: "MX-M" Mixed Use - Moderate Intensity Zone District  
Flood Zone: FIRM # 35001C0143G, effective date: September 26, 2008  
Zone "X": Areas determined to be outside the 0.2% annual chance floodplain.  
Note - Wyoming Boulevard subject to flooding depth of 1'

SEE GRADING & DRAINAGE NOTES AND DETAILS, SHEET C-3.1 FOR ADDITIONAL INFORMATION, FLOW CALCULATIONS, GENERAL NOTES, DETAILS AND CROSS SECTIONS.

GRADING LEGEND	
T/C	TOP-OF-CURB
S/P	SIDEWALK PAVEMENT
C/P	CONCRETE PAVEMENT
T/P	TOP-OF-PLATE (FOR CURB CULVERT)
F/G	FINISHED GRADE
F/L	FLOW LINE
T/W	TOP-OF-WALL
E/P	EDGE OF PAVEMENT
←	SHEET FLOW
→	CHANNEL FLOW
+00.00	SPOT ELEVATION
-0000	PROPOSED CONTOUR
	12" THICK STONE LINER

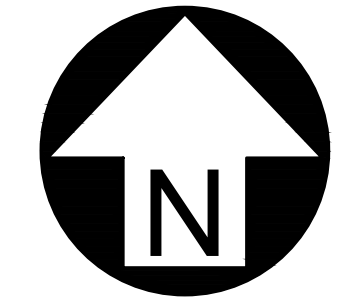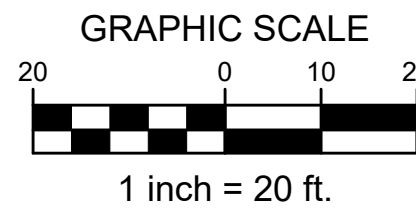

Item	Date	Description
1	02/15/19	Rev 1 - Revised per City Comments.
2	03/18/19	Rev 2 - Revised per City Comments.

**SITE DEVELOPMENT PLANS FOR**  
**CHAMPION XPRESS**  
**CAR WASH**  
**4516 WYOMING BOULEVARD N.E.**  
**1.0307 ACRES OUT OF TRACT 11-N, BLOCK 11**  
**OFIMIANO J. GUTIERREZ LOWER TERRACE SUBDIVISION**  
**CITY OF ALBUQUERQUE, BERNALILLO COUNTY, NEW MEXICO**



Design: RJM	Proj: 18.160
Draw: RJM	Dwg: 18-160.dwg
Check: JDB	Tab: C3.0-GP

Scale: 1" = 20'

Date: 01.04.2019

Sheet:

GRADING & DRAINAGE PLAN

Sheet No.:

C-3.0





GENERAL GRADING, EARTHWORK & DRAINAGE NOTES

- All spot elevations indicated in pavement areas are at bottom face of curb and/or finished pavement grade unless noted otherwise. All spot elevations indicated in grass or landscape areas are finished grade unless noted otherwise.
- The Contractor shall be responsible for the removal and disposal of all vegetation and organic materials from the site that results from clearing & grubbing activities.
- The Contractor shall be responsible for stripping and removal of all excess topsoil from the site. All topsoil that cannot be used on site shall be removed from the site at the Contractor's expense. The Contractor may dispose of excess topsoil by burying topsoil in landscape areas only at the direction of the Owner or the Owner's Representative.
- The Contractor will be responsible for all safety requirements and for the protection of all existing and proposed utilities or structures during earthwork procedures.
- The Contractor shall be responsible for the import of structural fill materials if suitable material is not available on site. The location and testing of suitable material shall be the Contractor's responsibility. The Contractor shall be responsible for the export and disposal of all excess or unsuitable materials.
- The Contractor shall provide construction dewatering as necessary to complete construction as outlined in plans.
- The Contractor shall exercise extreme care in establishing all grades and slopes in pavement areas, ramps and sidewalks in the vicinity of handicap parking and access areas and shall comply with Federal, State, and Local Codes.
- In areas where sheet drainage flows from grass or landscape areas onto paved areas, the finished grade in grass or landscape areas shall be 1/2 inch above the top of curb or above the pavement in areas without curb. In areas where sheet drainage flows from pavement to grass or landscaped areas, the finished grade in grass or landscape areas shall be 1/2 inch below the pavement.
- The Contractor shall provide positive drainage in all areas and away from all buildings.
- All pavement shall be laid on a straight, even, and uniform grade with a minimum of 1:100 (1.0%) slope toward the collection points unless otherwise specified on plans. Cut or fill slopes in unpaved areas shall not exceed 3:1 (33.3%) maximum grade unless otherwise noted on plans.
- ADA accessible areas shall not exceed the following slopes:
  - Ramps - 1:12 (8.3%) max.
  - Routes - 1:20 (5.0%) max.
  - Parking - 1:50 (2.0%) max.
  - Cross Slopes - 1:50 (2.0%) max.
- The Contractor shall adjust tops/lids/grates of all cleanouts, manholes, inlets, valves, etc. to match final grade.
- Following grading of subsoil to subgrade elevations, the Contractor shall provide 4" of topsoil (minimum) in all disturbed areas which are not to be paved. Final grades should be smoothly finished to surrounding areas and ensure positive drainage. Stockpiled topsoil shall be screened prior to respreading and should be free of subsoil, debris, and stones.
- The Contractor shall be responsible for determining exact quantities of cut and/or fill for estimating and construction and should alert the Engineer of any excessive cut and/or fill, especially if additional cut and/or fill will be required due to poor existing soil conditions discovered during earthwork operations.
- Refer to the Architectural and Structural Plans for information regarding any perimeter foundation drains.
- The Contractor shall obtain a copy of the Geotechnical / Soils Report and become thoroughly familiar with site and subgrade information and fully implement recommendations given therein.

Private Drainage Facilities within City Right-of-Way  
Notice to Contractor  
(Special Order 19 ~ "50-19")

- An excavation permit will be required before beginning any work within City Right-Of-Way.
- All work on this project shall be performed in accordance with applicable federal, state and local laws, rules and regulations concerning construction safety and health.
- Two working days prior to any excavation, the contractor must contact **New Mexico One Call**, dial **"811"** [or (505) 260-1990] for the location of existing utilities.
- Prior to construction, the contractor shall excavate and verify the locations of all obstructions. Should a conflict exist, the contractor shall notify the engineer so that the conflict can be resolved with a minimum amount of delay.
- Backfill compaction shall be according to traffic/street use.
- Maintenance of the facility shall be the responsibility of the owner of the property being served.
- Work on arterial streets may be required on a 24-hour basis.
- Contractor must contact Jason Rodriguez at 235-8016 and Construction Coordination at 924-3416 to schedule an inspection.

DRAINAGE CERTIFICATION


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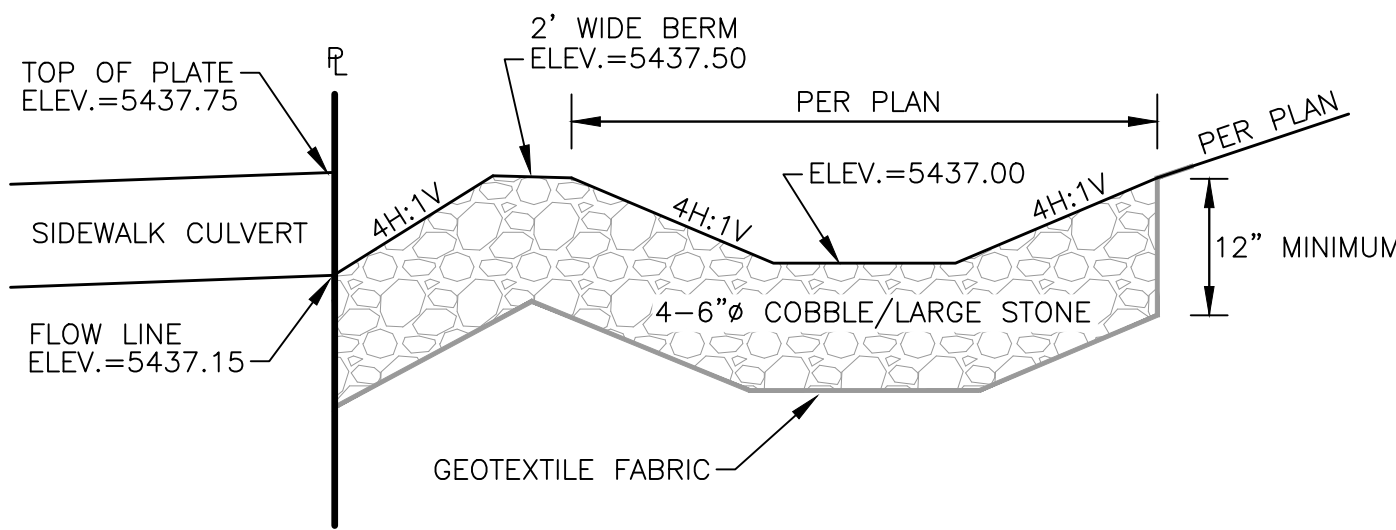
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DRAINAGE AREA MAP


Scale: 1"=50'



NOTES:  
1. GRADE OR EXCAVATE CROSS SECTION TO LINES AND GRADES SHOWN ON THE PLANS ACCORDING TO REQUIREMENTS IN THE GEOTECHNICAL REPORT.  
2. PLACE RIPRAP PROTECTION TO THE THICKNESS, DEPTH, AND ELEVATIONS PER FINISHED GRADE.

NORTHERN WQv AREA SECTION

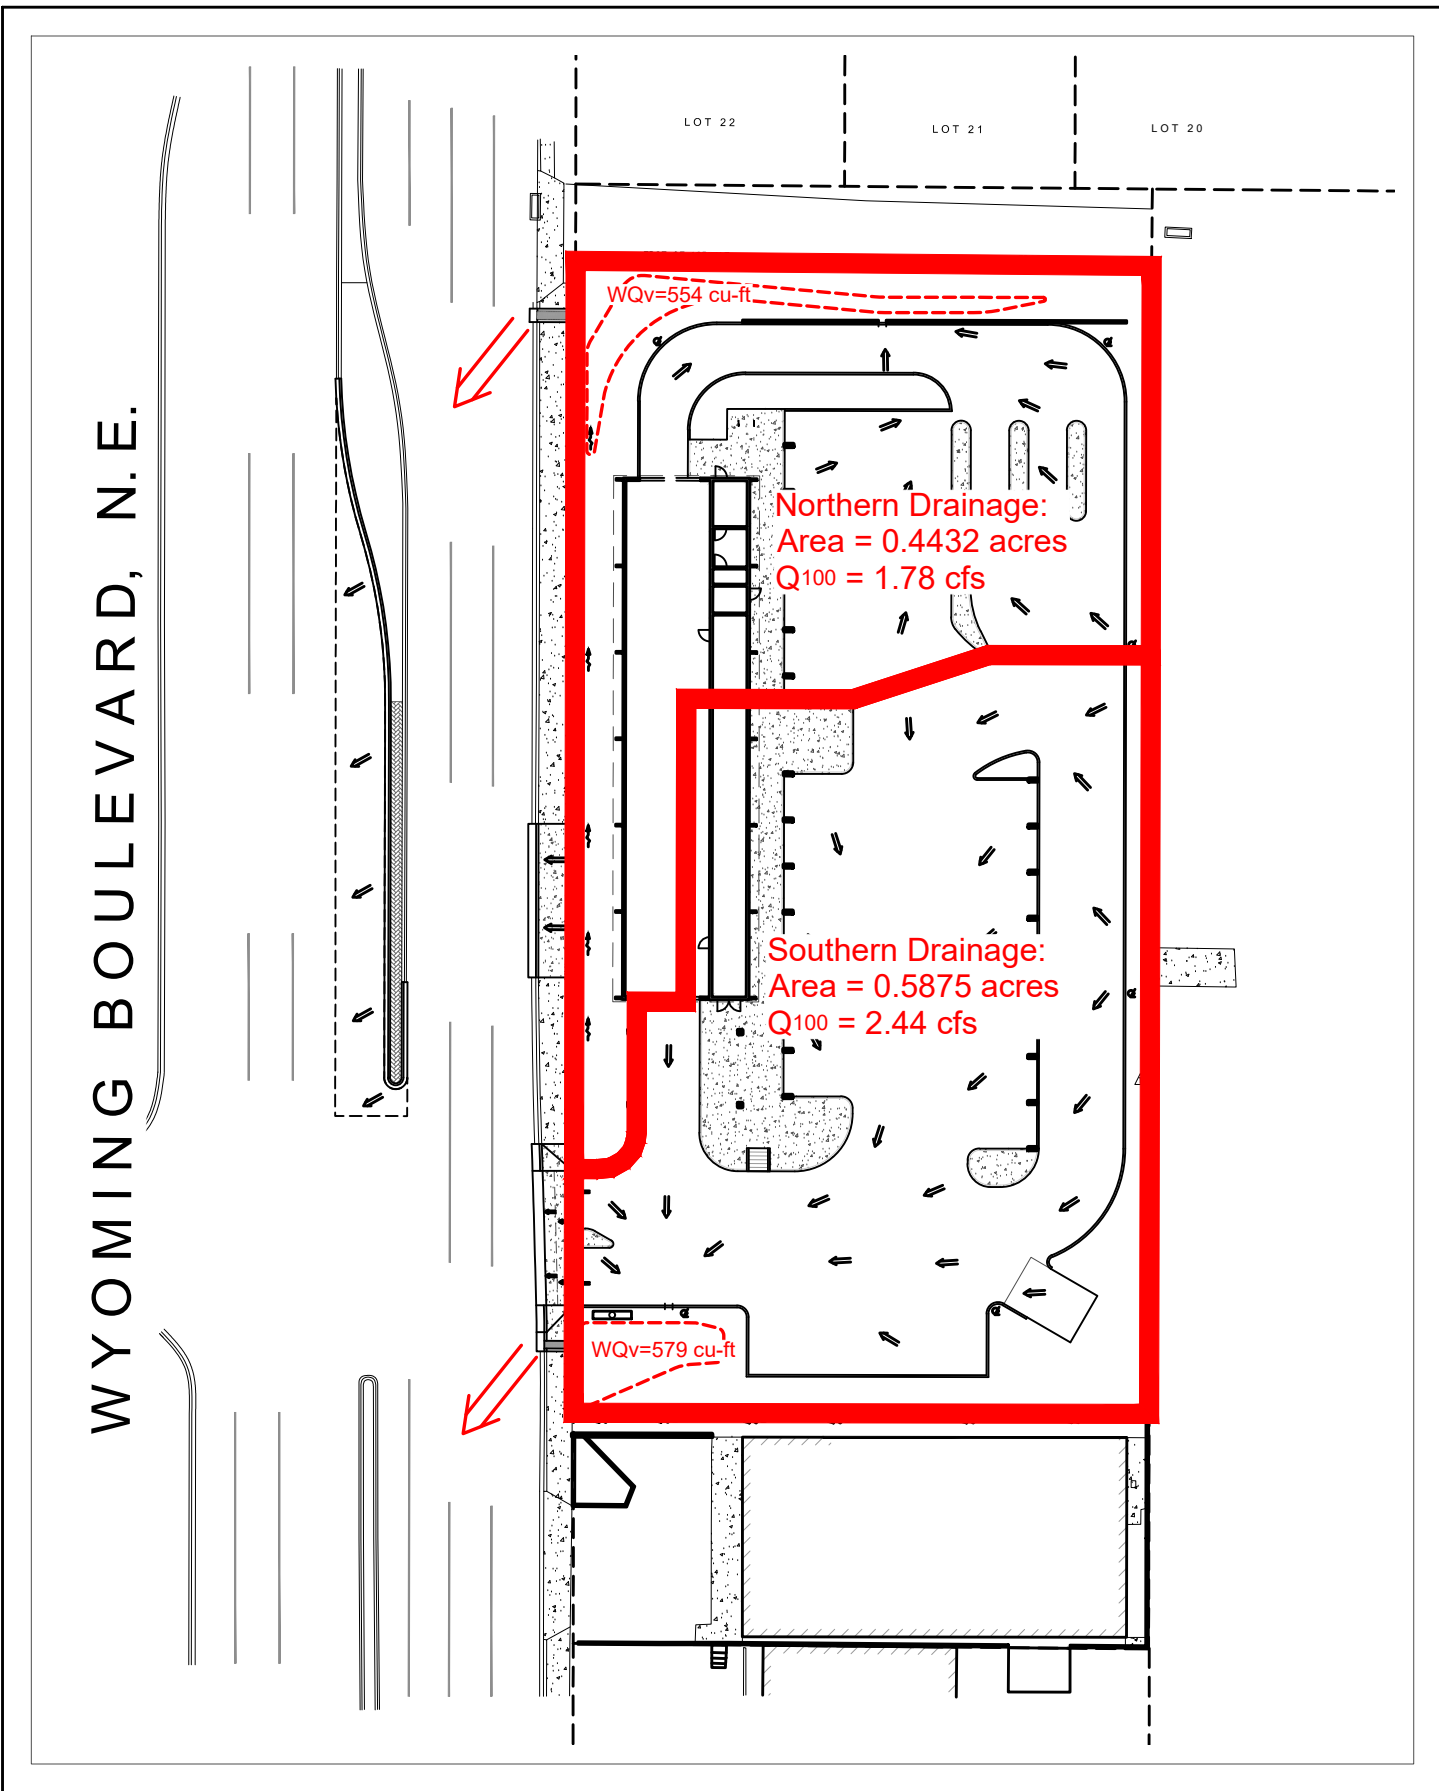NOT TO SCALE

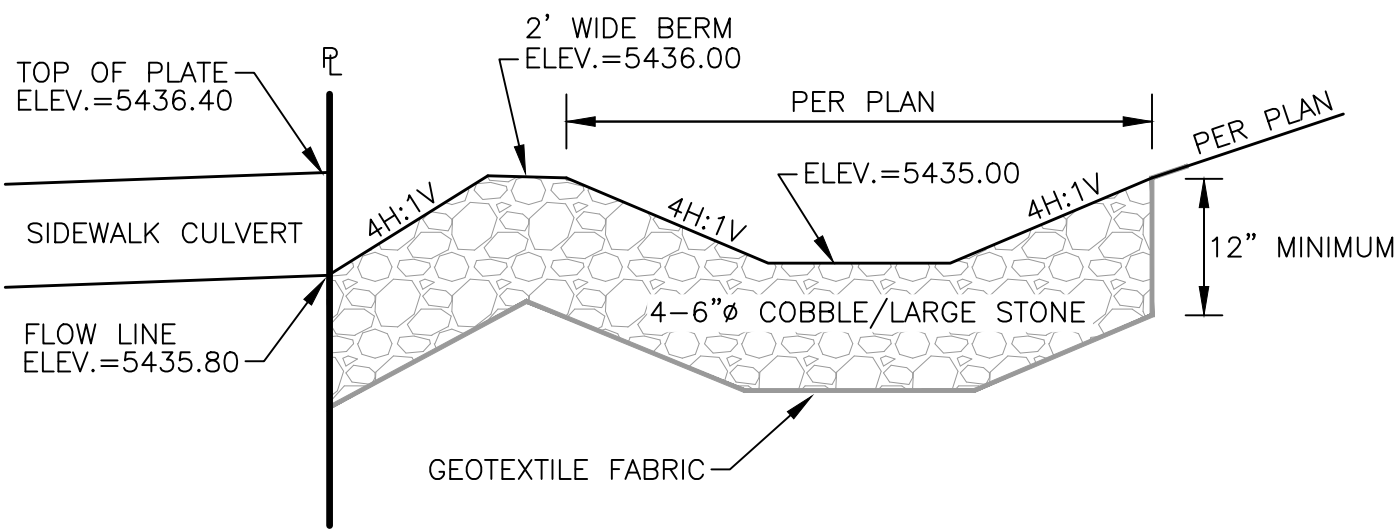

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SOUTHERN WQv AREA SECTION

NOT TO SCALE

STORM WATER MANAGEMENT NOTES:

Existing Lot Coverage - 90% impervious / 10% landscaping  
Proposed Lot Coverage - 80% impervious / 20% landscaping

\*\*\*Net Decrease in Storm Water Runoff due to Development\*\*\*  
\*\*\*No Storm Water Detention Required\*\*\*

Methodology:

Albuquerque Development Process Manual

Chapter 22, Section 2, Part A:

"A simplified procedure for projects with sub-basins smaller than 40 acres has been developed based on initial abstraction / uniform infiltration precipitation losses and Rational Method procedures."

Storm Water Quality Volume (WQv) = Impervious Area x 0.26 inches

Precipitation Zone:

Precipitation Zone 3: "Between the San Mateo and Eubank"

Northern Drainage:

Area = 0.4432 acres

Treatment B (Desert Landscaping Area) - 24%

Treatment D (Impervious Area) - 76% = 0.3370 acres

100-year peak Discharge Rate = 4.01 cfs/acre (Table A-9)

Q100 = 1.78 cfs

WQv = 1.78 cu-ft (required)

Provided Water Quality Storage Volume:

Elevation (ft)	Contour Area (sq-ft)	Surface Vol. (cu-ft)	Stone Vol. (cu-ft)	Σ Volume (cu-ft)
5437	206	0	82	82
5437.50	772	245	309	554 - overflow to R/W

\*Average End Area Method used to calculate storage volumes.

\*Stone Storage at Elevation = Contour Area x 12" (stone depth) x 40% void space.

Southern Drainage:

Area = 0.5875 acres

Treatment B (Desert Landscaping Area) - 17%

Treatment D (Impervious Area) - 83% = 0.4876 acres

100-year peak Discharge Rate = 4.15 cfs/acre (Table A-9)

Q100 = 2.44 cfs

WQv = 2.44 cu-ft (required)

Provided Water Quality Storage Volume:

Elevation (ft)	Contour Area (sq-ft)	Surface Vol. (cu-ft)	Stone Vol. (cu-ft)	Σ Volume (cu-ft)
5435	163	0	65	65
5436	553	358	221	579 - overflow to R/W

\*Average End Area Method used to calculate storage volumes.

\*Stone Storage at Elevation = Contour Area x 12" (stone depth) x 40% void space.

Curb Cut and Sidewalk Culvert Capacity:

Weir Equation:  $Q = CxLH^{3/2}$  where,

Q = discharge (cfs)


C = weir coefficient = 3.33

L = length of weir (ft)

H = head or depth (ft)


For the 24" wide Curb Cuts and Sidewalk Culverts with a max depth of 7";

Maximum Flow = 2.97 cfs (exceeds 100-year discharge of both watersheds)

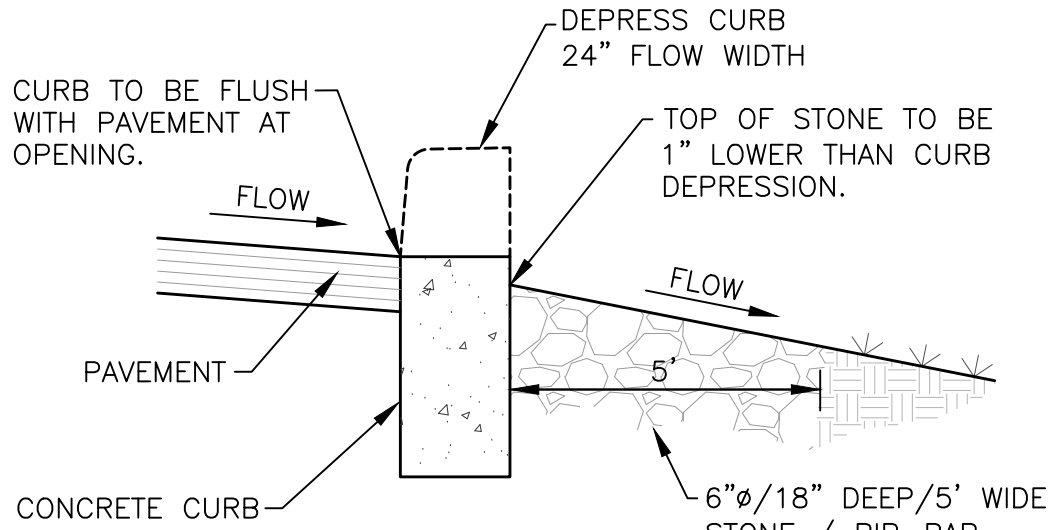

CURB CUT FOR CROSS DRAINAGE DETAIL


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DRAINAGE SWALE SECTION ALONG WYOMING BOULEVARD FRONTAGE

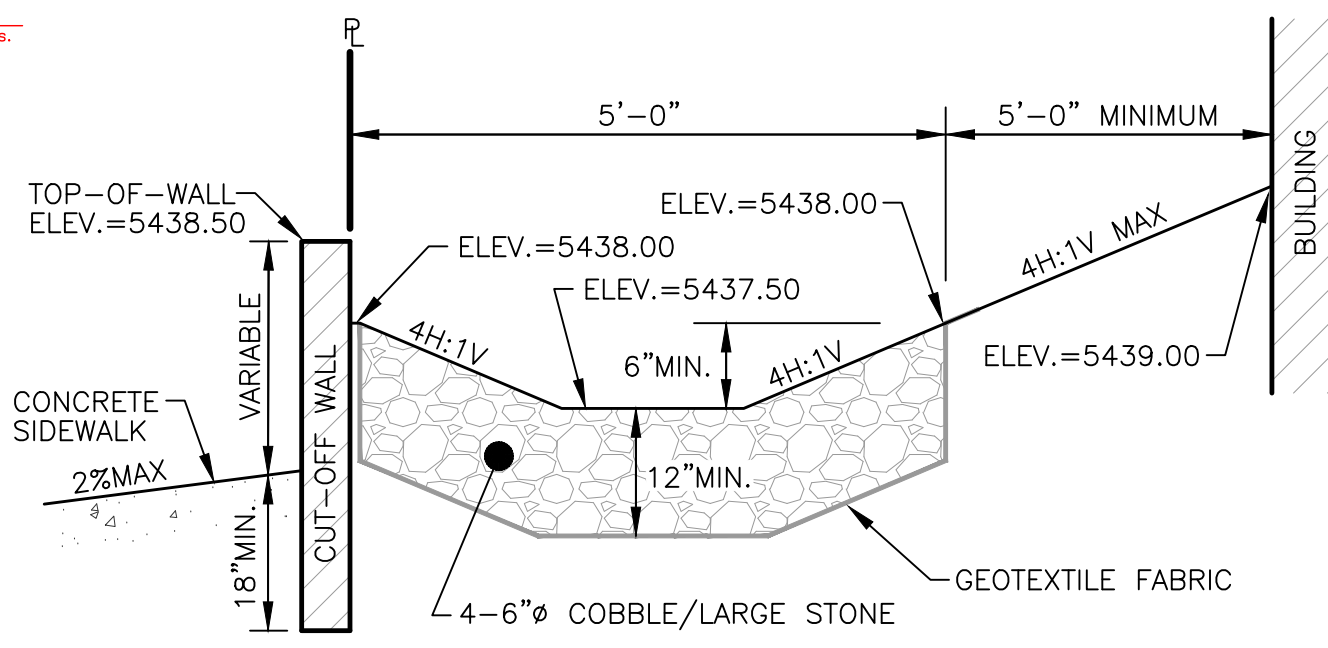
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DRAINAGE SWALE SECTION ALONG SOUTH PROPERTY LINE

NOT TO SCALE



NOTES:  
1. FOOTING TO BE IN COMPACTED SOIL @95%.  
2. CONCRETE TO BE 2500 PSI MINIMUM.  
3. REBAR TO BE GRADE 40.  
4. 8" CMU TO BE fm=1350psi  
5. MORTAR/GROUT TO BE TYPE S fm=1800psi  
6. COLOR AND TEXTURE OF BLOCK TO BE SPECIFIED ON PLANS  
7. INSTALL 1" EXPANSION JOINT WHEN ABUTTING PAVEMENT OR CURBING.

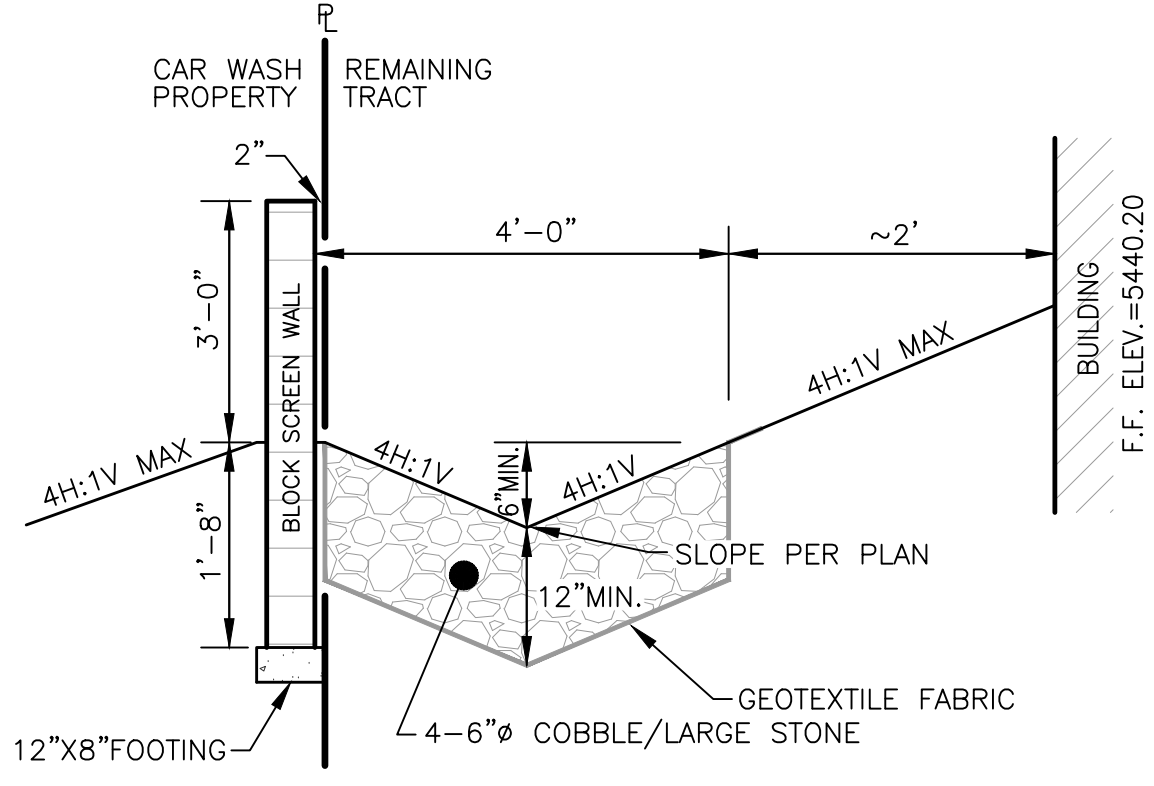BLOCK SCREENING WALL DETAIL

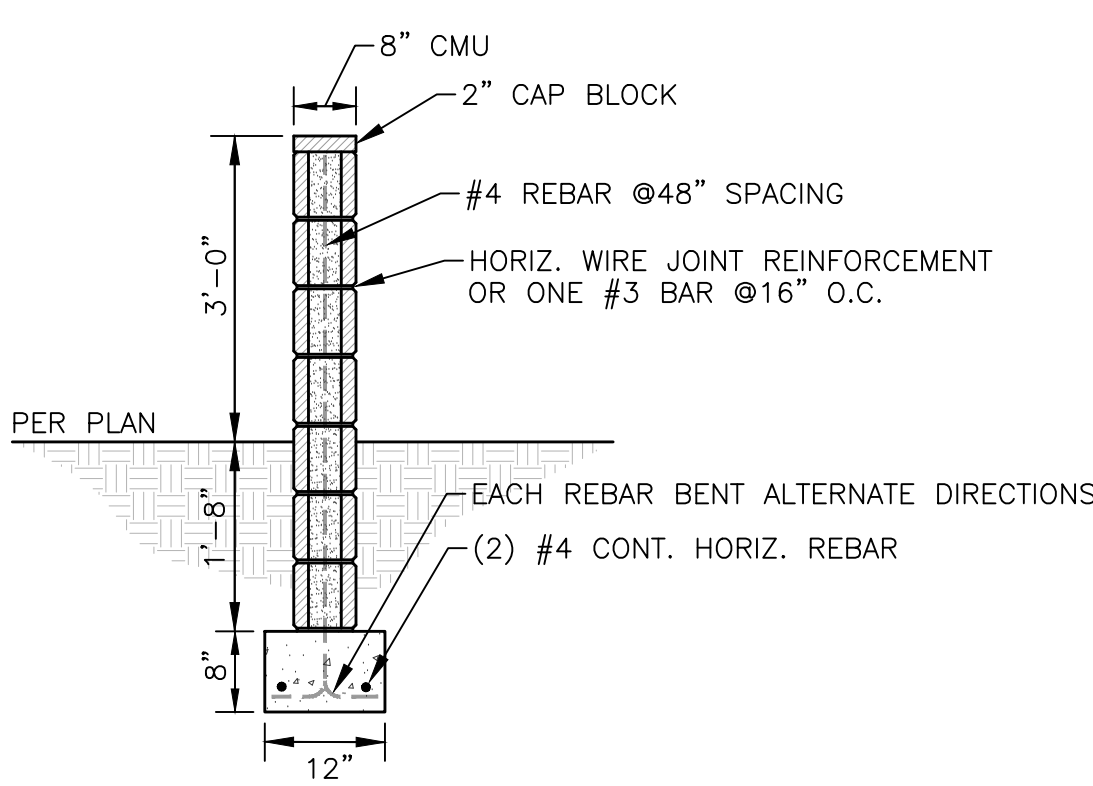NOT TO SCALE



Date	03.18.19
Description	Rev 2 - Revised per City Comments.
Item	1

SITE DEVELOPMENT PLANS FOR  
**CHAMPION XPRESS CAR WASH**  
4516 WYOMING BOULEVARD N.E.  
1.0307 ACRES OUT OF TRACT 11-N, BLOCK 11  
OF MIANO J. GUTIERREZ LOWER TERRACE SUBDIVISION  
CITY OF ALBUQUERQUE, BERNALILLO COUNTY, NEW MEXICO



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Draw: RJM	Dwg: 18-160.dwg
Check: JDB	Tab: C3.1-GP

Scale: N/A

Date: 01.04.2019

Sheet: GRADING & DRAINAGE NOTES AND DETAILS

Sheet No.:

C-3.1



Know what's below.  
Call before you dig.