

GRADING/DRAINAGE PLAN

THE FOLLOWING ITEMS CONCERNING (4802 WYOMING BLVD. N.E.) LOT A EVANGELICAL COVENANT CHURCH ADDITION, BERNALILLO COUNTY, ALBUQUERQUE, NEW MEXICO ARE CONTAINED HEREON:

EXISTING CONDITIONS

AS SHOWN BY THE VICINITY MAP, THE SITE CONTAINS 1.7463 ACRES AND IS LOCATED NORTH OF MONTGOMERY BLVD. N.E. AND EAST OF WYOMING BLVD. N.E. THE SITE CONTAINS A 7,150 SQ. FT. CHILDCARE CENTER ALONG WITH PAVED PARKING AND LANDSCAPED AREAS. EXISTING FLOW PATTERN IS FROM EAST TO WEST AND INTO WYOMING BLVD. N.E. ACCORDING TO THE FLOOD INSURANCE RATE MAP, PANEL 0143E, DATED NOVEMBER 19, 2003, THE SITE IS NOT LOCATED WITHIN A DESIGNATED FLOOD ZONE.

PROPOSED CONDITIONS

AS SHOWN BY THE GRADING/DRAINAGE PLAN, THE PROJECT WILL CONSIST OF A PROPOSED 720 SQ. FT. STORAGE BUILDING. THE NEW DEVELOPED RUN-OFF WILL BE ROUTED TOWARDS THE EXISTING PAVED PARKING AREA WEST OF THE BUILDING (AS INDICATED ON THE PLAN DRAWING). THERE ARE NO OFF-SITE FLOWS ENTERING FROM ANY DIRECTION. THE CALCULATIONS WHICH APPEAR HEREON, ANALYZE THE EXISTING AND PROPOSED CONDITIONS FOR THE SMALLER BASINS, AS SET FORTH IN THE REVISION OF SECTION 22.2 HYDROLOGY OF THE DEVELOPMENT PROCES MANUAL, VOLUME II DESIGN CRITERIA DATED 1997 HAS BEEN USED TO QUANTIFY THE PEAK RATE OF DISCHARGE AND VOLUME OF RUN-OFF

PROJECT AREA = 1.7463 ac.
METAL STORAGE BUILDING FOR SOUTHWEST CHILDCARE

PRECIPITATION: 360 = 2.60 in. 1440 = 3.1 in.

10day = 4.9 in.

EXCESS PRECIPITATION: PEAK DISCHARGE: TREATMENT A 0.66 in. 1.87 cfs/ac. TREATMENT B 0.92 in. 2.6 cfs/ac.

TREATMENT C 1.29 in. 3.45 cfs/ac. 5.02 cfs/ac. TREATMENT D 2.36 in.

EXISTING CONDITIONS: PROPOSED CONDITIONS: AREA AREA TREATMENT A O ac. O ac. TREATMENT B 0.13887 ac. 0.13887 ac.

TREATMENT C 1.10953 ac. 0.9892 ac. TREATMENT D 0.4979 ac. 0.61823 ac. EXISTING EXCESS PRECIPITATION:

Weighted E = $(0.66) \times (0.00) + (0.92) \times (0.14) + (1.29) \times (1.11) + (2.36) \times (0.50) / 1.75$ ac. = 1.57 in. V100-360 = (1.57)x(1.75)/12 = 0.227842 ac-ft = 9925 cf

EXISTING PEAK DISCHARGE:

Q100 = (1.87)x(0.00)+(2.60)x(0.14)+(3.45)x(1.11)+(5.02)x(0.50)=6.69 cfs PROPOSED EXCESS PRECIPITATION:

Weighted E = $(0.66) \times (0.00) + (0.92) \times (0.14) + (1.29) \times (0.99) + (2.36) \times (0.62) / 1.75$ ac. = 1.64 in.

V100-360 = (1.64)x(1.75)/12.0 = 0.238571 ac-ft = 10392 cf

V100-1440 = (0.24)+(0.62)x(3.10-2.60)/12 = 0.264331 ac-ft = 11514 cf V100-10day = (0.24)+(0.62)x(4.90-2.60)/12 = 0.357065 ac-ft = 15554 cf PROPOSED PEAK DISCHARGE:

Q100 = (1.87)x(0.00) + (2.60)x(0.14) + (3.45)x(0.99) + (5.02)x(0.62) = 6.52 cfs

6.52 CFS - 6.69 CFS = 0.170 CFS

- 1. THE CONTRACTOR SHALL BE HELD RESPONSIBLE FOR MANAGEMENT OF STORM RUN-OFF DURING CONSTRUCTION, HE SHALL ASSURE THAT THE FOLLOWING MEASURES ARE
- A. ADJACENT PROPERTY SHALL BE PROTECTED AT ALL TIMES BY TEMPORARY BERMS, DIKES, SWALES, AND OTHER TEMPORARY GRADING AS REQUIRED TO PREVENT STORM RUN-OFF FROM LEAVING THE SITE AND ENTERING ADJACENT PROPERTY.
- B. ADJACENT PUBLIC RIGHT-OF-WAY SHALL BE PROTECTED AT ALL TIMES FROM STORM WATER RUN-OFF FROM THE SITE. NO SEDIMENT BEARING WATER SHALL BE PERMITTED TO ENTER THE PUBLIC STREETS.
- 2. THE CONTRACTOR SHALL IMMEDIATELY AND THOROUGHLY REMOVE ANY OR ALL SEDIMENT WITHIN THE PUBLIC STREETS THAT HAVE BEEN ERODED FROM THE SITE AND DEPOSITED THERE.

NOTICE TO CONTRACTOR

- 1. An excavation/construction permit will be required before beginning any work within the City right-of-way. Approved copy of this plan must be submitted at the time of application for permit.
- 2. All work detailed in this plan to be performed, except as otherwise stated or provided hereon, shall be constructed in accordance with City of Albuquerque Standard Specification for Public Works Construction.
- 3. Two working days prior to any excavation, contractor must contact line locating Services for locating existing utilities, (260-1990).
- 4. Prior to construction, the contractor shall excavate and verify the horizonal and vertical location of all construction. Should a conflict exist, the contractor shall notify the engineer so that the conflict can be resolved with a minimum amount of delay.
- 5. Backfill compaction shall be according to Commercial use.
- 6. All work on this project shall be performed in accordance with applicable Federal, State and local laws, rules and regulations concerning construction safty and health.
- 7. Maintenance of this facilities shall be the responsibility of the owner of the property served.

SYMBOL LEGEND

EXISTING CONTOUR ---- 5450 --- EXISTING SPOT ELEVATION DESIGNED SPOT ELEVATION PROPERTY LINE EASEMENT LINE

FLOW DIRECTION EXISTING SPOT ELEVATION DOWN SPOUT

ABBREVIATION LEGEND

TOP OF CON. PAD TOP OF CURB - *TA* TOP OF ASPHALT FLOWLINE TOP OF WALL


GRADING/DRAINAGE PLAN 1

× 46.0

TRACT A OF THE EVANGELICAL COVENANT

CHURCH ADDITION, ALBUQUERQUE, NEW MEXICO


ONE FOOT CONTOUR INTERVAL

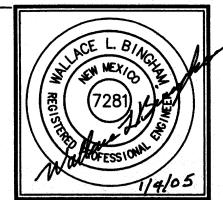

DECEMBER 2004 REVISIONS

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SHEET NO.

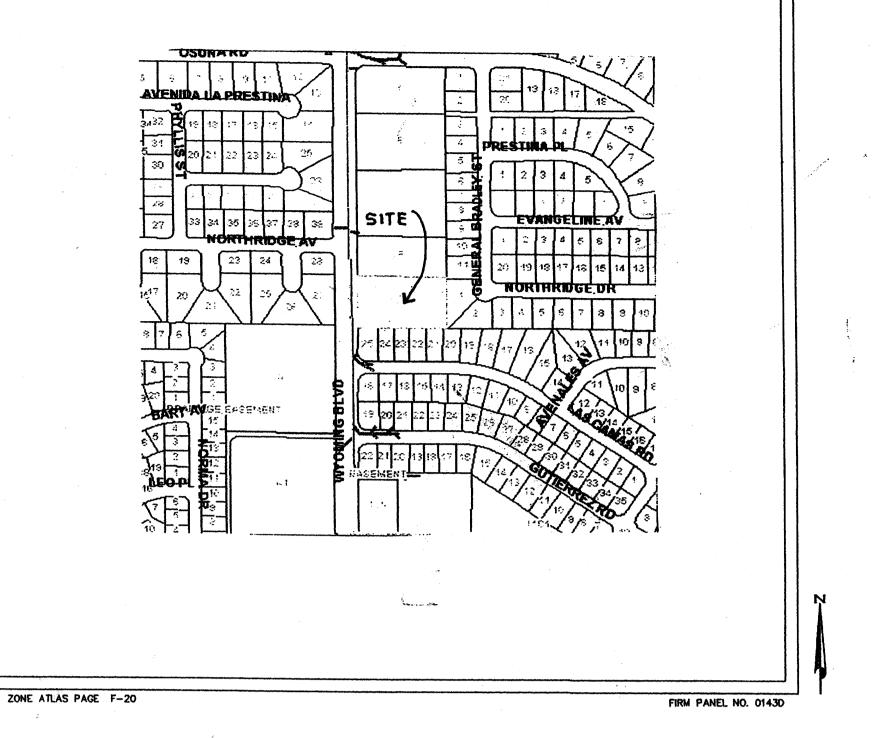

THE FOLLOWING ITEMS CONCERNING (4802 WYOMING BLVD. N.E.) LOT A EVANGELICAL COVENANT CHURCH ADDITION, BERNALILLO COUNTY, ALBUQUERQUE, NEW MEXICO ARE CONTAINED HEREON:

AS SHOWN BY THE VICINITY MAP, THE SITE CONTAINS 1.7463 ACRES AND IS LOCATED NORTH OF MONTGOMERY BLVD. N.E. AND EAST OF WYOMING BLVD. N.E. THE SITE CONTAINS A 4,237 SQ. FT. CHILDCARE CENTER ALONG WITH PAVED PARKING AND LANDSCAPED AREAS. EXISTING FLOW PATTERN IS FROM EAST TO WEST AND INTO WYOMING BLVD. N.E. ACCORDING TO THE FLOOD INSURANCE RATE MAP, PANEL 0143D, DATED SEPTEMBER 20, 1996, THE SITE IS NOT LOCATED WITHIN A DESIGNATED

PROPOSED CONDITIONS

AS SHOWN BY THE GRADING/DRAINAGE PLAN, THE PROJECT WILL CONSIST OF A PROPOSED 4000 SQ. FT. BUILDING ADDITION. THE NEW DEVELOPED RUN-OFF WILL BE ROUTED TOWARDS THE EXISTING PAVED PARKING AREA WEST OF THE PROPOSED BUILDING ADDITION. THERE ARE NO OFF-SITE FLOWS ENTERING FROM ANY DIRECTION. THE CALCULATIONS WHICH APPEAR HEREON, ANALYZE THE EXISTING AND PROPOSED CONDITIONS FOR THE SMALLER BASINS, AS SET FORTH IN THE REVISION OF SECTION 22.2 HYDROLOGY OF THE DEVELOPMENT PROCES MANUAL, VOLUME II DESIGN CRITERIA DATED 1997 HAS BEEN USED TO QUANTIFY THE PEAK RATE OF DISCHARGE AND VOLUME OF RUN-OFF

PROJECT AREA = 1.7463 ac. SOUTHWEST CHILDCARE ADDITION

PRECIPITATION: 360 = 2.60 in. 1440 = 3.1 in.10day = 4.9 in.

EXCESS PRECIPITATION: PEAK DISCHARGE: TREATMENT A 0.66 in. 1.87 cfs/ac. TREATMENT B 0.92 in. 2.6 cfs/ac. TREATMENT C 1.29 in. 3.45 cfs/ac. TREATMENT D 2.36 in.

5.02 cfs/ac. EXISTING CONDITIONS: PROPOSED CONDITIONS: TREATMENT A O oc. O ac. TREATMENT B O ac. 1.1446 ac. TREATMENT C 1.2484 oc.

TREATMENT D 0.4979 ac. EXISTING EXCESS PRECIPITATION:

Weighted E = $(0.66) \times (0.00) + (0.92) \times (0.00) + (1.29) \times (1.25) + (2.36) \times (0.50) / 1.75$ ac. V100-360 = (1.60)x(1.75)/12 = 0.232123 ac-ft = 10111 CF

0.6017 ac.

EXISTING PEAK DISCHARGE: Q100 = (1.87)x(0.00) + (2.60)x(0.00) + (3.45)x(1.25) + (5.02)x(0.50) = 6.81 CFSPROPOSED EXCESS PRECIPITATION:

Weighted E = $(0.66) \times (0.00) + (0.92) \times (0.00) + (1.29) \times (1.14) + (2.36) \times (0.60) / 1.75$ ac. V100-360 = (1.66)x(1.75)/12.0 = 0.241379 ac-ft = 10514 CF

V100-1440 = (0.24) + (0.60)x(3.10 - 2.60) / 12 = 0.266450 ac-ft = 11607 CF V100-10day = (0.24)+(0.60)x(4.90-2.60)/12 = 0.356705 ac-ft = 15538 CF

PROPOSED PEAK DISCHARGE:

Q100 = $(1.87) \times (0.00) + (2.60) \times (0.00) + (3.45) \times (1.14) + (5.02) \times (0.60) = 6.97$ CFS INCREASE 6.97 CFS -6.81 CFS =0.16 CFS



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DRAINAGE CERTIFICATION

I WALLACE L. BINGHAM NMPE 7281, HEREBY CERTIFY THAT THIS PROJECT HAS BEEN GRADED AND WILL DRAIN IN SUBSTANTIAL COMPLIANCE WITH AND IN ACCORDANCE WITH THE DESIGN INTENT OF THE APPROVED PLAN DATED 04/01/2003. THE RECORD INFORMATION EDITED ONTO THE ORIGINAL DESIGN DOCUMENT HAS BEEN OBTAINED BY ME OR UNDER MY DIRECT SUPERVISION AND IS TRUE AND CORRECT TO THE BEST ON MY KNOWLEDGE AND BELIEF. THE FOLLOWING ARE MINOR CHANGES WHICH DO NOT AFFECT THE ORIGINAL DRAINAGE CONCEPT.

NEW PERMA-CURB 5' FROM SOUTH PROPERTY LINE.

NEW 5' WIDE CONCRETE SIDEWALK ON WYOMING TOWARD ACCESSIBLE ROUTE. SOUTHEAST DOWNSPOUT BLOCKED.

NEW ASPHALT FROM EAST WOOD FENCE WEST TO EXISTING ASPHALT.

NEW OVERLAY & STRIPPING ON EXISTING ASPHALT.

NEW REFUSE BIN ENCLOSURE. 7. SEE ATTACHED SITE PLAN FOR LOCATION OF THE ABOVE CHANGES.

KNOWLEDGE AND BELIEF. THIS CERTIFICATION IS SUBMITTED IN SUPPORT OF A REQUEST FOR RELEASE OF CERTIFICATE OCCUPANCY.

45:50

45.50~

OR

AS-BUILT DESIGNATION

EROSION CONTROL MEASURES

- THE CONTRACTOR SHALL BE HELD RESPONSIBLE FOR MANAGEMENT OF STORM RUN-OFF DURING CONSTRUCTION, HE SHALL ASSURE THAT THE FOLLOWING MEASURES ARE
 - A. ADJACENT PROPERTY SHALL BE PROTECTED AT ALL TIMES BY TEMPORARY BERMS, DIKES, SWALES, AND OTHER TEMPORARY GRADING AS REQUIRED TO PREVENT STORM RUN-OFF FROM LEAVING THE SITE AND ENTERING ADJACENT PROPERTY.

CONCRETE SIDEMULK

UTILITY 364.42

- B. ADJACENT PUBLIC RIGHT-OF-WAY SHALL BE PROTECTED AT ALL TIMES FROM STORM WATER RUN-OFF FROM THE SITE. NO SEDIMENT BEARING WATER SHALL BE PERMITTED TO ENTER THE PUBLIC STREETS.
- 2. THE CONTRACTOR SHALL IMMEDIATELY AND THOROUGHLY REMOVE ANY OR ALL SEDIMENT WITHIN THE PUBLIC STREETS THAT HAVE BEEN ERODED FROM THE SITE AND DEPOSITED THERE.





113.25

NO OFF-SITE FLOWS

NEW RFFUST BIN

NOTICE TO CONTRACTOR

P.P.

4802 WYOMING BLVD.

T.B.M. F.F.E. = 5445.7

A 1-STORY MASONRY BUILDING

- 1. An excavation/construction permit will be required before beginning any work within the City right—of—way. Approved copy of this plan must be submitted at the time of application for permit.
- 2. All work detailed in this plan to be performed, except as otherwise stated or provided hereon, shall be constructed in accordance with City of Albuquerque Standard Specification for Public Works Construction.
- 3. Two working days prior to any excavation, contractor must contact line locating Services for locating existing utilities, (260-1990).
- 4. Prior to construction, the contractor shall excavate and verify the horizonal and vertical location of all construction. Should a conflict exist, the contractor shall notify the engineer so that the conflict can be resolved with a minimum amount of delay. Backfill compaction shall be according to Commercial use.
- All work on this project shall be performed in accordance with applicable Federal, State and local laws, rules and regulations concerning construction safty and health.
- 7. Maintenance of this facilities shall be the responsibility of the owner of the property served.

LEGAL DESRIPTION TRACT A OF THE EVANGELICAL COVENANT CHURCH ADDITION, ALBUQUERQUE, NEW MEXICO

NO OFF-SITE FLOWS

CONCRETE

SYMBOL LEGEND

251.17'

EXISTING CONTOUR EXISTING SPOT ELEVATION DESIGNED SPOT ELEVATION PROPERTY LINE EASEMENT LINE

FLOW DIRECTION EXISTING SPOT ELEVATION


DOWN SPOUT ABBREVIATION LEGEND

TOP OF CON. PAD - TCP TOP OF CURB - TC TOP OF ASPHALT - TA FLOWLINE – FL TOP OF WALL

× 46.0

- TW

A.C.S. BENCHMARK REFERENCE: STA. "13-F19", AN ALUM. DISK AT THE HIW QUAD. OF WYOMING & MONTGOMERY ELEV.=5431,700

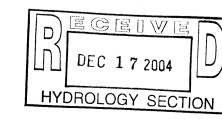


SCALE: 1" = 20'

ONE FOOT CONTOUR INTERVAL

S.89*59'20"W.

GRADING/DRAINAGE PLAN 1" =20'

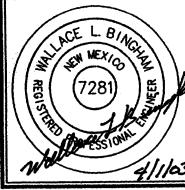


APRIL 2003 REVISIONS

364.42

5.0' UTILITY ANCHOR EASEMENT

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SHEET NO.

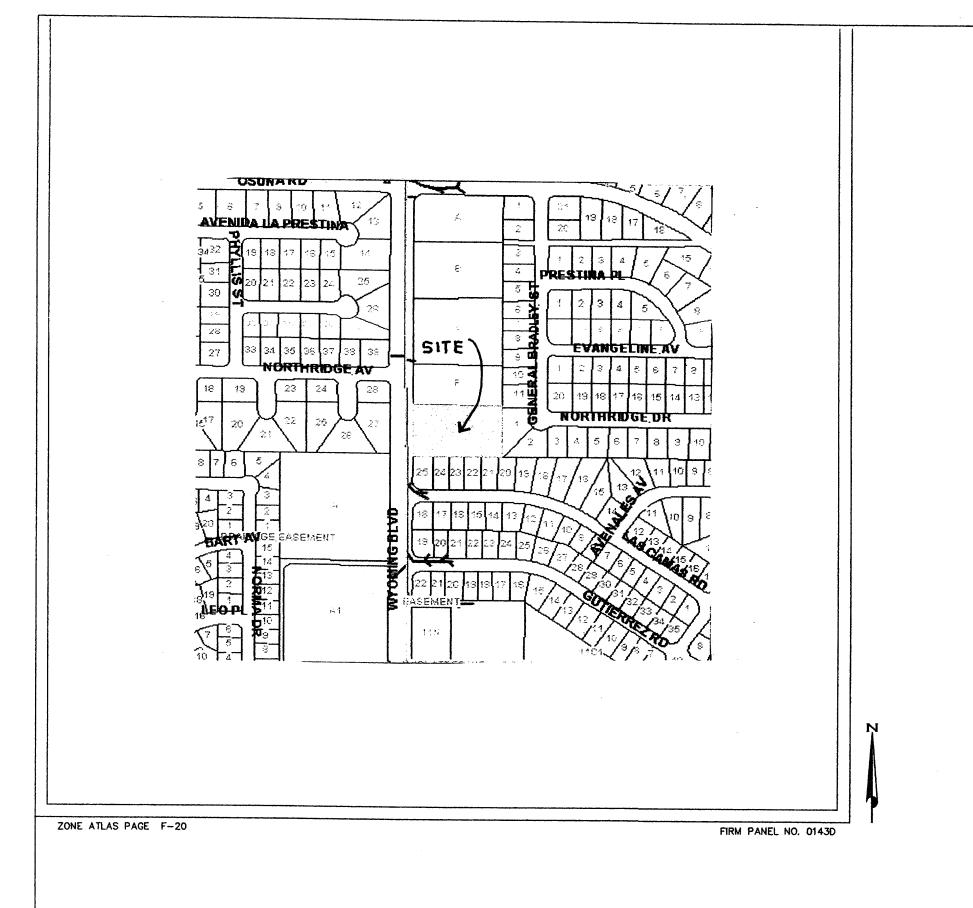

GRADING/DRAINAGE PLAN

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PROJECT AREA = 1.7463 ac. SOUTHWEST CHILDCARE ADDITION PRECIPITATION: 360 = 2.60 in. 1440 = 3.1 in.10day = 4.9 in.

EXCESS PRECIPITATION: PEAK DISCHARGE: TREATMENT A 0.66 in. 1.87 cfs/ac. TREATMENT B 0.92 in. 2.6 cfs/ac. TREATMENT C 1.29 in.

3.45 cfs/ac. TREATMENT D 2.36 in. 5.02 cfs/ac. EXISTING CONDITIONS: PROPOSED CONDITIONS: TREATMENT A O ac. 0 ac. TREATMENT B 0 ac. TREATMENT C 1.2484 ac. 1.1446 ac.

EXISTING EXCESS PRECIPITATION:

TREATMENT D 0.4979 ac.

Weighted E = (0.66)x(0.00)+(0.92)x(0.00)+(1.29)x(1.25)+(2.36)x(0.50)/1.75 ac. V100-360 = (1.60)x(1.75)/12 = 0.232123 ac-ft = 10111 CF

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EXISTING PEAK DISCHARGE:

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Q100 = (1.87)x(0.00)+(2.60)x(0.00)+(3.45)x(1.14)+(5.02)x(0.60)=6.97 CFS INCREASE 6.97 CFS - 6.81 CFS = 0.16 CFS

DRAINAGE CERTIFICATION

I WALLACE L. BINGHAM NMPE 7281, HEREBY CERTIFY THAT THIS PROJECT HAS BEEN GRADED AND WILL DRAIN IN SUBSTANTIAL COMPLIANCE WITH AND IN ACCORDANCE WITH THE DESIGN INTENT OF THE APPROVED PLAN DATED 04/01/2003. THE RECORD INFORMATION EDITED ONTO THE ORIGINAL DESIGN DOCUMENT HAS BEEN OBTAINED BY ME OR UNDER MY DIRECT SUPERVISION AND IS TRUE AND CORRECT TO THE BEST ON MY KNOWLEDGE AND BELIEF. THE FOLLOWING ARE MINOR CHANGES WHICH DO NOT AFFECT THE ORIGINAL DRAINAGE CONCEPT.

NEW PERMA-CURB 5' FROM SOUTH PROPERTY LINE.

NEW 5' WIDE CONCRETE SIDEWALK ON WYOMING TOWARD ACCESSIBLE ROUTE.

SOUTHEAST DOWNSPOUT BLOCKED. NEW ASPHALT FROM EAST WOOD FENCE WEST TO EXISTING ASPHALT.

NEW OVERLAY & STRIPPING ON EXISTING ASPHALT. NEW REFUSE BIN ENCLOSURE.

SEE ATTACHED SITE PLAN FOR LOCATION OF THE ABOVE CHANGES.

KNOWLEDGE AND BELIEF. THIS CERTIFICATION IS SUBMITTED IN SUPPORT OF A REQUEST FOR RELEASE OF CERTIFICATE OCCUPANCY.

AS-BUILT DESIGNATION 45.50 OR 45.50~

EROSION CONTROL MEASURES

1. THE CONTRACTOR SHALL BE HELD RESPONSIBLE FOR MANAGEMENT OF STORM RUN-OFF DURING CONSTRUCTION, HE SHALL ASSURE THAT THE FOLLOWING MEASURES ARE TAKEN:

N.89*59'20"E.

38 CONCRETE SIDEWALK

UTILITY 364.42'

SAMPLE AND CHARLES CONTRACTOR OF THE CONTRACTOR

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- A. ADJACENT PROPERTY SHALL BE PROTECTED AT ALL TIMES BY TEMPORARY BERMS, DIKES, SWALES, AND OTHER TEMPORARY GRADING AS REQUIRED TO PREVENT STORM RUN-OFF FROM LEAVING THE SITE AND ENTERING ADJACENT PROPERTY.
- B. ADJACENT PUBLIC RIGHT-OF-WAY SHALL BE PROTECTED AT ALL TIMES FROM STORM WATER RUN-OFF FROM THE SITE. NO SEDIMENT BEARING WATER SHALL BE PERMITTED TO ENTER THE PUBLIC STREETS.
- 2. THE CONTRACTOR SHALL IMMEDIATELY AND THOROUGHLY REMOVE ANY OR ALL SEDIMENT WITHIN THE PUBLIC STREETS THAT HAVE BEEN ERODED FROM THE SITE AND DEPOSITED THERE.

NOTICE TO CONTRACTOR

4802 WYOMING BLVD.

T.B.M. F.F.E. = 5445.7

22" CAL. MULBERR

NEW REFUSE BIT

BLOCK WALL

NO OFF-SITE FLOWS

EWCLOSUILE

A 1-STORY MASONRY BUILDING

ENTRY ARBORVITAE

¥ 5445.7**V**

- 20.00' UTILITY EASEMENT

PROPOSED FINISH FLOOR ELEV.

RAMP UP

- 1. An excavation/construction permit will be required before beginning any work within the City right-of-way. Approved copy of this plan must be submitted at the time of application for permit.
- 2. All work detailed in this plan to be performed, except as otherwise stated or provided hereon, shall be constructed in accordance with City of Albuquerque Standard Specification for Public Works Construction.
- 3. Two working days prior to any excavation, contractor must contact line locating Services for locating existing utilities, (260-1990).
- 4. Prior to construction, the contractor shall excavate and verify the horizonal and vertical location of all construction. Should a conflict exist, the contractor shall notify the engineer so that the conflict can be resolved with a minimum amount of delay.
- 5. Backfill compaction shall be according to Commercial use. All work on this project shall be performed in accordance with applicable Federal, State and local laws, rules and regulations concerning construction safty and health.
- 7. Maintenance of this facilities shall be the responsibility of the owner of the property served.

LEGAL DESRIPTION

NO OFF-SITE FLOWS

TRACT A OF THE EVANGELICAL COVENANT CHURCH ADDITION, ALBUQUERQUE, NEW MEXICO

CONCRETE

SYMBOL LEGEND EXISTING CONTOUR ------ 5450 -----

EXISTING SPOT ELEVATION DESIGNED SPOT ELEVATION PROPERTY LINE

EASEMENT LINE FLOW DIRECTION EXISTING SPOT ELEVATION


DOWN SPOUT

251.17′

ABBREVIATION LEGEND TOP OF CON. PAD - TCP TOP OF CURB

- TC TOP OF ASPHALT – *TA* FLOWLINE – FL TOP OF WALL - TW

<u>GRADING/DRAIN</u>AGE PLAN 1" =20

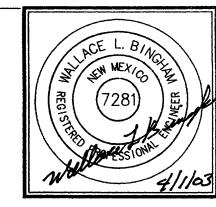

APRIL 2003 REVISIONS

364.42

S.89°59'20"W

SCALE: 1" = 20'


ONE FOOT CONTOUR INTERVAL


A.C.S. BENCHMARK REFERENCE: STA. '13-F19', AN ALUM. DISK AT THE NNW QUAD. OF WYOMING & MONTGOMERY. ELEV.=5431.700

5.0' UTILITY ANCHOR EASEMENT

OH'D. LINES

JOO \mathfrak{O}

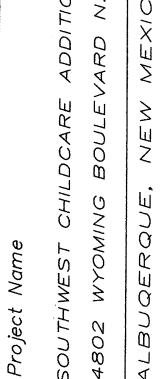

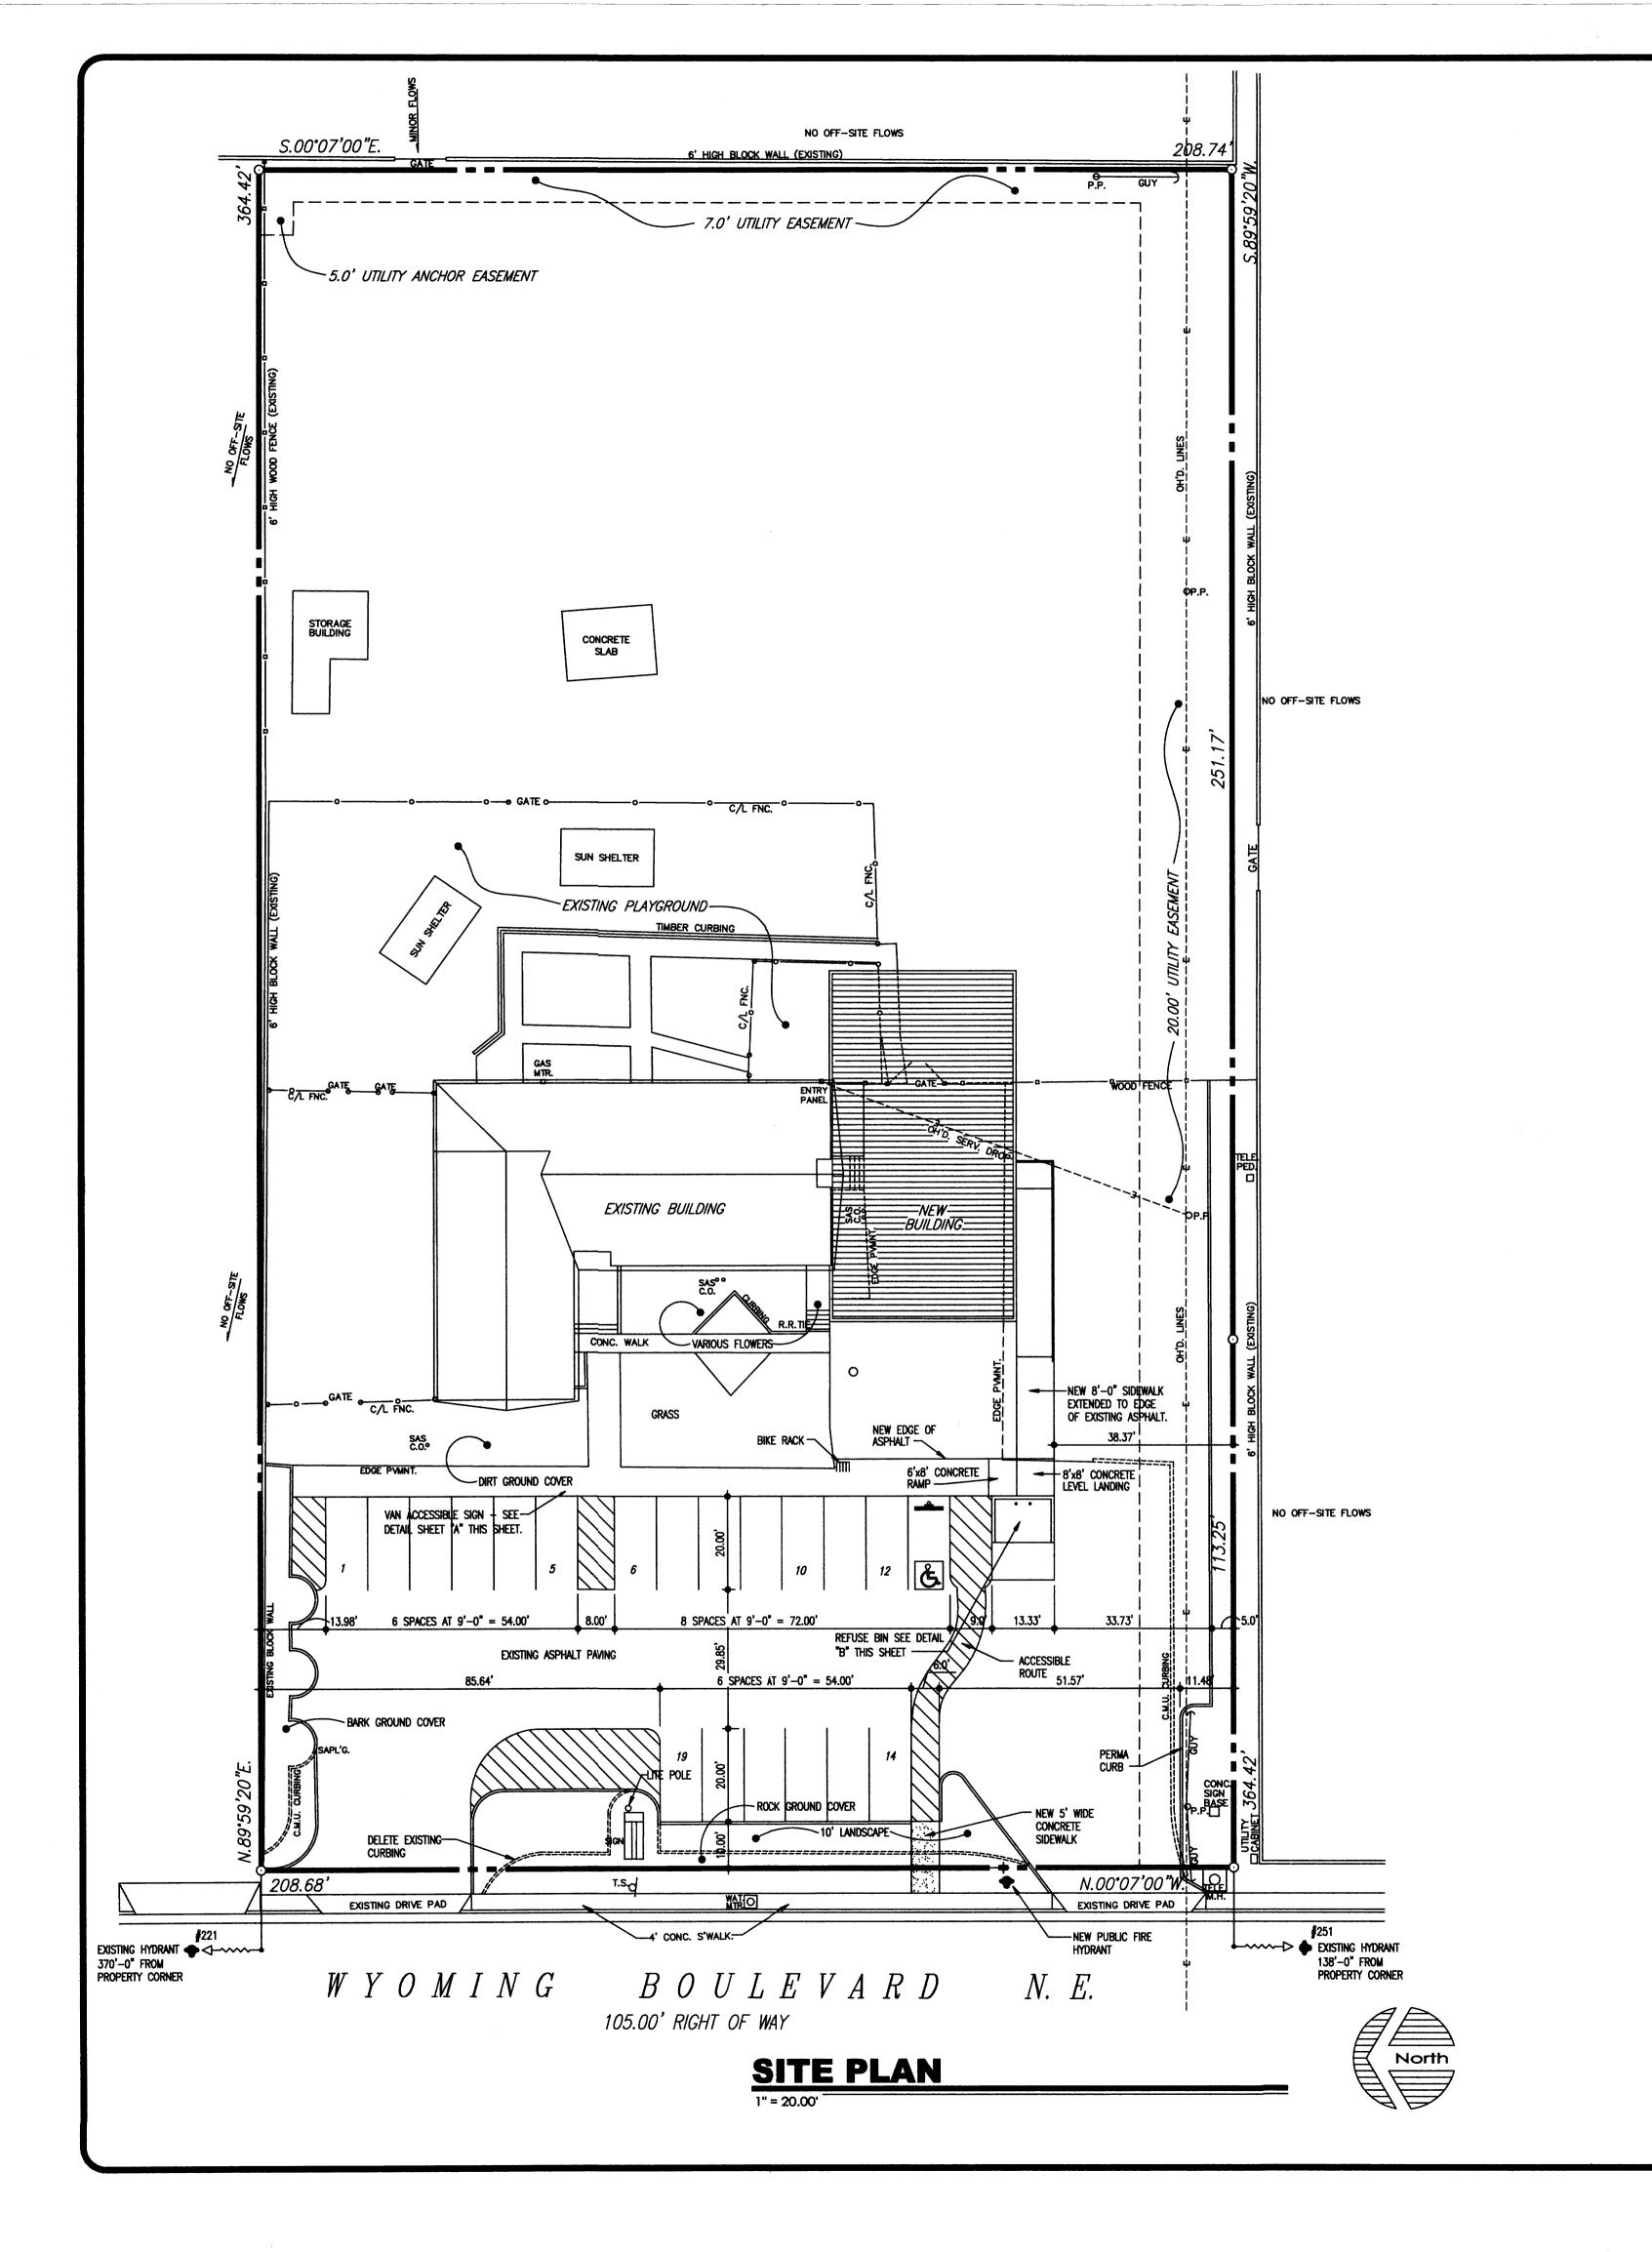

DURA BILT Products, Inc.

Products, Inc.

DESIGN / BUILDER
Since 1950

LICENSE NO. 3044

4808 JEFFERSON N.E.
ALBUQUERQUE N.M. 87109
Telephone: (505) 883-9100
Fax: (505) 883-9198

www.durabiltproducts.com

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DATE: December 2, 2002 PLOT DATE: June 25, 2003 REVISIONS:

FILE: SWSHTAI.D


LTHWEST ILDCARR MOMING BOULEVARD N.E.


> D) 国区国IV国 AUG 25 33

SITE PLAN

SHEET NO.

JOB NO. : 02-122 OF 5

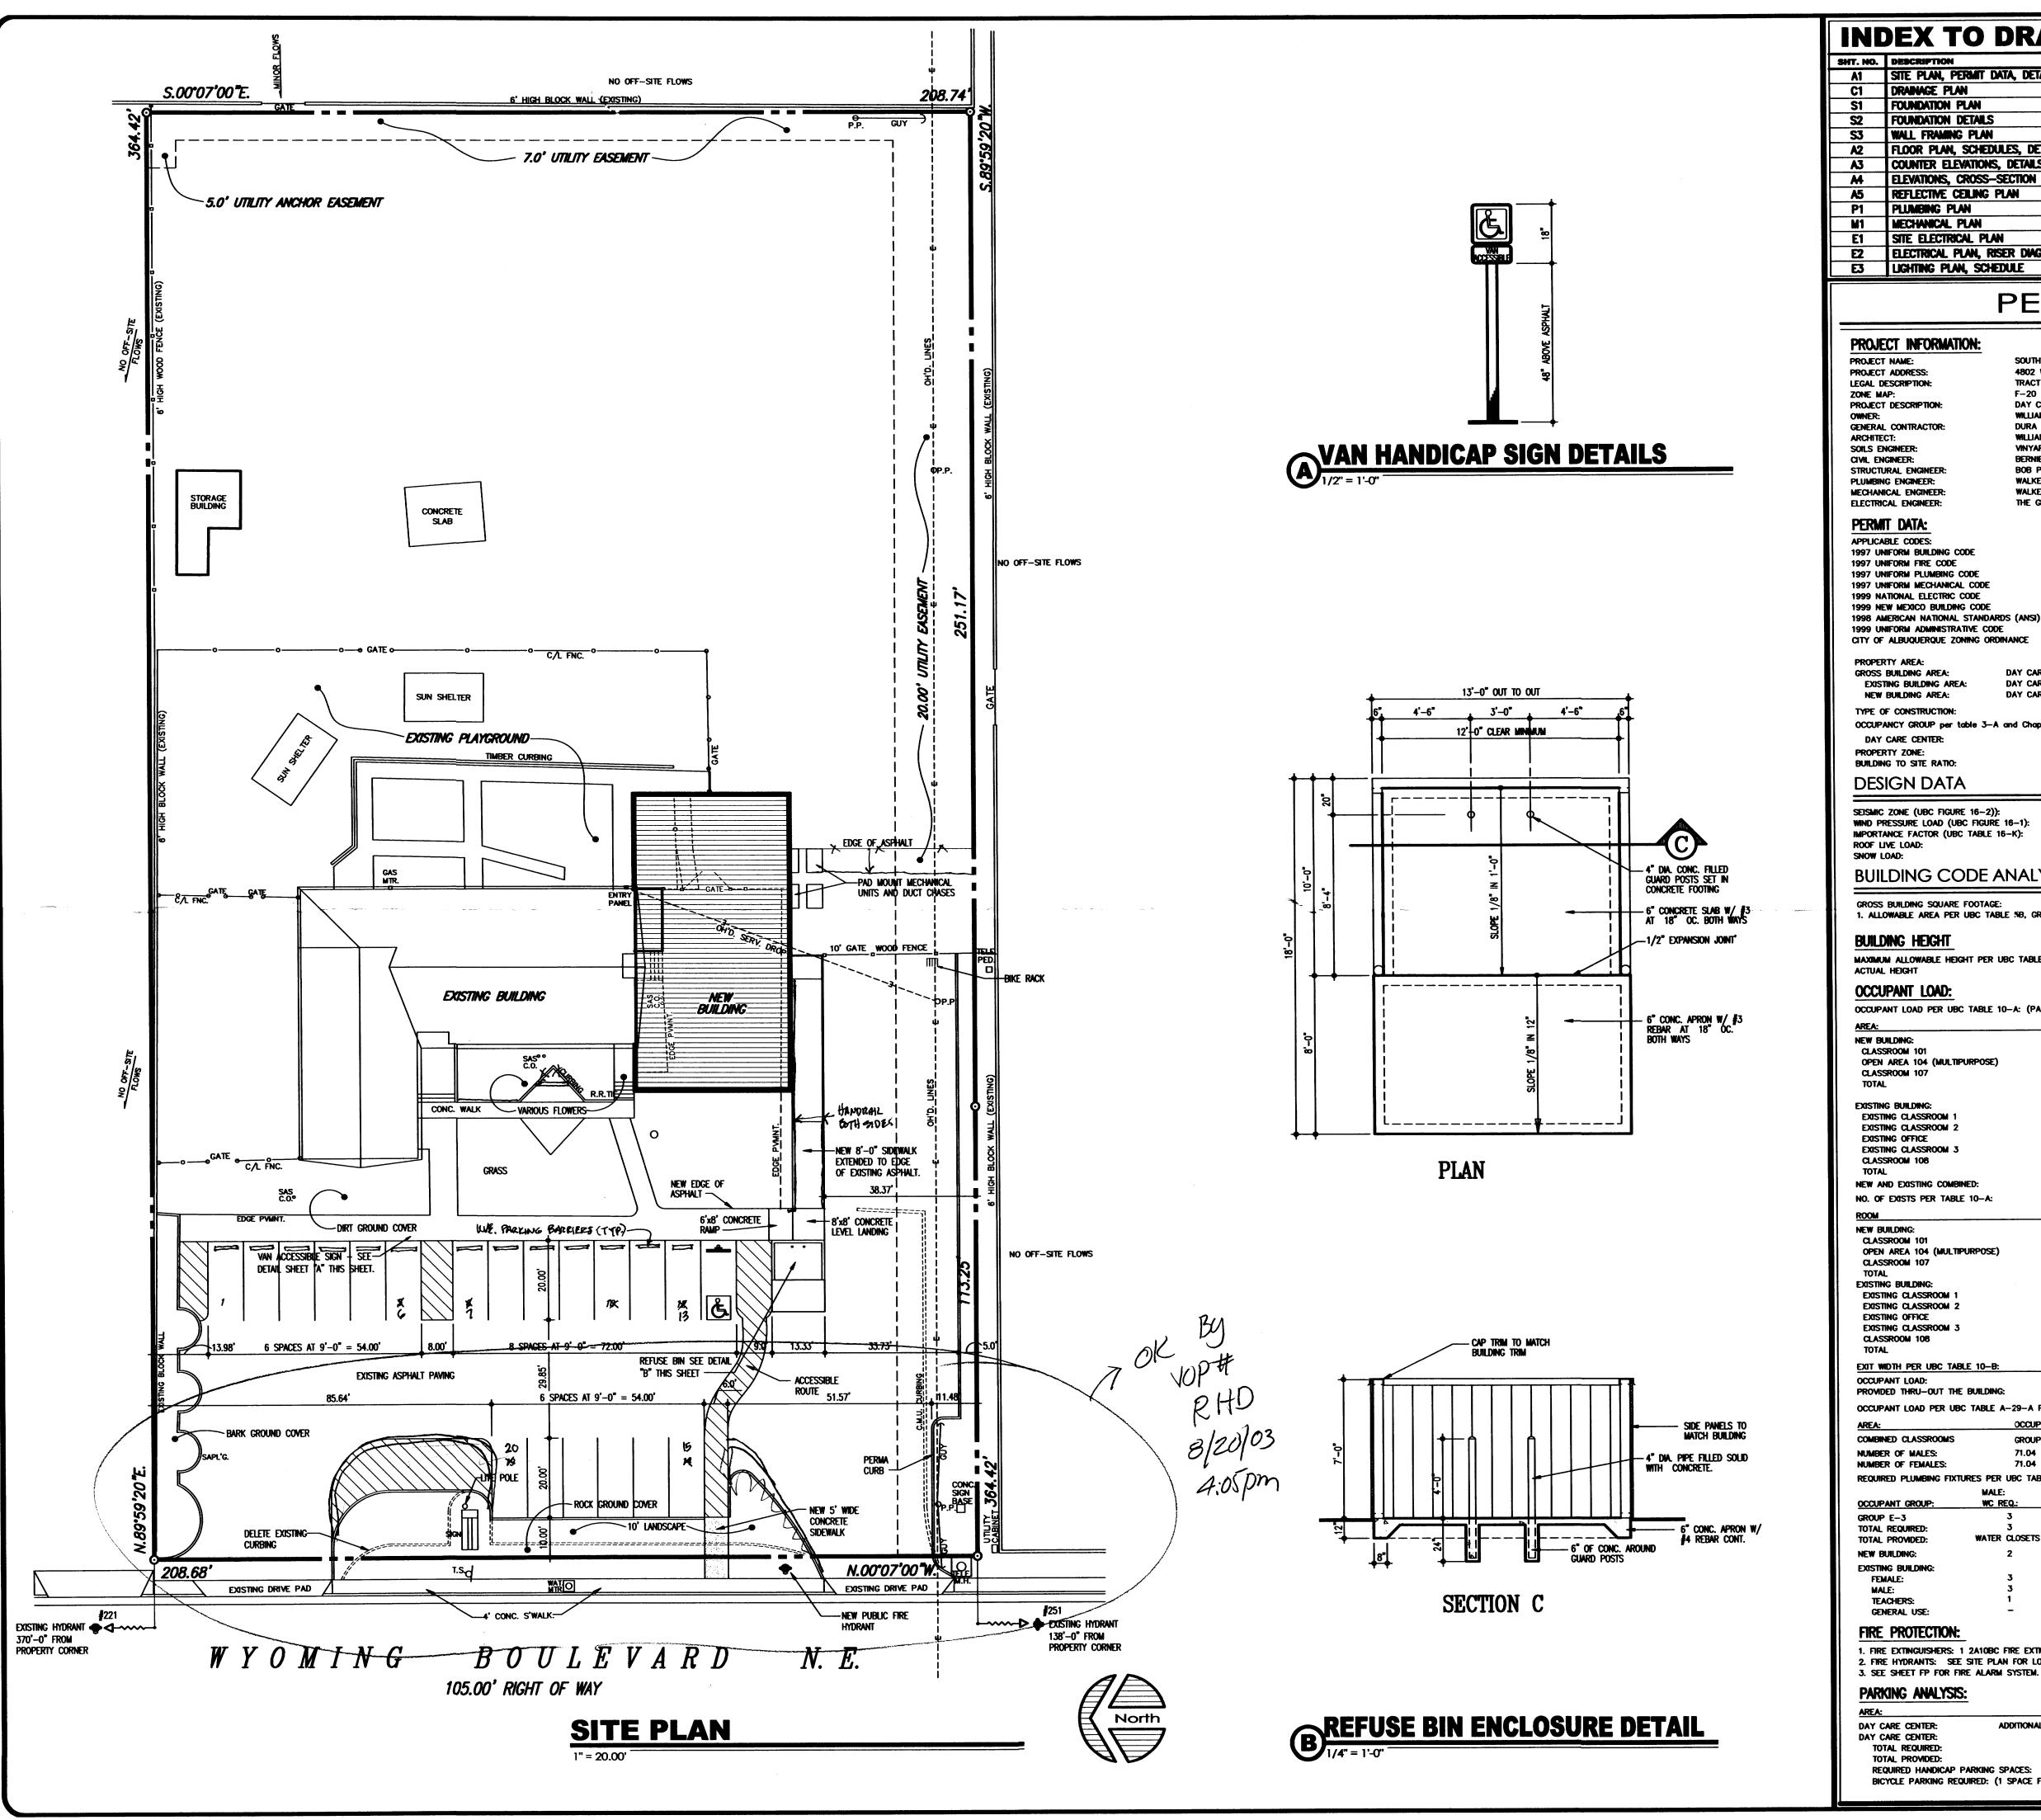

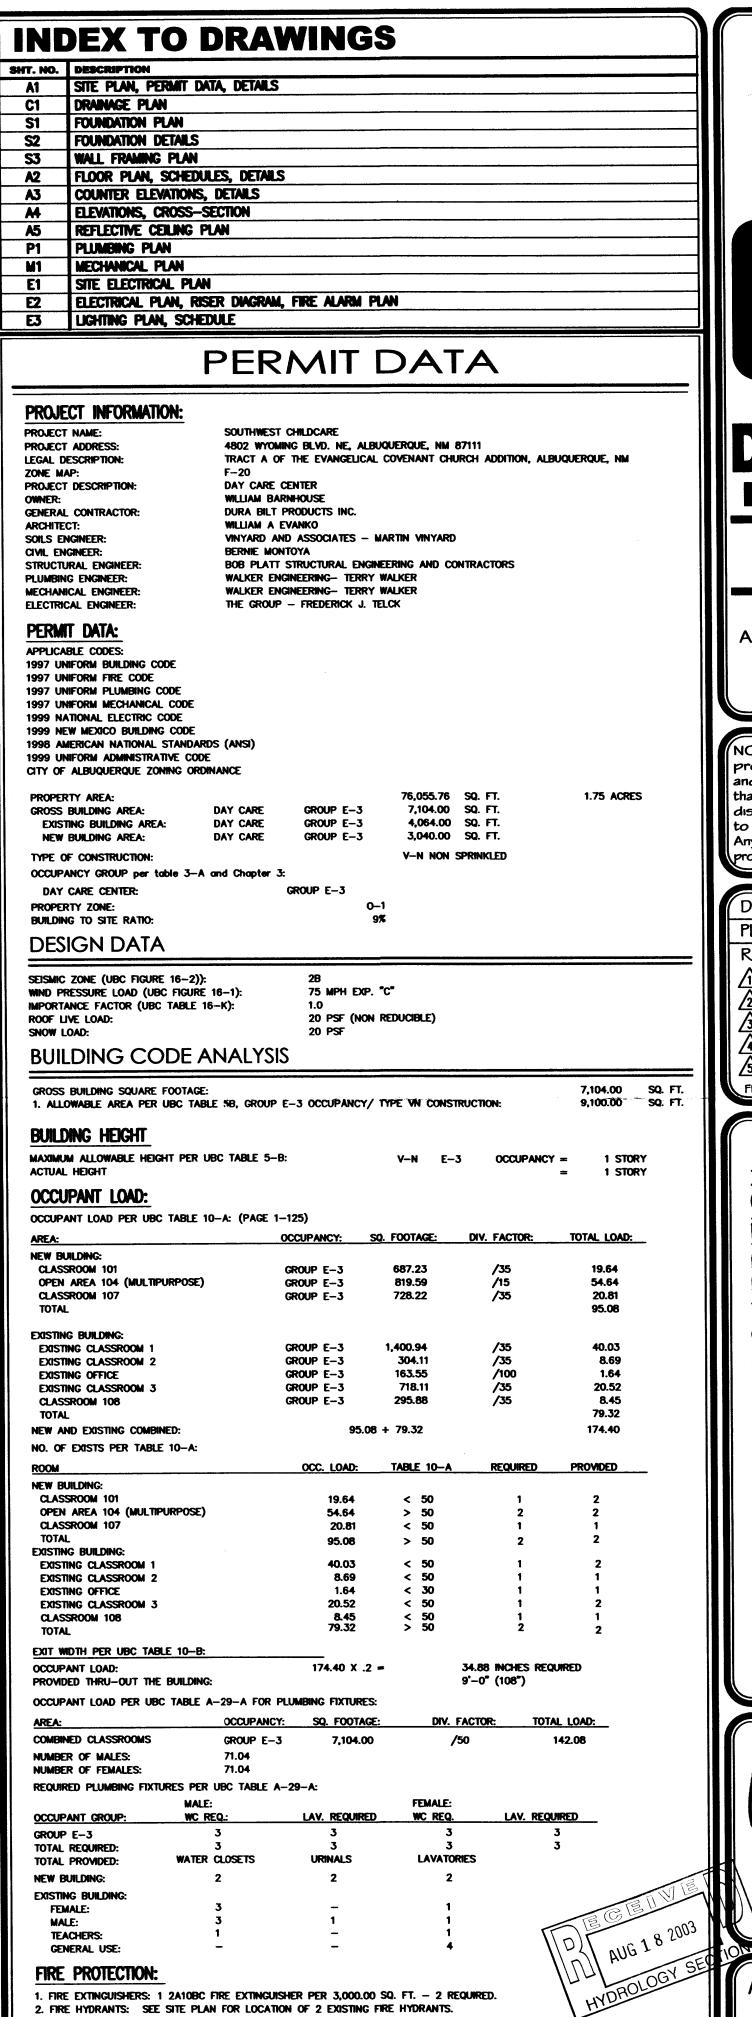


SQ. FOOTAGE: DIV. FACTOR:

ADDITIONAL 2 SPACES PLUS 1/500

TOTAL REQUIRED: TOTAL PROVIDED:

REQUIRED HANDICAP PARKING SPACES:

BICYCLE PARKING REQUIRED: (1 SPACE FOR EA. 20 PARKING SPACES)

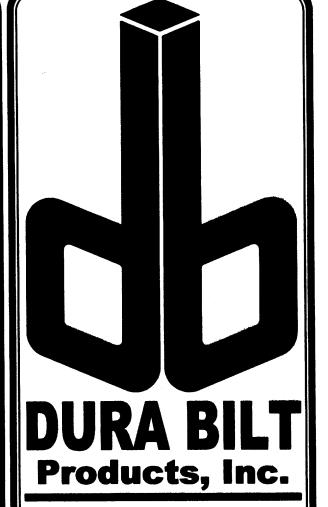


DESIGN / BUILDER Since 1950 LICENSE NO. 3044

4808 JEFFERSON N.E. ALBUQUERQUE N.M. 87109 Telephone: (505) 883-9100 Fax: (505) 883-9198 www.durabiltproducts.com


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DATE: December 2, 2002 PLOT DATE: August 15, 2003 **REVISIONS:**

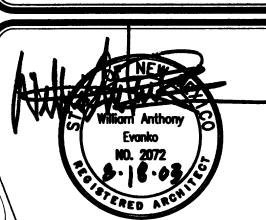

SHEET NO.

JOB NO. : 02-122 OF 5

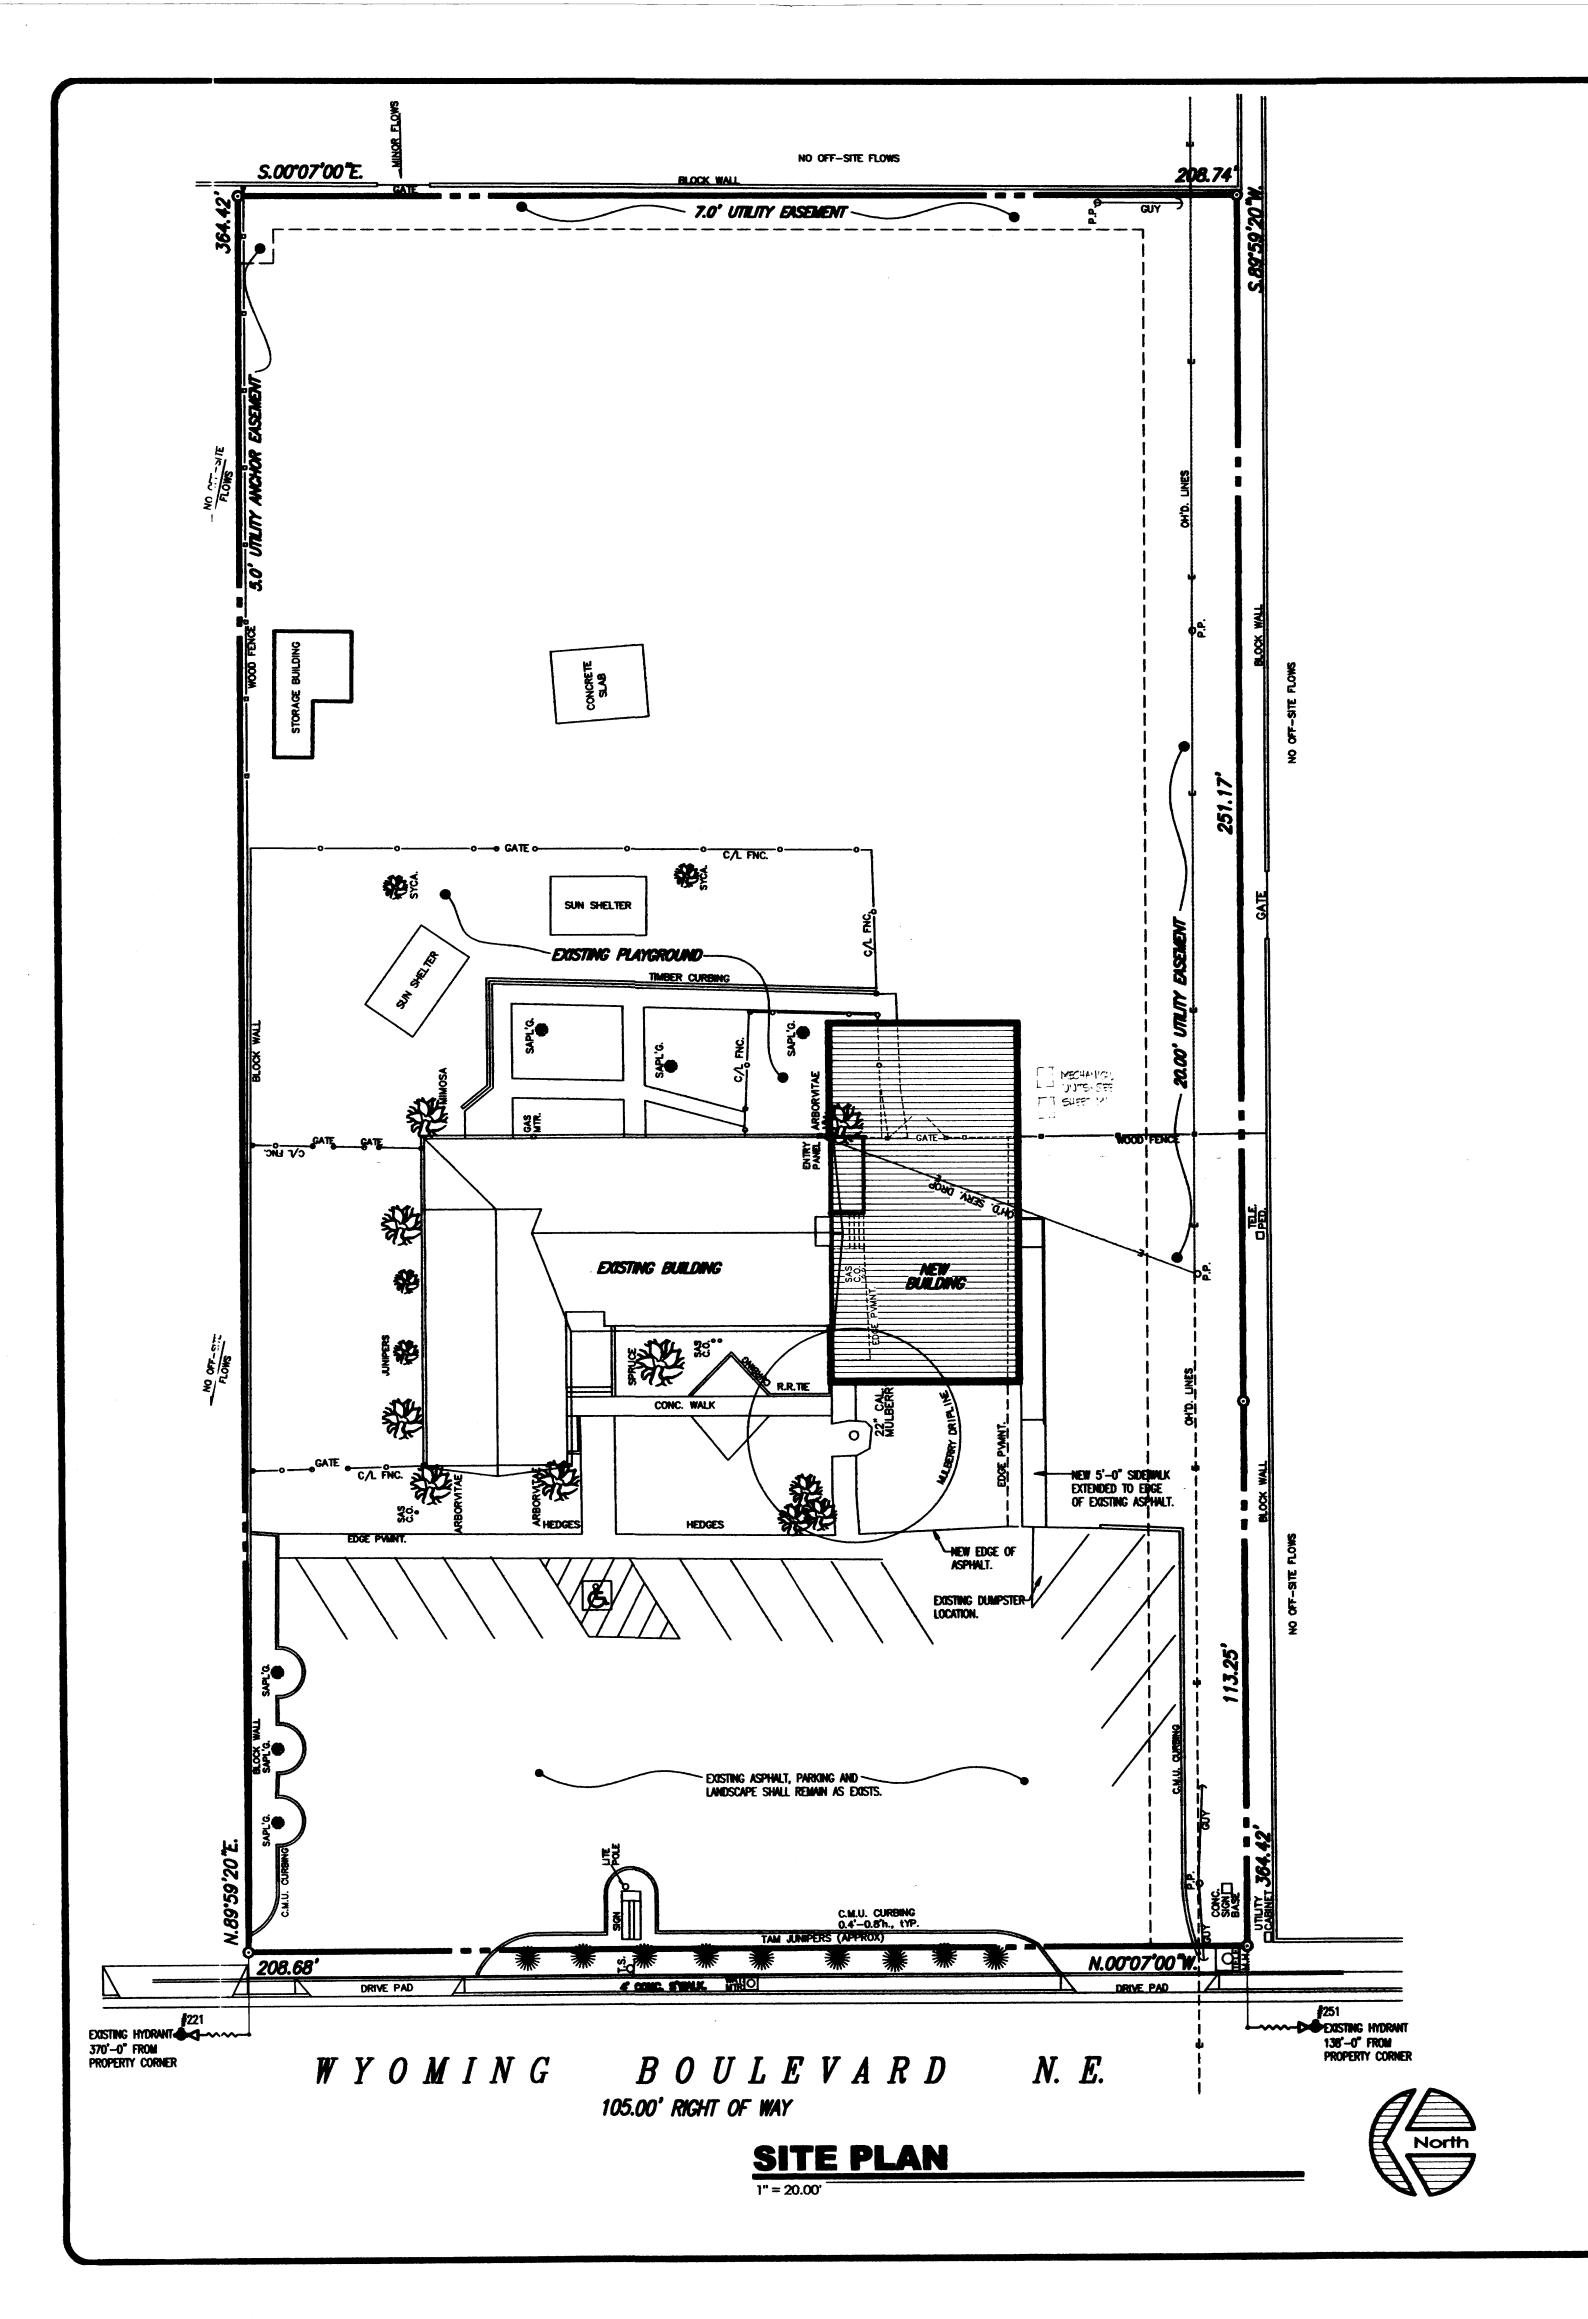

PERMIT DATA

PROJECT INFORMATION: SOUTHWEST CHILD CARE PROJECT NAME: 4802 WYOMING BLVD. NE, ALBUQUERQUE, NM 87111 PROJECT ADDRESS: TRACT A OF THE EVANGELICAL COVENANT CHURCH ADDITION, ALBUQUERQUE, NM LEGAL DESCRIPTION: ZONE MAP: PROJECT DESCRIPTION: DAY CARE CENTER

WILLIAM BARNHOUSE GENERAL CONTRACTOR: DURA BILT PRODUCTS INC. WILLIAM A EVANKO ARCHITECT:

SOILS ENGINEER: VINYARD AND ASSOCIATES - MARTIN VINYARD CML ENGINEER: BERNIE MONTOYA STRUCTURAL ENGINEER: BOB PLATT STRUCTURAL ENGINEERING AND CONTRACTORS WALKER ENGINEERING- TERRY WALKER PLUMBING ENGINEER: WALKER ENGINEERING— TERRY WALKER MECHANICAL ENGINEER: THE GROUP - FREDERICK J. TELCK ELECTRICAL ENGINEER:

PERMIT DATA:

APPLICABLE CODES: 1997 UNIFORM BUILDING CODE 1997 UNIFORM FIRE CODE 1997 UNIFORM PLUMBING CODE 1997 UNIFORM MECHANICAL CODE 1999 NATIONAL ELECTRIC CODE 1999 NEW MEXICO BUILDING CODE 1998 AMERICAN NATIONAL STANDARDS (ANSI) 1999 UNIFORM ADMINISTRATIVE CODE CITY OF ALBUQUERQUE ZONING ORDINANCE

1.75 ACRES 76,055.76 SQ. FT. PROPERTY AREA: GROUP E-3 DAY CARE 7,104.00 SQ. FT. GROSS BUILDING AREA: 4,064.00 SQ. FT. GROUP E-3 EXISTING BUILDING AREA: DAY CARE DAY CARE GROUP E-3 3,040.00 SQ. FT. NEW BUILDING AREA: TYPE OF CONSTRUCTION: II—N FULLY SPRINKLED OCCUPANCY GROUP per table 3-A and Chapter 3: GROUP E-3 DAY CARE CENTER:

DESIGN DATA

BUILDING TO SITE RATIO:

PROPERTY ZONE:

SEISMIC ZONE (UBC FIGURE 16-2)): WIND PRESSURE LOAD (UBC FIGURE 16-1): 75 MPH EXP. "C" IMPORTANCE FACTOR (UBC TABLE 16-K): 20 PSF (NON REDUCIBLE) ROOF LIVE LOAD: SNOW LOAD:

BUILDING CODE ANALYSIS

7.104.00 SQ. FT. GROSS BUILDING SQUARE FOOTAGE: 1. ALLOWABLE AREA PER UBC TABLE 5B, GROUP E-3 OCCUPANCY/ TYPE IIN CONSTRUCTION: 13,500.00 SQ. FT

II-N E-3 OCCUPANCY = 1 STORY = 1 STORY

BUILDING HEIGHT MAXIMUM ALLOWABLE HEIGHT PER UBC TABLE 5-B: ACTUAL HEIGHT

OCCUPANT LOAD:

OCCUPANCY: SQ. FOOTAGE: DIV. FACTOR: TOTAL LOAD: NEW BUILDING:

CLASSROOM 101 19.64 54.64 OPEN AREA 104 (MULTIPURPOSE) GROUP E-3 819.59 20.81 **95**.08 728.22 CLASSROOM 107 GROUP E-3 EXISTING BUILDING: GROUP E-3 GROUP E-3 40.03 EXISTING CLASSROOM 1,400.94 8.69 1.64 304.11 **EXISTING CLASSROOM 2** 163.55 EXISTING OFFICE GROUP E-3 20.52 **EXISTING CLASSROOM 3** GROUP E-3 718.11 8.45 CLASSROOM 108 GROUP E-3 **79.32** 174.40 NEW AND EXISTING COMBINED: 95.08 + 79.32

NO. OF EXISTS PER TABLE 10-A:

OCC. LOAD: TABLE 10-A REQUIRED PROVIDED NEW BUILDING: CLASSROOM 101 OPEN AREA 104 (MULTIPURPOSE) < 50 20.81 CLASSROOM 107 < 50 EXISTING BUILDING: EXISTING CLASSROOM 1 **EXISTING CLASSROOM 2** EXISTING OFFICE < 50 EXISTING CLASSROOM 3 CLASSROOM 108

EXIT WIDTH PER UBC TABLE 10-B: OCCUPANT LOAD: $174.40 \times .2 =$ 34.88 INCHES REQUIRED 9'-0" (108") PROVIDED THRU-OUT THE BUILDING:

OCCUPANT LOAD PER UBC TABLE A-29-A FOR PLUMBING FIXTURES: GROUP E-3 174.40 COMBINED CLASSROOMS

NUMBER OF WALES: NUMBER OF FEMALES:

TEACHERS:

REQUIRED PLUMBING FIXTURES PER UBC TABLE A-29-A:

| | MALE: | | FEMALE: | |
|--------------------|---------------|---------------|------------|---------------|
| OCCUPANT GROUP: | WC REQ.: | LAV. REQUIRED | WC REQ. | LAV. REQUIRED |
| GROUP E-3 | 1 | 1 | 1 | 1 |
| TOTAL REQUIRED: | 1 | 1 | 1 | 1 |
| TOTAL PROVIDED: | WATER CLOSETS | urinals | LAVATORIES | 2 |
| | 2 | 2 | 2 | |
| NEW BUILDING: | | | | |
| EXISTING BUILDING: | | | | |
| FEMALE: | 3 | - | 1 | |
| MAI E. | 3 | 1 | 1 | |

FIRE PROTECTION:

1. FIRE EXTINGUISHERS: 1 2A10BC FIRE EXTINGUISHER PER 3,000.00 SQ. FT. - 2 REQUIRED. 2. FIRE HYDRANTS: SEE SITE PLAN FOR LOCATION OF 2 EXISTING FIRE HYDRANTS. 3. SEE SHEET FP FOR FIRE ALARM SYSTEM.


PARKING ANALYSIS:

SQ. FOOTAGE: DIV. FACTOR: TOTAL REQUIRED: ADDITIONAL 2 SPACES PLUS 1/500 DAY CARE CENTER: DAY CARE CENTER: 7,104.00 /500 14.21 16.21 TOTAL REQUIRED: TOTAL PROVIDED: REQUIRED HANDICAP PARKING SPACES:

BICYCLE PARKING REQUIRED: (1 SPACE FOR EA. 20 PARKING SPACES)

INDEX TO DRAWINGS

AT SITE PLAN, PERMIT DATA, VICINITY MAP C1 DRAWGE PLAN FOUNDATION PLAN S2 FOUNDATION DETAILS S3 WALL FRANKS PLAN A2 FLOOR PLAN, SCHEDULES, DETAILS AS COUNTER ELEWITIONS, DETAILS AA ELEVATIONS, CROSS-SECTION AS REFLECTIVE CELLING PLAN MI MECHANICAL PLAN ET SITE ELECTRICAL PLAN E2 ELECTRICAL PLAN, RISER DIAGRAM, FIRE ALARM PLAN E3 LIGHTING PLAN, SCHEDULE

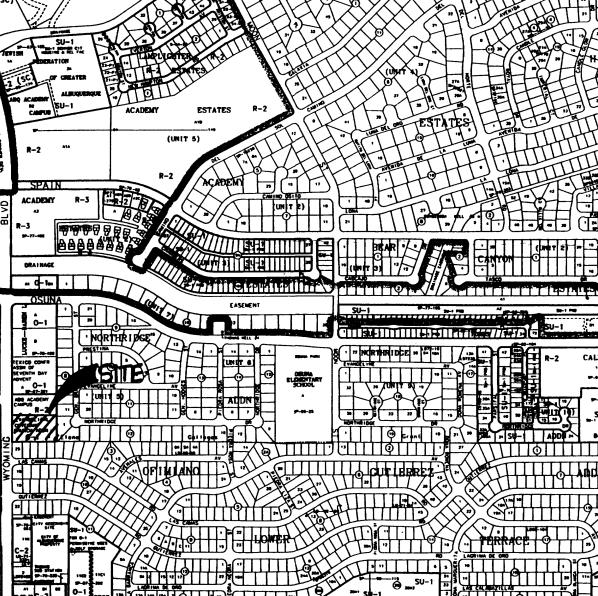

VICINITY MAP

Products, Inc.

DESIGN / BUILDER Since 1950 LICENSE NO. 3044


4808 JEFFERSON N.E. ALBUQUERQUE N.M. 87109

Telephone: (505) 883-9100 Fax: (505) 883-9198 www.durabiltproducts.com

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DATE: December 2, 2002 PLOT DATE: March 21, 2003 **REVISIONS:**


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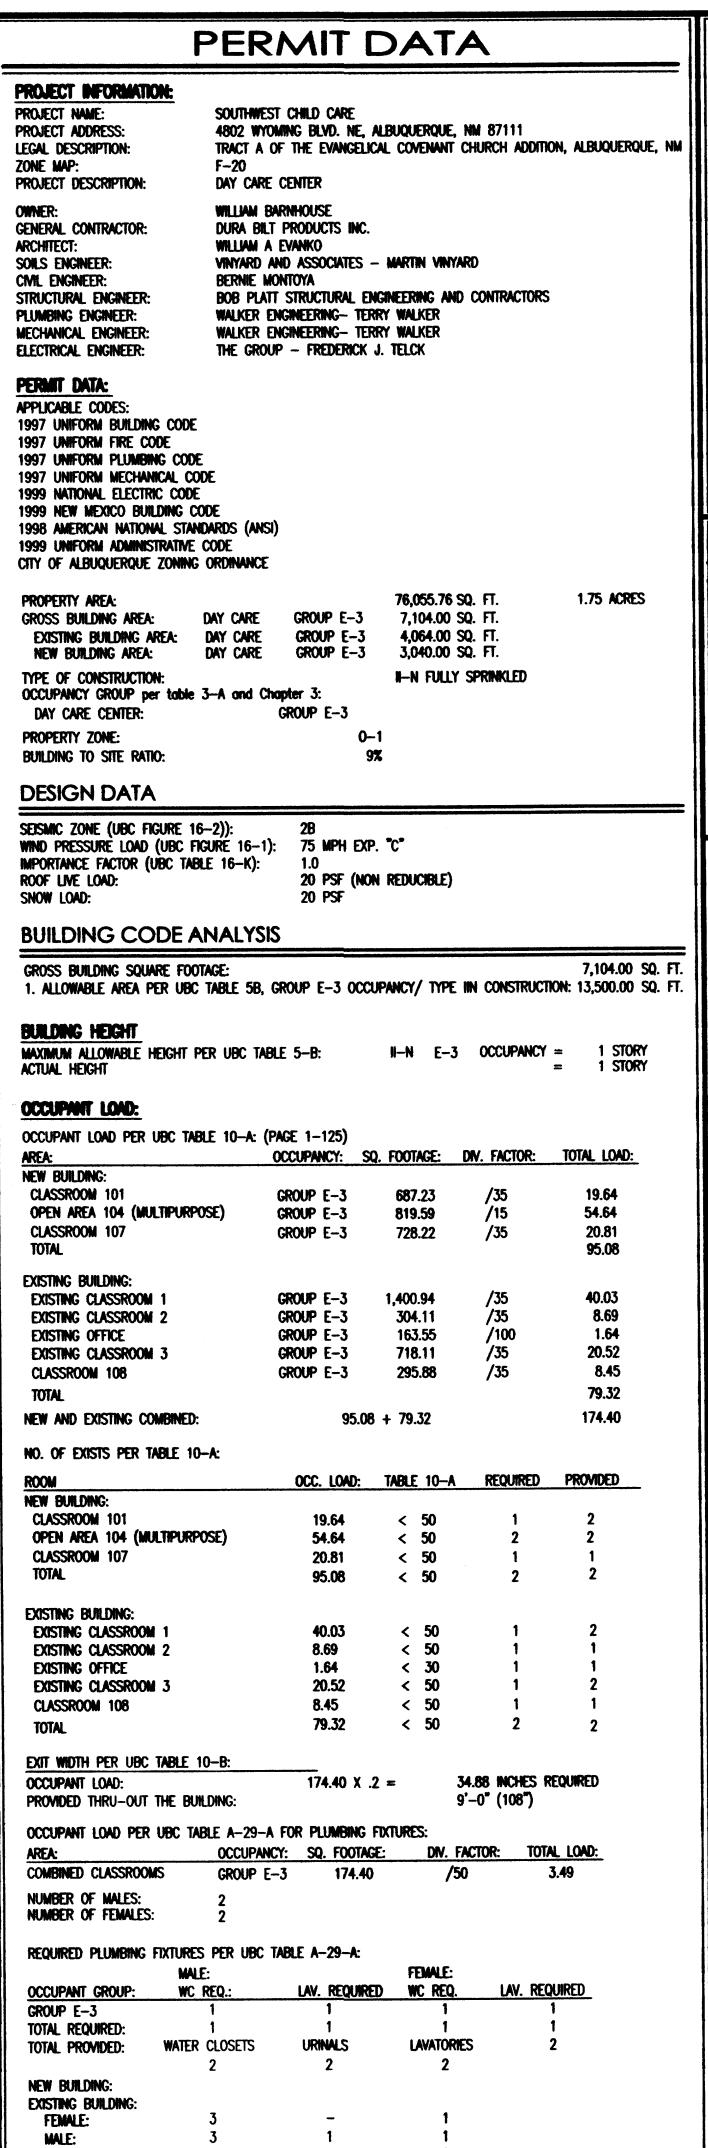


SITE PLAN

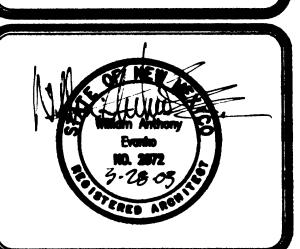JOB NO. : 02-122 **OF**

SHEET NO.



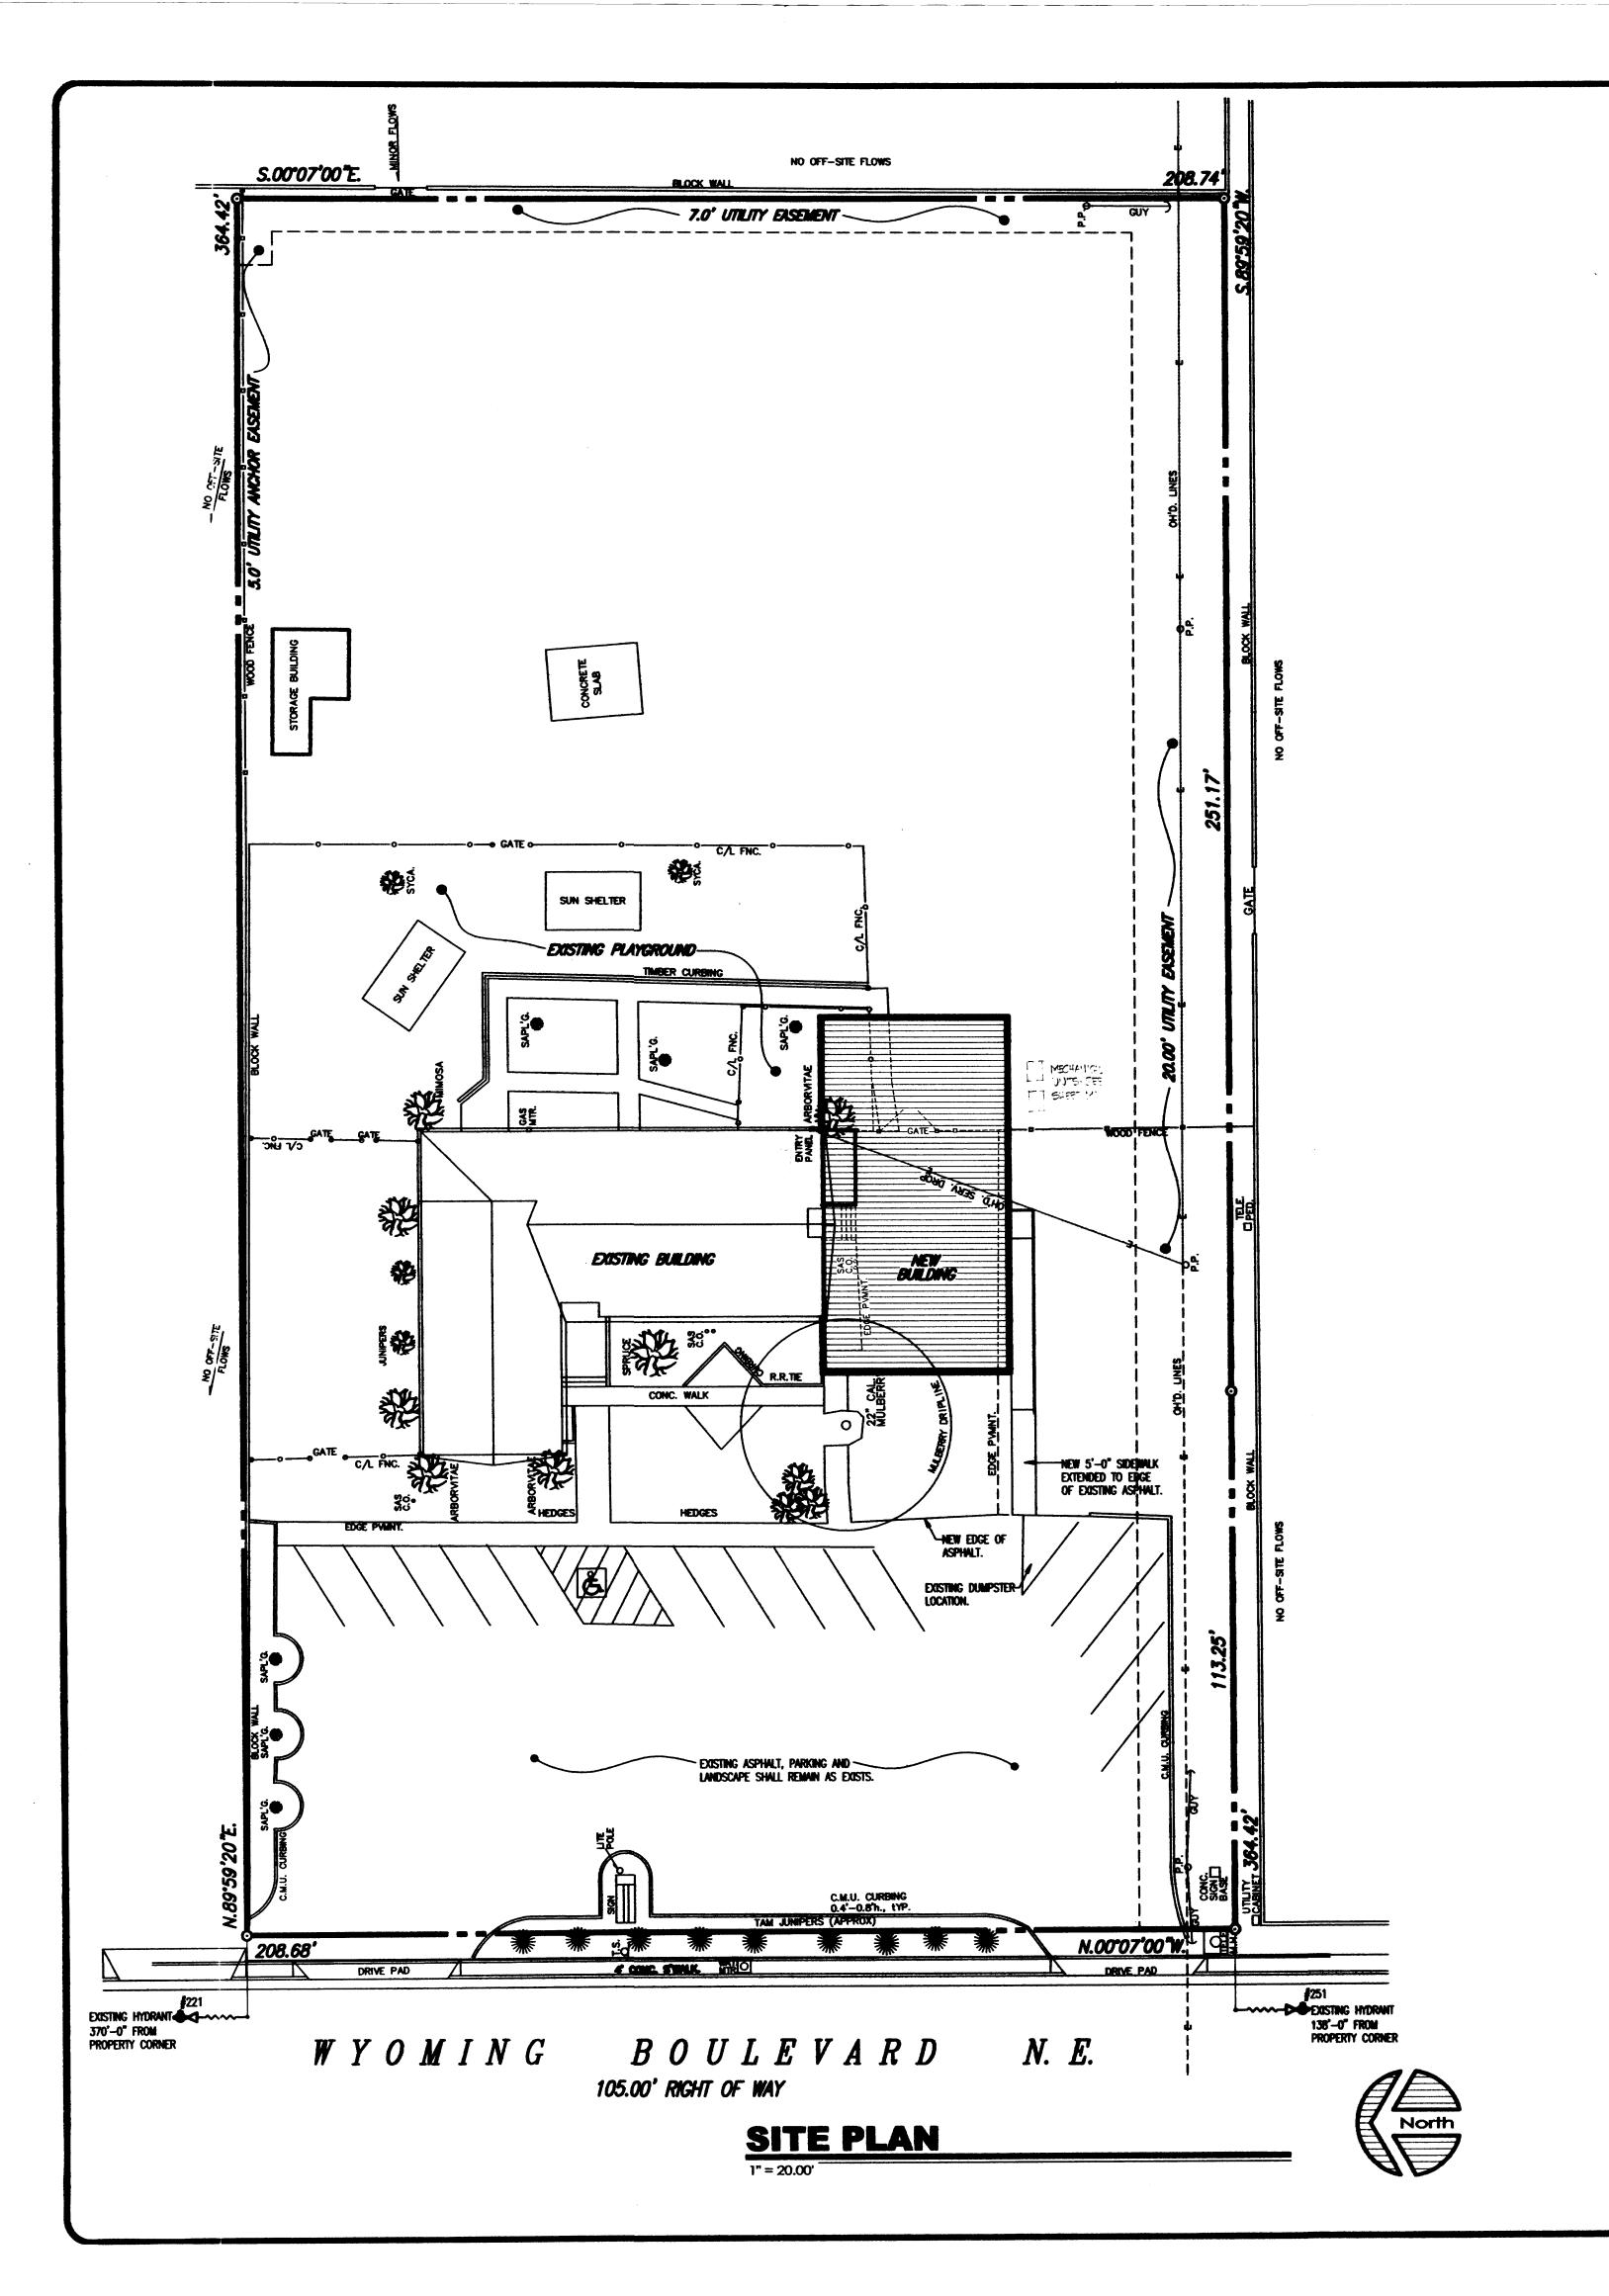

TEACHERS:

FIRE PROTECTION:

1. FIRE EXTINGUISHERS: 1 2A10BC FIRE EXTINGUISHER PER 3,000.00 SQ. FT. - 2 REQUIRED. 2. FIRE HYDRANTS: SEE SITE PLAN FOR LOCATION OF 2 EXISTING FIRE HYDRANTS. 3. SEE SHEET FP FOR FIRE ALARM SYSTEM.

PARKING ANALYSIS:

| I LEAVING LEAFLOW | | | |
|----------------------------------|------------------|----------------|-----------------|
| AREA: | SQ. FOOTAGE: | DIV. FACTOR: | TOTAL REQUIRED: |
| DAY CARE CENTER: ADDITIONA | L 2 SPACES PLUS | 1/500 | 2 |
| DAY CARE CENTER: | 7,104.00 | /500 | 14.21 |
| TOTAL REQUIRED: | | | 16.21 |
| TOTAL PROVIDED: | | | - |
| REQUIRED HANDICAP PARKING SPAC | ES: | | 1.00 |
| BICYCLE PARKING REQUIRED: (1 SP. | ACE FOR EA. 20 P | PARKING SPACES | 0.81 |

INDEX TO DRAWINGS

EZ ELECTRICAL PLAN, RISER DIAGRAM, FIRE ALARM PLAN

VICINITY MAP

AT SITE PLAN, PENMIT DATA, VICINITY MAP

A2 FLOOR PLAN, SCHEDULES, DETAILS

AS COUNTER ELEVATIONS, DETAILS

AM ELEVATIONS, CROSS-SECTION AS REFLECTIVE CEILING PLAN

C1 DRABBAGE PLAN

S1 FOUNDATION PLAN

P1 PLUMBING PLAN

M1 MECHANICAL PLAN

E1 SHE ELECTRICAL PLAN

E3 LIGHTING PLAN, SCHEDULE

32 FOUNDATION DETAILS

S3 WALL FRAMING PLAN

Products, Inc. DESIGN / BUILDER


Since 1950

LICENSE NO. 3044 4808 JEFFERSON N.E.

ALBUQUERQUE N.M. 87109 Telephone: (505) 883-9100 Fax: (505) 883-9198 www.durabiltproducts.com

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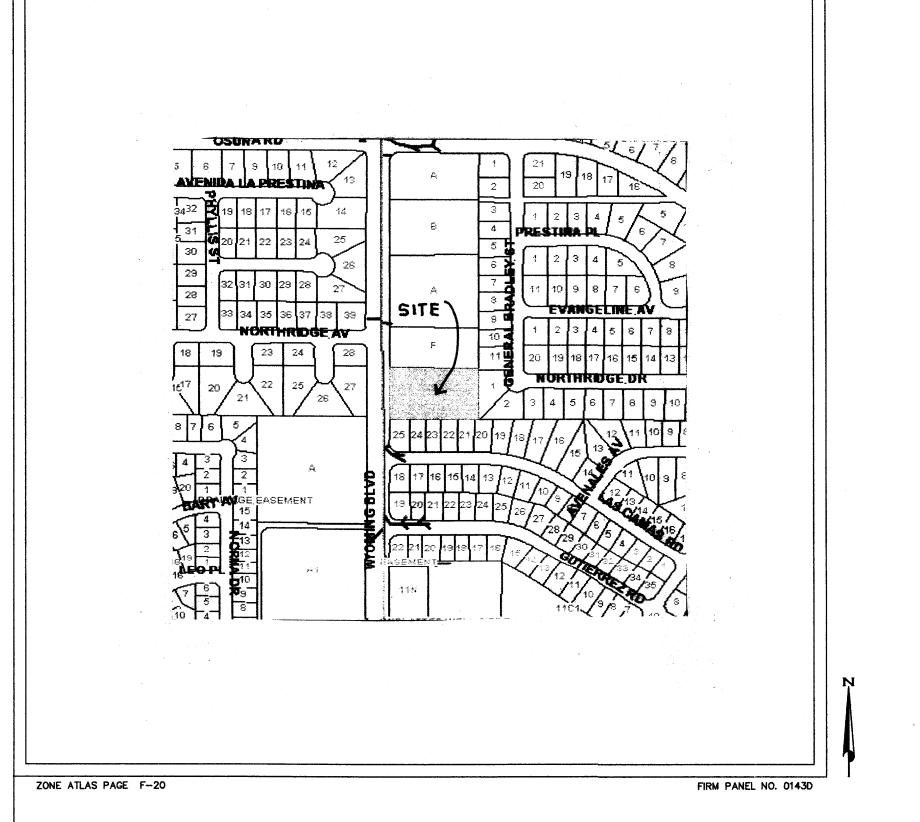
DATE: December 2, 2002 PLOT DATE: March 21, 2003 **REVISIONS:** FILE: SWSHTAI.DWG

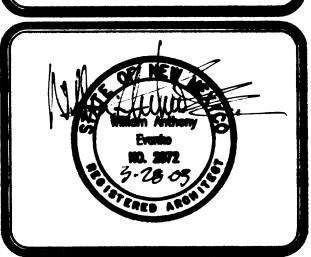

SITE PLAN

SHEET NO.

JOB NO. : 02-122 **OF**



GRADING/DRAINAGE PLAN

THE FOLLOWING ITEMS CONCERNING (4802 WYOMING BLVD. N.E.) LOT A EVANGELICAL COVENANT CHURCH ADDITION, BERNALILLO COUNTY, ALBUQUERQUE, NEW MEXICO ARE CONTAINED HEREON:

AS SHOWN BY THE VICINITY MAP, THE SITE CONTAINS 1.7463 ACRES AND IS LOCATED NORTH OF MONTGOMERY BLVD. N.E. AND EAST OF WYOMING BLVD. N.E. THE SITE CONTAINS A 4,237 SQ. FT. CHILDCARE CENTER ALONG WITH PAVED PARKING AND LANDSCAPED AREAS. EXISTING FLOW PATTERN IS FROM EAST TO WEST AND INTO WYOMING BLVD. N.E. ACCORDING TO THE FLOOD INSURANCE RATE MAP, PANEL 0143D, DATED SEPTEMBER 20, 1996, THE SITE IS NOT LOCATED WITHIN A DESIGNATED FLOOD ZONE.

PROPOSED CONDITIONS

AS SHOWN BY THE GRADING/DRAINAGE PLAN, THE PROJECT WILL CONSIST OF A PROPOSED 4000 SQ. FT. BUILDING ADDITION. THE NEW DEVELOPED RUN-OFF WILL BE ROUTED TOWARDS THE EXISTING PAVED PARKING AREA WEST OF THE PROPOSED BUILDING ADDITION. THERE ARE NO OFF-SITE FLOWS ENTERING FROM ANY DIRECTION. THE CALCULATIONS WHICH APPEAR HEREON, ANALYZE THE EXISTING AND PROPOSED CONDITIONS FOR THE SMALLER BASINS, AS SET FORTH IN THE REVISION OF SECTION 22.2 HYDROLOGY OF THE DEVELOPMENT PROCES MANUAL, VOLUME II DESIGN CRITERIA DATED 1997 HAS BEEN USED TO QUANTIFY THE PEAK RATE OF DISCHARGE AND VOLUME OF RUN-OFF GENERATED.

PROJECT AREA = 1.7463 ac. SOUTHWEST CHILDCARE ADDITION ZONE 3 PRECIPITATION: 360 = 2.60 in. 1440 = 3.1 in.

10day = 4.9 in.

EXCESS PRECIPITATION:

TREATMENT A 0.66 in. TREATMENT B 0.92 in. TREATMENT C 1.29 in. TREATMENT D 2.36 in.

2.6 cfs/ac. 3.45 cfs/ac. 5.02 cfs/ac.

EXISTING CONDITIONS: TREATMENT A 0 ac. TREATMENT B 0 ac. TREATMENT C 1.2484 ac.

AREA 0 ac. 0 ac. 1.1446 ac. 0.6017 ac.

PEAK DISCHARGE:

PROPOSED CONDITIONS:

1.87 cfs/ac.

EXISTING EXCESS PRECIPITATION:

TREATMENT D 0.4979 ac.

Weighted E =(0.66)x(0.00)+(0.92)x(0.00)+(1.29)x(1.25)+(2.36)x(0.50)/ 1.75 ac. = 1.60 in. V100-360 = (1.60)x(1.75)/12 = 0.232123 ac-ft = 10111 CF

EXISTING PEAK DISCHARGE:

Q100 = (1.87)x(0.00) + (2.60)x(0.00) + (3.45)x(1.25) + (5.02)x(0.50) = 6.81 CFSPROPOSED EXCESS PRECIPITATION:


Weighted E =(0.66)x(0.00)+(0.92)x(0.00)+(1.29)x(1.14)+(2.36)x(0.60)/ 1.75 ac. = 1.66 in. V100-360 = (1.66)x(1.75)/12.0 = 0.241379 ac-ft = 10514 CF

V100-1440 = (0.24)+(0.60)x(3.10-2.60)/12 = 0.266450 ac-ft = 11607 CF V100-10day = (0.24)+(0.60)x(4.90-2.60)/12 = 0.356705 ac-ft = 15538 CF

PROPOSED PEAK DISCHARGE: Q100 = $(1.87)x(0.00)+(2.60)x(0.00)+(3.45)x(1.14)+(5.02)x(0.60) \approx 6.97$ CFS INCREASE 6.97 CFS - 6.81 CFS = 0.16 CFS

EROSION CONTROL MEASURES

- 1. THE CONTRACTOR SHALL BE HELD RESPONSIBLE FOR MANAGEMENT OF STORM RUN-OFF DURING CONSTRUCTION, HE SHALL ASSURE THAT THE FOLLOWING MEASURES ARE TAKEN:
 - A. ADJACENT PROPERTY SHALL BE PROTECTED AT ALL TIMES BY TEMPORARY BERMS, DIKES. SWALES, AND OTHER TEMPORARY GRADING AS REQUIRED TO PREVENT STORM RUN-OFF FROM LEAVING THE SITE AND ENTERING ADJACENT PROPERTY.
 - B. ADJACENT PUBLIC RIGHT-OF-WAY SHALL BE PROTECTED AT ALL TIMES FROM STORM WATER RUN-OFF FROM THE SITE. NO SEDIMENT BEARING WATER SHALL BE PERMITTED TO ENTER THE PUBLIC STREETS.
- 2. THE CONTRACTOR SHALL IMMEDIATELY AND THOROUGHLY REMOVE ANY OR ALL SEDIMENT WITHIN THE PUBLIC STREETS THAT HAVE BEEN ERODED FROM THE SITE AND DEPOSITED THERE.

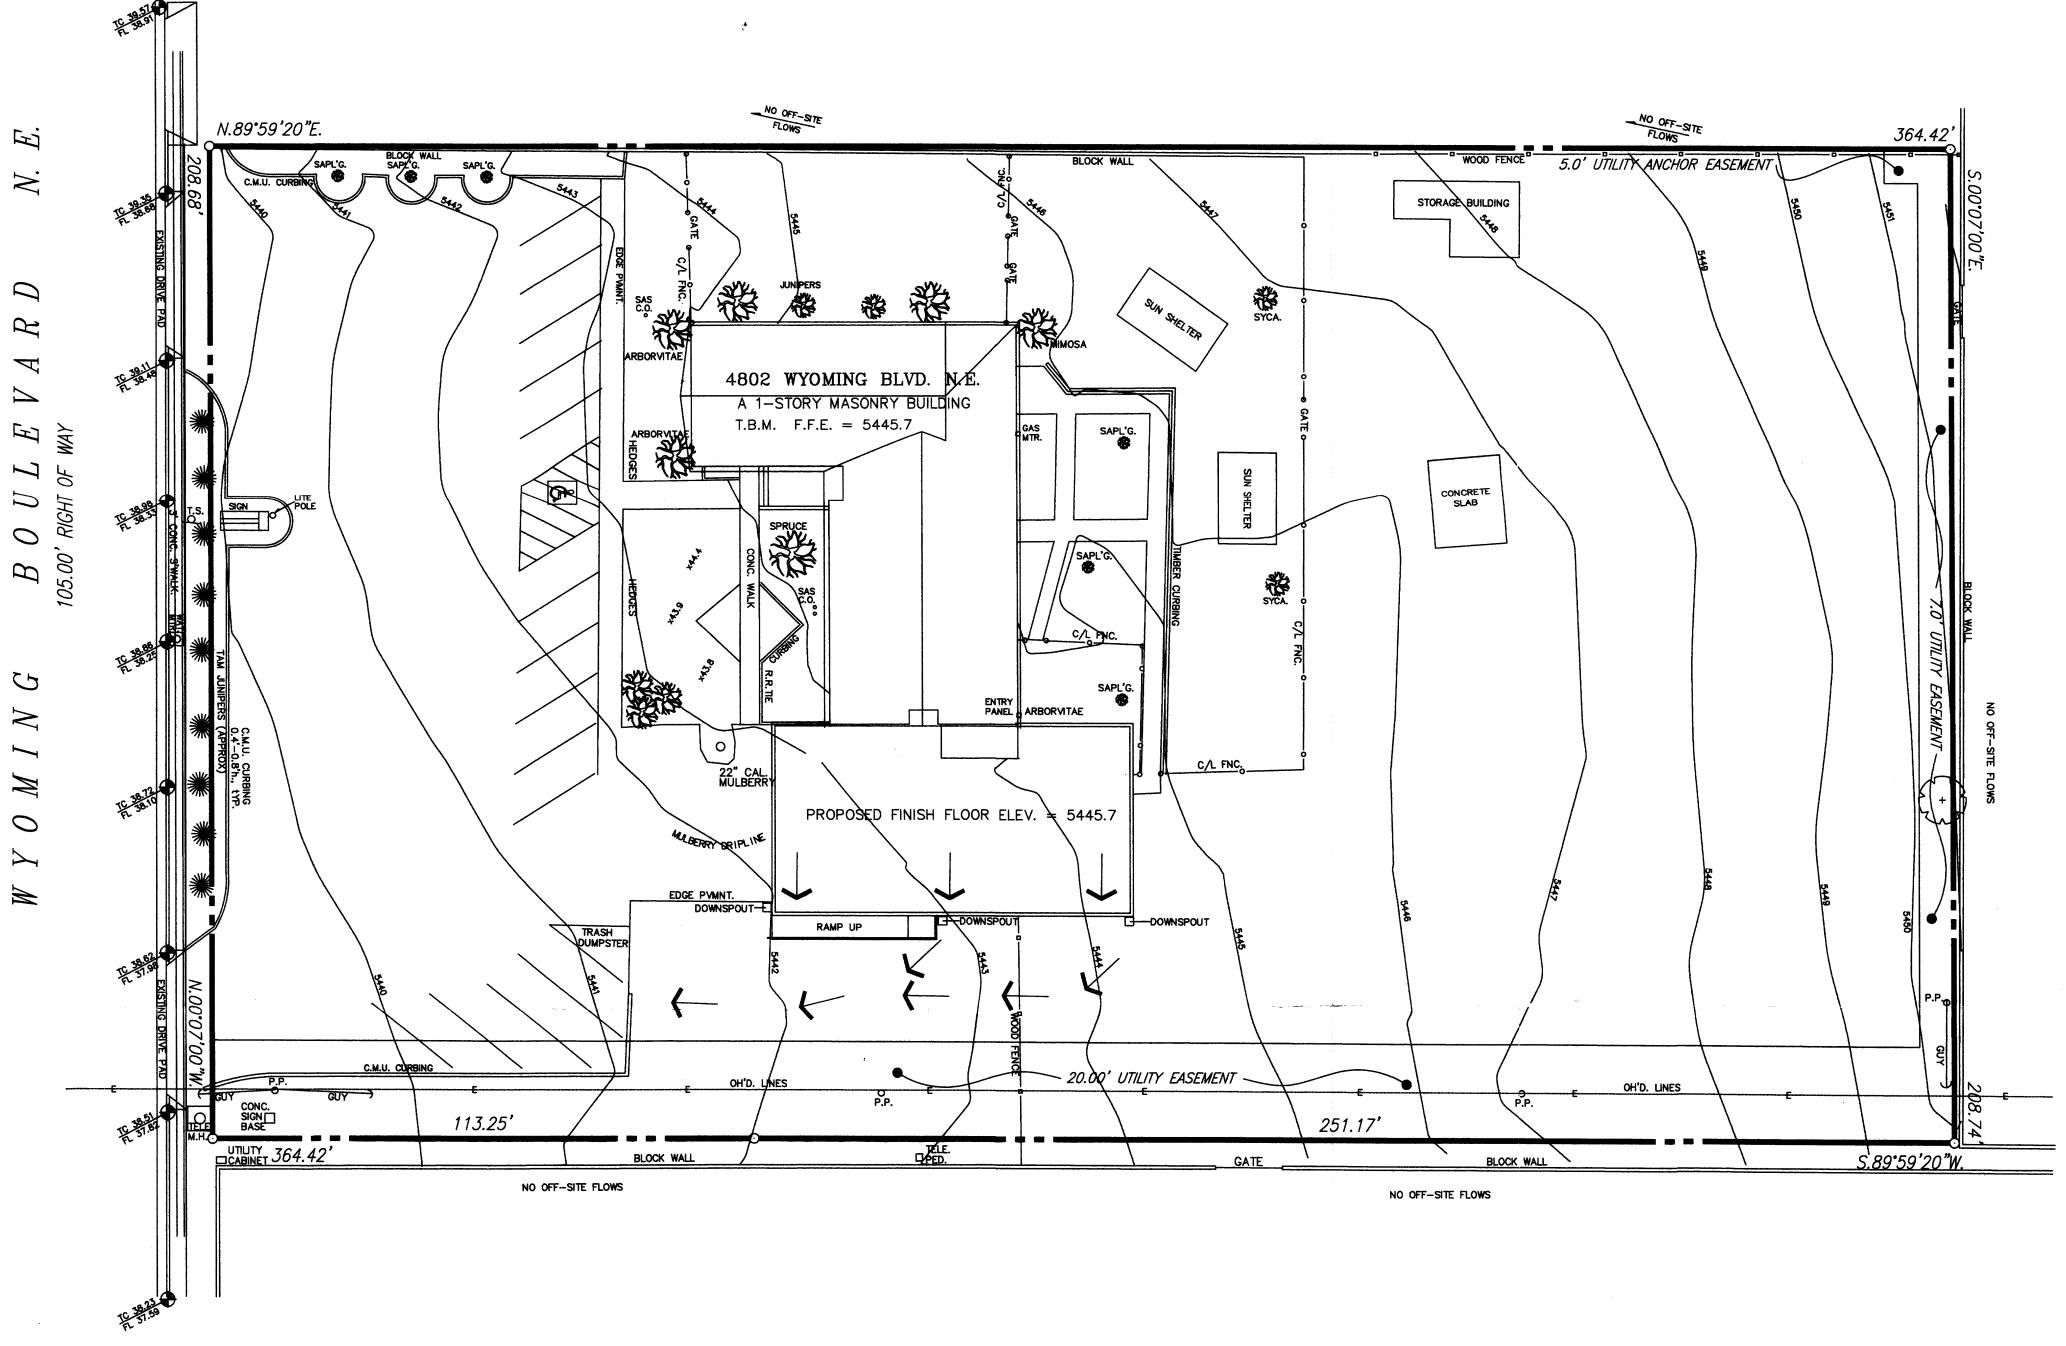

TRACT A OF THE EVANGELICAL COVENANT

CHURCH ADDITION, ALBUQUERQUE, NEW MEXICO

LEGAL DESRIPTION

1. An excavation/construction permit will be required before beginning any work within the City right-of-way. Approved copy of this plan SYMBOL LEGEND

EXISTING CONTOUR 2. All work detailed in this plan to be performed, except as otherwise stated or provided hereon, shall be constructed in accordance with City of Albuquerque Standard Specification for Public Works

3. Two working days prior to any excavation, contractor must contact line locating Services for locating existing utilities, (260-1990).

must be submitted at the time of application for permit.

4. Prior to construction, the contractor shall excavate and verify the horizonal and vertical location of all construction. Should a conflict exist, the contractor shall notify the engineer so that the conflict can be resolved with a minimum amount of delay.

5. Backfill compaction shall be according to Commercial use.

NOTICE TO CONTRACTOR

Construction.

- All work on this project shall be performed in accordance with applicable Federal, State and local laws, rules and regulations concerning construction safty and health.
- 7. Maintenance of this facilities shall be the responsibility of the owner of the property served.

----- 5450 -----

EXISTING SPOT ELEVATION DESIGNED SPOT ELEVATION PROPERTY LINE

EASEMENT LINE FLOW DIRECTION EXISTING SPOT ELEVATION \times 46.0

DOWN SPOUT ABBREVIATION LEGEND


TOP OF CON. PAD TOP OF CURB - TC TOP OF ASPHALT - TA FLOWLINE – FL TOP OF WALL TW'


GRADING/DRAINAGE PLAN 1'


SCALE: 1" = 20'

ONE FOOT CONTOUR INTERVAL

A.C.S. BENCHMARK REFERENCE: STA. '13-F19', AN ALUM. DISK AT THE NNW QUAD. OF WYOMING & MONTGOMERY. ELEV.=5431.700

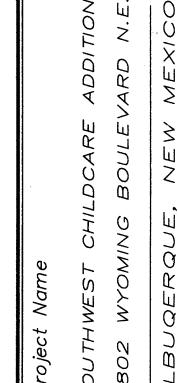

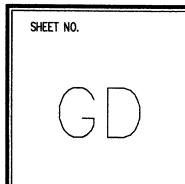

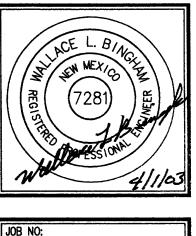

APRIL 2003 REVISIONS

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