
FRÉD C. ARFMAN, NMPE NO. 73

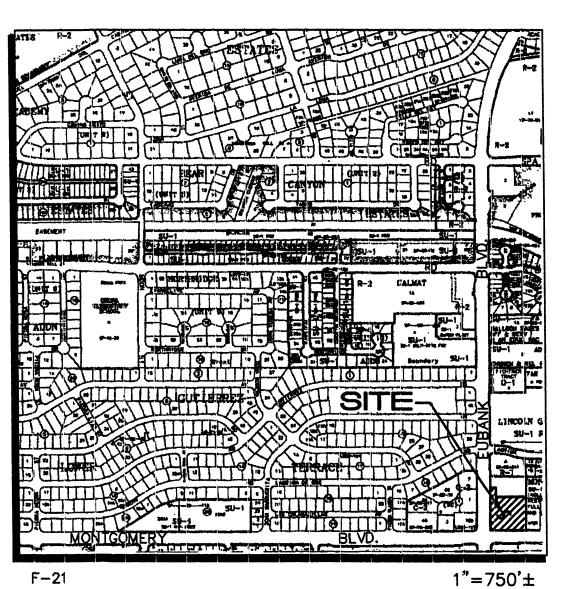

VICINITY MAP

PROPOSED CONDITION: THE EXISTING ONSITE IMPROVEMENTS ARE SCHEDULED TO BE "RAZE AND REBUILT" AS A 24,000 SQ. FT. RETAIL OPERATION WITH SUPPORT PARKING AND LANDSCAPING. A PRE CONFERENCE WITH THE CITY YIELDED THE FOLLOWING IN HANDLING THE STORM WATER

A QUALITATIVE APPROACH MAY BE APPROPRIATE TO JUSTIFY FREE DISCHARGE FOR THIS INFALL (REDEVELOPMENT) SITE. THE FOLLOWING ITEMS SHOULD BE ADDRESSED IN YOUR DRAINAGE PLAIN TO JUSTIFY FREE DISCHARGE:

- 1. THE SIGNIFICANCE OF THE INCREASED FLOWS FROM THIS DEVELOPMENT ON THE DOWNSTREAM SYSTEM.
- 2. ANY EXISTING DRAINAGE PROBLEMS? 3. ANY POTENTIAL PROBLEMS THAT MAY RESULT FROM THIS DEVELOPMENT.
- 4. THE SIZE OF THIS DEVELOPMENT TO THE OVERALL BASIN. 5. THE IMPACT ON DOWNSTREAM FLOOD PLAINS.

THE RESPONSE TO THE ABOVE FIVE ITEMS ARE FOUND IN A SUPPLEMENTAL SUBMITTAL TO THE DRAINAGE FILE.

THE SITE SHALL DIRECT ALL OF THE STORM WATER FLOWS TO THE SOUTHWEST CORNER (LOW POINT AT THE NE QUADRANT OF EUBANK AND MONTGOMERY BLVD...). THE STORM WATERS THEN ENTER INTO A PRIVATE CATCH BASIN IN A SUMP CONDITION WITH A 12" CONNECTOR PIPE TO THE BACK OF THE EXISTING CATCH BASIN AT THE CURB RETURN IN EUBANK BLVD. THIS SOLUTION SHALL HANDLE THE MINOR (NUISANCE) FLOWS AS WELL AS THE STORM WATERS GENERATED BY THE 100 YEAR STORM EVENT.

PROPOSED HYDROLOGY:

RUNOFF.

TOTAL SITE: 1.8543 AC.

PUBLIC R.O.W.

EXISTING LINES.

MINIMUM OF DELAY.

PROPERTY SERVED.

CONSTRUCTION NOTES

EXCEPT AS OTHERWISE STATED OR PROVIDED FOR HEREIN, BE CONSTRUCTED IN ACCORDANCE

SPECIFICATIONS PUBLIC WORKS CONSTRUCTION

EXCAVATION, CONTRACTOR SHALL CONTACT LINE

LOCATING SERVICE, 260-1990, FOR LOCATION OF

SHALL EXCAVATE AND VERIFY THE HORIZONTAL AND VERTICAL LOCATIONS OF ALL OBSTRUCTIONS.

SHOULD A CONFLICT EXIST, THE CONTRACTOR

4. BACKFILL COMPACTION SHALL BE ACCORDING TO

AN EXCAVATION/CONSTRUCTION PERMIT WILL BE

REQUIRED BEFORE BEGINNING ANY WORK WITHIN CITY RIGHT-OF-WAY. AN APPROVED COPY OF THESE PLANS MUST BE SUBMITTED AT THE TIME

SPECIFIED STREET USE (RESIDENTIAL).

OF APPLICATION FOR THIS PERMIT.

SHALL NOTIFY THE ENGINEER OR SURVEYOR SO THAT THE CONFLICT CAN BE RESOLVED WITH A

WITH "CITY OF ALBUQUERQUE STANDARD

3. PRIOR TO CONSTRUCTION, THE CONTRACTOR

2. TWO (2) WORKING DAYS PRIOR TO ANY

80,733 SQ. FT..

- LAND TREATMENT: B(5%), C(5%), D(90%)
- Qp = 1.85(0.90(5.25) + 0.05(3.73) + 0.05(2.92))= 9.4 CFS (INCREASE OF 0.6 CFS OVER THE PREVIOUS DEVELOPMENT)

THE HYDRAULIC CALCULATIONS FOR DETERMINING THE CAPACITY OF THE SINGLE "C" INLET IN A SUMP CONDITION AND THE CAPACITY OF THE 12" CONNECTOR PIPE IS FOUND IN THE SUPPLEMENTAL HYDROLOGICAL INFORMATION SUPPLIED AS PART OF THIS SUBMITTAL.

GENERAL NOTES

1. SEE SHEET #191 FOR DETAILS & SECTIONS

KEYED CONSTRUCTION NOTES ()


- 1. REMOVE & DISPOSE EXISTING PCC DRIVE PAD, 35 SY.
- 2. BUILD 6' PCC SIDEWALK, 25 SY.
- 3. CONSTRUCT 38 FT. OF COA STD C&G, COA DWG #2415.
- 4. REMOVE & DISPOSE 92 FT. PCC CURBING.
- 5. REMOVE & DISPOSE 31 LF STD C&G AND 27 SY PCC SIDEWALK.
- 6. CONSTRUCT REPLACEMENT PCC DRIVE PAD TO MATCH EXISTING DRIVE PAD TO THE NORTH.
- 7. REMOVE & DISPOSE 80 LF C&G AND 65 SY PCC SIDEWALK AND DRIVE PAD.
- 8. CONSTRUCT PCC FILLETS AND VALLEY GUTTER.
- 9. CONSTRUCT WHEELCHAIR RAMP(S) PER PLAN.

APPROVALS	NAME		DATE
HYDROLOGY			
INSPECTOR			
A.C.E./FIELD			
PERMIT NO.		MAP NO.	
			F-21

architecture interiors planning engineering

> 6801 Jefferson NE Suite 100 Albuquerque, NM 87109 fax 761-4222 dps @ dpsabq.com

engineer

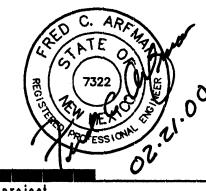

plotted:

drawn by reviewed by

drawing name


date


12/08/99 project no. 99046

GRADING & DRAINAGE PLAN "ISSUED FOR

sheet no. C101

CONSTRUCTION"

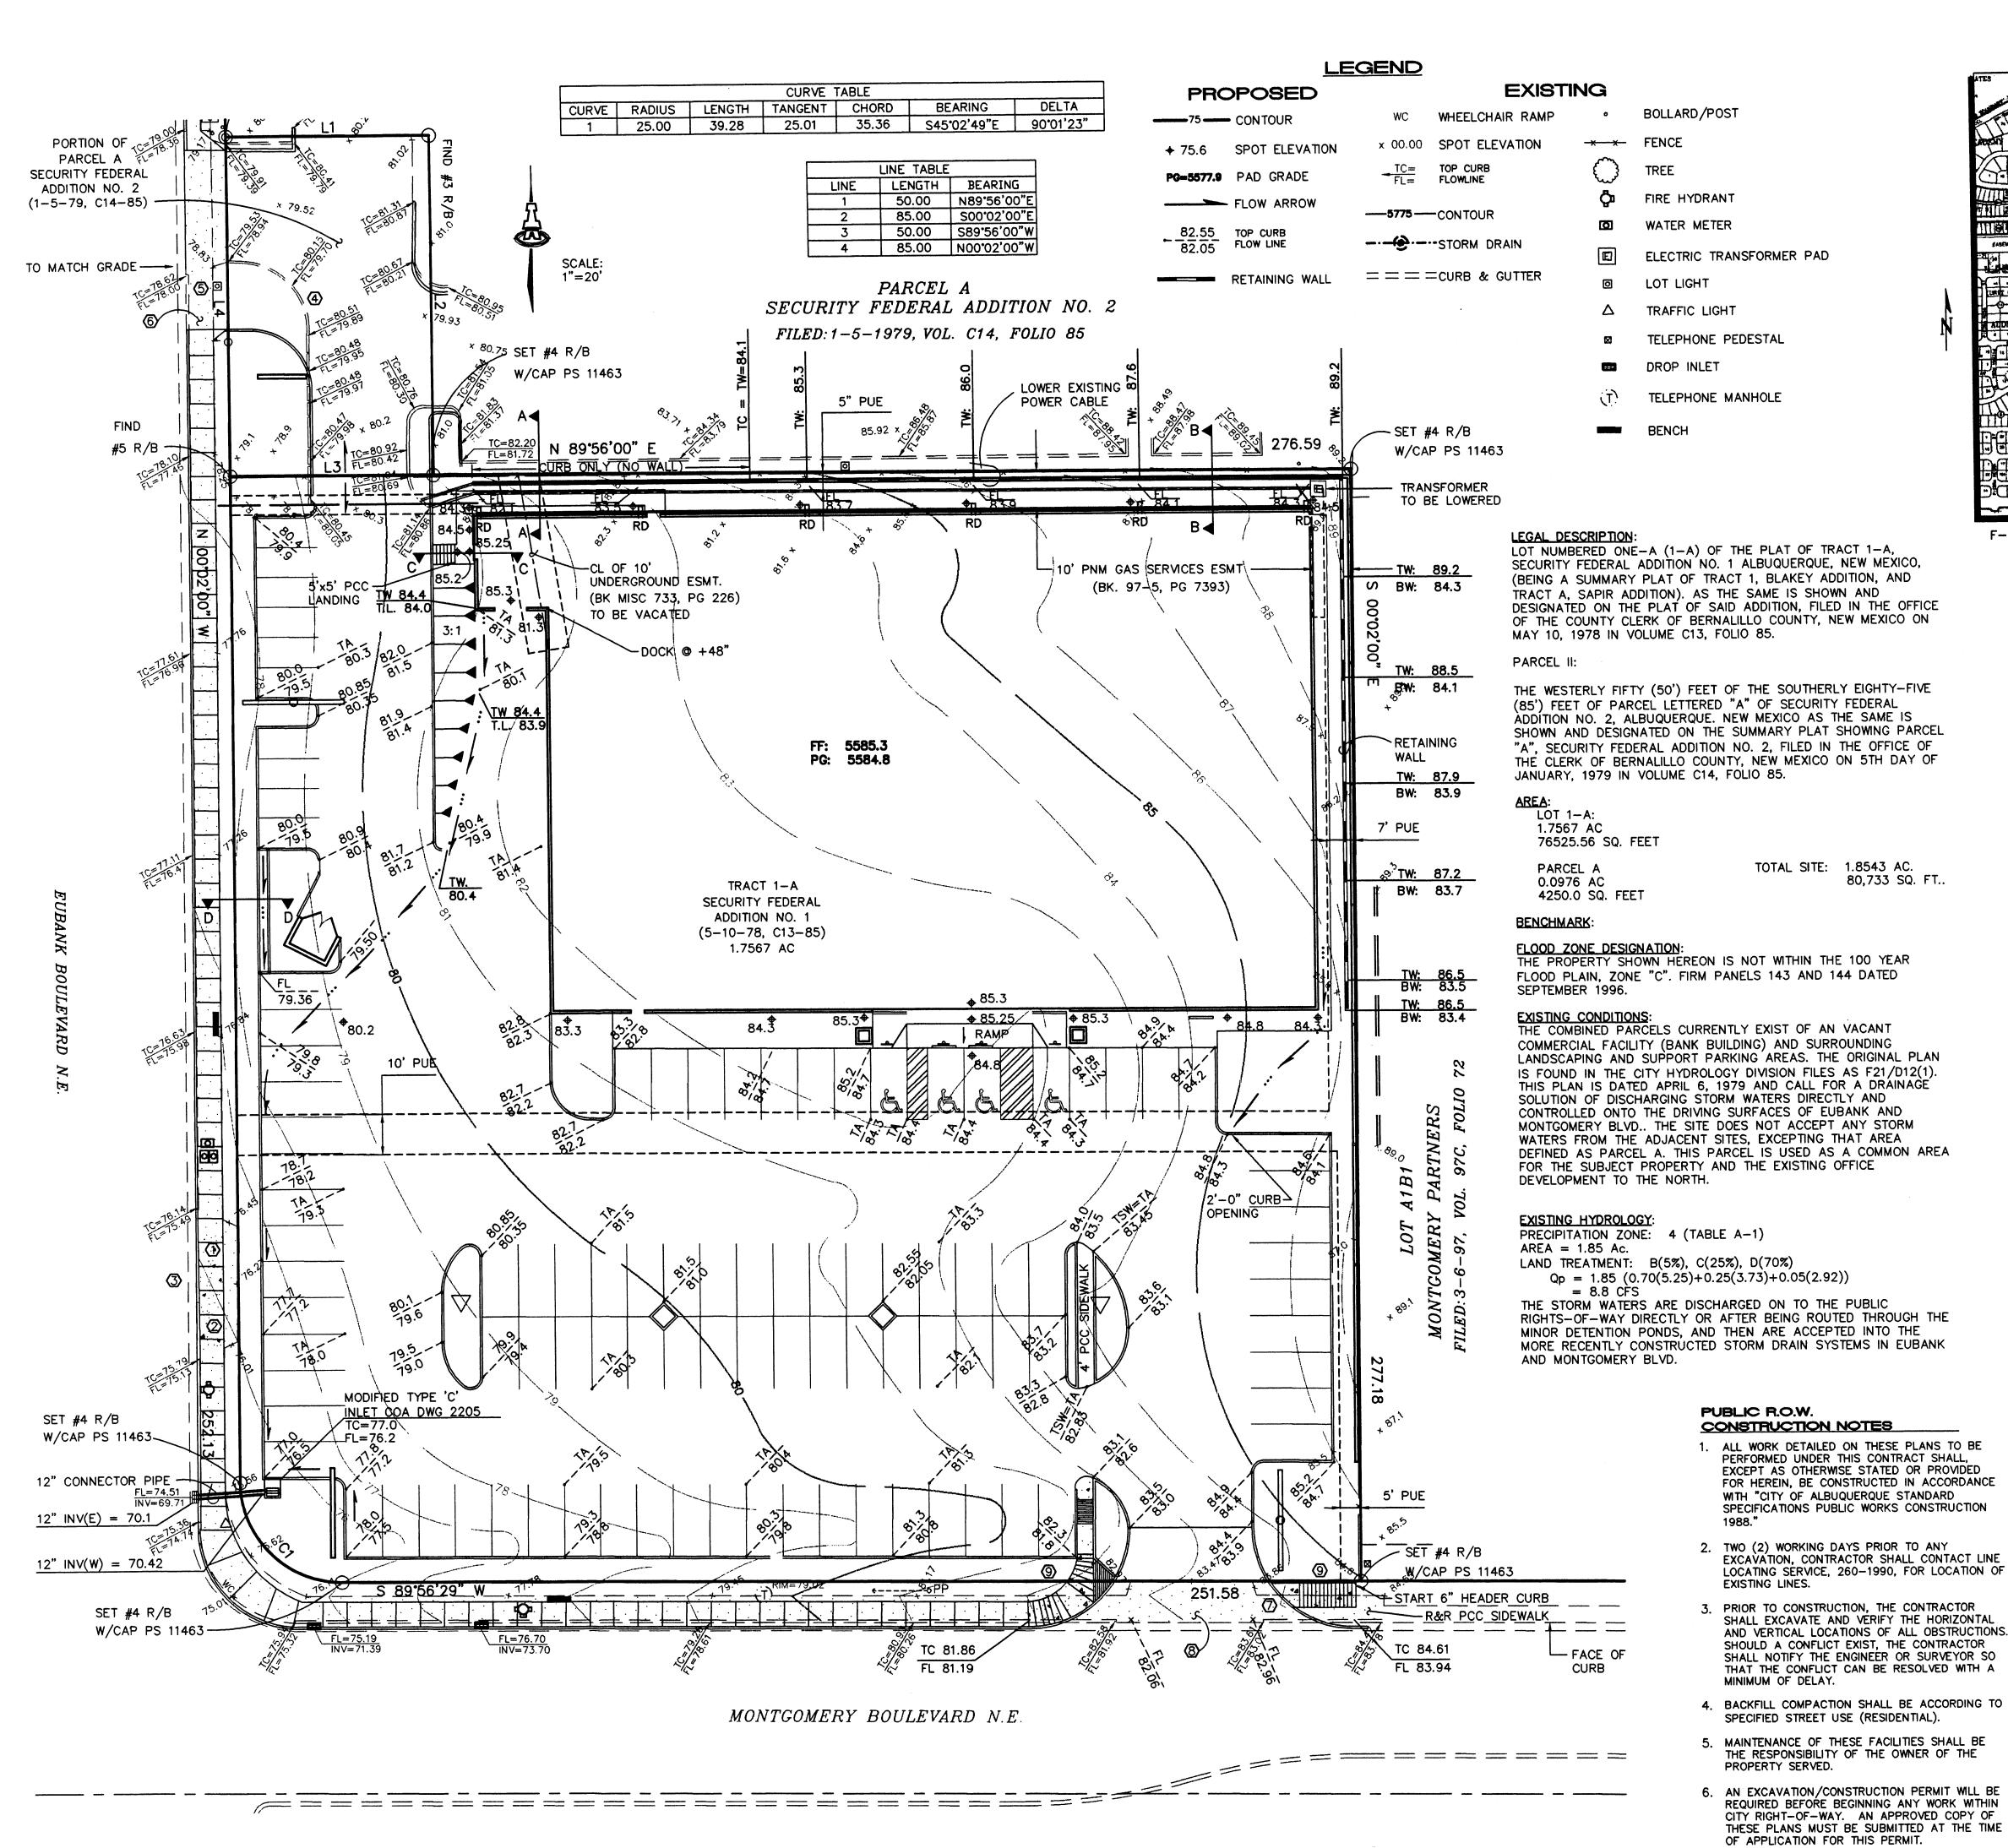

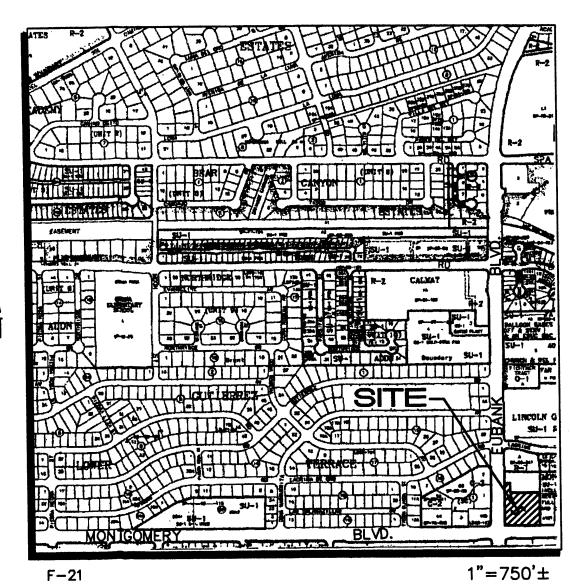

VICINITY MAP

PROPOSED CONDITION: THE EXISTING ONSITE IMPROVEMENTS ARE SCHEDULED TO BE "RAZE AND REBUILT" AS A 24,000 SQ. FT. RETAIL OPERATION WITH SUPPORT PARKING AND LANDSCAPING. A PRE CONFERENCE WITH THE CITY YIELDED THE FOLLOWING IN HANDLING THE STORM WATER RUNOFF.

A QUALITATIVE APPROACH MAY BE APPROPRIATE TO JUSTIFY FREE DISCHARGE FOR THIS INFALL (REDEVELOPMENT) SITE. THE FOLLOWING ITEMS SHOULD BE ADDRESSED IN YOUR DRAINAGE PLAIN TO JUSTIFY FREE DISCHARGE:

- 1. THE SIGNIFICANCE OF THE INCREASED FLOWS FROM THIS DEVELOPMENT ON THE DOWNSTREAM SYSTEM.
- 2. ANY EXISTING DRAINAGE PROBLEMS? 3. ANY POTENTIAL PROBLEMS THAT MAY RESULT FROM THIS
- DEVELOPMENT. 4. THE SIZE OF THIS DEVELOPMENT TO THE OVERALL BASIN. 5. THE IMPACT ON DOWNSTREAM FLOOD PLAINS.
- THE RESPONSE TO THE ABOVE FIVE ITEMS ARE FOUND IN A SUPPLEMENTAL SUBMITTAL TO THE DRAINAGE FILE.

THE SITE SHALL DIRECT ALL OF THE STORM WATER FLOWS TO THE SOUTHWEST CORNER (LOW POINT AT THE NE QUADRANT OF EUBANK AND MONTGOMERY BLVD ..). THE STORM WATERS THEN ENTER INTO A PRIVATE CATCH BASIN IN A SUMP CONDITION WITH A 12" CONNECTOR PIPE TO THE BACK OF THE EXISTING CATCH BASIN AT THE CURB RETURN IN EUBANK BLVD. THIS SOLUTION SHALL HANDLE THE MINOR (NUISANCE) FLOWS AS WELL AS THE STORM WATERS GENERATED BY THE 100 YEAR STORM EVENT.

PROPOSED HYDROLOGY:

TOTAL SITE: 1.8543 AC.

80,733 SQ. FT..

LAND TREATMENT: B(5%), C(5%), D(90%)

Qp = 1.85(0.90(5.25)+0.05(3.73)+0.05(2.92))= 9.4 CFS (INCREASE OF 0.6 CFS OVER THE PREVIOUS

DEVELOPMENT) THE HYDRAULIC CALCULATIONS FOR DETERMINING THE CAPACITY OF THE SINGLE "C" INLET IN A SUMP CONDITION AND THE CAPACITY OF THE 12" CONNECTOR PIPE IS FOUND IN THE SUPPLEMENTAL HYDROLOGICAL INFORMATION SUPPLIED AS PART OF THIS SUBMITTAL.

GENERAL NOTES

1. SEE SHEET #191 FOR DETAILS & SECTIONS

KEYED CONSTRUCTION NOTES (

- 1. REMOVE & DISPOSE EXISTING PCC DRIVE PAD, 35 SY.
- 2. BUILD 6' PCC SIDEWALK, 213 SY.
- 3. CONSTRUCT 32 FT. OF COA STD C&G, COA DWG #2415.
- 4. REMOVE & DISPOSE 45 FT. PCC CURBING.
- 5. REMOVE & DISPOSE 31 LF STD C&G AND 21 SY PCC SIDEWALK.
- 6. CONSTRUCT REPLACEMENT PCC DRIVE PAD TO MATCH EXISTING DRIVE PAD TO THE NORTH.
- 7. REMOVE & DISPOSE 80 LF C&G AND 65 SY PCC SIDEWALK AND DRIVE PAD.
- 8. CONSTRUCT PCC FILLETS AND VALLEY GUTTER.
- 9. CONSTRUCT WHEELCHAIR RAMP(S) PER PLAN.

PERMIT NO.		MAP NO.	F-21
	<u> </u>	MAP NO.	<u> </u>
A.C.E./FIELD			
INSPECTOR			
HYDROLOGY			
APPROVALS	NAME		DATE




6801 Jefferson NE Suite 100 Albuquerque, NM 87109 505 761-9700 fax 761-4222 dps@dpsabq.com

engineer



project

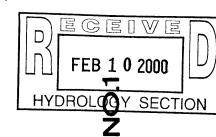

	Ø		
revisions			
\triangle			
\triangle			
\triangle			
plotted:			
drawn by			

GRADING & DRAINAGE PLAN

12/08/99

99046

sheet no. C101


reviewed by

project no.

drawing name

date

066GRD.DWGrfh 2/9/00

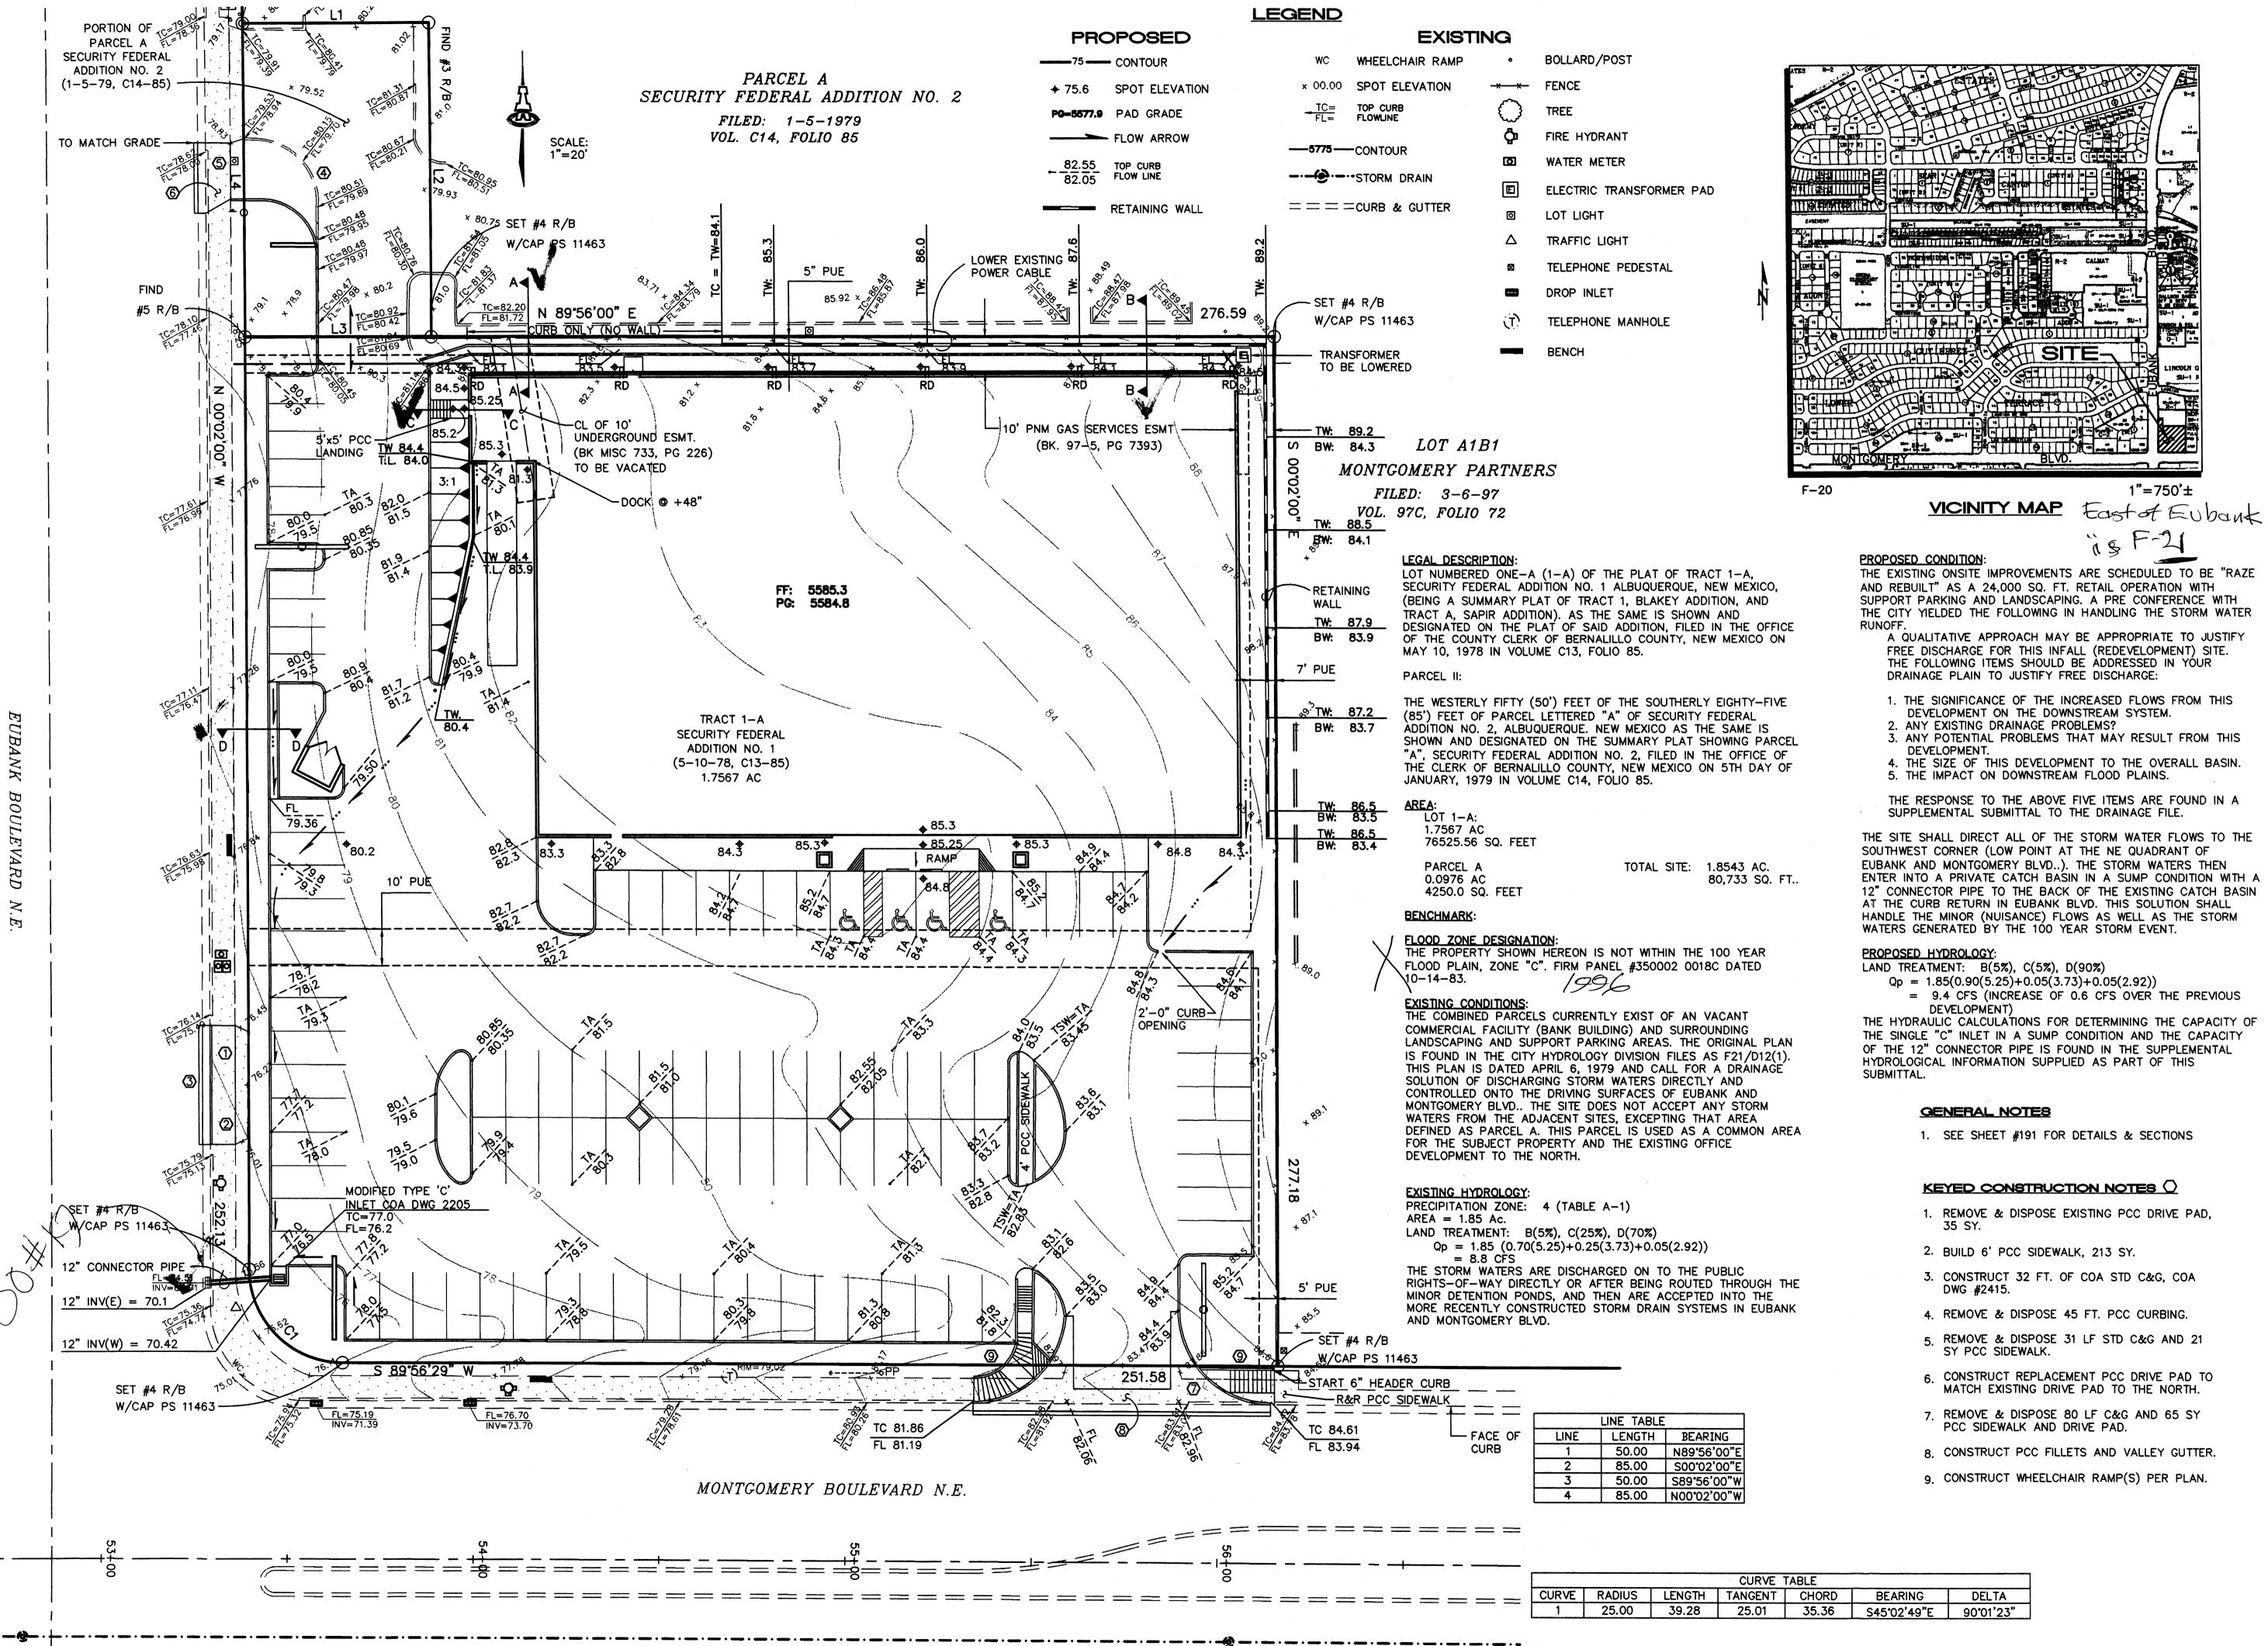


architecture

interiors planning engineering

6801 Jefferson NE Suite 100 Albuquerque, NM 87109 505 761-9700 fax 761-4222 dps@dpsabq.com

architect

engineer

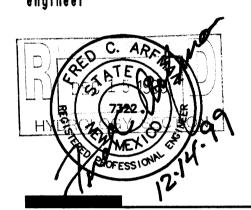

THE SITE SHALL DIRECT ALL OF THE STORM WATER FLOWS TO THE ENTER INTO A PRIVATE CATCH BASIN IN A SUMP CONDITION WITH A 12" CONNECTOR PIPE TO THE BACK OF THE EXISTING CATCH BASIN

GRADING & DRAINAGE PLAN

12/08/99

99046

sheet no. C101

revisions

plotted:

date

drawn by


reviewed by

project no.


drawing name

066GRD.DWGrfh 12/14/99


SECTION A-A

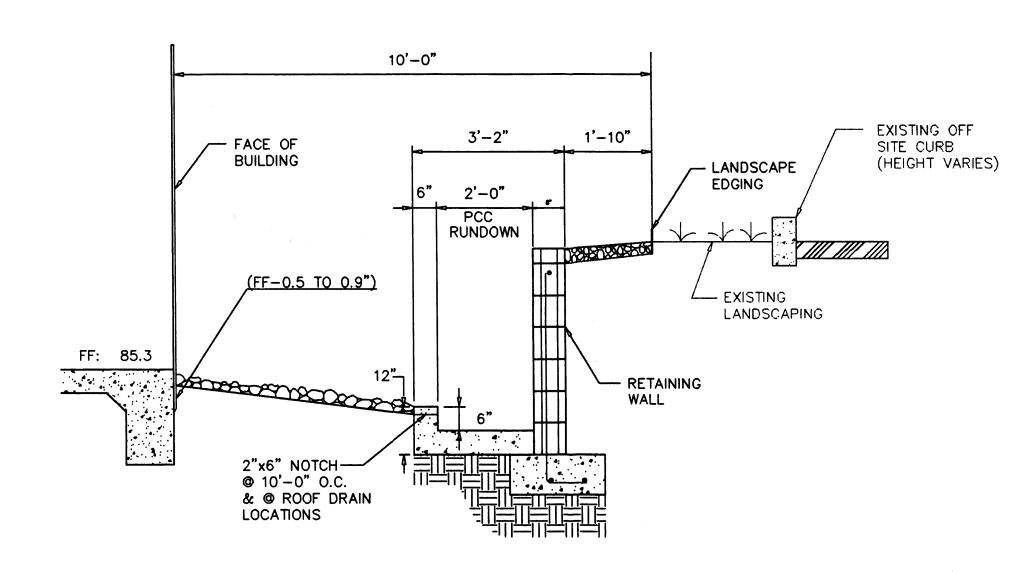

SECTION B-B 1"=2'-0" (H&V)

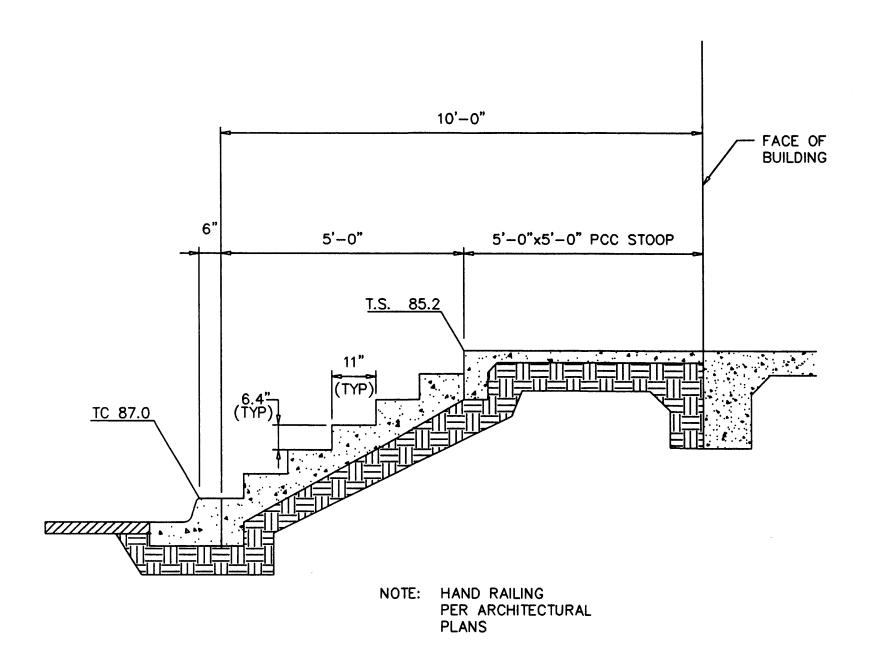

SECTION C-C

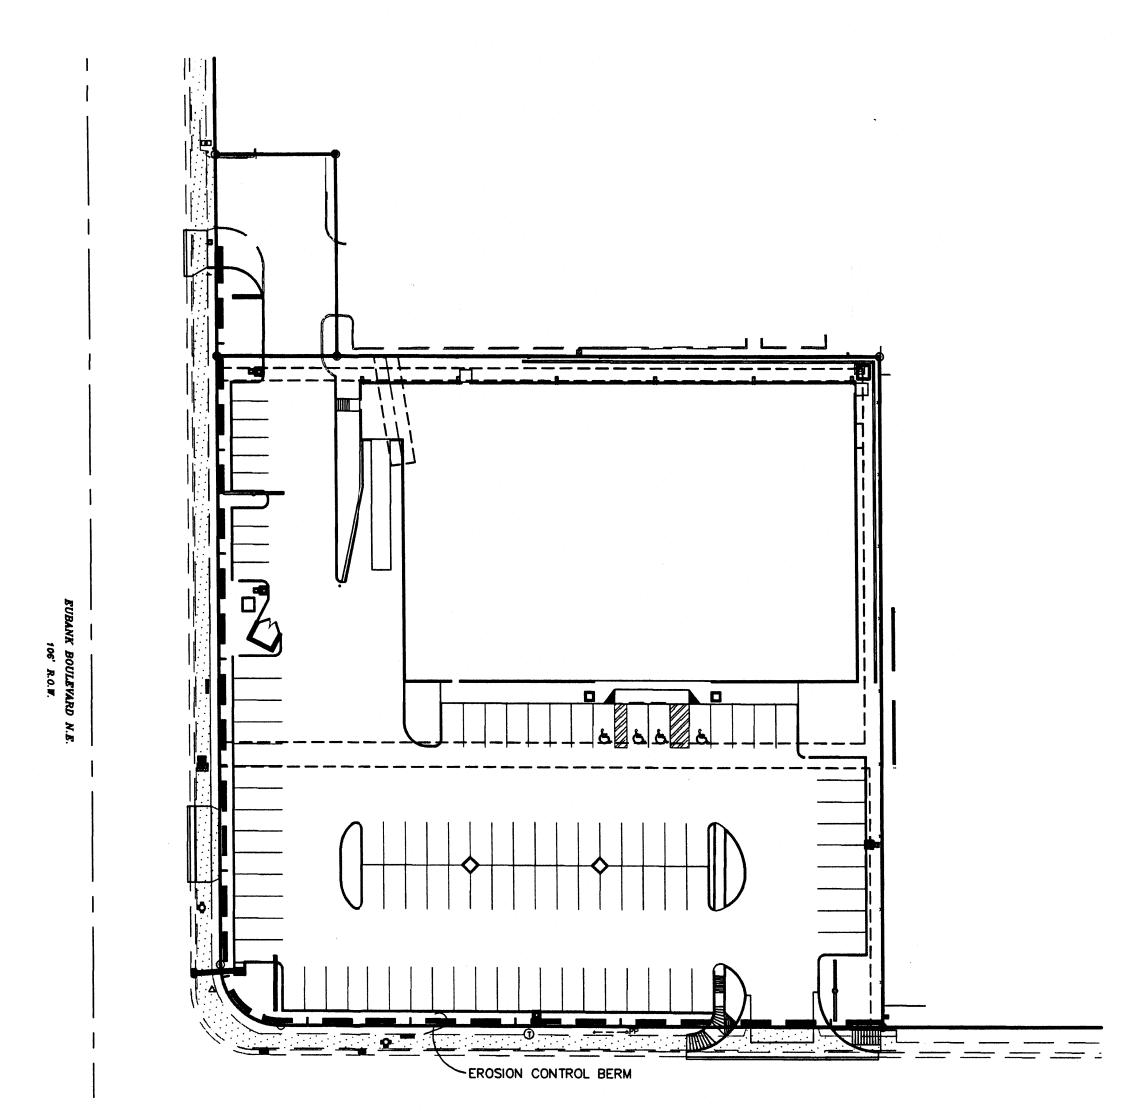

EROSION CONTROL BERM PLAN


SCALE: 1"=100"

EXISTING GROUND - CONSTRUCT & MAINTAIN BERM AS SHOWN ON THE GRADING PLAN.

EROSION CONTROL BERM SCALE: 1"=2"

EROSION CONTROL

- 1. THE CONTRACTOR SHALL ENSURE THAT NO SOIL ERODES FROM THE SITE INTO THE PUBLIC RIGHT-OF-WAY OR ONTO PRIVATE PROPERTY. THIS CAN BE ACHIEVED BY CONSTRUCTING EROSION CONTROL BERMS (AS DETAILED AT RIGHT) AS SHOWN ON THE PLAN AND WETTING THE SOIL TO KEEP IT FROM BLOWING.
- 2. THE CONTRACTOR SHALL SECURE "TOPSOIL DISTURBANCE PERMIT" FROM THE CITY ENVIRONMENTAL HEALTH DEPARTMENT PRIOR TO BEGINNING CON-STRUCTION. AN EXCAVATION PERMIT IS REQUIRED FOR ALL WORK WITHIN PUBLIC RIGHT-OF-WAY.
- 3. SEE GRADING NOTES.

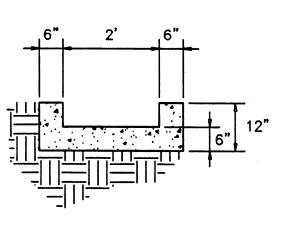

SECTION D-D 1"=2'-0" (H&V)

RESTRAINED JOINT LENGTHS FOR WATERLINE FITTINGS

RESTRAINED JOINT LENGTHS, LT FOR HORIZONTAL BENDS, VALVES, AND DEAD ENDS, (FT.) HORZ. BENDS 45' | 22 1/2' | 11 1/4'

THIS TABLE IS BASED UPON THE FOLLOWING CRITERIA:

DEPTH OF BURY 3.0 FT. MINIMUM FACTOR OF SAFETY 1.25 MATERIAL

GM/SM - SILTY GRAVELS AND SILTY SANDS,

SOIL TYPE: GRAVEL-SAND-SILT MIXTURES. PIPE BEDDED IN SAND, GRAVEL, OR CRUSHED

TEST PRESSURE TRENCH TYPE 4:


STONE TO DEPTH OF 1/8 PIPE DIAMETER, 4 INCH MINIMUM; BACKFILL COMPACTED TO TOP OF PIPE. DIFFERENT CRITERIA, E.G., DUCTILE IRON PIPE, GREATER DEPTH OF BURY,

ETC., WILL REQUIRE DIFFERENT RESTRAINED LENGTHS. THESE MUST BE CALCULATED BY A QUALIFIED PROFESSIONAL ENGINEER AND APPROVED BY THE PUBLIC WORKS DEPARTMENT.

VALVES & **ENDS**

engineer

architect

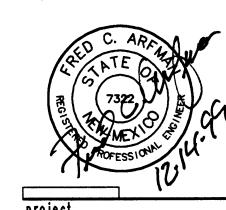

architecture

engineering

6801 Jefferson NE

505 761-9700

fax 761-4222 dps@dpsabq.com

Albuquerque, NM 87109

Suite 100

interiors

revisions

plotted:

drawn by reviewed by

date 12/09/99 project no. 99046 drawing name

GRADING & DRAINAGE

sheet no. C191

DETAILS

GRADING NOTES:

- 1. ALL TRASH, DEBRIS, & SURFACE VEGETATION SHALL BE CLEARED AND LEGALLY DISPOSED OFFSITE.
- 2. ALL SUBGRADE AND FILL SHALL BE COMPACTED TO A MINIMUM OF 90% ASTM D-1557.
- 3. EXCAVATION IS UNCLASSIFIED AND INCLUDES EXCAVATION TO SUBGRADE ELEVATIONS INDICATED, REGARDLESS OF CHARACTER OF MATERIALS ENCOUNTERED.
- 4. CONFORM TO ELEVATIONS AND DIMENSIONS SHOWN ON PLANS WITHIN A TOLERANCE OF 0.3± FEET.
- 5. SCARIFY AND COMPACT SUBGRADE FOR FILLS. PLACE FILL MATERIALS IN LAYERS NOT MORE THAN 8" IN LOOSE DEPTH. MOISTEN AS NECESSARY TO PROVIDE OPTIMUM MOISTURE (±2%) CONTENT.
- 6. UNIFORMLY GRADE AREAS WITHIN LIMITS OF GRADING AS SHOWN ON PLAN. SMOOTH FINISHED SURFACE WITHIN SPECIFIED TOLERANCE, COMPACT WITH UNIFORM SLOPES BETWEEN POINTS WHERE ELEVATIONS ARE INDICATED.
- 7. MAXIMUM SLOPES SHALL BE 3:1 MINIMUM SLOPES SHALL BE 1%.
- 8. TWO (2) WORKING DAYS PRIOR TO ANY EXCAVATION, CONTRACTOR MUST CONTACT NEW MEXICO ONE CALL SYSTEM, 260-1990, FOR LOCATION OF EXISTING UTILITIES.
- 9. IF ANY UTILITY LINES, PIPELINES, OR UNDERGROUND UTILITY LINES ARE SHOWN ON THESE DRAWINGS, THEY ARE SHOWN IN AN APPROXIMATE MANNER ONLY, AND SUCH LINES MAY EXIST WHERE NONE ARE SHOWN. IF ANY SUCH EXISTING LINES ARE SHOWN, THE LOCATION IS BASED UPON INFORMATION PROVIDED BY THE OWNER OF SAID UTILITY, AND THE INFORMATION MAY BE INCOMPLETE, OR MAY BE OBSOLETE BY THE TIME CONSTRUCTION COMMENCES. THE ENGINEER HAS CONDUCTED ONLY PRELIMINARY INVESTIGATION OF THE LOCATION, DEPTH, SIZE OR TYPE OF EXISTING UTILITY LINES, PIPELINES, OR UNDERGROUND UTILITY LINES. THIS INVESTIGATIONS IS NOT CONCLUSIVE, AND MAY NOT BE COMPLETE, THEREFORE, MAKES NO REPRESENTATION PERTAINING THERETO, AND ASSUMES NO RESPONSIBILITY OR LIABILITY THEREFORE. THE CONTRACTOR SHALL INFORM ITSELF OF THE LOCATION OF ANY UTILITY LINE, PIPELINE, OR UNDERGROUND UTILITY LINE IN OR NEAR THE AREA OF THE WORK IN ADVANCE OF AND DURING EXCAVATION WORK. THE CONTRACTOR IS FULLY RESPONSIBLE FOR ANY AND ALL DAMAGE CAUSED BY ITS FAILURE TO LOCATE, IDENTIFY AND PRESERVE ANY AND ALL EXISTING UTILITIES, PIPELINES, AND UNDERGROUND UTILITY LINES. IN PLANNING AND CONDUCTING EXCAVATION, THE CONTRACTOR SHALL COMPLY WITH STATE STATUES, MUNICIPAL AND LOCAL ORDINANCES, RULES AND REGULATIONS, IF ANY, PERTAINING TO THE LOCATION OF THESE LINES AND FACILITIES.
- 10. THE CONTRACTOR SHALL PROMPTLY CLEAN UP ANY MATERIAL EXCAVATED WITHIN THE PUBLIC RIGHT-OF-WAY SO THAT THE EXCAVATED MATERIAL IS NOT ERODED AND WASHED DOWN THE STREET.
- 11. OWNER WILL PROVIDE SOIL TESTING AND INSPECTION SERVICES DURING EARTHWORK OPERATIONS. ALLOW TESTING SERVICE TO INSPECT AND APPROVE COMPACTED SUBGRADES AND FILL LAYERS BEFORE FURTHER CONSTRUCTION WORK IS DONE. SHALL COMPACTION TESTS INDICATE INADEQUATE DENSITY, CONTRACTOR SHALL PROVIDE ADDITIONAL COMPACTION AND TESTING AT NO ADDITIONAL EXPENSE.
- 12. OWNER HAS ESTABLISHED SUBDIVISION BOUNDARY CORNERS. CONTRACTOR SHALL PROVIDE ALL OTHER CONSTRUCTION STAKING INCLUDING TRACT CORNERS. CONTRACTOR SHALL LOCATE AND PRESERVE ALL BOUNDARY CORNERS AND REPLACE ANY LOST OR DISTURBED CORNERS.