
SEQUOIA APARTMENTS


TEMPORARY SEDIMENT AND EROSION CONTROL DRAWINGS

ALBUQUERQUE, BERNALILLO COUNTY, NEW MEXICO

DRAWING INDEX

- 1 COVER SHEET
- 2 PROJECT DETAILS
- **3 GENERAL NOTES**
- **4 BEST MANAGEMENT PRACTICES**
- **5 BEST MANAGEMENT PRACTICES**
- 6 BEST MANAGEMENT PRACTICES 7 BEST MANAGEMENT PRACTICES
- 8 TEMPORARY EROSION & SEDIMENT CONTROL PLAN
- 9 FINAL STABILIZATION
- **LANDSCAPING PLAN (BY OTHERS)**

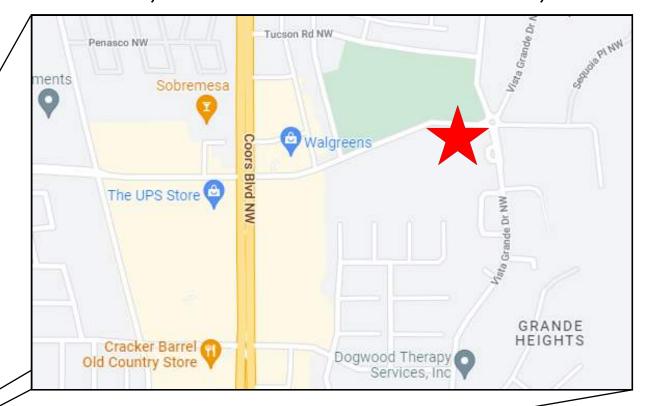

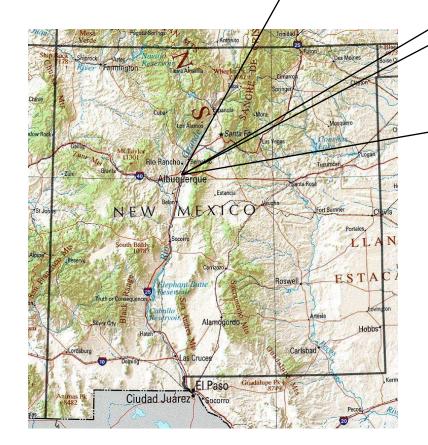








SWPPP
Stormwater
Erosion Control
Reclamation
Seeding

www.e2rc.com | 505.867.4040

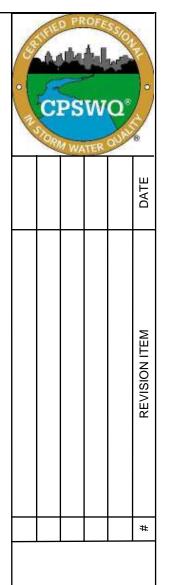

SEQUOIA APARTMENTS ALBUQUERQUE, NM

DESIGNED BY:
K. FETTER, P.E.
DRAWN BY:

S. FETTER
SHEET:

COVER

PROJECT DETAILS

NPDES ID: NMR1005BW

ADDRESS: 5100 SEQUOIA DRIVE NW, ALBUQUERQUE, NM 87120

GPS COORDINATES: 35.121782, -106.697133

TOTAL ACREAGE: 1.2

ANTICIPATED DISTURBED ACREAGE: 1.2

FIRST RECEIVING WATER: RIO GRANDE (NM-2105_51)

WATERS WITHIN ONE MILE OF PROJECT: RIO GRANDE

IMPAIRED/TIERED WATERS: RIO GRANDE

ENDANGERED SPECIES: CRITERION C

SUPPORT ACTIVITIES: SEE SECTION 3.6 OF SWPPP NARRATIVE

SOIL TYPE: SEE NRCS SOIL REPORT PROVIDED IN SWPPP BINDER

TYPE PRE-CONSTRUCTION COVER: NATIVE VEGETATION, APPROXIMATELY 80% DENSITY

STABILIZATION MEASURES AND DEADLINES: SEE SECTION 6.0 OF SWPPP NARRATIVE

REGULATING AUTHORITY: ENVIRONMENTAL PROTECTION AGENCY (EPA)

OPERATORS

PROPERTY OWNER: ESMAIL HAIDARI 12008 GAZELLE PL. NE ALBUQUERQUE, NM 87111

OWNER CONTACT: ESMAIL HAIDARI (505) 250-6088

GENERAL CONTRACTOR (GC):

GC CONTACT:

STORMWATER TEAM

SEE SECTION 2.0 OF THE SWPPP NARRATIVE FOR THE PROJECT'S STORMWATER TEAM, RESPONSIBILITIES AND CONTACT INFORMATION

SEQUENCE OF ACTIVITIES

REFER TO THE ANTICIPATED CONSTRUCTION SCHEDULE INCLUDED WITH THE SWPPP BINDER

PHASE I: SITE PREPARATION AND PRE - CONSTRUCTION

1.PRIOR TO BEGINNING EARTH DISTURBING ACTIVITIES, THE OPERATOR(S) WILL CLEARLY DEMARCATE THE LIMITS OF DISTURBANCE WITH STAKES, RIBBONS, CONSTRUCTION FENCING, OR OTHER APPROPRIATE METHOD. THESE DEMARCATIONS SHALL REMAIN VISIBLE FOR THE DURATION OF THE PROJECT.

2.THE INITIAL EROSION CONTROL MEASURES SHALL BE INSTALLED PRIOR TO EARTH DISTURBANCE. THE INITIAL CONTROL MEASURES MAY INCLUDE BUT ARE NOT LIMITED TO:

a.PERIMETER CONTROLS (E.G., SILT FENCE, WATTLES, CONSTRUCTION FENCE)
b.VEHICLE TRACKING PAD IF THE SITE ENTERS/EXITS ONTO A PAVED PUBLIC ROADWAY
c.NPDES NOTIFICATION POSTING
d.DESIGNATED STAGING AREA
e.ANCHORED SANILETS
f.DUMPSTERS

PHASE II: CONSTRUCTION ACTIVITIES

1.THE OPERATORS WILL MINIMIZE THE AREA DISTURBED AS MUCH AS FEASIBLY POSSIBLE.

2.ANY DISTURBED AREA IN WHICH CONSTRUCTION ACTIVITIES HAVE TEMPORARILY CEASED SHALL TEMPORARILY STABILIZED USING THE METHODS DESCRIBED IN SECTION 6.4 OF THE SWPPP NARRATIVE. SECTION 6.3 OF THE SWPPP NARRATIVE PROVIDES THE TEMPORARY STABILIZATION DEADLINES.

3.THE LOCATION OF SOME BMPS MAY REQUIRE ALTERATION IF DRAINAGE PATTERNS CHANGE DURING CONSTRUCTION. THE OPERATORS SHALL INSTALL ADDITIONAL BMPS OR UPGRADE BMPS IF NECESSARY.

4.IF CONCRETE IS USED ONSITE AND CONCRETE TRUCKS ARE UNABLE TO WASHOUT OFFSITE, THE OPERATORS WILL PROVIDE ONE OR MORE DESIGNATED CONCRETE WASHOUT AREAS. THE CONCRETE WASHOUTS MUST BE INSTALLED PRIOR TO CONCRETE USE ONSITE AND REMOVED ONLY AFTER CONCRETE WORK IS COMPLETE.

PHASE III: FINAL STABILIZATION AND CONSTRUCTION COMPLETION

1.IF APPLICABLE, REVEGETATION OR LANDSCAPING SHALL BE INITIATED IMMEDIATELY UPON KNOWING WORK IN A DISTURBED AREA HAS PERMANENTLY STOPPED AND THE AREA IS NOT COVERED BY PERMANENT STRUCTURES, UNLESS INFEASIBLE. SECTION 6.5 OF THE SWPPP NARRATIVE DISCUSSES PERMANENT STABILIZATION AND ASSOCIATED DEADLINES.


2.THE OPERATORS SHALL REMOVE TEMPORARY BMPS ONLY AFTER FINAL STABILIZATION IS COMPLETE.





SWPPP
Stormwater
Erosion Control
Reclamation
Seeding

www.e2rc.com | 505.867.4040

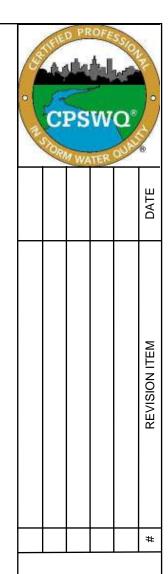

SEQUOIA APARTMENTS SWPPP NOTES

DESIGNED BY:
K. FETTER, P.E.
DRAWN BY:
S. FETTER

SHEET:

GENERAL NOTES

GENERAL NOTES

THE NPDES COMPLIANCE SWPPP DRAWING AND ASSOCIATED DOCUMENTATION IS AND SHALL BE CONSIDERED A LIVING DOCUMENT ALLOWING FOR MODIFICATIONS AS SITE CONDITIONS CHANGE OR DICTATE.

ALL SITE FEATURES (EXISTING/PROPOSED GRADES, EXISTING CONSTRUCTION, FUTURE CONSTRUCTION, ETC.) SHOWN IS PER INFORMATION FROM OTHERS.

MINIMUM REQUIREMENTS TO FURTHER DEVELOP OR MODIFY THIS STORMWATER POLLUTION PREVENTION PLAN (SWPPP) DRAWING SHALL BE BASED ON THE CURRENT EDITION OF THE NEW MEXICO STATE HIGHWAY AND TRANSPORTATION DEPARTMENT (NMSHTD), NPDES LAW AND CITY OF ALBUQUERQUE ORDINANCE § 14-5-2-11.

ALL OPERATORS SHALL SUBMIT A NOTICE OF INTENT (NOI). THE NOI SHALL BE ACTIVE AND POSTED ON THE EPA'S WEBSITE PRIOR TO COMMENCING EARTH DISTURBING ACTIVITIES.

LOCATE TEMPORARY WASHOUT, ANCHORED TOILETS, CONSTRUCTION ENTRANCE AND PARKING, STAGING, REFUELING, TRASH CONTAINMENT AREA TO MINIMIZE SITE DISTURBANCE DURING CONSTRUCTION ACTIVITY.

THE OPERATOR IS REQUIRED TO REGULARLY PERFORM STREET SWEEPING AND CLEAN - UP MEASURES IN THE EVENT OF SEDIMENT TRACK - OUT.

THE FOLLOWING ARE STANDARD EROSION CONTROL REQUIREMENTS PER THE CITY OF ALBUQUERQUE STORMWATER QUALITY DEPARTMENT (MARCH 24, 2021):

ALL EROSION AND SEDIMENT CONTROL (ESC) WORK ON THESE PLANS, EXCEPT AS OTHERWISE STATED OR PROVIDED HEREON SHALL BE PERMITTED, CONSTRUCTED, INSPECTED, AND MAINTAINED IN ACCORDANCE WITH:

THE CITY ORDINANCE § 14-5-2-11, THE ESC ORDINANCE; THE EPA'S 2022 CONSTRUCTION GENERAL PERMIT (CGP); AND THE CITY OF ALBUQUERQUE CONSTRUCTION BMP MANUAL

ALL TEMPORARY SEDIMENT AND EROSION CONTROL MEASURES MUST BE INSTALLED PRIOR TO BEGINNING ANY EARTH MOVING ACTIVITIES EXCEPT AS SPECIFIED HEREON IN THE PHASING PLAN.
CONSTRUCTION OF EARTHEN BMPS SUCH AS SEDIMENT TRAPS, SEDIMENT BASINS, AND DIVERSION BERMS SHALL BE COMPLETED AND INSPECTED PRIOR TO ANY OTHER CONSTRUCTION OR EARTHWORK.
SELF-INSPECTION IS REQUIRED AFTER INSTALLATION OF THE BMPS AND PRIOR TO BEGINNING CONSTRUCTION.

SEE SECTION 3.5 OF THE SWPPP NARRATIVE OR THE CONTRACTOR'S SCHEDULE (TAB II OF SWPPP BINDER) FOR BMP SCHEDULING OR PHASING.

SELF-INSPECTIONS - AT A MINIMUM A ROUTINE COMPLIANCE SELF-INSPECTION IS REQUIRED TO REVIEW THE PROJECT FOR COMPLIANCE WITH THE CONSTRUCTION GENERAL PERMIT ONCE EVERY 14 DAYS AND AFTER ANY PRECIPITATION EVENT OF 1/4 INCH OR GREATER UNTIL THE SITE CONSTRUCTION HAS BEEN COMPLETED AND THE SITE DETERMINED AS STABILIZED BY THE CITY. REPORTS OF THESE INSPECTIONS SHALL BE KEPT BY THE PERSON OR ENTITY AUTHORIZED TO DIRECT THE CONSTRUCTION ACTIVITIES ON THE SITE AND MADE AVAILABLE UPON REQUEST.

CORRECTIVE ACTION REPORTS MUST BE KEPT BY THE PERSON OR ENTITY AUTHORIZED TO DIRECT THE CONSTRUCTION ACTIVITIES ON THE SITE AND MADE AVAILABLE UPON REQUEST.

STABILIZATION REPORTS MUST BE KEPT BY THE PERSON OR ENTITY AUTHORIZED TO DIRECT THE CONSTRUCTION ACTIVITIES ON THE SITE AND MADE AVAILABLE UPON REQUEST. REPORTS SHOULD INCLUDE RECORDS OF WEED REMOVAL PER CITY ORDINANCE (§ 9-8-1), STERILIZATION, SOIL TEST RESULTS AND RECOMMENDATION, MATERIALS AND MANUFACTURER'S SPECIFICATIONS FOR APPLICATION RATES, ESTIMATED FUNCTIONAL LONGEVITY, METHODS OF APPLICATION, INSPECTION AND MAINTENANCE. THE REDUCED SELF-INSPECTION SCHEDULE IN CGP 4.4.1 APPLIES TO STABILIZED AREA AND ANY DAMAGED OR WORN STABILIZATION MUST BE IDENTIFIED IN THE REPORTS ALONG WITH WEED PROBLEMS. CORRECTIVE ACTIONS FOR STABILIZATION SHALL BE DOCUMENTED IN A STABILIZATION REPORT INCLUDING ACTUAL RATES AND DATES OF STABILIZATION. AND THE MATERIALS AND MANUFACTURER'S SPECIFICATIONS USED.


BMPS SHALL BE INSPECTED AND MAINTAINED UNTIL ALL DISTURBED AREAS ARE STABILIZED IN ACCORDANCE WITH THE FINAL STABILIZATION CRITERIA (CGP 2.2.14.B). GENERALLY, ALL DISTURBED AREAS, OTHER THAN STRUCTURES AND IMPERVIOUS SURFACES, MUST HAVE UNIFORM PERENNIAL VEGETATION THAT PROVIDES 70 PERCENT OR MORE OF THE COVER PROVIDED BY NATIVE VEGETATION OR SEED THE DISTURBED AREA AND PROVIDE NON-VEGETATIVE MULCH THAT PROVIDES COVER FOR AT LEAST THREE YEARS WITHOUT ACTIVE MAINTENANCE. FINAL STABILIZATION MUST BE APPROVED BY THE CITY OF ALBUQUERQUE PRIOR TO REMOVAL OF BMPS AND DISCONTINUATION OF INSPECTIONS.





SWPPP
Stormwater
Erosion Control
Reclamation

www.e2rc.com | 505.867.4040

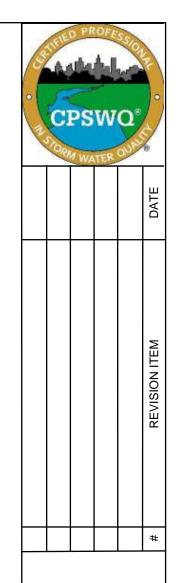


SEQUOIA APARTMENTS SWPPP NOTES


DESIGNED BY:
K. FETTER, P.E.
DRAWN BY:
S. FETTER

SHEET:

GENERAL NOTES

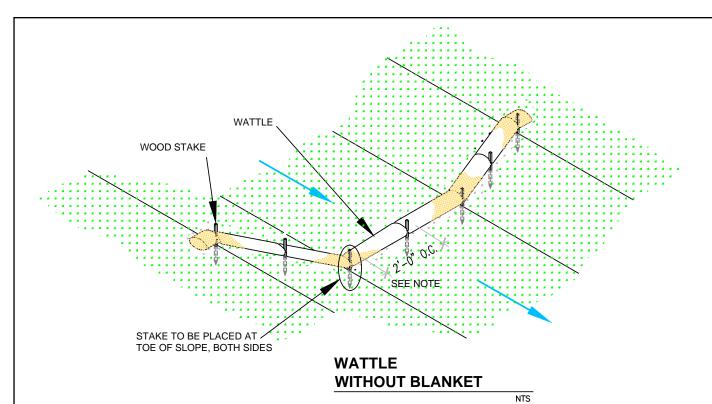


2' FOR DRAWING ONLY. 8' MAX SPACING BETWEEN STAKES

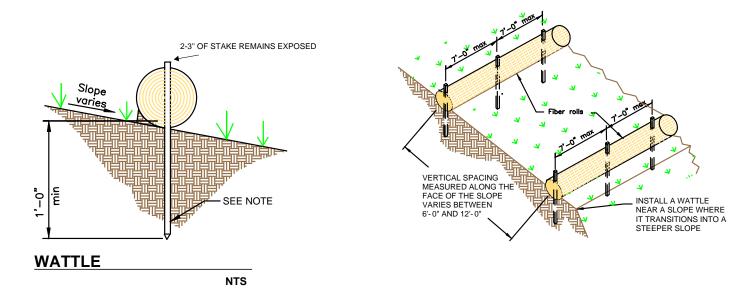

SECURE WATTLE WITH 18-24" STAKES EVERY 3-4' AND STAKES ON EACH END OF THE WATTLE.

DRIVE STAKES PERPENDICULAR TO THE SLOPE FACE AND THROUGH THE MIDDLE OF THE WATTLE LEAVING AT LEAST 2-3" OF THE STAKE ABOVE THE WATTLE.

VERTICAL SPACING DEPENDENT ON SLOPE GRADIENT.

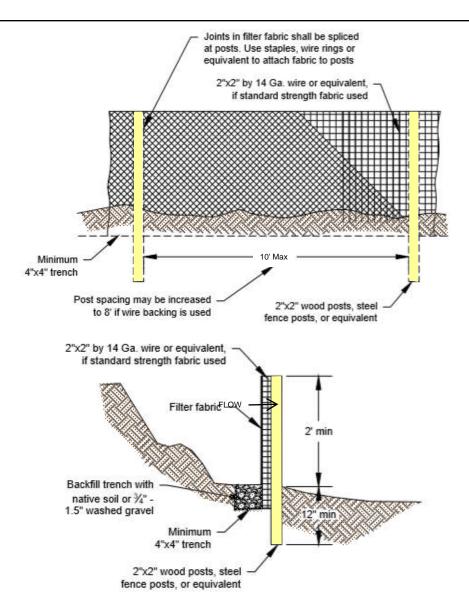

SILT FENCE

NTS

SILT FENCE IS TO BE PLACED PERPENDICULAR TO THE SLOPE OF THE SITE.

DIG A 4"X4" MINIMUM TRENCH UPSTREAM OF THE SILT FENCE. DRIVE STAKES AT LEAST 1' DEEP ON THE DOWNSTREAM EDGE.

RUN THE SILT FENCE ON THE INSIDE OF THE STAKES AND SECURE WITH HOG RINGS, WIRE, ZIP TIES OR STAPLES.

IF ONE CONTINUOUS PIECE OF FABRIC IS NOT AVAILABLE, OVERLAP THE FABRIC AT LEAST THE WIDTH OF THE STAKE AND SECURE WITH HOG RINGS, WIRE, ZIP TIES OR STAPLES.

COVER TRENCH WITH BACKFILLED COMPACTED SOIL, GRAVEL OR ROCK.



SWPPP
Stormwater
Erosion Control
Reclamation
Seeding

SHEET

www.e2rc.com | 505.867.4040


DATE REVISION ITEM

> SEQUOIA APARTMENTS BMP DETAILS

DESIGNED BY:
K. FETTER, P.E.
DRAWN BY:
S. FETTER

SHEET:

4

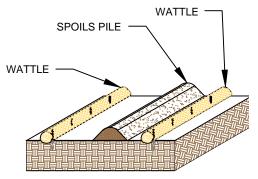

SPOILS PILE PROTECTION


NTS

PLACE WATTLES IN FUTURE LOCATIONS OF SPOILS STOCKPILES PRIOR TO CONSTRUCTION.

PLACE WATTLES CONTINOUSLY ALONG THE EXTENT OF THE SPOILS STOCKPILE.

ANCHOR THE WATTLES USING A MINIMUM OF 1" X 2" X 18" WOODEN STAKES OR SAND BAGS.


ONCE/IF THE SPOILS STOCKPILE IS DEPLETED OR MOVED, REMOVE THE WATTLES AND REUSE THEM IN THE NEXT LOCATION.

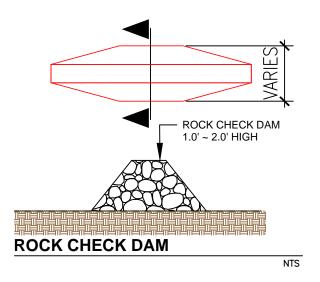

PLACE CHECK DAMS AT REGULARLY SPACED INTERVALS ALONG SWALE OR DRAINAGE DITCH.

HEIGHTS SHOULD ALLOW FOR POOLS TO DEVELOP UPSTREAM OF EACH CHECK DAM.

IF MULTIPLE DAMS ARE USED, THE TOP OF THE LOWER DAM SHOULD BE THE SAME HEIGHT AS THE ELEVATION AS THE TOE OF THE UPPER DAM.

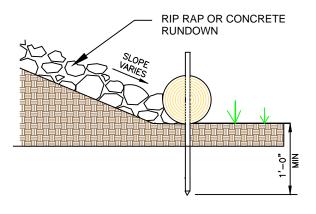

RUNDOWN DETAIL


NTS

8' MAX SPACING BETWEEN STAKES

PLACE WATTLES AT THE TOE OF SLOPE. THE RIP RAP OR CONCRETE RUNDOWN SHOULD ABUT THE WATTLE.

ANCHOR THE WATTLES WITH WOODEN STAKES. DRIVE THE STAKE A MINIMUM OF 12" INTO THE MIDDLE OF THE WATTLE AND SOIL UNDERNEATH.

2-3" OF THE WOODEN STAKE SHOULD BE PRESENT ABOVE THE WATTLE.

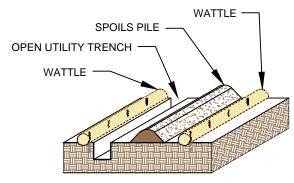

OPEN TRENCH SPOILS PILE PROTECTION


NTS

PLACE WATTLES CONTINUOUSLY ALONG THE EXTENT OF THE UTILITY TRENCH AND FUTURE LOCATION OF THE SPOILS STOCKPILE PRIOR TO EXCAVATION OF THE UTILITY.

WATTLES ARE TO REMAIN ANCHORED IN PLACE UNTIL THE UTILITY TRENCH IS BACKFILLED.

ANCHOR THE WATTLES USING A MINIMUM 1"X2"X18" WOODEN STAKE OR SANDBAGS.

ONCE THE TRANCH IS BACKFILLED, WATTLES MAY BE REMOVED AND REUSED IN THE NEXT SECTION OF EXCAVATION PROVIDED THEY ARE IN GOOD CONDITION.

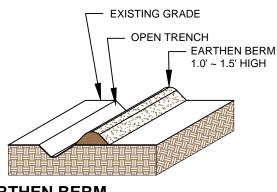

EARTHEN BERM

CONSTRUCT AN EARTHEN BERM DOWN HILL OF THE AREA TO BE CONTROLLED.

BERM SHOULD BE A MINIMUM 12" HIGH AND 12" WIDE.

USE EQUIPMENT TO COMPACT EARTHEN BERM BY ROLLING OVER BERM TO MINIMIZE SPREAD.





SWPPP
Stormwater
Erosion Control
Reclamation

Seeding

tion S

www.e2rc.com | 505.867.4040


CPSWO BATE AND MATERIAL MATERI


SEQUOIA APARTMENTS BMP DETAILS

DESIGNED BY: K. FETTER, P.E. DRAWN BY: S. FETTER

SHEET:

5

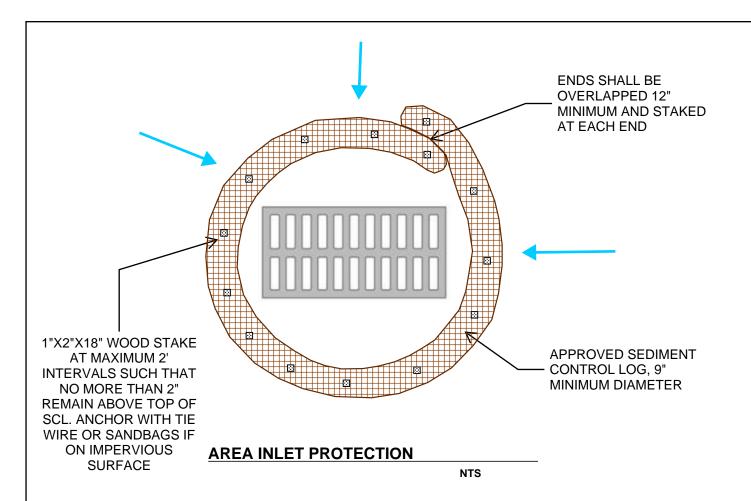

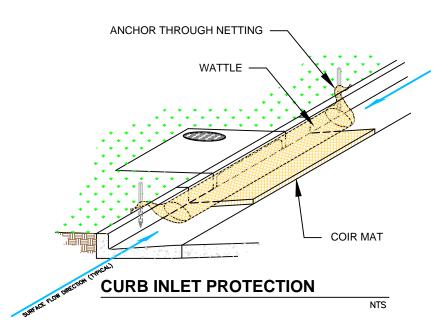


THE MAT SHOULD EXTEND A MINIMUM OF 1" PAST ALL EDGES OF THE INLET. PLACE MAT AGAINST THE CURB INLET.

PLACE WATTLES ON TOP OF THE MAT CLOSEST TO THE INLET OPENING AND CURB.

THE MAXIMUM HEIGHT OF THE PROTECTIVE BARRIER MUST BE LOWER THAN THE TOP OF THE CURB OPENING. THIS ALLOWS OVERFLOW INTO THE INLET DURING LARGE PRECIPITATION EVENTS.

ANCHOR THE BARRIER NETTING OVER THE CURB WITH WOODEN STAKES IF ABLE. IF UNABLE TO DO THAT ANCHOR THE WATTLE WITH SAND BAGS ON EACH END.

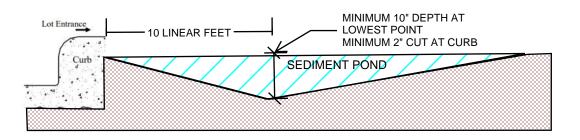

CUTBACK CURB

NTS

CUTBACK CURBS SHOULD TYPICALLY BE INSTALLED AT THE SITE ENTRANCE WHEN ACCESS IS NEEDED.

SOIL SHOULD BE CUT BACK FROM BEHIND THE CURB, SIDEWALK OR ROADWAY A MINIMUM 2" DOWN FROM THE TOP OF THE HARDSCAPE.

BRING THE SOIL BACK > 10 FEET FT FROM THE HARDSCAPE TO FORM THE SEDIMENT TRAP.

THE LOWEST POINT OF THE SEDIMENT POND SHALL BE AT LEAST 10 INCHES.


IF THE HOUSE PAD HAS BEEN STABILIZED, THE DEPTH OF THE SEDIMENT POND MAY BE REDUCED TO 4 INCHES.

THE DEPTH AND LENGTH OF THE EXCAVATED AREA CAN BE INCREASED IF MORE STORAGE IS NEEDED.

INSPECT BMPs PRIOR TO FORCAST PRCIPITATION, DAILY DURING PRECIPITATION EVENTS, AFTER PRECIPITATION EVENTS AND THROUGH THE LIFE OF THE PROJECT.

MAINTAIN PROPER DEPTH AND LENGTH OF THE CUTBACK FOR THE DURATION OF THE PROJECT.

KEEP CUTBACK AREA CLEAN AND FREE OF TRASH AND DEBRIS.

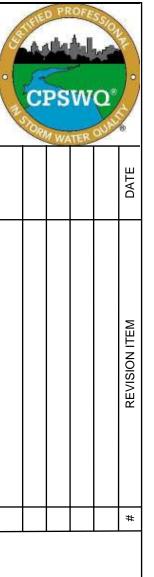


APARTMENTS DETAILS SEQUOIA A


SWPPP Stormwater **Erosion Control** Reclamation Seeding

DESIGNED BY: K. FETTER, P.E. DRAWN BY: S. FETTER

SHEET:



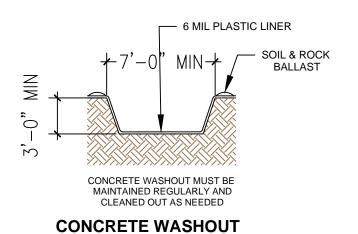

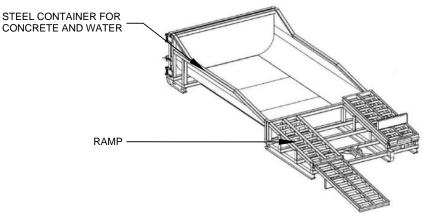

MODULAR CONCRETE WASHOUT

NPDES Permit must

be positioned at the most active part of

the project where it

can be viewed by

project entrance)

the public (e.g.

LOCATE WASHOUT AT LEAST 50 FT FROM STORMDRAINS, OPEN DITCHES, WATER BODIES OR PROJECT PERIMETER. A SIGN SHOULD BE INSTALLED ADJACENTLY TO THE WASHOUT.

WASH OUT WASTE INTO THE WASHOUT WHERE THE CONCRETE CAN SET, BE BROKEN UP AND DISPOSED OF CORRECTLY.

DO NOT CREATE RUNOFF BY DRAINING WATER TO BERMED AREA OR BY COLLECTING THE WATER WASTE WHEN WASHING CONCRETE TO REMOVE PARTICLES AND EXPOSE THE AGGREGATE.

DO NOT WASH SWEEPINGS FROM EXPOSED AGGREGATE CONCRETE INTO THE STREET, STORMDRAIN SYSTEMS OR OFF THE PROJECT SITE.



PORTABLE TOILET STAKING

PLACE THE PORTABLE TOILET ON LEVEL GROUND. A FLAT PAVED SURFACE IS BEST IF AVAILABLE.

DRIVE THE STAKES OVER THE SKIDS OF THE PROTABLE TOILET, AROUND ALL SIDES.




CRUSHED AGGREGATE GREATER THAN 75 MM (3 IN.) BUT SMALLER THAN 150 MM (6 IN.)

FILTER FABRIC

ORIGINAL

300 MM (12 IN), UNLESS OTHERWISE SPECIFIED BY A SOILS ENGINEER

SECTION B-B

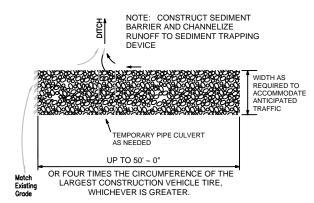

STABILIZED CONSTRUCTION **ENTRANCE**

CONSTRUCT THE ENTRANCE ON A LEVEL SURFACE WHERE AN UNPAVED ROAD MEETS A PAVED ROAD. TYPICALLY AT PROJECTS ACCESS AREA.

GRADE THE ENTRANCE TOWARD THE CONSTRUCTION SITE TO PREVENT RUNOFF.

INSPECT THE ENTRANCE TO KEEP TRASH AND DEBRIS OUT OF THE WAY.

AFTER PRECIPTATION EVENTS, INSPECT THE ENTRANCE FOR ANY REPAIRS THAT MAY BE NEEDED.

SWPPP Stormwater **Erosion Control** Reclamation

K. FETTER, P.E. DRAWN BY: S. FETTER

DESIGNED BY:

SHEET:

APARTMENTS

DETAIL


SEQUOIA /

REVISION ITEM

NPDES POSTING BOARD

NTS

TEMP TOILET

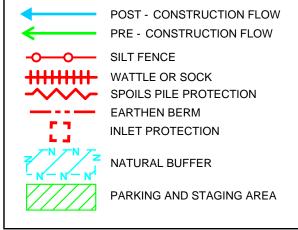

CONCRETE WASHOUT

STABILIZED CONSTRUCTION ENTRANCE

VEGETATIVE STABILIZATION

ENDANGERED/THREATENED

CHEMICAL STORAGE

SPECIES

CHECK DAM



LOCATION FOR PUBLIC NOTIFICATION OF NPDES

PROJECT BOUNDRY DISTURBED AREA PROJECT AND DISTURBED

BOUNDRY

CULVERT BLANKET CUTBACK CURB

DRAWING KEY

PARKING AND STAGING AREA.


TOGETHER IF MOVED. AREAS


CAN BE MOVED AFTER START OF


CHEMICAL STORAGE AND

CONCRETE WASHOUT IN APPROXIMATE LOCATION.

www.e2rc.com | 505.867.4040

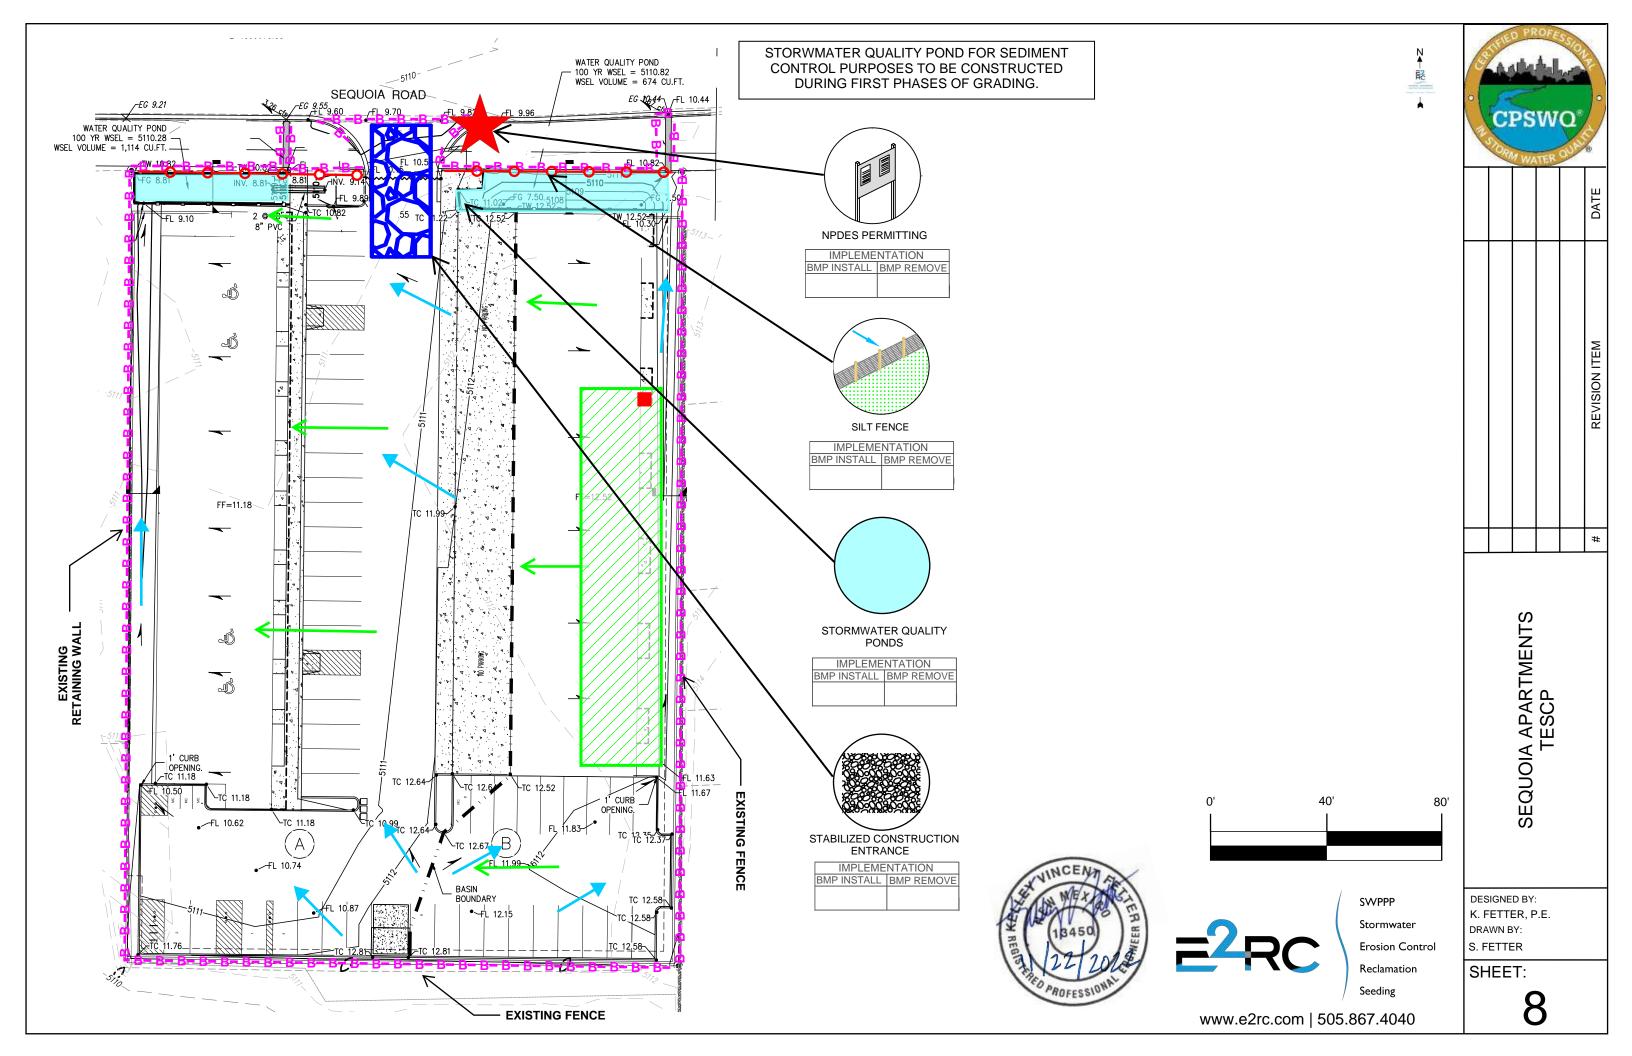

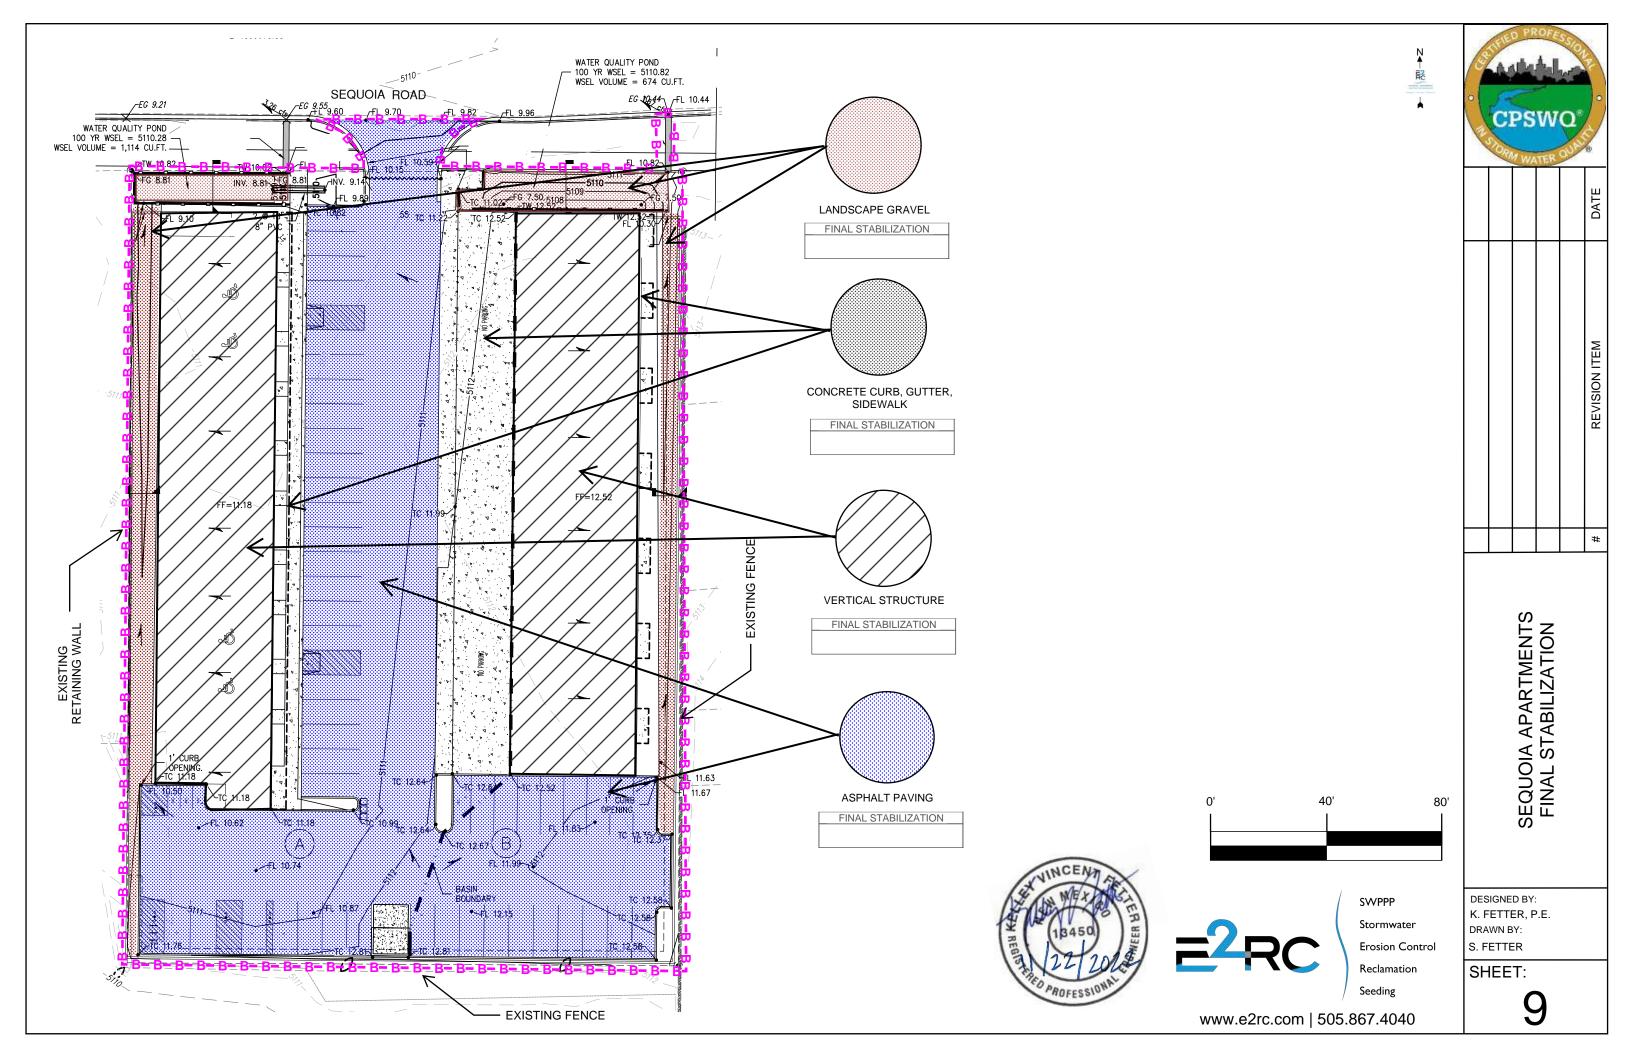

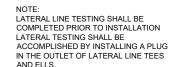


KEYED NOTES: A FINISH GRADE B. FLOOD BUBBLER (SEE C. SCH. 80 PVC NIPPLE. D. SCH 40 PVC TEE. F LATERAL PIPE F. SCH 40 PVC THREADED

IRRIGATION BUBBLER


NINO

NOTE: CUT & REMOVE WIRE FROM ROOTBALL. PEEL BACK BURLAP TO EXPOSE TOP 1/3 OF ROOTBALL. CAREFULLY TAMP IN BACKFILL MIX TO INSURE ROOTBALL REMAINS INTACT

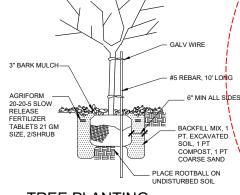

TREE PLANTING

NOTE: CONTRACTOR SHALL GRADE SOIL ADJACENT TO TREES AND SHRUBS TO ENSURE EVEN AND ADEQUATE WATERING OF ALL PLANT MATERIAL

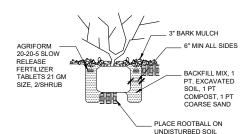

R-ML ZONING R-MH ZONING **A** D **R-T ZONING**

LANDSCAPE PLAN

35"-0" CLEAR SIGHT TRIANGLE DPM 35 MPH CLEAR SIGHT TRIANGLE

LANDSCAPE PLANTING

A FINISH GRADE

B. BROOKS PRODUCTS, INC. 1730 PB-18 BODY (ABS) VALVE BOX W/1730 BOLT DOWN COVER (ABS) & TWO 8" EXTENSIONS.

- C. DRY SPLICE CONNECTOR OR EQUAL.
- D. IRRIGATION MAINLINE.
 E. IRRIGATION MAINLINE SERVICE TEE OR ELL.
- SCHEDULE 80 PVC X 12" NIPPLE.
- G SPEARS TRUE LINION SCHEDULE 80 PVC BALL VALVE
- SCHEDULE 80 PVC CLOSE NIPPLE
- ELECTRIC VALVE (SEE PLAN) SPEARS SCHEDULE 80 PVC UNION
- LATERAL LINE
- 1 CUBIC FOOT 1" DIA. WASHED ROCK. M. 8" X 8" X 16" SOLID CMU BLOCK.
- N. 24" WIRE EXPANSION COIL. O. 6 mm BLACK POLYETHYLENE PLASTIC. TAPE TO ALL INLET & OUTLET PIPE & INSTALL THE FULL DEPTH OF THE

VALVE BOX BOTTOM

INSTALL AN 8" X 8" X 16" SOLID CMU BLOCK @ EA. CORNER

WASH ROCK SHALL BE INSTALLED FLUSH WITH BOTTOM OF PIPE & VALVE.

COORS BOULEVARD - CPO-2 HEIGHT PER 14-16-3-6 (D) (IDO PAGE 130) NOT APPLICABLE

PARKING: MULTI-FAMILY DWELLING: 46 X 1.5 = 69 SPACES 12 CARAGES EACH HAVE A CHARCING STATION SPACES PROVIDED: 48 SURFACE + 24 GARAGE (12 X 2) + 4 ON STREET = 76 SPACES HC REQUIRED: 3 STANDARD, 1 VAN 4 MOTORCYCLE REQUIRED 2 EA. 6 SPACE BIKE RACK

GROSS LOT AREA = 51,888 SF BUILDINGS = 15,914 SF NET LOT AREA = 35,974 SF REGUIRED LANDSCAPE AREA @ 15% = 5,396 SF; 8,409 SF PROVIDED

IDO TABLE 5-1-2 OPEN SPACE R-MH (IDO PAGE 216): 1 BEDROOM: 17 EA X 225 SF = 3,600 SF 2 BEDROOM: 17 EA X 285 SF = 8,265 SF 3 BEDROOM: 12 EA X 350 SF = 4.200 SI

TOTAL REQUIRED = 16.065 SE

GRADE | EVEL = 11 091 SE BALCONY LEVEL 2 = 1,165 SF BALCONY LEVEL 3 = 1,165 SF 4TH FLOOR DECK = 5,000 SE TOTAL PROVIDED = 18 421 SE

LEGAL: LOT 20, CORONA DEL SOL ZONING: R-MH ZONE ATLAS PAGE: G11

SETBACKS R-MH IDO PAGE 23

SIDE: INTERIOR 5FT REAR: 15 FT

NOTE: RECESS WINDOWS 2 INCHES

LANDSCAPING, DWELLING, MULTI-FAMILY GROUND FLOOR UNITS = 22 UNITS TOTAL TREES REQUIRED = 34

IDO 154-16-5-6 (D)(1) STREET FRONTAGE 190FT / 25FT = 8 TREES REQUIRED

BUFFER
IDO 14-16-\$-6 (E)(2)
15FT BUFFER PROVIDED ON EAST PROPERTY LINE
6FT CMU WALL PROVIDED ON EAST, SOUTH & WEST PROPERTY LINES

LANDSCAPING @ PARKING LOT IDO 14-16-5 (FI/Z) PARKING MORE THAN 50 SPACES 15% LANDSCAPING REQUIRED 19,120 SF X 15% = 2,868 SF LANDSCAPING 1 TREE PER 10 PARKING SPACES = 7 TREES

NOTE: THE PROPERTY OWNER SHALL PROPERLY MAINTAIN ALL IRRIGATION SYSTEMS, LANDSCAPING PLANTS AND GRAVEL MULCH

SCALE: 1" = 20'-0"

CM - CRAPE MYRTLE - LAGERSTROEMIA INDICA - 7'-9'

OR - OKLAHOMA REDBUD - CERCIS RENIFORMIS - 8'-10'

LE - LACEBARK ELM - ULMUS PARVIFOLIA - 8'-10'

S - BLUE MIST SPIREA - CARYOPTERIS X CLANDONENSIS - 1-2 GAL

FG - MEXICAN FEATHER GRASS - NASSELLA TENUISSIMA - 1-2 GAL

C - CATMINT - NEPETA FAASSENII - 1-2 GAL

PM - PINK MUHLYGRASS - MUHLENBERGIA CAPILLARIS - 1-2 GAL

FRG - FEATHER REED GRASS - CALAMAGROSTIS ACUTIFLORA 1-2 GAL €}

BAG - BLUE AVENA GRASS - HELICTOTRICHON SEMPERVIRENS 1-2 GAL

L - ENGELMAN IVY - 1-2 GAL - 25 EACH (ATTACHED TO WALL)


GRAVEL MULCH

ZONING

Ķ

NR-PO-

- LANDSCAPE MAINTENANCE SHALL BE THE RESPONSIBILITY OF THE PROPERTY OWNER.
- IT IS THE INTENT OF THIS PLAN TO COMPLY WITH THE CITY OF ALBUQUERQUE WATER CONSERVATION LANDSCAPING AND WATER WASTE ORDINANCE PLANTING RESTRICTION APPROACH.
- 3 APPROVAL OF THIS PLAN DOES NOT CONSTITUTE OR IMPLY EXEMPTION FROM WATER WASTE PROVISIONS OF THE WATER CONSERVATION LANDSCAPING AND WATER WASTE ORDINANCE. WATER MANAGEMENT IS THE SOLE RESPONSIBILITY OF THE PROPERTY OWNER.
- ALL LANDSCAPING WILL BE IN CONFORMANCE WITH THE CITY OF ALBUQUERUOE ZONING CODE, STREET TREE ORDINANCE, POLLEN ORDINANCE, AND WATER CONSERVATION LANDSCAPING AND WATER WASTE ORDINANCE. IN GENERAL, WATER CONSERVATIVE, ENVIRONMENTALLY SOUND LANDSCAPE PRINCIPLES WILL BE FOLLOWED IN DESIGN AND
- 5. PLANT BEDS SHALL ACHIEVE 75% LIVE GROUND COVER AT MATURITY
- SFBROWN GRAVEL OVER FILTER FABRIC SHALL BE PLACED IN ALL
 LANDSCAPE AREAS WHICH ARE NOT DESIGNATED TO RECEIVE NATIVE SEED
- IRRIGATION SHALL BE A COMPLETE UNDERGROUND SYSTEM WITH TREES TO RECEIVE (5) 1.0 GPH DRIP EMITTERS AND SHRUBS TO RECEIVE (2) 1.0 GPH DRIP EMITTERS. DRIP AND BUBBLER SYSTEMS TO BE TIED TO 1/2" POLYPIPE WITH FLUSH CAPS AT EACH END.
- POINT OF CONNECTION FOR IRRIGATION SYSTEM IS UNKNOWN AT CURRENT TIME AND WILL BE COORDINATED IN THE FIELD.
- 10. IRRIGATION WILL BE OPERATED BY AUTOMATIC CONTROLLER, LOCATION OF CONTROLLER TO BE FIELD DETERMINED AND POWER SOURCE FOR CONTROLLER TO BE PROVIDED BY OTHERS.
- 11. IRRIGATION MAINTENANCE SHALL BE THE RESPONSIBILITY OF THE PROPERTY
- 12. FINAL LANDSCAPING LAYOUT AND DESIGN TO BE DETERMINED UPON RECEIPT OF FINAL GRADING PLAN
- 13. INSTALL BACKFLOW PREVENTION @ IRRIGATION SYSTEM. REFERENCE DETAIL
- 14. NO PARKING SPACE SHALL BE MORE THAN 50'-0" FROM A TREE TRUNK
- TREE CANOPY COUNTS TOWARD 75% OF REQUIRED GROUND COVER FOR LANDSCAPE AREAS UP TO 100SF.

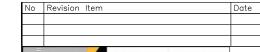



5130 SEQUOIA RD NW ALBUQUERQUE, NM 87120

LANDSCAPE PLAN



IRRIGATION VALVES