

ENGINEERSEAL



PROJECT

COORS BLVD. & QUAIL RD., NW Albuquerque, New Mexico

REVISIONS

WASH

August 25, 2003

NORTH SCALE



DRAWING NAME

GRADING PLAN

1"=20'

SHEET NUMBER


LARRY READ & ASSOCIATES

Civil Engineers

4800-C Juan Tabo, NE
Albuquerque, New Mexico 87111

(505) 237-8421

C-2

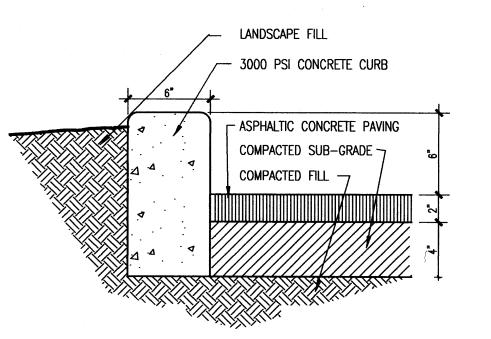

TYPICAL CURB DETAIL
1-1/2"=1'-0"

- LOW CUT OFF 'SHOE BOX" TYPE


POLE MOUNTED LIGHT FIXTURE

- CONCRETE POLE


BASE. SEE ELEC.

TYP. POLE LIGHT


SEE ELEC.

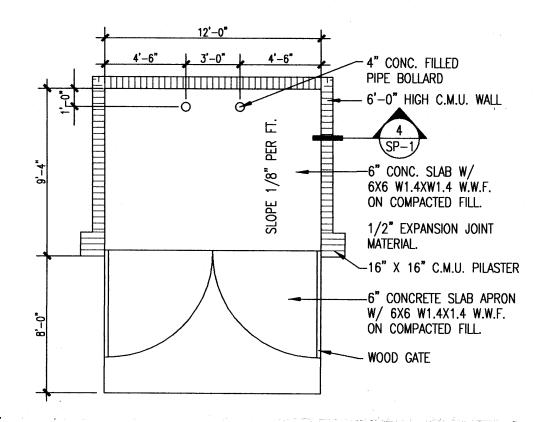

TRASH ENCLOSURE
3/16"=1'-0"

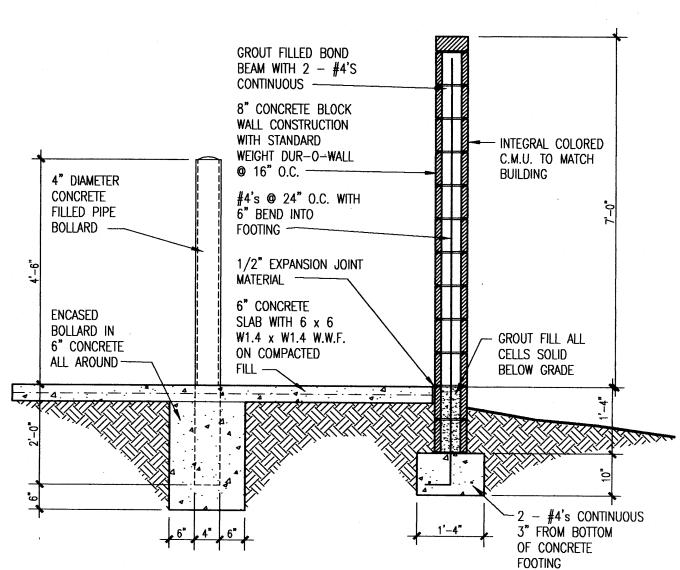

SECTION THRU ENCLOSURE WALL

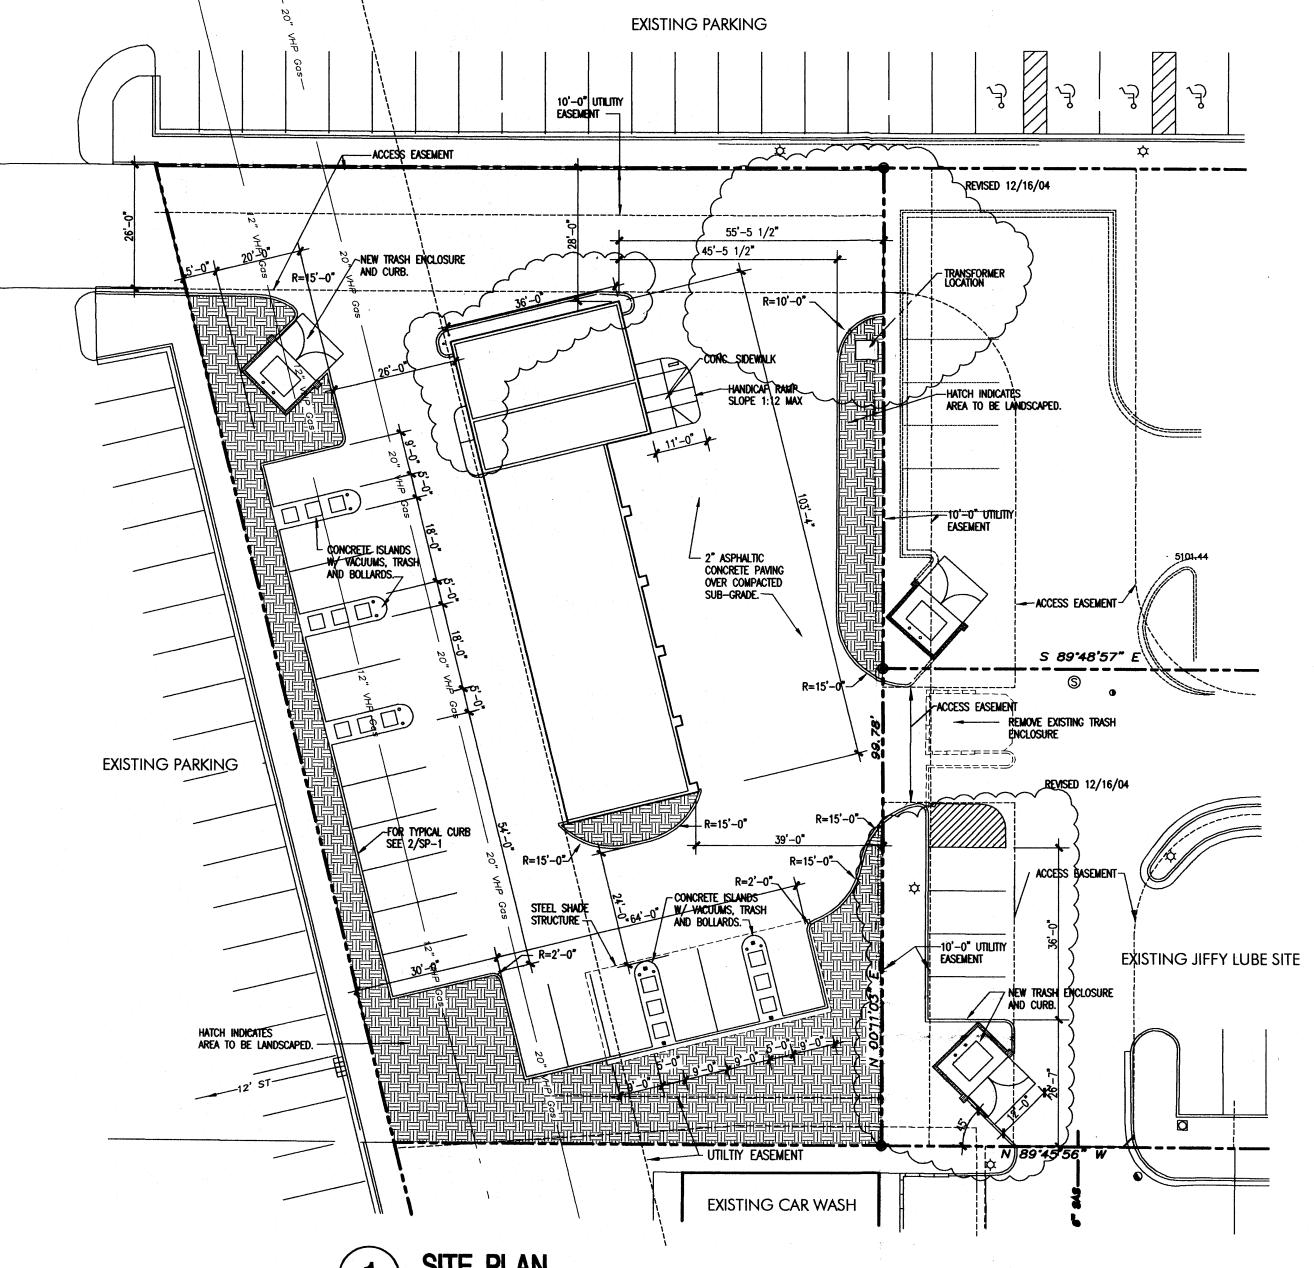

SITE PLAN
1"=20'-0"

PROJECT INFORMATION

PROJECT: LOCATION: OWNER:

NEW SELF-SERVE CAR WASH 2923 COORS BLVD., N.W.

PURPLE SAGE, LLC 20 VISTA SANDIA CT. PLACITAS, NM 87043 867-3167 TATE FISHBURN ARCHITECT

ARCHITECT: LEGAL DESCRIPTION:

TRACT A-26-A2A-1
TOWN OF ATRISCO GRANT
ZONE ATLAS H-11-Z CURRENT ZONING CLASSIFICATION:

TYPE CONSTRUCTION: OCCUPANCY:

ALLOWABLE AREA: TYPE V-N CONSTRUCTION & B OCCUPANCY = 8,000

GROSS BUILDING AREA: **NET BUILDING AREA:**

2,880 S.F. 264 S.F.

TYPE VN

OCCUPANT LOAD:

264/100 = 3 OCCUPANTS

EXIT WIDTH REQUIRED: 1 INCH EXIT WIDTH PROVIDED: 36 INCHES NUMBER OF EXITS PROVIDED: ONE TOTAL TOTAL LOT AREA:

PARKING ANALYSIS:


.59 ACRES +/-NET AREA = 264 264 / 200 =2 REQUIRED SPACES

SPACES REQUIRED = 2 SPACES PROVIDED= 17 SPACES

SEISMIC ZONE:

L I шΟ ARCHITECT SEAL

ENGINEER SEAL

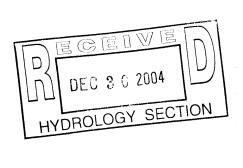

PROJECT

CAR WASH FAC BLVD. NEW 2923 COORS E Albuquerque, 1 TRAFFIC NEW

REVISIONS

DECEMBER 30, 2004



DRAWING NAME

SITE PLAN .

SHEET NUMBER

SP-1

GENERAL

CONTRACTOR IS RESPONSIBLE FOR OBTAINING ALL REQUIRED CONSTRUCTION PERMITS, INCLUDING A TOP SOIL DISTURBANCE PERMIT. PRIOR TO START OF CONSTRUCTION.

ALL WORK ON THIS PROJECT SHALL BE PERFORMED IN ACCORDANCE WITH APPLICABLE FEDERAL, STATE, AND LOCAL LAWS, ORDINANCES, AND REGULATIONS CONCERNING CONSTRUCTION SAFETY AND HEALTH.

REFERENCES MADE TO STANDARD SPECIFICATIONS AND STANDARD DRAWINGS REFER TO THE CITY OF ALBUQUERQUE STANDARD SPECIFICATIONS FOR PUBLIC WORKS CONSTRUCTION, 1986 EDITION WITH ALL UPDATES.

THE CONTRACTOR SHALL NOT INSTALL ITEMS AS SHOWN ON THESE PLANS WHEN IT IS OBVIOUS THAT FIELD CONDITIONS ARE DIFFERENT THAN SHOWN IN THE PLANS. SUCH CONDITIONS SHALL BE BROUGHT TO THE ATTENTION OF THE ENGINEER IN A TIMELY MANNER. IN THE EVENT THE CONTRACTOR DOES NOT NOTIFY THE ENGINEER IN A TIMELY MANNER, THE CONTRACTOR ASSUMES FULL RESPONSIBILITY AND EXPENSE FOR ANY REVISIONS NECESSARY. INCLUDING ENGINEERING DESIGN FEES.

EXISTING SITE IMPROVEMENTS WHICH ARE DAMAGED OR DISPLACED BY THE CONTRACTOR SHALL BE REMOVED AND REPLACED BY THE CONTRACTOR AT THE CONTRACTOR'S EXPENSE. REPAIRS SHALL BE APPROVED BY THE OWNER PRIOR TO CONSTRUCTION OF THE REPAIRS. REPAIRS SHALL BE ACCEPTED BY THE OWNER PRIOR TO FINAL PAYMENT.

EXISTING FENCING THAT IS NOT DESIGNATED FOR REMOVAL SHALL NOT BE DISTURBED. ANY FENCING THAT IS DISTURBED OR ALTERED BY THE CONTRACTOR SHALL BE RESTORED TO ITS ORIGINAL CONDITION AT THE CONTRACTORS EXPENSE. IF THE CONTRACTOR DESIRES TO REMOVE FENCING TO ACCOMMODATE CONSTRUCTION ACTIVITIES, THE CONTRACTOR SHALL OBTAIN THE OWNER'S WRITTEN PERMISSION BEFORE THE FENCE IS REMOVED. CONTRACTOR SHALL RESTORE THE FENCE TO ITS ORIGINAL CONDITION AT THE EARLIEST OPPORTUNITY. WHILE ANY FENCING IS REMOVED, THE CONTRACTOR SHALL BE SOLELY RESPONSIBLE FOR SECURITY OF THE SITE UNTIL THE FENCE IS RESTORED.

WORK WITHIN ADJACENT RIGHT-OF-WAY

PRIOR TO BEGINNING ANY CONSTRUCTION ACTIVITIES WITHIN ADJACENT RIGHT-OF-WAYS OR WITHIN PROPERTY NOT OWNED BY THE OWNER OF THE PROJECT SITE. THE CONTRACTOR SHALL ASSURE THAT ALL PERMITS AND PERMISSIONS REQUIRED HAVE BEEN OBTAINED IN WRITING.

SURVEY MONUMENTS. PROPERTY CORNERS. BENCHMARKS

THE CONTRACTOR SHALL NOTIFY THE OWNER AT LEAST SEVEN DAYS BEFORE BEGINNING ANY CONSTRUCTION ACTIVITY THAT COULD DAMAGE OR DISPLACE SURVEY MONUMENTS, PROPERTY CORNERS, OR PROJECT BENCHMARKS SO THESE ITEMS MAY BE RELOCATED.

ANY SURVEY MONUMENTS, PROPERTY CORNERS, OR BENCHMARKS THAT ARE NOT IDENTIFIED FOR RELOCATION ARE THE RESPONSIBILITY OF THE CONTRACTOR TO PRESERVE AND PROTECT. RELOCATION OR REPLACEMENT OF THESE ITEMS SHALL BE DONE BY THE OWNER'S SURVEYOR AT THE EXPENSE OF THE CONTRACTOR.

DIMENSIONS

ALL DIMENSIONS TO CURBS ARE TO THE FLOWLINE UNLESS OTHERWISE NOTED.

ALL STATIONING IS TO THE CENTERLINE OF THE RIGHT-OF-WAY UNLESS OTHERWISE NOTED.

ALL SLOPES AND GRADES ARE IN PERCENT UNLESS OTHERWISE NOTED.

CURB ELEVATIONS ARE SHOWN AT THE FLOW LINE UNLESS OTHERWISE NOTED. SEE THE DETAIL SHEET TO DETERMINE THE CURB HEIGHT ABOVE FLOW LINE.

UNLESS OTHERWISE SPECIFIED, SUBGRADE, ENGINEERED FILL, AND STRUCTURAL FILL SHALL BE COMPACTED TO THE FOLLOWING SPECIFICATIONS OF THE ASTM D-1557 MAXIMUM DRY DENSITY.

MATERIAL/LOCATION	PERCENT COMPACTIO
STRUCTURAL FILL IN THE BUILDING AREA	95%
SUBBASE FOR SLAB SUPPORT	95%
MISCELLANEOUS BACKFILL BELOW STRUCTURAL	_
FILL OR ROADWAY PAVEMENT	95%
MISCELLANEOUS BACKFILL BELOW UNPAVED.	
NON-BUILDING AREAS	90%
ROADWAY PAVEMENT SUBGRADE	95%
SIDEWALK SUBGRADE	90%
CURB AND GUTTER SUBGRADE	95%

PAVEMENT

WHEN ABUTTING NEW PAVEMENT TO EXISTING PAVEMENT. CUT EXISTING PAVEMENT EDGE TO A NEAT, STRAIGHT LINE AS NECESSARY TO REMOVE ANY BROKEN OR CRACKED PAVEMENT AND MATCH NEW PAVEMENT ELEVATION TO

ALL UTILITIES AND UTILITY SERVICE LINES SHALL BE INSTALLED AND APPROVED PRIOR TO PAVING.

ALL WATER VALVE BOXES AND ELECTRICAL, TELEPHONE, TELEVISION, AND SEWER MANHOLES IN THE CONSTRUCTION AREA SHALL BE ADJUSTED TO FINISHED GRADE BEFORE PAVING.

WHEN SIDEWALK OR CURB AND GUTTER IS REMOVED, IT SHALL BE REMOVED TO EXISTING CONSTRUCTION JOINTS. CUTTING OR BREAKING SHALL NOT BE ALLOWED.

LEGEND	

	EX BLOCK WALL	*	LIGHT POLE		EX SD INLET
x G 89.5	EX SPOT ELEV.	A	EX FIRE HYDRANT	, 14	CONCRETE
◆ <u>FL 09.3</u>	PROP SPOT ELEV.	•	EX WATER VALVE		EX WATER METER
 5160	EX BLOCK WALL	©	EX SD MANHOLE		EXIST. TREE
\boxtimes	TRANSFORMER	S	EX SAS MANHOLE		

UTILITIES

IF ANY UTILITY LINES. PIPELINES. OR UNDERGROUND UTILITY LINES ARE SHOWN ON THESE DRAWINGS. THEY ARE SHOWN IN AN APPROXIMATE LOCATION ONLY BASED ON THE INFORMATION PROVIDED TO THE ENGINEER BY OTHERS. THIS INFORMATION MAY BE INACCURATE OR INCOMPLETE. ADDITIONALLY, UNDERGROUND LINES MAY EXIST THAT ARE NOT SHOWN. THE CONTRACTOR SHALL VERIFY THE LOCATION OF ANY UTILITY LINE, PIPELINE, OR UNDERGROUND UTILITY LINE IN OR NEAR THE AREA OF THE WORK IN ACCORDANCE WITH CHAPTER 62, ARTICLE 14-1. THROUGH 14-8. NMSA 1978.

THE CONTRACTOR SHALL CONTACT THE STATEWIDE UTILITY LOCATOR SERVICE AT 1-800-321-2537 AT LEAST TWO WORKING DAYS BEFORE BEGINNING CONSTRUCTION. AFTER THE UTILITIES ARE SPOTTED. THE CONTRACTOR SHALL EXPOSE ALL PERTINENT UTILITIES TO VERIFY THEIR VERTICAL AND HORIZONTAL LOCATION. IF A CONFLICT EXISTS BETWEEN EXISTING UTILITIES AND PROPOSED CONSTRUCTION, THE CONTRACTOR SHALL NOTIFY THE ENGINEER SO THAT THE CONFLICT CAN BE RESOLVED WITH MINIMAL DELAY.

THE CONTRACTOR SHALL EXERCISE DUE CARE TO AVOID DISTURBING ANY EXISTING UTILITIES, ABOVE OR BELOW GROUND. UTILITIES THAT ARE DAMAGED BY CARELESS CONSTRUCTION SHALL BE REPAIRED OR REPLACED AT THE CONTRACTOR'S EXPENSE.

EXISTING VALVES SHALL ONLY BE OPERATED BY THE UTILITY COMPANY. CONTRACTOR SHALL NOTIFY THE UTILITY A MINIMUM OF TWO WORKING DAYS BEFORE ANY VALVE, NEW OR EXISTING, NEEDS TO BE OPERATED.

THE CONTRACTOR SHALL COORDINATE ANY REQUIRED UTILITY INTERRUPTIONS WITH THE OWNER AND AFFECTED UTILITY COMPANY A MINIMUM OF THREE WORKING DAYS BEFORE THE INTERRUPTION.

THE CONTRACTOR SHALL MAINTAIN A RECORD DRAWING SET OF PLANS AND PROMPTLY LOCATE ALL UTILITIES. EXITING OR NEW, IN THEIR CORRECT LOCATION, HORIZONTAL AND VERTICAL. THIS RECORD SET OF DRAWINGS SHALL BE MAINTAINED ON THE PROJECT SITE AND SHALL BE AVAILABLE TO THE OWNER AND ENGINEER AT ANY TIME DURING CONSTRUCTION.

EROSION CONTROL. ENVIRONMENTAL PROTECTION, AND STORM WATER POLLUTION PREVENTION PLAN

THE CONTRACTOR SHALL CONFORM TO ALL CITY, COUNTY, STATE, AND FEDERAL DUST AND EROSION CONTROL REGULATIONS. THE CONTRACTOR SHALL OBTAIN AND PREPARE ANY DUST CONTROL OR EROSION CONTROL PERMITS REQUIRED FROM THE REGULATORY AGENCIES.

THE CONTRACTOR SHALL PROMPTLY REMOVE ANY MATERIAL EXCAVATED WITH THE PUBLIC RIGHT-OF-WAY OR ADJACENT PROPERTY TO KEEP IT FROM WASHING OFF THE PROJECT SITE.

THE CONTRACTOR SHALL ENSURE THAT NO SOIL ERODES FROM THE SITE ONTO ADJACENT PROPERTY BY CONSTRUCTION OF TEMPORARY EROSION CONTROL BERMS OR INSTALLING SILT FENCES AT THE PROPERTY LINES AND WETTING THE SOIL TO PREVENT IT FROM BLOWING.

WATERING, AS REQUIRED FOR CONSTRUCTION DUST CONTROL, SHALL BE CONSIDERED INCIDENTAL TO CONSTRUCTION AND NO MEASUREMENT OR PAYMENT SHALL BE MADE. CONSTRUCTION AREAS SHALL BE WATERED FOR DUST CONTROL IN COMPLIANCE WITH GOVERNMENT ORDINANCES. THE CONTRACTOR SHALL BE RESPONSIBLE FOR LOCATING AND SUPPLYING WATER AS REQUIRED.

ANY AREAS DISTURBED BY CONSTRUCTION AND NOT COVERED BY LANDSCAPING OR IMPERVIOUS SURFACES SHALL BE REVEGETATED WITH RECLAMATION SEEDING.

THE CONTRACTOR SHALL PROPERLY HANDLE AND DISPOSE OF ALL ASPHALT REMOVED ON THE PROJECT BY HAULING IT TO AN APPROVED DISPOSAL SITE IN ACCORDANCE WITH THE REQUIREMENTS OF THE NEW MEXICO SOLID WASTE ACT.

ALL WASTE PRODUCTS FROM THE CONSTRUCTION SITE, INCLUDING ITEMS DESIGNED FOR REMOVAL. CONSTRUCTION WASTE, CONSTRUCTION EQUIPMENT WASTE PRODUCTS (OIL, GAS, TIRES, ETC.), GARBAGE, GRUBBING, EXCESS CUT MATERIAL, VEGETATIVE DEBRIS, ETC., SHALL BE APPROPRIATELY DISPOSED OF OFFSET AT NO ADDITIONAL COST TO THE OWNER. IT SHALL BE THE CONTRACTOR'S RESPONSIBILITY TO OBTAIN ANY PERMITS REQUIRED FOR HAUL OR DISPOSAL OF WASTE PRODUCTS, IT SHALL BE THE CONTRACTOR'S RESPONSIBILITY TO ENSURE THAT THE WASTE DISPOSAL SITE COMPLIES WITH GOVERNMENT REGULATIONS REGARDING THE ENVIRONMENT, ENDANGERED SPECIES. AND ARCHAEOLOGICAL RESOURCES.

THE CONTRACTOR SHALL BE RESPONSIBLE FOR THE CLEANUP AND REPORTING OF SPILLS OF HAZARDOUS MATERIALS ASSOCIATED WITH THE CONSTRUCTION SITE. HAZARDOUS MATERIALS INCLUDE GASOLINE, DIESEL FUEL. MOTOR OIL SOLVENTS, CHEMICALS, PAINT, ETC. WHICH MAY BE A THREAT TO THE ENVIRONMENT. THE CONTRACTOR SHALL REPORT THE DISCOVERY OF PAST OR PRESENT SPILLS TO THE NEW MEXICO EMERGENCY RESPONSE AT 1-800-219-6157.

THE CONTRACTOR SHALL COMPLY WITH ALL APPLICABLE REGULATIONS CONCERNING SURFACE AND UNDERGROUND WATER. CONTACT WITH SURFACE WATER BY CONSTRUCTION EQUIPMENT AND PERSONNEL SHALL BE MINIMIZED. EQUIPMENT MAINTENANCE AND REFUELING OPERATIONS SHALL BE PERFORMED IN AN ENVIRONMENTALLY SAFE MANNER IN COMPLIANCE WITH GOVERNMENT REGULATIONS.

THE CONTRACTOR SHALL COMPLY WITH ALL APPLICABLE REGULATIONS CONCERNING CONSTRUCTION NOISE AND HOURS OF OPERATION.

ACCESSIBLE FACILITIES

ALL SURFACES ALONG ACCESSIBLE ROUTES AND FOR HANDICAP RAMPS SHALL BE STABLE FIRM, SLIDE RESISTANT AND SHALL COMPLY WITH UNIFORM FEDERAL ACCESSIBILITY STANDARDS, PARAGRAPH 4.5.

LONGITUDINAL SLOPES ALONG ACCESSIBLE ROUTE SIDEWALKS, EXCEPT AT HANDICAP RAMPS, SHALL NOT BE STEEPER THAN 1:20. CROSS SLOPES ALONG ACCESSIBLE ROUTE SIDEWALKS EXCEPT AT HANDICAP RAMPS, SHALL NOT BE STEEPER THAN 1: 48. SLOPES IN ACCESSIBLE PARKING SPACES, ACCESS AISLES, AND PASSENGER LOADING ZONES SHALL NOT BE STEEPER THAN 1:48 IN ALL DIRECTIONS.


THE SITE SHALL COMPLY WITH ANSI A117.1-1992, "ACCESSIBLE AND USABLE BUILDINGS AND FACILITIES".

TRAFFIC CONTROL

THE CONTRACTOR SHALL PROVIDE ALL REQUIRED TRAFFIC CONTROL PLANS. ALL SIGNS, BARRICADES. CHANNELIZATION DEVICES, SIGN FRAMES AND ERECTION OF SUCH DEVICES SHALL CONFORM TO THE REQUIREMENTS OF " MANUAL OF UNIFORM TRAFFIC CONTROL DEVICES FOR STREETS AND HIGHWAYS" LATEST EDITION. PRIOR TO CONSTRUCTION, TRAFFIC CONTROL PLANS SHALL BE APPROVED BY THE GOVERNING AUTHORITY.

BENCHMARK CABLE TELEVISION LINE CLEANOUT CITY OF ALBUQUERQUE			Z ₋
CABLE TELEVISION LINE CLEANOUT			n D
CLEANOUT			\supset
CIT OF ALBUQUERQUE			മധ
CONCRETE			I L
CONCRETE			S
CENTERLINE			
			டエ
			шО
			⊢ ∝
			⋖
			⊢ ∢
			ARCHITECT S
GAS PIPE			
GAS METER			
GATE VALVE			ENGINEERS
INVERT ELEVATION			, WR
LINEAL FEET			THE STATE OF THE S
LIGHT POLE			L Mass
LANDSCAPING			人類人
MANHOLE			
NATURAL GROUND			
OVERHEAD ELECTRIC LINE			PROJECT
OVERHEAD TELEPHONE LINE			
PORTLAND CEMENT CONCRETE			
POWER POLE			
PROPOSED			>
POLYVINYL CHLORIDE PIPE			FACILITY
REINFORCED CONCRETE PIPE		en North Control of the Control of t	<u>=</u>
RIGHT-OF-WAY			Ă
SLOPE			
SANITARY SEWER		1	ASH
STORM DRAIN			Ă
STATION			>
STANDARD			CAR W
SIDEWALK			\prec
TELEPHONE			
TOP OF ASPHALT PAVEMENT			NEW
TOP OF CONCRETE SLAB (PAVEMENT)			当
TOP OF CONCRETE CURB			_
TOP OF GRATE			
TOP OF SIDEWALK			
TOP OF WALL			
TYPICAL	9		REVISIONS
JNDERGROUND ELECTRIC			
JNDERGROUND TELEPHONE			•
WATER			
VATER METER		/	
			DATE
VATER VALVE	* / * **		
WATER VALVE	. 호선 		NORTH
WATER VALVE		•	NORTH
	GAS METER GATE VALVE NVERT ELEVATION LINEAL FEET LIGHT POLE LANDSCAPING MANHOLE NATURAL GROUND DVERHEAD ELECTRIC LINE DVERHEAD TELEPHONE LINE PORTLAND CEMENT CONCRETE POWER POLE PROPOSED POLYVINYL CHLORIDE PIPE REINFORCED CONCRETE PIPE RIGHT-OF-WAY SLOPE SANITARY SEWER STORM DRAIN STATION STANDARD SIDEWALK TELEPHONE TOP OF ASPHALT PAVEMENT TOP OF CONCRETE SLAB (PAVEMENT) TOP OF CONCRETE CURB TOP OF GRATE TOP OF SIDEWALK TOP OF SIDEWALK TOP OF SIDEWALK TOP OF SIDEWALK TOP OF WALL TYPICAL UNDERGROUND ELECTRIC UNDERGROUND TELEPHONE	DETAIL DRAWING ELECTRIC LINE ELECTRIC LINE ELECTRIC CHE ENER HYDRANT CHOW LINE EASA PIPE EASA METER BATE VALVE NVERT ELEVATION LINEAL FEET LIGHT POLE ANDSCAPING AMHOLE NATURAL GROUND DVERNEAD ELECTRIC LINE EVERHEAD ELECTRIC LINE EVERHEAD TELEPHONE LINE POPERLAND CEMENT CONCRETE FROPOSED POLYMNYL CHLORIDE PIPE ELENFORGED GONGRETE FIPE STORM DRAIN STANDARD SIDEWALK ELEPHONE COP OF ASPHALT PAVEMENT COP OF CONCRETE SLAB (PAVEMENT) COP OF CONCRETE SLAB (PAVEMENT) COP OF GRATE COP OF SIDEWALK OP OF SIDEWALK OP OF SIDEWALK OP OF SIDEWALK OP OF WALL TYPICAL INDERGROUND TELEPHONE	DETAIL PRAMING ELECTRIC LINE INSISTED GRADE RISE HYDRANT I-LOW LINE BASE PIPE BASE METER BASE PALVE AND ELECTRIC LINE INSISTED FROM INSISTED


 \supset L I ARCHITECT SEAL

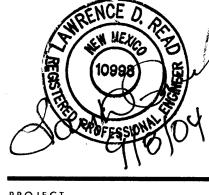

 α B Ш \propto

August 25, 2003 SCALE

1"=20'

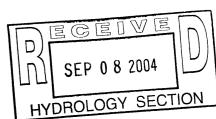


GENERAL NOTES

SHEET NUMBER


LARRY READ & ASSOCIATES

Civil Engineers 4800-C Juan Tabo, NE Albuquerque, New Mexico 87111 (505) 237-8421

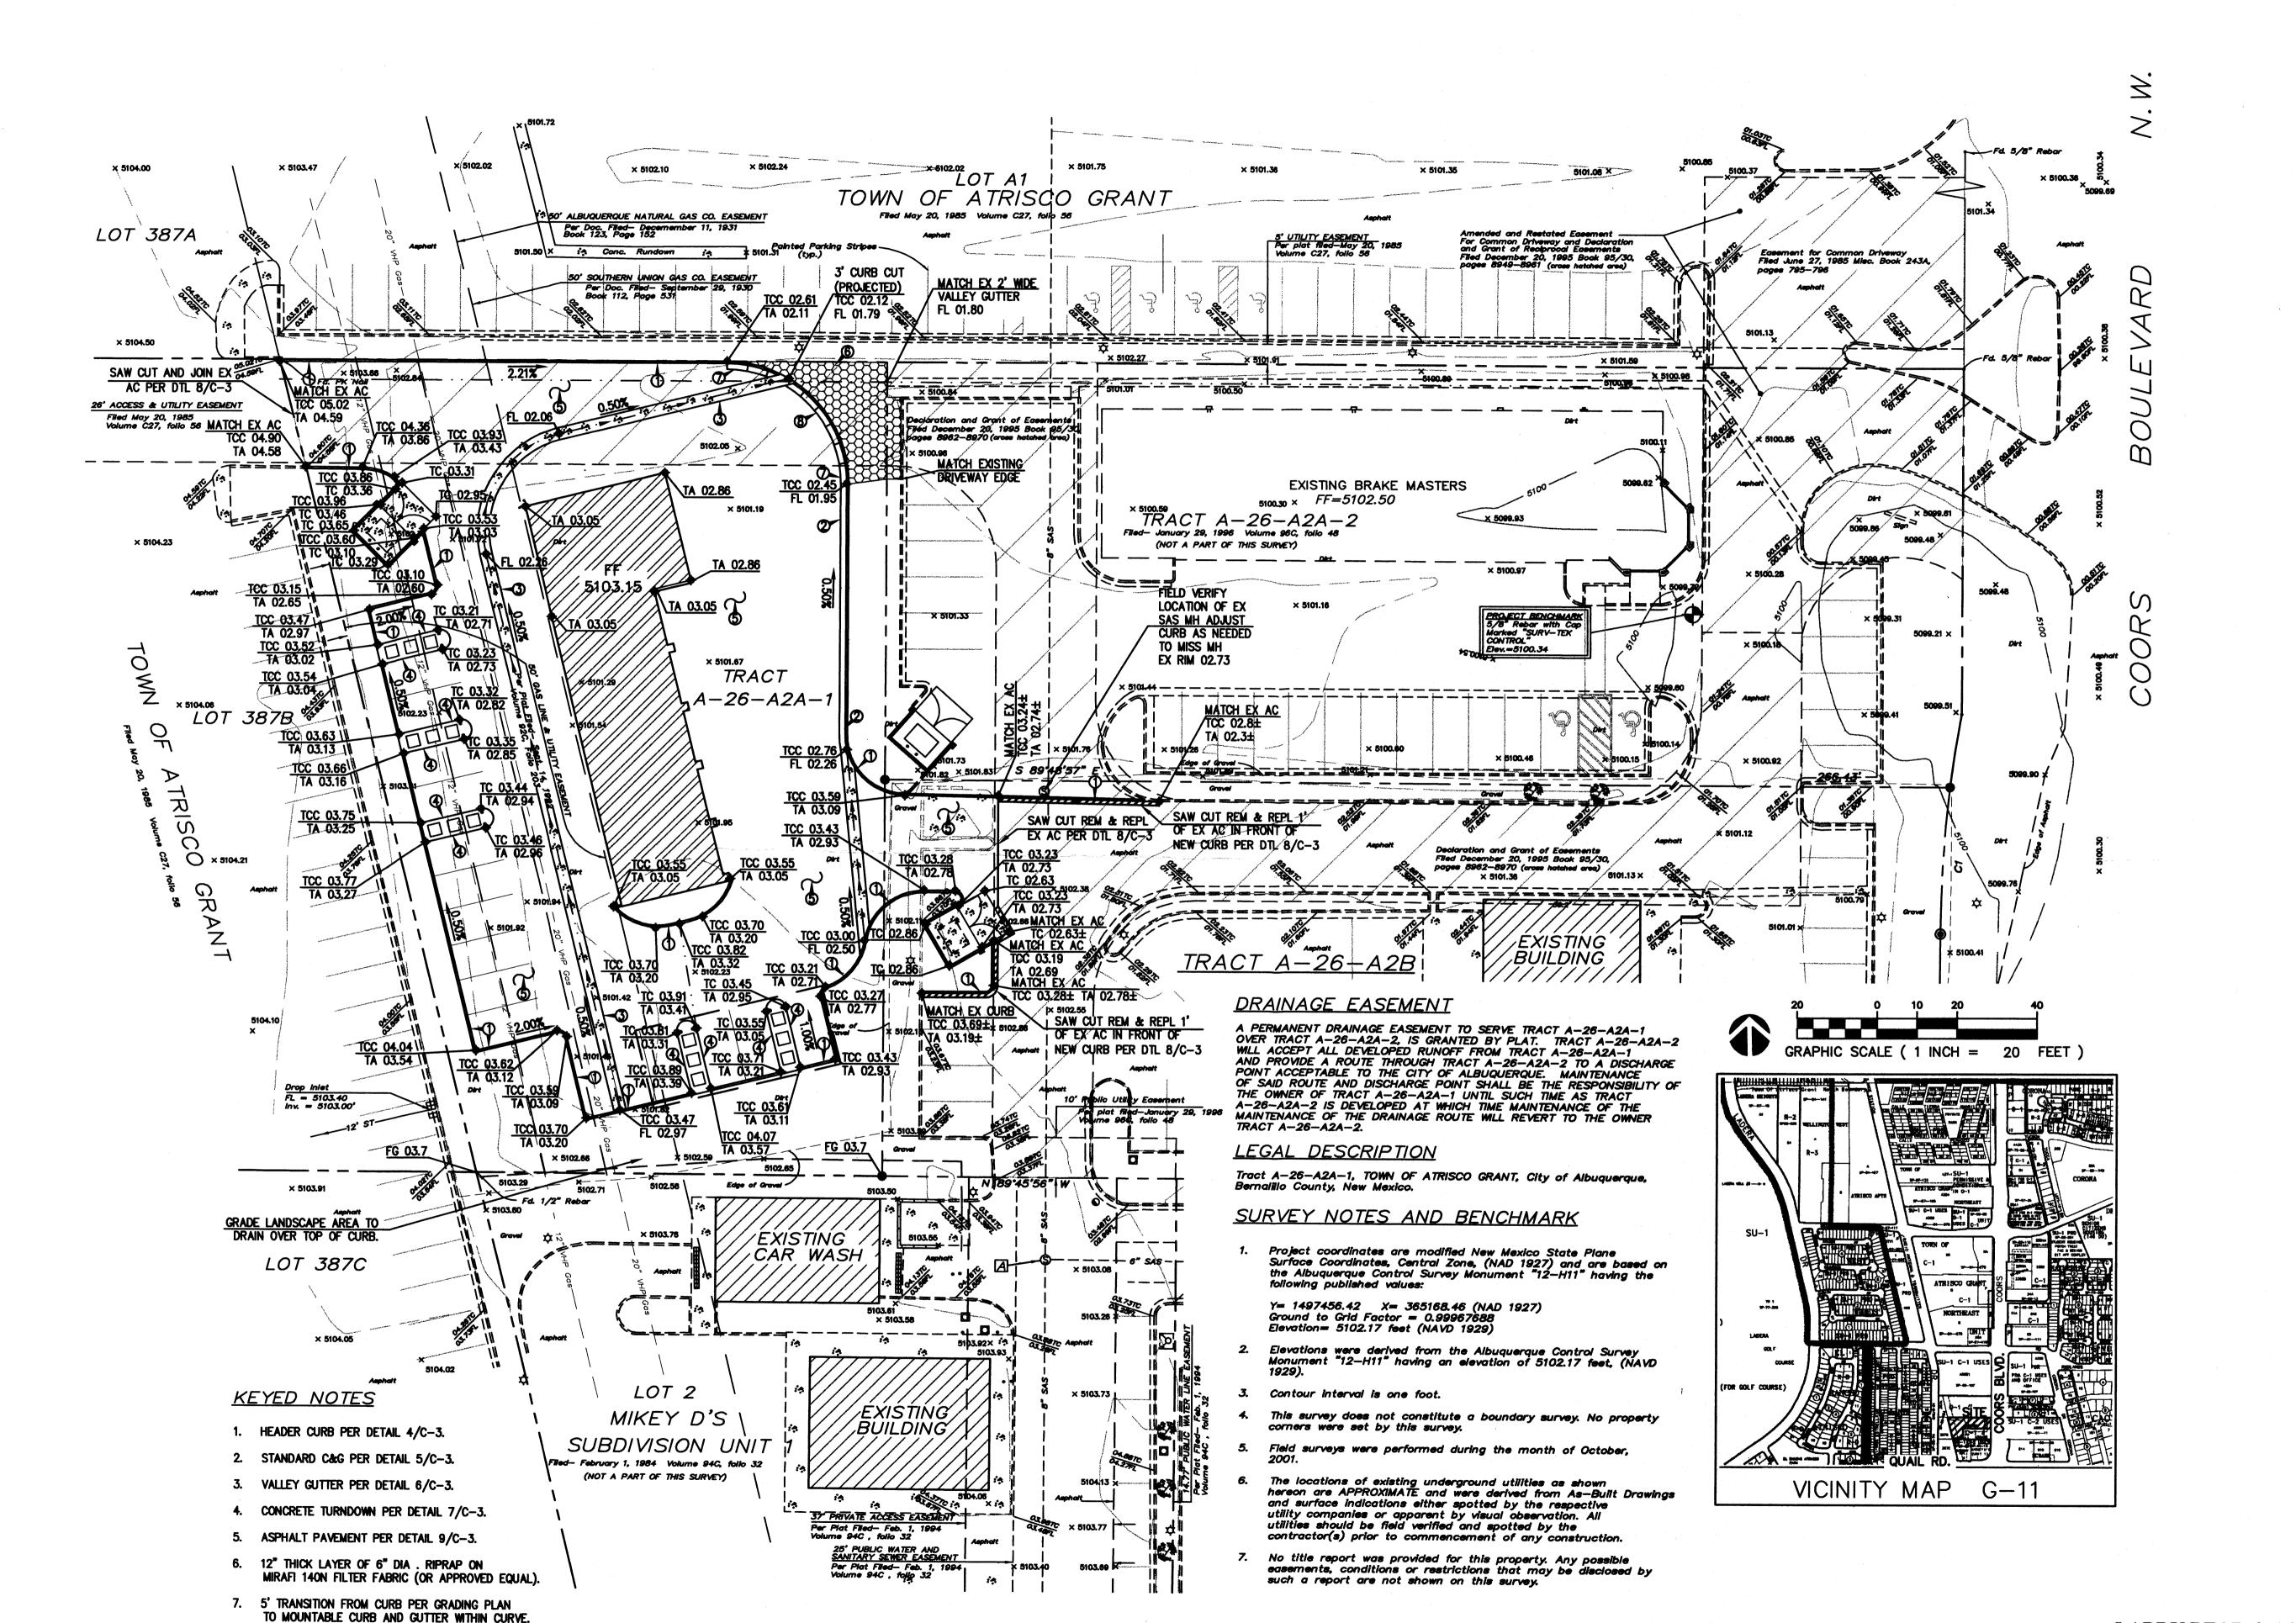

8. MOUNTABLE C&G PER DETAIL 10/C-3.

TATEFISHBURN

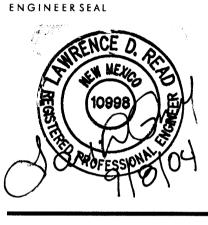

PROJECT

COORS BLVD. & QUAIL RD., NW Albuquerque, New Mexico

REVISIONS

August 25, 2003

NORTH S C A




GRADING PLAN


1"=20'


LARRY READ & ASSOCIATES


Civil Engineers

4800-C Juan Tabo, NE Albuquerque, New Mexico 87111 (505) 237-8421 C-2

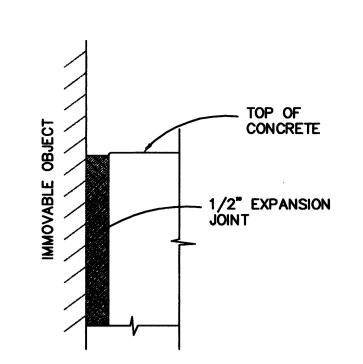


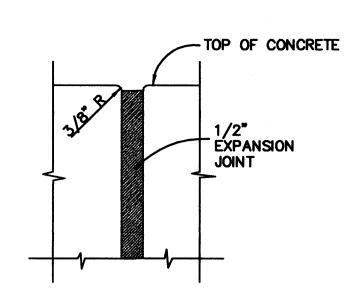

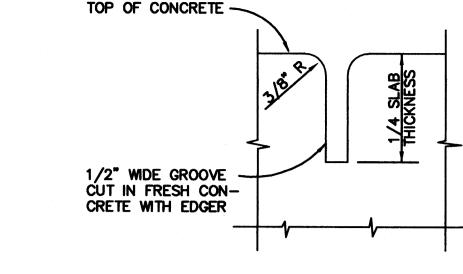

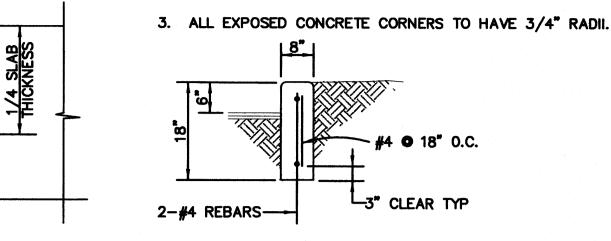


CONSTRUCTION NOTES:

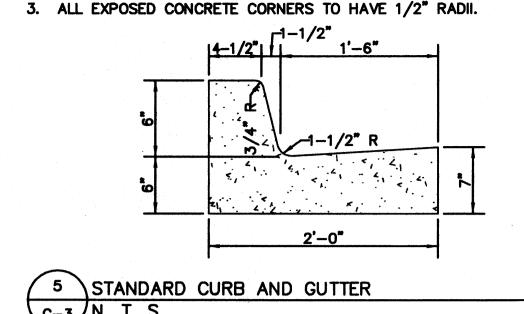

PROVIDE 1/2" EXPANSION JOINTS AT 36' O.C., AT IMMOVABLE OBJECTS AND AT THE BEGINNING AND END OF CURVES.

CONSTRUCTION NOTES:

2. PROVIDE CONTRACTION JOINTS AT 6' O.C.

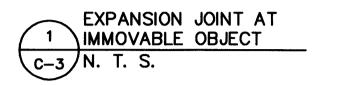


1. PROVIDE 1/2" EXPANSION JOINTS AT 36' O.C., AT IMMOVABLE


CONCRETE VALLEY GUTTER

2. PROVIDE CONTRACTION JOINTS • 6' O.C. PER DETAIL THIS SHEET

OBJECTS AND AT PERPENDICULAR CURBS PER DETAIL THIS SHEET


CONSTRUCTION NOTES:

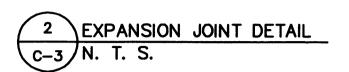


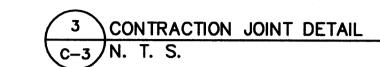

CONSTRUCTION NOTES:

- 1. 1/2" EXPANSION JOINTS SHALL BE INSTALLED WHERE CONCRETE ABUTS RIGID STRUCTURES, SUCH AS CURBS, BUILDINGS, OR LIGHT STANDARDS. SEE DETAIL THIS SHEET.
- 2. CONCRETE SHALL HAVE CONTRACTION JOINTS AT 6' INTERVALS, UNLESS OTHERWISE SHOWN ON PLANS. SEE DETAIL THIS SHEET.

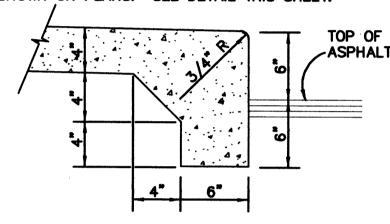

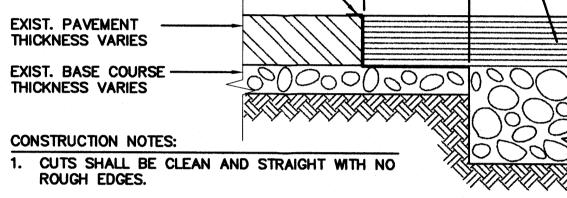


TACK COAT -


1. PROVIDE 1/2" EXPANSION JOINTS AT 36' O.C., AT IMMOVABLE OBJECTS, AND AT THE BEGINNING AND END OF CURVES.

2. PROVIDE CONTRACTION JOINTS • 6' O.C.


CONCRETE HEADER CURB DETAIL



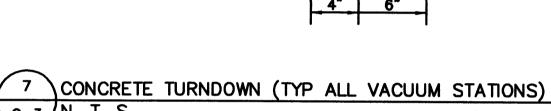

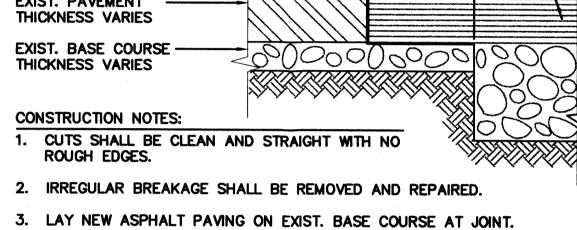




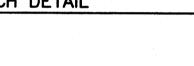

NEW PAVEMENT (SEE_

DETAIL THIS SHEET)

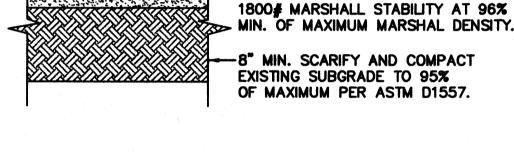

2" ASPHALTIC CONCRETE PAVEMENT

CLASS B PER COA STANDARD

-SPECIFICATIONS SECTION 116.

DRAINAGE REPORT

6" MIN. SCARIFY

AND RECOMPACT

OF MAXIMUM PER ASTM D1557.

SUBGRADE TO 95%

EXISTING

LOCATION & DESCRIPTION

THE PROPOSED SITE IS 0.59 ACRES, LOCATED ON THE WEST END OF LOT A-26-A2A, AS SHOWN ON THE GRADING PLAN ON SHEET C-2. LOT A-26-A2A IS LOCATED NORTH OF QUAIL ROAD AND WEST OF COORS BOULEVARD, AS SHOWN ON THE VICINITY MAP ON SHEET C-2. ALL OF THE PROPERTIES AROUND THIS SITE ARE ALREADY DEVELOPED AND UTILIZE FREE DISCHARGE TO COORS BOULEVARD WHERE THE FLOW IS INTERCEPTED BY A STORM DRAIN. THIS LOT HAS A SLIGHT SLOPE TOWARD COORS BOULEVARD ENABLING IT TO DRAIN TO THE EAST.

FLOODPLAIN STATUS

THIS PROJECT, AS SHOWN ON FEMA'S FLOOD INSURANCE RATE MAP 35001C0337 D, DATED SEPTEMBER 20, 1996 IS NOT WITHIN ANY DESIGNATED 100-YEAR FLOODPLAIN. THE SITE IS DESIGNATED ON THE FIRM PANEL ON THIS SHEET.

METHODOLOGY

THE HYDROLOGY FOR THIS PROJECT WAS ANALYZED USING THE QUICK CALCULATIONS OF THE JUNE 1997 RELEASE OF THE CITY OF ALBUQUERQUE DEVELOPMENT PROCESS MANUAL, SECTION 22.2.

PRECIPITATION


THE 100-YR 6-HR DURATION STORM WAS USED AS THE DESIGN STORM FOR THIS ANALYSIS. THIS SITE IS WITHIN ZONE 1 AS IDENTIFIED IN THE CITY OF ALBUQUERQUE DEVELOPMENT PROCESS MANUAL, SECTION 22.2. TABLES WITHIN THIS SECTION WAS USED TO ESTABLISH THE 6-HOUR PRECIPITATION, EXCESS PRECIPITATION, AND PEAK DISCHARGE.

EXISTING DRAINAGE

THE SITE IS UNDEVELOPED AS DESCRIBED IN "LOCATION AND DESCRIPTION" ABOVE. ALL OF THE ADJACENT SITES HAVE BEEN FILLED TO DRAIN AWAY FROM THIS PROPERTY. THEREFORE, THERE ARE NO OFF SITE BASINS CONTRIBUTING DRAINAGE TO THIS SITE. A STORM DRAIN IN COORS BOULEVARD HAS BEEN DESIGNED AND CONSTRUCTED TO INTERCEPT DEVELOPED FLOWS FROM THIS TRACT OF LAND.


DEVELOPED CONDITION

AT THIS TIME THE REMAINING 0.59 ACRES OF THE 1.24 ACRE SITE WILL BE DEVELOPED AS A CAR WASH. THE REMAINING 0.64 ACRES HAS PREVIOUSLY BEEN DEVELOPED AS A BRAKEMASTERS FACILITY WITH ASSOCIATED PARKING. THE "100-YEAR HYDROLOGIC CALCULATIONS", ON THIS SHEET, DEMONSTRATE THAT THIS DEVELOPMENT WILL INCREASE THE RUNOFF FROM THIS SITE FROM 0.77 CFS TO 2.36 CFS. HOWEVER, THE AREA BEING DEVELOPED AS A CAR WASH IS ONLY 73.66% IMPERVIOUS WHICH IS LESS THAN THE DPM SECTION 22.2 ALLOWANCE OF 90% FOR COMMERCIAL SITES. THEREFORE, THIS DEVELOPMENT DISCHARGES LESS RUNOFF THAN WHAT WAS ANTICIPATED WHEN THE COORS STORM DRAIN WAS DESIGNED. GRADES HAVE BEEN SET TO ASSURE THAT SURFACE RUNOFF WILL CONTINUE TO CROSS THE BRAKEMASTERS PORTION OF THIS LOT AND DRAIN TO COORS BOULEVARD. THEREFORE, THIS SITE CAN BE DEVELOPED ACCORDING TO THIS GRADING AND DRAINAGE PLAN WITHOUT ADVERSELY AFFECTING DOWNSTREAM PROPERTY.

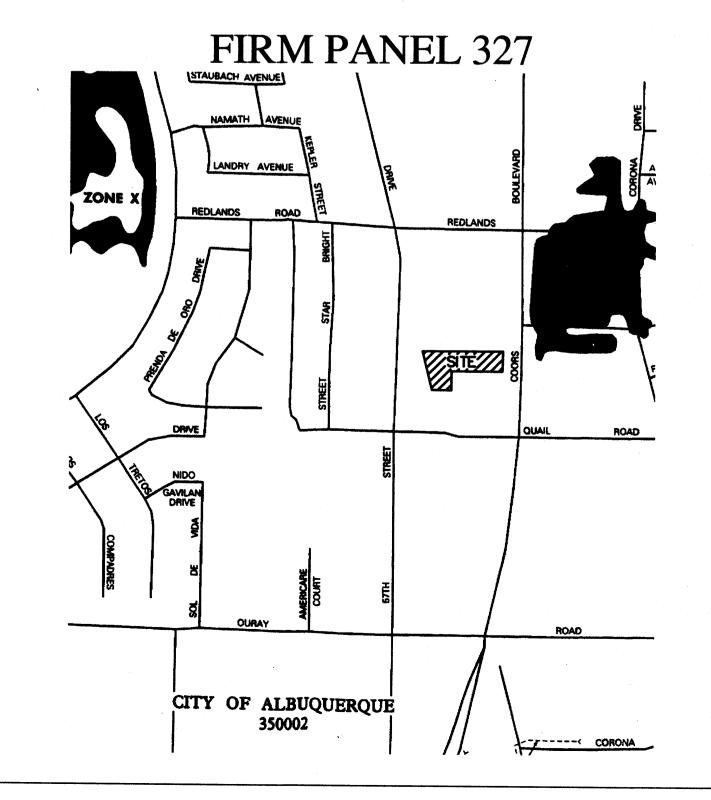

CONSTRUCTION NOTES:

- PROVIDE 1/2" EXPANSION JOINTS AT 36' O.C., AT IMMOVABLE OBJECTS AND AT THE BEGINNING AND END OF CURVES.
- 2. PROVIDE CONTRACTION JOINTS AT 6' O.C.
- 3. ALL EXPOSED CONCRETE CORNERS TO HAVE 1/2" RADII.

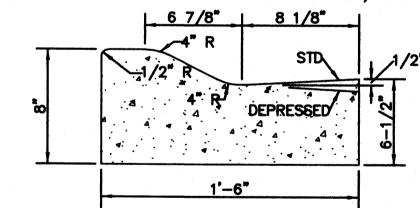

10 MOUNTABLE CURB AND GUTTER

	LAND TREATMENT			T	WEIGHTED				i i		
BASIN	AREA	A	В	C	D] E	V (6-hr)	V (6-hr)	V(10 day)	V(10 day)	Q
#	(acre)	(%)	(%)	(%)	(%)	(in)	(acre-ft)	(cu-ft)	(acre-ft)	(cu-ft)	(cfs)
					EXIST	NG CONDITIO	NS		,	<u> </u>	
CAR WASH	0.5938	100.00	0.00	0.00	0.00	0.44	0.02	948	0.02	948	0.77
EMAINDER	0.6442	0.00	5.00	5.00	90.00	1.86	0.10	4,340	0.17	7,434	2.69
TOTAL	1.2380				7.79		0.12	5,288	0.19	8,382	3.46
					PROPO	BED CONDITION	ONS				
CAR WASH	0.5938	0.00	0.00	26.34	73.66	1.71	0.08	3,690	0.14	6,024	2.36
EMAINDER	0.6442	0.00	5.00	5.00	90.00	1.86	0.10	4,340	0.17	7,434	2.69
TOTAL	1.2380						0.18	8,030	0.31	13,457	5.05
EXCESS P	RECIP.	0.44	0.67	0.99	1.97	E (in)				•	
PEAK DISC	HARGE	1.29	2.03	2.87	4.37	On (cfs)					
									ZONE =	1	
VEIGHTED E	$(in) = (E_A)$	(%A) + (E	a)(%B) +	(Ec)(%C)	+ (Eo)(9	6D)			Peur (in.) =	2.20	
/e-ra (acre-ft) :									Pauer (in.) =		
10DAY (acre-ft)	= Vaum + (ADYP HODAY	- Pupy	12					P100AY (in.) =		

LARRY READ & ASSOCIATES
Civil Engineers 4800-C Juan Tabo, NE Albuquerque, New Mexico 87111 (505) 237-8421

ARCHITECT SEAL

ENGINEERSEAL

PROJECT

 ≈ 4 BLV UER SS Q

REVISIONS


August 25, 2003

1"=20


DRAWING NAME

DETAILS AND DRAINAGE PLAN


SHEET NUMBER

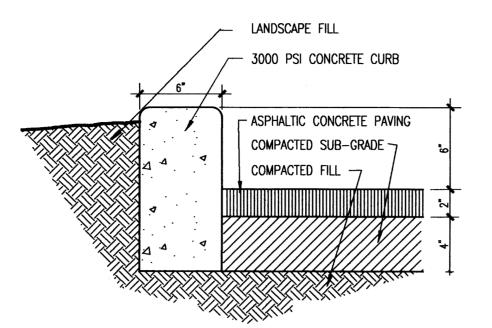


TYPICAL CURB DETAIL

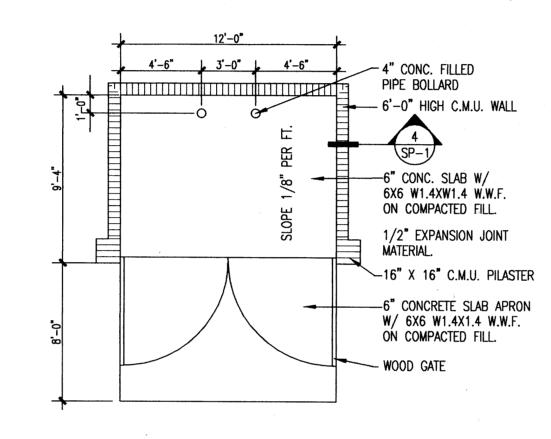


TRASH ENCLOSURE

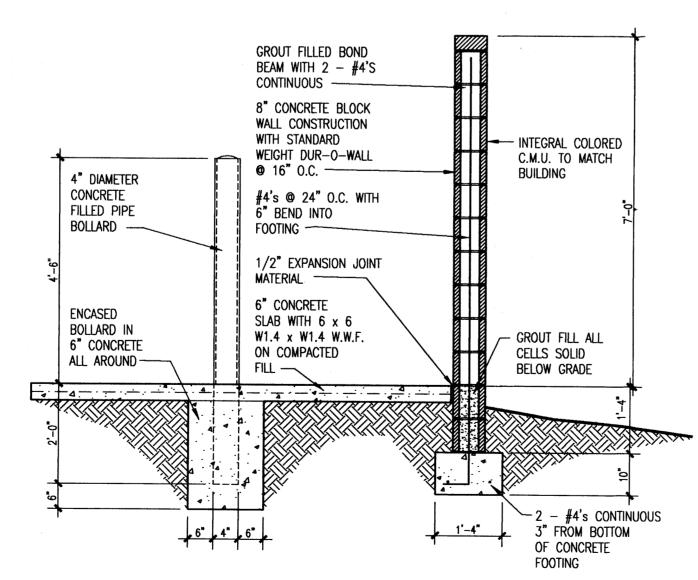

SECTION THRU ENCLOSURE WALL

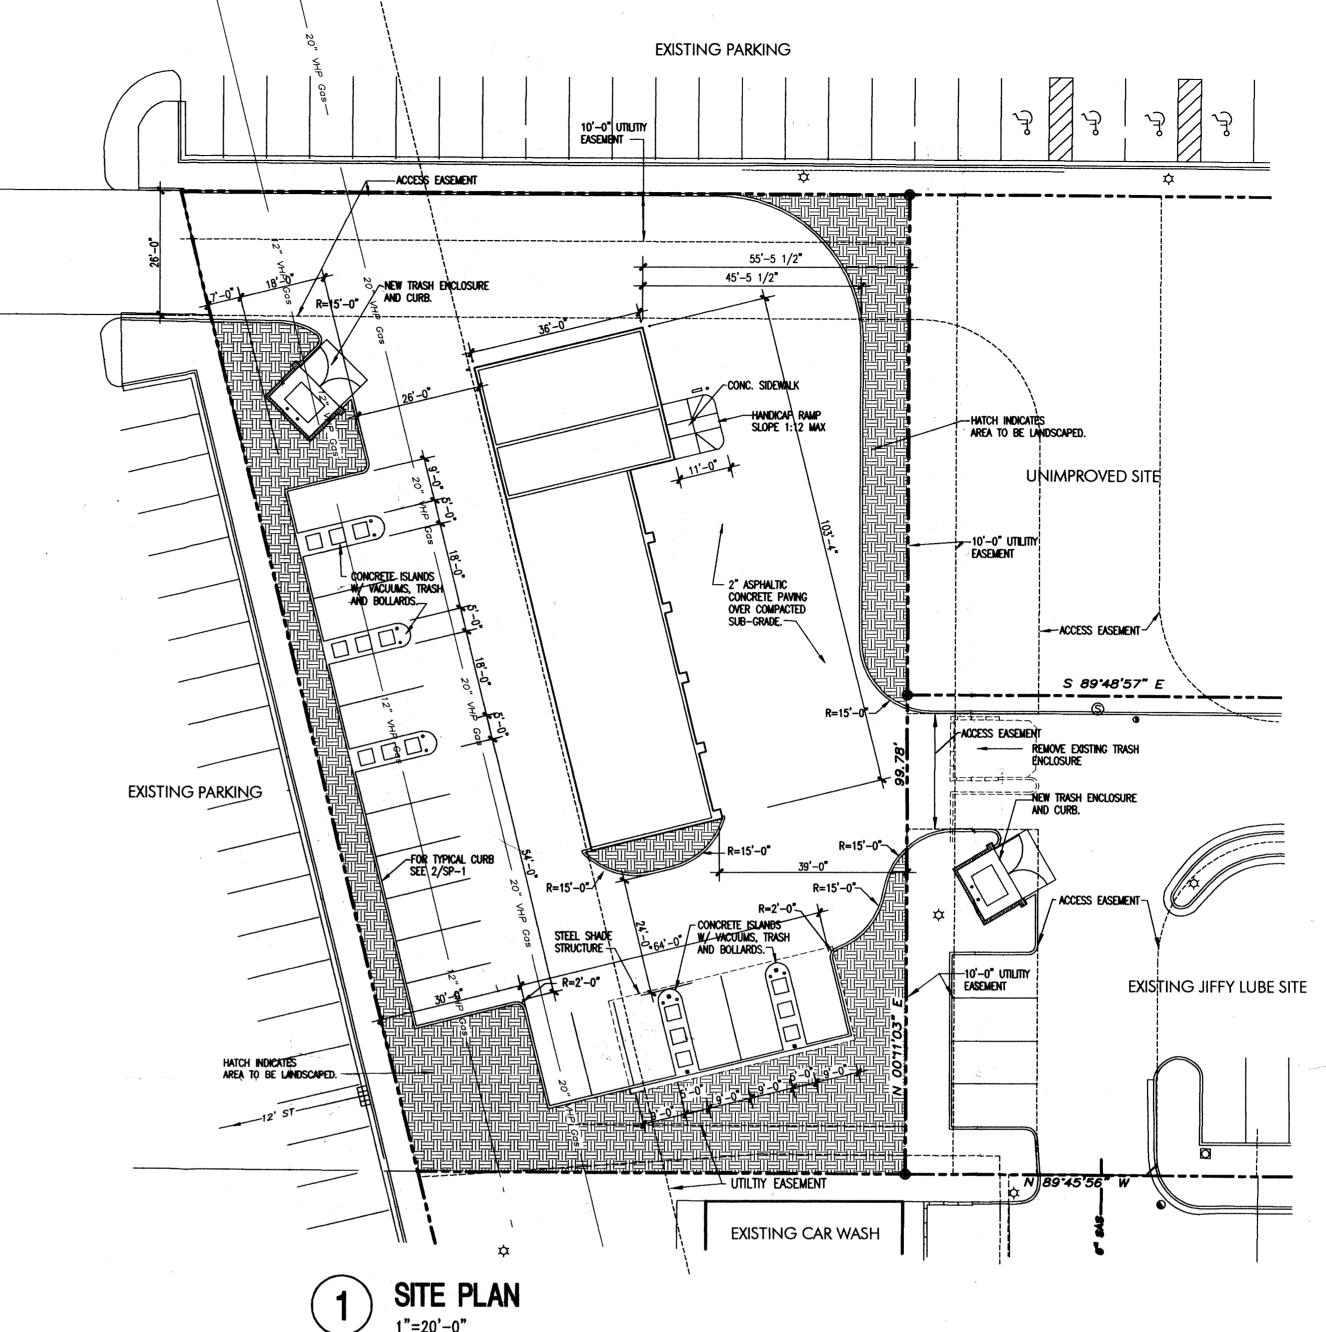

SITE PLAN
1"=20'-0"

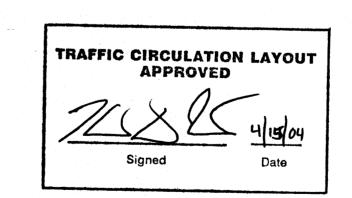

PROJECT: INFORMATION

PROJECT: LOCATION: OWNER:

NEW SELF-SERVE CAR WASH 2923 COORS BLVD., N.W.

PURPLE SAGE, LLC 20 VISTA SANDIA CT. PLACITAS, NM 87043 867-3167

ARCHITECT: TATE FISHBURN ARCHITECT LEGAL DESCRIPTION:

TRACT A-26-A2A-1
TOWN OF ATRISCO GRANT
ZONE ATLAS H-11-Z CURRENT ZONING CLASSIFICATION: C-1 TYPE CONSTRUCTION: TYPE VN OCCUPANCY:

ALLOWABLE AREA: TYPE V-N CONSTRUCTION & B OCCUPANCY = 8,000 GROSS BUILDING AREA: 2,880 S.F.

NET BUILDING AREA: 264 S.F.

OCCUPANT LOAD: 264/100 = 3 OCCUPANTS

EXIT WIDTH REQUIRED: 1 INCH EXIT WIDTH PROVIDED: 36 INCHES NUMBER OF EXITS PROVIDED: ONE TOTAL TOTAL LOT AREA: .59 ACRES +/-

PARKING ANALYSIS: NET AREA = 264 264 / 200 =2 REQUIRED SPACES

SPACES REQUIRED = 2 SPACES PROVIDED = 17 SPACES

SITE PLAN

APRIL 8, 2004

SCALE

1"=20'-0"

REVISIONS

DRAWING NAME

H<mark>eet number</mark>

 \simeq

 \supset

 \bot \bot

шО


ARCHITECT SEAL


ENGINEER SEAL


PROJECT


2923 COORS BLVD., Albuquerque, new M

SEISMIC ZONE:

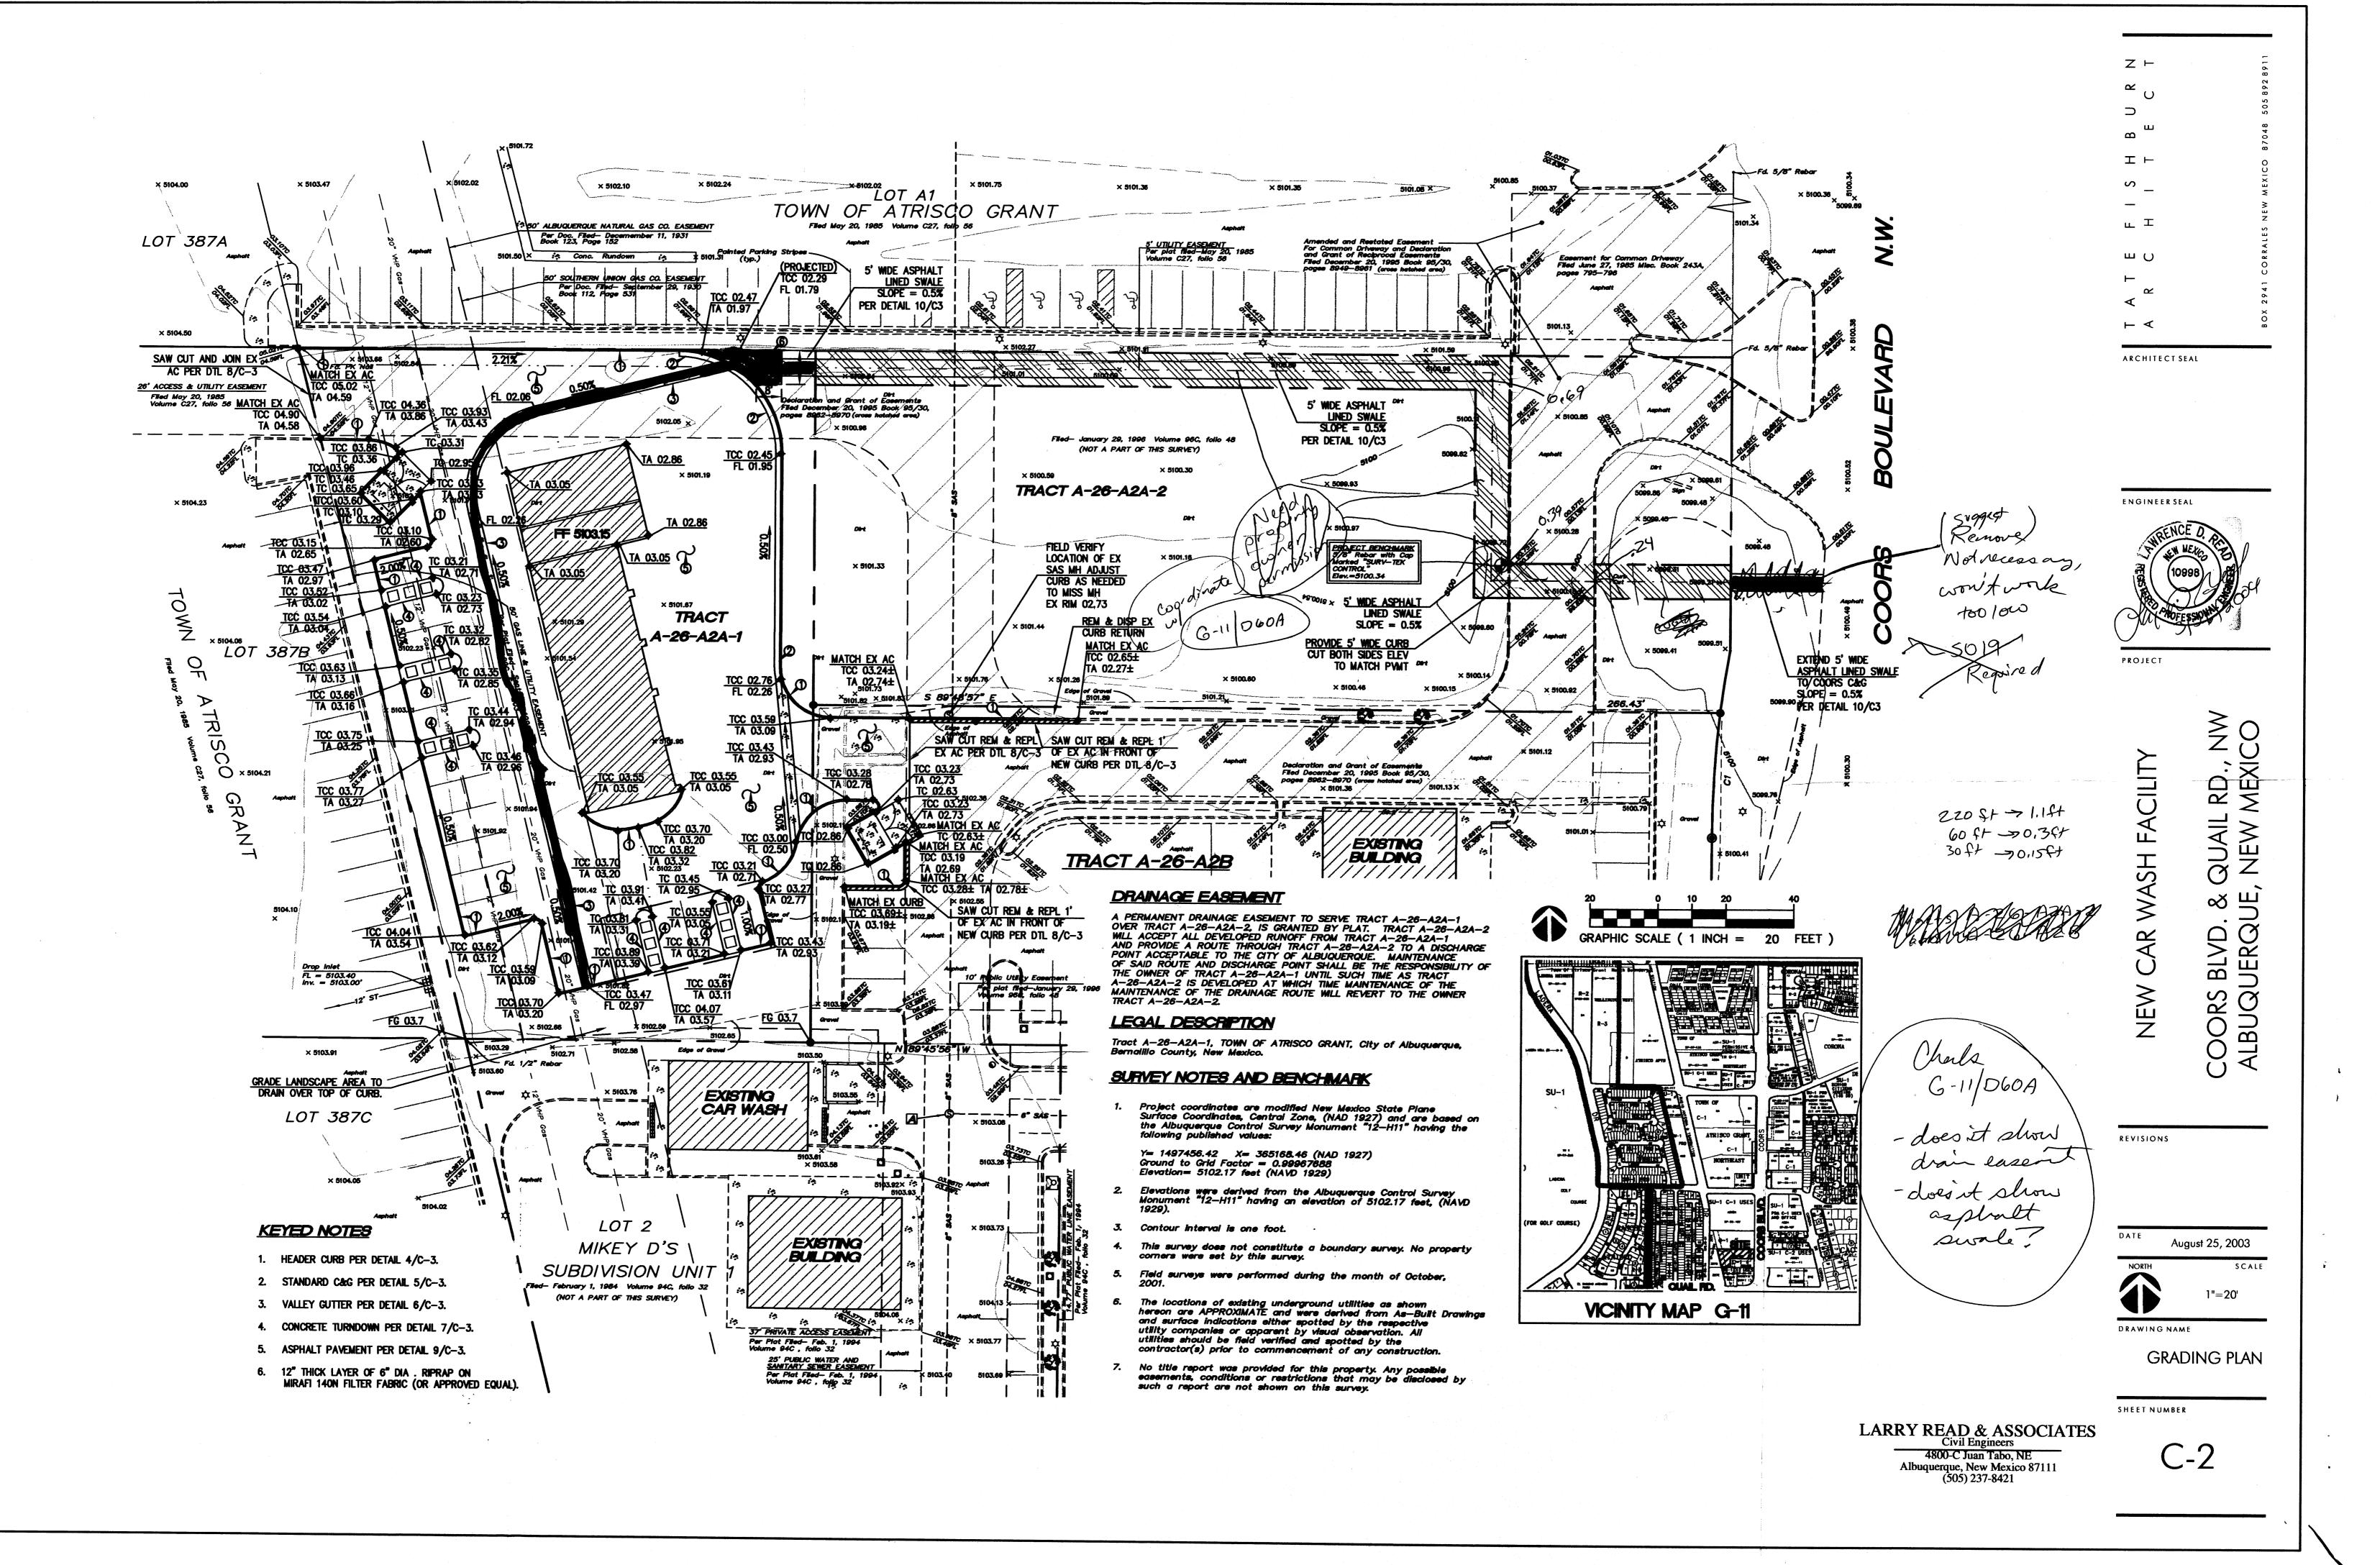


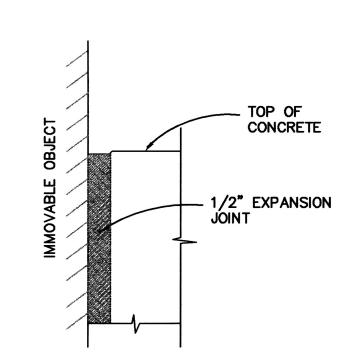


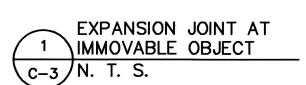

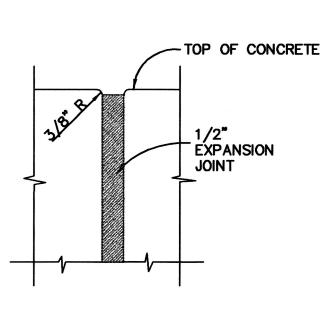


2 EXPANSION JOINT DETAIL

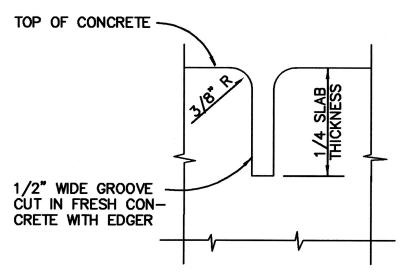


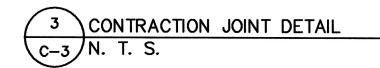


1. PROVIDE 1/2" EXPANSION JOINTS AT 36' O.C., AT IMMOVABLE OBJECTS, AND AT THE BEGINNING AND END OF CURVES. 2. PROVIDE CONTRACTION JOINTS @ 6' O.C. 3. ALL EXPOSED CONCRETE CORNERS TO HAVE 3/4" RADII.

CONSTRUCTION NOTES:

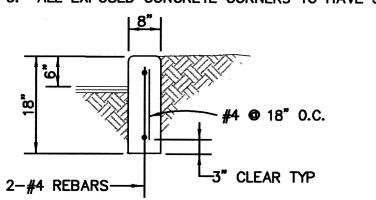

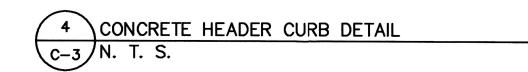

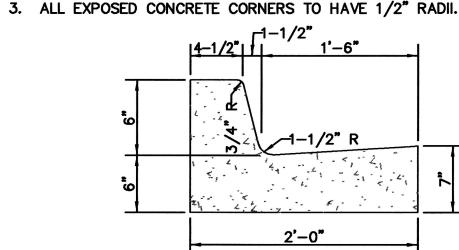

1. PROVIDE 1/2" EXPANSION JOINTS AT 36' O.C., AT IMMOVABLE


OBJECTS AND AT THE BEGINNING AND END OF CURVES.



ASPHALT PAVEMENT SECTION

2. PROVIDE CONTRACTION JOINTS AT 6' O.C.

CONSTRUCTION NOTES:

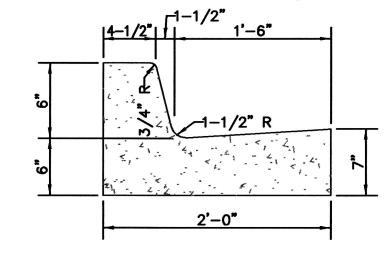

2" ASPHALTIC CONCRETE PAVEMENT


1800# MARSHALL STABILITY AT 96% MIN. OF MAXIMUM MARSHAL DENSITY.


CLASS B PER COA STANDARD -SPECIFICATIONS SECTION 116.

-8" MIN. SCARIFY AND COMPACT

EXISTING SUBGRADE TO 95%

OF MAXIMUM PER ASTM D1557.

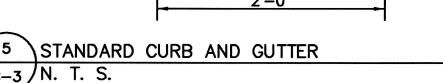

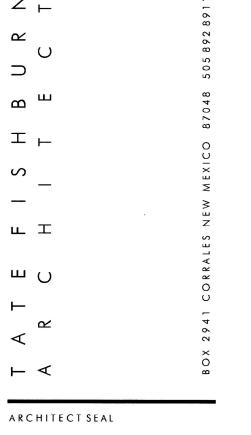



PROJECT

QU/ NE/ BLVD. UERQI

COORS

REVISIONS

August 25, 2003

1"=20'

SCALE

DRAWING NAME DETAILS AND DRAINAGE PLAN

SHEET NUMBER


LARRY READ & ASSOCIATES
Civil Engineers

4800-C Juan Tabo, NE Albuquerque, New Mexico 87111 (505) 237-8421

CONSTRUCTION NOTES:

PROVIDE 1/2" EXPANSION JOINTS AT 36' O.C., AT IMMOVABLE OBJECTS AND AT PERPENDICULAR CURBS PER DETAIL THIS SHEET

2. PROVIDE CONTRACTION JOINTS @ 6' O.C. PER DETAIL THIS SHEET

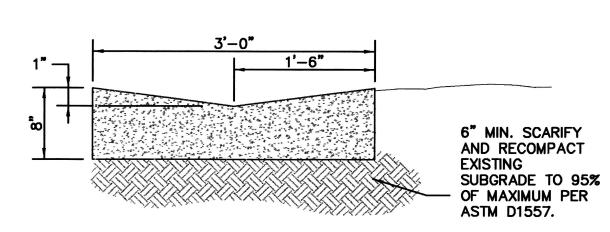


6 \CONCRETE VALLEY GUTTER


CONSTRUCTION NOTES:

1. 1/2" EXPANSION JOINTS SHALL BE INSTALLED WHERE CONCRETE ABUTS RIGID STRUCTURES, SUCH AS CURBS, BUILDINGS, OR LIGHT STANDARDS. SEE DETAIL THIS SHEET.

2. CONCRETE SHALL HAVE CONTRACTION JOINTS AT 6' INTERVALS, UNLESS OTHERWISE SHOWN ON PLANS. SEE DETAIL THIS SHEET.

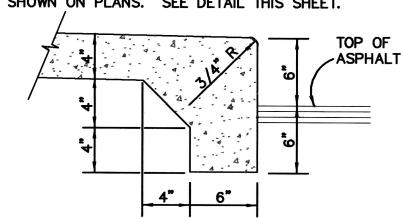


CONCRETE TURNDOWN (TYP ALL VACUUM STATIONS)

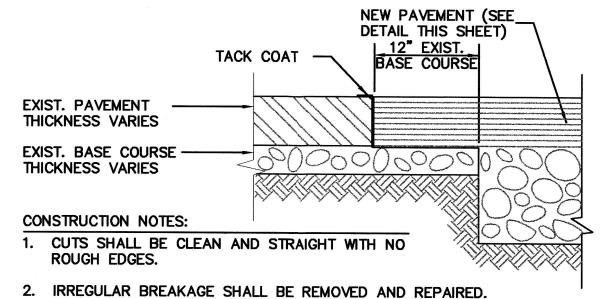

- 3. LAY NEW ASPHALT PAVING ON EXIST. BASE COURSE AT JOINT.

8 \PAVEMENT CUT AND PATCH DETAIL C-3 N. T. S.



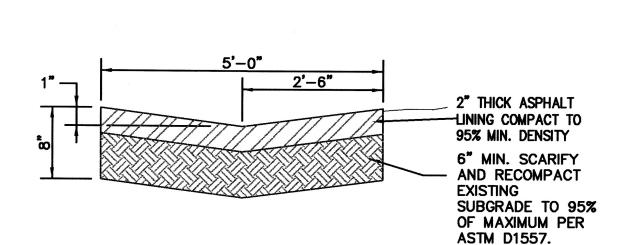

TEMPORARY ASPHALT SWALE

DRAINAGE REPORT

LOCATION & DESCRIPTION

THE **PROPOSED SITE IS 0.59 ACRES,** LOCATED ON THE WEST END OF LOT A-26-A2A, AS SHOWN ON THE GRADING PLAN ON SHEET C-2. LOT A-26-A2A IS LOCATED NORTH OF QUAIL ROAD AND WEST OF COORS BOULEVARD, AS SHOWN ON THE VICINITY MAP ON SHEET C-2. ALL OF THE PROPERTIES AROUND THIS SITE ARE ALREADY DEVELOPED AND UTILIZE FREE DISCHARGE TO COORS BOULEVARD WHERE THE FLOW IS INTERCEPTED BY A STORM DRAIN. THIS LOT HAS A SLIGHT SLOPE TOWARD COORS BOULEVARD ENABLING IT TO DRAIN TO THE EAST.

FLOODPLAIN STATUS

THIS PROJECT, AS SHOWN ON FEMA'S FLOOD INSURANCE RATE MAP 35001C0337 D, DATED SEPTEMBER 20, 1996 IS DESIGNATED 100—YEAR FLOODPLAIN. THE SITE IS DESIGNATED ON THE FIRM PANEL ON THIS SHEET.

METHODOLOGY

THE HYDROLOGY FOR THIS PROJECT WAS ANALYZED USING THE QUICK CALCULATIONS OF THE JUNE 1997 RELEASE OF THE CITY OF ALBUQUERQUE DEVELOPMENT PROCESS MANUAL, SECTION 22.2.

PRECIPITATION


THE 100-YR 6-HR DURATION STORM WAS USED AS THE DESIGN STORM FOR THIS ANALYSIS. THIS SITE IS WITHIN ZONE 1 AS IDENTIFIED IN THE CITY OF ALBUQUERQUE DEVELOPMENT PROCESS MANUAL, SECTION 22.2. TABLES WITHIN THIS SECTION WAS USED TO ESTABLISH THE 6-HOUR PRECIPITATION, EXCESS PRECIPITATION, AND PEAK DISCHARGE.

EXISTING DRAINAGE

THE SITE IS UNDEVELOPED AS DESCRIBED IN "LOCATION AND DESCRIPTION" ABOVE. ALL OF THE ADJACENT SITES HAVE BEEN FILLED TO DRAIN AWAY FROM THIS PROPERTY. THEREFORE, THERE ARE NO OFF SITE BASINS CONTRIBUTING DRAINAGE TO THIS SITE. A STORM DRAIN IN COORS BOULEVARD HAS BEEN DESIGNED AND CONSTRUCTED TO INTERCEPT DEVELOPED FLOWS FROM THIS TRACT OF LAND.

DEVELOPED CONDITION

AT THIS TIME ONLY 0.59 ACRES OF THE 1.24 ACRE SITE WILL BE DEVELOPED AS A CAR WASH. THE REMAINING 0.64 ACRES WILL AT THIS TIME ONLY 0.59 ACRES OF THE 1.24 ACRE SITE WILL BE DEVELOPED AS A CAR WASH. THE REMAINING 0.64 ACRES WILL REMAIN UNDEVELOPED. THE "100—YEAR HYDROLOGIC CALCULATIONS", ON THIS SHEET, DEMONSTRATE THAT THIS DEVELOPMENT WILL INCREASE THE RUNOFF FROM THIS SITE FROM 0.77 CFS TO 2.36 CFS.) HOWEVER, THE AREA BEING DEVELOPED AS A CAR WASH IS ONLY 73.66% IMPERVIOUS WHICH IS LESS THAN THE DPM SECTION—22.2 ALLOWANCE OF 90% FOR COMMERCIAL SITES. THEREFORE, THIS DEVELOPMENT DISCHARGES LESS RUNOFF THAN WHAT WAS ANTICIPATED WHEN THE COORS STORM DRAIN WAS DESIGNED. GRADES HAVE BEEN SET TO ASSURE THAT SURFACE RUNOFF WILL CONTINUE TO CROSS THE UNDEVELOPED PORTION OF THIS LOT AND DRAIN TO COORS BOULEVARD WITHOUT OBSTRUCTING FUTURE DEVELOPMENT ON THE REMAINDER OF THE LOT. THEREFORE, THIS SITE CAN BE DEVELOPED ACCORDING TO THIS GRADING AND DRAINAGE PLAN WITHOUT ADVERSELY AFFECTING DOWNSTDEAM PROPERTY. WITHOUT ADVERSELY AFFECTING DOWNSTREAM PROPERTY.

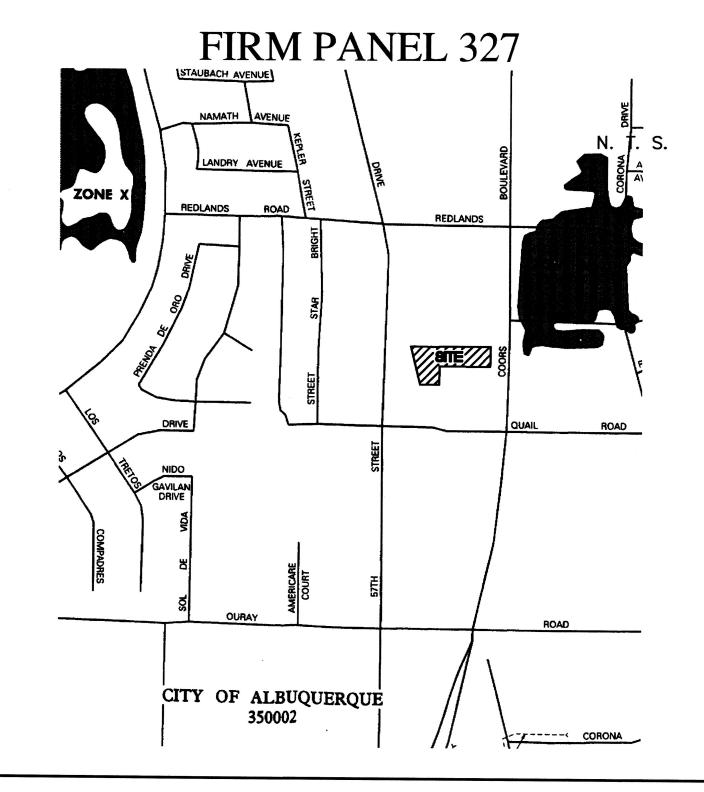

> 8		L	AND TR	EATMEN	T	WEIGHTED			T		
BASIN	AREA	Α	В	С	D	E	V (6-hr)	V (6-hr)	V(10 day)	V(10 day)	Q
#	(acre)	(%)	(%)	(%)	(%)	(in)	(acre-ft)	(cu-ft)	(acre-ft)	(cu-ft)	(cfs)
					EXISTIN	IG CONDITIO	NS				
CAR WASH	0.5938	100.00	0.00	0.00	0.00	0.44	0.02	948	0.02	948	0.77
REMAINDER	0.6442	75.62	0.00	10.83	13.54	0.71	0.04	1,653	0.05	2,118	1.21
TOTAL	1.2380						0.06	2,601	0.07	3,067	1.98
					PROPOS	ED CONDITION	ONS				
CAR WASH	0.5938	0.00	0.00	26.34	73.66	1.71	0.08	3,690	0.14	6,024	2.36
REMAINDER	0.6442	75.62	0.00	10.83	13.54	0.71	0.04	1,653	0.05	2,118	1.21
TOTAL	1.2380						0.12	5,343	0.19	8,142	3.57
										-,	
EXCESS P	RECIP.	0.44	0.67	0.99	1.97	Ei (in)					
PEAK DISC	HARGE	1.29	2.03	2.87	4.37	Q _{Pi} (cfs)					
									ZONE =	1	
WEIGHTED E (in) = $(E_A)(\%A) + (E_B)(\%B) + (E_C)(\%C) + (E_D)(\%D)$									P _{6-HR} (in.) =	2.20	
Vs-нк (acre-ft) :	(WEIGHT	ΓED E)(Al	REA)/12			•			P _{24-HR} (in.) =		
V10DAY (acre-ft)				2							
	- V6-HR + (, (Aa) + (Qpb								P100AY (in.) =	3.67	

GENERAL

CONTRACTOR IS RESPONSIBLE FOR OBTAINING ALL REQUIRED CONSTRUCTION PERMITS, INCLUDING A TOP SOIL DISTURBANCE PERMIT. PRIOR TO START OF CONSTRUCTION.

ALL WORK ON THIS PROJECT SHALL BE PERFORMED IN ACCORDANCE WITH APPLICABLE FEDERAL, STATE, AND LOCAL LAWS, ORDINANCES, AND REGULATIONS CONCERNING CONSTRUCTION SAFETY AND HEALTH.

REFERENCES MADE TO STANDARD SPECIFICATIONS AND STANDARD DRAWINGS REFER TO THE CITY OF ALBUQUERQUE STANDARD SPECIFICATIONS FOR PUBLIC WORKS CONSTRUCTION, 1986 EDITION WITH ALL UPDATES.

THE CONTRACTOR SHALL NOT INSTALL ITEMS AS SHOWN ON THESE PLANS WHEN IT IS OBVIOUS THAT FIELD CONDITIONS ARE DIFFERENT THAN SHOWN IN THE PLANS. SUCH CONDITIONS SHALL BE BROUGHT TO THE ATTENTION OF THE ENGINEER IN A TIMELY MANNER. IN THE EVENT THE CONTRACTOR DOES NOT NOTIFY THE ENGINEER IN A TIMELY MANNER, THE CONTRACTOR ASSUMES FULL RESPONSIBILITY AND EXPENSE FOR ANY REVISIONS NECESSARY, INCLUDING ENGINEERING DESIGN FEES.

EXISTING SITE IMPROVEMENTS WHICH ARE DAMAGED OR DISPLACED BY THE CONTRACTOR SHALL BE REMOVED AND REPLACED BY THE CONTRACTOR AT THE CONTRACTOR'S EXPENSE. REPAIRS SHALL BE APPROVED BY THE OWNER PRIOR TO CONSTRUCTION OF THE REPAIRS. REPAIRS SHALL BE ACCEPTED BY THE OWNER PRIOR TO FINAL

EXISTING FENCING THAT IS NOT DESIGNATED FOR REMOVAL SHALL NOT BE DISTURBED. ANY FENCING THAT IS DISTURBED OR ALTERED BY THE CONTRACTOR SHALL BE RESTORED TO ITS ORIGINAL CONDITION AT THE CONTRACTORS EXPENSE. IF THE CONTRACTOR DESIRES TO REMOVE FENCING TO ACCOMMODATE CONSTRUCTION ACTIVITIES. THE CONTRACTOR SHALL OBTAIN THE OWNER'S WRITTEN PERMISSION BEFORE THE FENCE IS REMOVED. CONTRACTOR SHALL RESTORE THE FENCE TO ITS ORIGINAL CONDITION AT THE EARLIEST OPPORTUNITY. WHILE ANY FENCING IS REMOVED, THE CONTRACTOR SHALL BE SOLELY RESPONSIBLE FOR SECURITY OF THE SITE UNTIL THE FENCE IS RESTORED.

WORK WITHIN ADJACENT RIGHT-OF-WAY

PRIOR TO BEGINNING ANY CONSTRUCTION ACTIVITIES WITHIN ADJACENT RIGHT-OF-WAYS OR WITHIN PROPERTY NOT OWNED BY THE OWNER OF THE PROJECT SITE, THE CONTRACTOR SHALL ASSURE THAT ALL PERMITS AND PERMISSIONS REQUIRED HAVE BEEN OBTAINED IN WRITING.

SURVEY MONUMENTS. PROPERTY CORNERS. BENCHMARKS

THE CONTRACTOR SHALL NOTIFY THE OWNER AT LEAST SEVEN DAYS BEFORE BEGINNING ANY CONSTRUCTION ACTIVITY THAT COULD DAMAGE OR DISPLACE SURVEY MONUMENTS, PROPERTY CORNERS, OR PROJECT BENCHMARKS SO THESE ITEMS MAY BE RELOCATED.

ANY SURVEY MONUMENTS. PROPERTY CORNERS. OR BENCHMARKS THAT ARE NOT IDENTIFIED FOR RELOCATION ARE THE RESPONSIBILITY OF THE CONTRACTOR TO PRESERVE AND PROTECT, RELOCATION OR REPLACEMENT OF THESE ITEMS SHALL BE DONE BY THE OWNER'S SURVEYOR AT THE EXPENSE OF THE CONTRACTOR.

DIMENSIONS

ALL DIMENSIONS TO CURBS ARE TO THE FLOWLINE UNLESS OTHERWISE NOTED.

ALL STATIONING IS TO THE CENTERLINE OF THE RIGHT-OF-WAY UNLESS OTHERWISE NOTED.

ALL SLOPES AND GRADES ARE IN PERCENT UNLESS OTHERWISE NOTED.

CURB ELEVATIONS ARE SHOWN AT THE FLOW LINE UNLESS OTHERWISE NOTED. SEE THE DETAIL SHEET TO DETERMINE THE CURB HEIGHT ABOVE FLOW LINE.

UNLESS OTHERWISE SPECIFIED, SUBGRADE, ENGINEERED FILL, AND STRUCTURAL FILL SHALL BE COMPACTED TO THE FOLLOWING SPECIFICATIONS OF THE ASTM D-1557 MAXIMUM DRY DENSITY.

MATERIAL/LOCATION	PERCENT COMPACTION
STRUCTURAL FILL IN THE BUILDING AREA	95%
SUBBASE FOR SLAB SUPPORT	95%
MISCELLANEOUS BACKFILL BELOW STRUCTURAL	_
FILL OR ROADWAY PAVEMENT	95%
MISCELLANEOUS BACKFILL BELOW UNPAVED,	
NON-BUILDING AREAS	90%
ROADWAY PAVEMENT SUBGRADE	95%
SIDEWALK SUBGRADE	90%
CURB AND GUTTER SUBGRADE	95%

PAVEMENT

WHEN ABUTTING NEW PAVEMENT TO EXISTING PAVEMENT, CUT EXISTING PAVEMENT EDGE TO A NEAT, STRAIGHT LINE AS NECESSARY TO REMOVE ANY BROKEN OR CRACKED PAVEMENT AND MATCH NEW PAVEMENT ELEVATION TO

ALL UTILITIES AND UTILITY SERVICE LINES SHALL BE INSTALLED AND APPROVED PRIOR TO PAVING.

ALL WATER VALVE BOXES AND ELECTRICAL, TELEPHONE, TELEVISION, AND SEWER MANHOLES IN THE CONSTRUCTION AREA SHALL BE ADJUSTED TO FINISHED GRADE BEFORE PAYING.

WHEN SIDEWALK OR CURB AND GUTTER IS REMOVED, IT SHALL BE REMOVED TO EXISTING CONSTRUCTION JOINTS. CUTTING OR BREAKING SHALL NOT BE ALLOWED.

LEGEND	

	EX BLOCK WALL	\$	LIGHT POLE	(1)	EX SD INLET
x G 89.5	EX SPOT ELEV.	A	EX FIRE HYDRANT	is	CONCRETE
♠ FL 09.3	PROP SPOT ELEV.	•	EX WATER VALVE		EX WATER METER
 5160	EX BLOCK WALL	o	EX SD MANHOLE	€	EXIST. TREE
\boxtimes	TRANSFORMER	S	EX SAS MANHOLE		

IF ANY UTILITY LINES, PIPELINES, OR UNDERGROUND UTILITY LINES ARE SHOWN ON THESE DRAWINGS. THEY ARE SHOWN IN AN APPROXIMATE LOCATION ONLY BASED ON THE INFORMATION PROVIDED TO THE ENGINEER BY OTHERS. THIS INFORMATION MAY BE INACCURATE OR INCOMPLETE. ADDITIONALLY, UNDERGROUND LINES MAY EXIST THAT ARE NOT SHOWN. THE CONTRACTOR SHALL VERIFY THE LOCATION OF ANY UTILITY LINE, PIPELINE, OR UNDERGROUND UTILITY LINE IN OR NEAR THE AREA OF THE WORK IN ACCORDANCE WITH CHAPTER 62. ARTICLE 14-1. THROUGH 14-8. NMSA 1978.

THE CONTRACTOR SHALL CONTACT THE STATEWIDE UTILITY LOCATOR SERVICE AT 1-800-321-2537 AT LEAST TWO WORKING DAYS BEFORE BEGINNING CONSTRUCTION. AFTER THE UTILITIES ARE SPOTTED. THE CONTRACTOR SHALL EXPOSE ALL PERTINENT UTILITIES TO VERIFY THEIR VERTICAL AND HORIZONTAL LOCATION. IF A CONFLICT EXISTS BETWEEN EXISTING UTILITIES AND PROPOSED CONSTRUCTION, THE CONTRACTOR SHALL NOTIFY THE ENGINEER SO THAT THE CONFLICT CAN BE RESOLVED WITH MINIMAL DELAY.

THE CONTRACTOR SHALL EXERCISE DUE CARE TO AVOID DISTURBING ANY EXISTING UTILITIES, ABOVE OR BELOW GROUND. UTILITIES THAT ARE DAMAGED BY CARELESS CONSTRUCTION SHALL BE REPAIRED OR REPLACED AT THE CONTRACTOR'S EXPENSE.

EXISTING VALVES SHALL ONLY BE OPERATED BY THE UTILITY COMPANY. CONTRACTOR SHALL NOTIFY THE UTILITY A MINIMUM OF TWO WORKING DAYS BEFORE ANY VALVE, NEW OR EXISTING, NEEDS TO BE OPERATED.

THE CONTRACTOR SHALL COORDINATE ANY REQUIRED UTILITY INTERRUPTIONS WITH THE OWNER AND AFFECTED UTILITY COMPANY A MINIMUM OF THREE WORKING DAYS BEFORE THE INTERRUPTION.

THE CONTRACTOR SHALL MAINTAIN A RECORD DRAWING SET OF PLANS AND PROMPTLY LOCATE ALL UTILITIES, EXITING OR NEW, IN THEIR CORRECT LOCATION, HORIZONTAL AND VERTICAL. THIS RECORD SET OF DRAWINGS SHALL BE MAINTAINED ON THE PROJECT SITE AND SHALL BE AVAILABLE TO THE OWNER AND ENGINEER AT ANY TIME DURING CONSTRUCTION.

EROSION CONTROL. ENVIRONMENTAL PROTECTION. AND STORM WATER POLLUTION PREVENTION PLAN

THE CONTRACTOR SHALL CONFORM TO ALL CITY, COUNTY, STATE, AND FEDERAL DUST AND EROSION CONTROL REGULATIONS. THE CONTRACTOR SHALL OBTAIN AND PREPARE ANY DUST CONTROL OR EROSION CONTROL PERMITS REQUIRED FROM THE REGULATORY AGENCIES.

THE CONTRACTOR SHALL PROMPTLY REMOVE ANY MATERIAL EXCAVATED WITH THE PUBLIC RIGHT-OF-WAY OR ADJACENT PROPERTY TO KEEP IT FROM WASHING OFF THE PROJECT SITE.

THE CONTRACTOR SHALL ENSURE THAT NO SOIL ERODES FROM THE SITE ONTO ADJACENT PROPERTY BY CONSTRUCTION OF TEMPORARY EROSION CONTROL BERMS OR INSTALLING SILT FENCES AT THE PROPERTY LINES AND WETTING THE SOIL TO PREVENT IT FROM BLOWING.

WATERING, AS REQUIRED FOR CONSTRUCTION DUST CONTROL, SHALL BE CONSIDERED INCIDENTAL TO CONSTRUCTION AND NO MEASUREMENT OR PAYMENT SHALL BE MADE. CONSTRUCTION AREAS SHALL BE WATERED FOR DUST CONTROL IN COMPLIANCE WITH GOVERNMENT ORDINANCES. THE CONTRACTOR SHALL BE RESPONSIBLE FOR LOCATING AND SUPPLYING WATER AS REQUIRED.

ANY AREAS DISTURBED BY CONSTRUCTION AND NOT COVERED BY LANDSCAPING OR IMPERVIOUS SURFACES SHALL BE REVEGETATED WITH RECLAMATION SEEDING.

THE CONTRACTOR SHALL PROPERLY HANDLE AND DISPOSE OF ALL ASPHALT REMOVED ON THE PROJECT BY HAULING IT TO AN APPROVED DISPOSAL SITE IN ACCORDANCE WITH THE REQUIREMENTS OF THE NEW MEXICO SOLID WASTE ACT.

ALL WASTE PRODUCTS FROM THE CONSTRUCTION SITE, INCLUDING ITEMS DESIGNED FOR REMOVAL, CONSTRUCTION WASTE, CONSTRUCTION EQUIPMENT WASTE PRODUCTS (OIL, GAS, TIRES, ETC.), GARBAGE, GRUBBING, EXCESS CUT MATERIAL, VEGETATIVE DEBRIS, ETC.. SHALL BE APPROPRIATELY DISPOSED OF OFFSET AT NO ADDITIONAL COST TO THE OWNER. IT SHALL BE THE CONTRACTOR'S RESPONSIBILITY TO OBTAIN ANY PERMITS REQUIRED FOR HAUL OR DISPOSAL OF WASTE PRODUCTS, IT SHALL BE THE CONTRACTOR'S RESPONSIBILITY TO ENSURE THAT THE WASTE DISPOSAL SITE COMPLIES WITH GOVERNMENT REGULATIONS REGARDING THE ENVIRONMENT, ENDANGERED SPECIES, AND ARCHAEOLOGICAL RESOURCES.

THE CONTRACTOR SHALL BE RESPONSIBLE FOR THE CLEANUP AND REPORTING OF SPILLS OF HAZARDOUS MATERIALS ASSOCIATED WITH THE CONSTRUCTION SITE. HAZARDOUS MATERIALS INCLUDE GASOLINE, DIESEL FUEL MOTOR OIL, SOLVENTS, CHEMICALS, PAINT, ETC. WHICH MAY BE A THREAT TO THE ENVIRONMENT. THE CONTRACTOR SHALL REPORT THE DISCOVERY OF PAST OR PRESENT SPILLS TO THE NEW MEXICO EMERGENCY RESPONSE AT 1-800-219-6157.

THE CONTRACTOR SHALL COMPLY WITH ALL APPLICABLE REGULATIONS CONCERNING SURFACE AND UNDERGROUND WATER. CONTACT WITH SURFACE WATER BY CONSTRUCTION EQUIPMENT AND PERSONNEL SHALL BE MINIMIZED. EQUIPMENT MAINTENANCE AND REFUELING OPERATIONS SHALL BE PERFORMED IN AN ENVIRONMENTALLY SAFE MANNER IN COMPLIANCE WITH GOVERNMENT REGULATIONS.

THE CONTRACTOR SHALL COMPLY WITH ALL APPLICABLE REGULATIONS CONCERNING CONSTRUCTION NOISE AND HOURS OF OPERATION.

ACCESSIBLE FACILITIES

ALL SURFACES ALONG ACCESSIBLE ROUTES AND FOR HANDICAP RAMPS SHALL BE STABLE FIRM, SLIDE RESISTANT AND SHALL COMPLY WITH UNIFORM FEDERAL ACCESSIBILITY STANDARDS, PARAGRAPH 4.5.

LONGITUDINAL SLOPES ALONG ACCESSIBLE ROUTE SIDEWALKS, EXCEPT AT HANDICAP RAMPS, SHALL NOT BE STEEPER THAN 1:20. CROSS SLOPES ALONG ACCESSIBLE ROUTE SIDEWALKS EXCEPT AT HANDICAP RAMPS, SHALL NOT BE STEEPER THAN 1:48. SLOPES IN ACCESSIBLE PARKING SPACES, ACCESS AISLES, AND PASSENGER LOADING ZONES SHALL NOT BE STEEPER THAN 1:48 IN ALL DIRECTIONS.

THE SITE SHALL COMPLY WITH ANSI A117.1-1992, "ACCESSIBLE AND USABLE BUILDINGS AND FACILITIES".

TRAFFIC CONTROL

THE CONTRACTOR SHALL PROVIDE ALL REQUIRED TRAFFIC CONTROL PLANS. ALL SIGNS, BARRICADES, CHANNELIZATION DEVICES, SIGN FRAMES AND ERECTION OF SUCH DEVICES SHALL CONFORM TO THE REQUIREMENTS OF " MANUAL OF UNIFORM TRAFFIC CONTROL DEVICES FOR STREETS AND HIGHWAYS" LATEST EDITION. PRIOR TO CONSTRUCTION, TRAFFIC CONTROL PLANS SHALL BE APPROVED BY THE GOVERNING AUTHORITY.

ABBR	REVI	ATIONS	e i					HYDROLOGY SEC
ВМ	_	BENCHMARK		- -			Z _⊢	. 11
		CABLE TELEVISION LINE					∝ ∪	8 9 2 8
CO		CLEANOUT	:				⊃ O	5 0 5
COA		CITY OF ALBUQUERQUE					Ф ш	0 4 8
		CONCRETE	. 7				I _	0 87
CL		CENTERLINE					S	M EXICO
DIA		DIAMETER						∑ } w z
DTL		DETAIL					டு	LES Z
DWG	=	DRAWING	. ;				шО	R R A L i
Ε	=	ELECTRIC LINE					· ⊢	0
ELEC.	. =	ELECTRIC					≪ ≪	2941
ELEV	=	ELEVATION					⊢ ∢	× O B
EX	· =	EXISTING	• • • • • • • • • • • • • • • • • • •					
FF	=	FINISHED FLOOR ELEVATION	9 9 9 9 9 9 9 9 9 9 9 9 9 9 9 9 9 9 9				ARCHITE	CTSEAL
FG	=	FINISHED GRADE	1					
FH	=	FIRE HYDRANT						
FL	=	FLOW LINE						
G	=	GAS PIPE	· ·					
GM	=	GAS METER						
GV	=	GATE VALVE					ENGINEI	ERSEAL
INV	=	INVERT ELEVATION					Ju P	ENCE Q
LF	==	LINEAL FEET						EN NEWS E
LP	=	LIGHT POLE	· · · · · · · · · · · · · · · · · · ·				AE GESTIE	(10998)
L/S	=	LANDSCAPING						1000
MH		MANHOLE						TOFESSION
NG		NATURAL GROUND						
0E		OVERHEAD ELECTRIC LINE					PROJECT	
OT		OVERHEAD TELEPHONE LINE						
PCC		PORTLAND CEMENT CONCRETE						≥ ∩
PP		POWER POLE	**************************************					Ź
PROP		POLYVINYL CHLORIDE PIPE					_	-
PVC-RCP		REINFORCED CONCRETE PIPE			<u> </u>			AD.
R/W		RIGHT-OF-WAY					Q	
s,		SLOPE					T A	₹≥
SAS		SANITARY SEWER					エ	Ž ₩
SD		STORM DRAIN					ASH	Ø Z
STA		STATION					\Rightarrow	~ ~ <u>"</u>
STD	=	STANDARD					8	o R
SW	=	SIDEWALK					$\overline{\mathbf{x}}$	Z S S
T	=	TELEPHONE					Ò	B UE
TA	=	TOP OF ASPHALT PAVEMENT					>	S Q
TC	=	TOP OF CONCRETE SLAB (PAVEMENT)					N N N N N N N N N N N N N N N N N N N	\cap
TCC	=	TOP OF CONCRETE CURB						O HB
TG	=	TOP OF GRATE) .					Ŭ∢
TS	=	TOP OF SIDEWALK						
TW	=	TOP OF WALL	**************************************				<u> </u>	
TYP	=	TYPICAL					REVISION	IS
UE	=	UNDERGROUND ELECTRIC	e e					
UT		UNDERGROUND TELEPHONE	**					
W		WATER	* . *					
WM		WATER METER					DATE	August 25, 2003
WV	=	WATER VALVE	₹ •				NORTH	S CALE
							новн	
						J.		1"=20'
							DRAWING	NAME
							C	ENERAL NOTES
					,		G	LIALIAVE IAO1E9

LARRY READ & ASSOCIATES Civil Engineers

4800-C Juan Tabo, NE Albuquerque, New Mexico 87111 (505) 237-8421

SHEET NUMBER

| | | MAR 2 6 2004

HYDROLOGY SECTI

GENERAL

CONTRACTOR IS RESPONSIBLE FOR OBTAINING ALL REQUIRED CONSTRUCTION PERMITS, INCLUDING A TOP SOIL DISTURBANCE PERMIT, PRIOR TO START OF CONSTRUCTION.

ALL WORK ON THIS PROJECT SHALL BE PERFORMED IN ACCORDANCE WITH APPLICABLE FEDERAL, STATE, AND LOCAL LAWS, ORDINANCES, AND REGULATIONS CONCERNING CONSTRUCTION SAFETY AND HEALTH.

REFERENCES MADE TO STANDARD SPECIFICATIONS AND STANDARD DRAWINGS REFER TO THE CITY OF ALBUQUERQUE STANDARD SPECIFICATIONS FOR PUBLIC WORKS CONSTRUCTION, 1986 EDITION WITH ALL UPDATES.

THE CONTRACTOR SHALL NOT INSTALL ITEMS AS SHOWN ON THESE PLANS WHEN IT IS OBVIOUS THAT FIELD CONDITIONS ARE DIFFERENT THAN SHOWN IN THE PLANS. SUCH CONDITIONS SHALL BE BROUGHT TO THE ATTENTION OF THE ENGINEER IN A TIMELY MANNER. IN THE EVENT THE CONTRACTOR DOES NOT NOTIFY THE ENGINEER IN A TIMELY MANNER, THE CONTRACTOR ASSUMES FULL RESPONSIBILITY AND EXPENSE FOR ANY REVISIONS NECESSARY, INCLUDING ENGINEERING DESIGN FEES.

EXISTING SITE IMPROVEMENTS WHICH ARE DAMAGED OR DISPLACED BY THE CONTRACTOR SHALL BE REMOVED AND REPLACED BY THE CONTRACTOR AT THE CONTRACTOR'S EXPENSE. REPAIRS SHALL BE APPROVED BY THE OWNER PRIOR TO CONSTRUCTION OF THE REPAIRS. REPAIRS SHALL BE ACCEPTED BY THE OWNER PRIOR TO FINAL PAYMENT.

EXISTING FENCING THAT IS NOT DESIGNATED FOR REMOVAL SHALL NOT BE DISTURBED. ANY FENCING THAT IS DISTURBED OR ALTERED BY THE CONTRACTOR SHALL BE RESTORED TO ITS ORIGINAL CONDITION AT THE CONTRACTORS EXPENSE. IF THE CONTRACTOR DESIRES TO REMOVE FENCING TO ACCOMMODATE CONSTRUCTION ACTIVITIES, THE CONTRACTOR SHALL OBTAIN THE OWNER'S WRITTEN PERMISSION BEFORE THE FENCE IS REMOVED. CONTRACTOR SHALL RESTORE THE FENCE TO ITS ORIGINAL CONDITION AT THE EARLIEST OPPORTUNITY. WHILE ANY FENCING IS REMOVED. THE CONTRACTOR SHALL BE SOLELY RESPONSIBLE FOR SECURITY OF THE SITE UNTIL THE FENCE IS RESTORED.

WORK WITHIN ADJACENT RIGHT-OF-WAY

PRIOR TO BEGINNING ANY CONSTRUCTION ACTIVITIES WITHIN ADJACENT RIGHT-OF-WAYS OR WITHIN PROPERTY NOT OWNED BY THE OWNER OF THE PROJECT SITE, THE CONTRACTOR SHALL ASSURE THAT ALL PERMITS AND PERMISSIONS REQUIRED HAVE BEEN OBTAINED IN WRITING.

SURVEY MONUMENTS, PROPERTY CORNERS, BENCHMARKS

THE CONTRACTOR SHALL NOTIFY THE OWNER AT LEAST SEVEN DAYS BEFORE BEGINNING ANY CONSTRUCTION ACTIVITY THAT COULD DAMAGE OR DISPLACE SURVEY MONUMENTS, PROPERTY CORNERS, OR PROJECT BENCHMARKS SO THESE ITEMS MAY BE RELOCATED.

ANY SURVEY MONUMENTS, PROPERTY CORNERS, OR BENCHMARKS THAT ARE NOT IDENTIFIED FOR RELOCATION ARE THE RESPONSIBILITY OF THE CONTRACTOR TO PRESERVE AND PROTECT, RELOCATION OR REPLACEMENT OF THESE ITEMS SHALL BE DONE BY THE OWNER'S SURVEYOR AT THE EXPENSE OF THE CONTRACTOR.

DIMENSIONS

ALL DIMENSIONS TO CURBS ARE TO THE FLOWLINE UNLESS OTHERWISE NOTED.

ALL STATIONING IS TO THE CENTERLINE OF THE RIGHT-OF-WAY UNLESS OTHERWISE NOTED.

ALL SLOPES AND GRADES ARE IN PERCENT UNLESS OTHERWISE NOTED.

CURB ELEVATIONS ARE SHOWN AT THE FLOW LINE UNLESS OTHERWISE NOTED. SEE THE DETAIL SHEET TO DETERMINE THE CURB HEIGHT ABOVE FLOW LINE.

UNLESS OTHERWISE SPECIFIED, SUBGRADE, ENGINEERED FILL, AND STRUCTURAL FILL SHALL BE COMPACTED TO THE FOLLOWING SPECIFICATIONS OF THE ASTM D-1557 MAXIMUM DRY DENSITY.

MATERIAL	/LOCATION	PERCENT COMPACTI
STRUCTURAL FILL	. IN THE BUILDING AREA	95%
SUBBASE FOR SL	AB SUPPORT	95%
MISCELLANEOUS E	BACKFILL BELOW STRUCTURAL	<u>. </u>
FILL OR ROADWAY		95%
MISCELLANEOUS E	BACKFILL BELOW UNPAVED.	
NON-BUILDING AF		90%
ROADWAY PAVEM	ENT SUBGRADE	95%
SIDEWALK SUBGRA		90%
CURB AND GUTTE		95%

PAVEMENT

WHEN ABUTTING NEW PAVEMENT TO EXISTING PAVEMENT. CUT EXISTING PAVEMENT EDGE TO A NEAT. STRAIGHT LINE AS NECESSARY TO REMOVE ANY BROKEN OR CRACKED PAVEMENT AND MATCH NEW PAVEMENT ELEVATION TO

ALL UTILITIES AND UTILITY SERVICE LINES SHALL BE INSTALLED AND APPROVED PRIOR TO PAVING.

ALL WATER VALVE BOXES AND ELECTRICAL, TELEPHONE, TELEVISION, AND SEWER MANHOLES IN THE CONSTRUCTION AREA SHALL BE ADJUSTED TO FINISHED GRADE BEFORE PAVING.

WHEN SIDEWALK OR CURB AND GUTTER IS REMOVED, IT SHALL BE REMOVED TO EXISTING CONSTRUCTION JOINTS. CUTTING OR BREAKING SHALL NOT BE ALLOWED.

LEGEND

	EX BLOCK WALL	*	LIGHT POLE		EX SD INLET
x G 89.5	EX SPOT ELEV.	A	EX FIRE HYDRANT	i o	CONCRETE
◆ FL 09.3	PROP SPOT ELEV.	•	EX WATER VALVE		EX WATER METER
 5160	EX BLOCK WALL	©	EX SD MANHOLE	6	EXIST. TREE
\boxtimes	TRANSFORMER	S	EX SAS MANHOLE		

UTILITIES

IF ANY UTILITY LINES, PIPELINES, OR UNDERGROUND UTILITY LINES ARE SHOWN ON THESE DRAWINGS, THEY ARE SHOWN IN AN APPROXIMATE LOCATION ONLY BASED ON THE INFORMATION PROVIDED TO THE ENGINEER BY OTHERS. THIS INFORMATION MAY BE INACCURATE OR INCOMPLETE. ADDITIONALLY, UNDERGROUND LINES MAY EXIST THAT ARE NOT SHOWN. THE CONTRACTOR SHALL VERIFY THE LOCATION OF ANY UTILITY LINE, PIPELINE, OR UNDERGROUND UTILITY LINE IN OR NEAR THE AREA OF THE WORK IN ACCORDANCE WITH CHAPTER 62. ARTICLE 14-1, THROUGH 14-8, NMSA 1978.

THE CONTRACTOR SHALL CONTACT THE STATEWIDE UTILITY LOCATOR SERVICE AT 1-800-321-2537 AT LEAST TWO WORKING DAYS BEFORE BEGINNING CONSTRUCTION. AFTER THE UTILITIES ARE SPOTTED, THE CONTRACTOR SHALL EXPOSE ALL PERTINENT UTILITIES TO VERIFY THEIR VERTICAL AND HORIZONTAL LOCATION. IF A CONFLICT EXISTS BETWEEN EXISTING UTILITIES AND PROPOSED CONSTRUCTION, THE CONTRACTOR SHALL NOTIFY THE ENGINEER SO THAT THE CONFLICT CAN BE RESOLVED WITH MINIMAL DELAY.

THE CONTRACTOR SHALL EXERCISE DUE CARE TO AVOID DISTURBING ANY EXISTING UTILITIES, ABOVE OR BELOW GROUND. UTILITIES THAT ARE DAMAGED BY CARELESS CONSTRUCTION SHALL BE REPAIRED OR REPLACED AT THE CONTRACTOR'S EXPENSE.

EXISTING VALVES SHALL ONLY BE OPERATED BY THE UTILITY COMPANY. CONTRACTOR SHALL NOTIFY THE UTILITY A MINIMUM OF TWO WORKING DAYS BEFORE ANY VALVE, NEW OR EXISTING, NEEDS TO BE OPERATED.

THE CONTRACTOR SHALL COORDINATE ANY REQUIRED UTILITY INTERRUPTIONS WITH THE OWNER AND AFFECTED UTILITY COMPANY A MINIMUM OF THREE WORKING DAYS BEFORE THE INTERRUPTION.

THE CONTRACTOR SHALL MAINTAIN A RECORD DRAWING SET OF PLANS AND PROMPTLY LOCATE ALL UTILITIES. EXITING OR NEW, IN THEIR CORRECT LOCATION, HORIZONTAL AND VERTICAL. THIS REGORD SET OF DRAWINGS SHALL BE MAINTAINED ON THE PROJECT SITE AND SHALL BE AVAILABLE TO THE OWNER AND ENGINEER AT ANY TIME DURING CONSTRUCTION.

EROSION CONTROL. ENVIRONMENTAL PROTECTION, AND STORM WATER POLLUTION PREVENTION PLAN

THE CONTRACTOR SHALL CONFORM TO ALL CITY, COUNTY, STATE, AND FEDERAL DUST AND EROSION CONTROL REGULATIONS. THE CONTRACTOR SHALL OBTAIN AND PREPARE ANY DUST CONTROL OR EROSION CONTROL PERMITS REQUIRED FROM THE REGULATORY AGENCIES.

THE CONTRACTOR SHALL PROMPTLY REMOVE ANY MATERIAL EXCAVATED WITH THE PUBLIC RIGHT-OF-WAY OR ADJACENT PROPERTY TO KEEP IT FROM WASHING OFF THE PROJECT SITE.

THE CONTRACTOR SHALL ENSURE THAT NO SOIL ERODES FROM THE SITE ONTO ADJACENT PROPERTY BY CONSTRUCTION OF TEMPORARY EROSION CONTROL BERMS OR INSTALLING SILT FENCES AT THE PROPERTY LINES AND WETTING THE SOIL TO PREVENT IT FROM BLOWING.

WATERING, AS REQUIRED FOR CONSTRUCTION DUST CONTROL, SHALL BE CONSIDERED INCIDENTAL TO CONSTRUCTION AND NO MEASUREMENT OR PAYMENT SHALL BE MADE. CONSTRUCTION AREAS SHALL BE WATERED FOR DUST CONTROL IN COMPLIANCE WITH GOVERNMENT ORDINANCES. THE CONTRACTOR SHALL BE RESPONSIBLE FOR LOCATING AND SUPPLYING WATER AS REQUIRED.

ANY AREAS DISTURBED BY CONSTRUCTION AND NOT COVERED BY LANDSCAPING OR IMPERVIOUS SURFACES SHALL BE REVEGETATED WITH RECLAMATION SEEDING.

THE CONTRACTOR SHALL PROPERLY HANDLE AND DISPOSE OF ALL ASPHALT REMOVED ON THE PROJECT BY HAULING IT TO AN APPROVED DISPOSAL SITE IN ACCORDANCE WITH THE REQUIREMENTS OF THE NEW MEXICO SOLID WASTE ACT.

ALL WASTE PRODUCTS FROM THE CONSTRUCTION SITE, INCLUDING ITEMS DESIGNED FOR REMOVAL, CONSTRUCTION WASTE, CONSTRUCTION EQUIPMENT WASTE PRODUCTS (OIL, GAS, TIRES, ETC.), GARBAGE, GRUBBING, EXCESS CUT MATERIAL, VEGETATIVE DEBRIS, ETC.. SHALL BE APPROPRIATELY DISPOSED OF OFFSET AT NO ADDITIONAL COST TO THE OWNER. IT SHALL BE THE CONTRACTOR'S RESPONSIBILITY TO OBTAIN ANY PERMITS REQUIRED FOR HALL OR DISPOSAL OF WASTE PRODUCTS. IT SHALL BE THE CONTRACTOR'S RESPONSIBILITY TO ENSURE THAT THE WASTE DISPOSAL SITE COMPLIES WITH GOVERNMENT REGULATIONS REGARDING THE ENVIRONMENT, ENDANGERED SPECIES, AND ARCHAEOLOGICAL RESOURCES.

THE CONTRACTOR SHALL BE RESPONSIBLE FOR THE CLEANUP AND REPORTING OF SPILLS OF HAZARDOUS MATERIALS ASSOCIATED WITH THE CONSTRUCTION SITE. HAZARDOUS MATERIALS INCLUDE GASOLINE, DIESEL FUEL. MOTOR OIL, SOLVENTS, CHEMICALS, PAINT, ETC. WHICH MAY BE A THREAT TO THE ENVIRONMENT. THE CONTRACTOR SHALL REPORT THE DISCOVERY OF PAST OR PRESENT SPILLS TO THE NEW MEXICO EMERGENCY RESPONSE AT 1-800-219-6157.

THE CONTRACTOR SHALL COMPLY WITH ALL APPLICABLE REGULATIONS CONCERNING SURFACE AND UNDERGROUND WATER. CONTACT WITH SURFACE WATER BY CONSTRUCTION EQUIPMENT AND PERSONNEL SHALL BE MINIMIZED. EQUIPMENT MAINTENANCE AND REFUELING OPERATIONS SHALL BE PERFORMED IN AN ENVIRONMENTALLY SAFE MANNER IN COMPLIANCE WITH GOVERNMENT REGULATIONS.

THE CONTRACTOR SHALL COMPLY WITH ALL APPLICABLE REGULATIONS CONCERNING CONSTRUCTION NOISE AND HOURS OF OPERATION.

ACCESSIBLE FACILITIES

ALL SURFACES ALONG ACCESSIBLE ROUTES AND FOR HANDICAP RAMPS SHALL BE STABLE FIRM, SLIDE RESISTANT AND SHALL COMPLY WITH UNIFORM FEDERAL ACCESSIBILITY STANDARDS, PARAGRAPH 4.5.

LONGITUDINAL SLOPES ALONG ACCESSIBLE ROUTE SIDEWALKS, EXCEPT AT HANDICAP RAMPS, SHALL NOT BE STEEPER THAN 1: 20. CROSS SLOPES ALONG ACCESSIBLE ROUTE SIDEWALKS EXCEPT AT HANDICAP RAMPS, SHALL NOT BE STEEPER THAN 1:48. SLOPES IN ACCESSIBLE PARKING SPACES, ACCESS AISLES, AND PASSENGER LOADING ZONES SHALL NOT BE STEEPER THAN 1:48 IN ALL DIRECTIONS.

THE SITE SHALL COMPLY WITH ANSI A117.1-1992, "ACCESSIBLE AND USABLE BUILDINGS AND FACILITIES".

TRAFFIC CONTROL

THE CONTRACTOR SHALL PROVIDE ALL REQUIRED TRAFFIC CONTROL PLANS. ALL SIGNS, BARRICADES. CHANNELIZATION DEVICES, SIGN FRAMES AND ERECTION OF SUCH DEVICES SHALL CONFORM TO THE REQUIREMENTS OF " MANUAL OF UNIFORM TRAFFIC CONTROL DEVICES FOR STREETS AND HIGHWAYS" LATEST EDITION. PRIOR TO CONSTRUCTION, TRAFFIC CONTROL PLANS SHALL BE APPROVED BY THE GOVERNING AUTHORITY.

ABBREVIATIONS

BM - BENCHMARK CATV = CABLE TELEVISION LINE

CO = CLEANOUT

COA = CITY OF ALBUQUERQUE

CL = CENTERLINE

CONC = CONCRETE

DIA = DIAMETER

DTL - DETAIL DWG = DRAWING

E = ELECTRIC LINE

ELEC. = ELECTRIC ELEV = ELEVATION

EX = EXISTING

= FINISHED FLOOR ELEVATION

FL = FLOW LINE

G = GAS PIPE

= INVERT ELEVATION

= GATE VALVE

= LINEAL FEET

LP = LIGHT POLE

L/S = LANDSCAPING

= NATURAL GROUND

- OVERHEAD ELECTRIC LINE

= OVERHEAD TELEPHONE LINE

PCC = PORTLAND CEMENT CONCRETE

- POWER POLE

PVC = POLYVINYL CHLORIDE PIPE

RCP = REINFORGED CONCRETE PIPE

R/W = RIGHT-OF-WAY

= SLOPE

SAS = SANITARY SEWER

SD = STORM DRAIN

STA = STATION STD = STANDARD

SW = SIDEWALK

= TELEPHONE

TA = TOP OF ASPHALT PAVEMENT

TC = TOP OF CONCRETE SLAB (PAVEMENT)

TCC = TOP OF CONCRETE CURB

TG = TOP OF GRATE

TS = TOP OF SIDEWALK

TW = TOP OF WALL

= UNDERGROUND ELECTRIC

= UNDERGROUND TELEPHONE

= WATER


TYP = TYPICAL

- WATER METER

= WATER VALVE

 \supset IH ш U ARCHITECT SEAL

ENGINEERSEAL

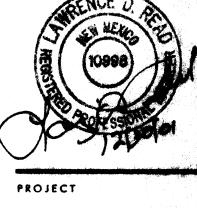

REVISIONS

DRAWING NAME

GENERAL NOTES

SHEET NUMBER

LARRY READ & ASSOCIATES Civil Engineers 4800-C Juan Tabo, NE Albuquerque, New Mexico 87111

(505) 237-8421

No title report was provided for this property. Any possible easements, conditions or restrictions that may be disclosed by such a report are not shown on this survey.

25' PUBLIC WATER AND SANITARY SEWER EASEMENT Per Plot Filed— Feb. 1, 1994 Volume 94C , folio 32

5. ASPHALT PAVEMENT PER DETAIL 9/C-3.

6. 12" THICK LAYER OF 6" DIA . RIPRAP ON MIRAFI 140N FILTER FABRIC (OR APPROVED EQUAL).

ARCHITECT SEAL

ENGINEER SEAL

REVISIONS

OCTOBER 25, 200

1'=20'



DRAWING NAME

GRADING PLAN


SHEET NUMBER

LARRY READ & ASSOCIATES


Civil Engineers

4800-C Juan Tabo, NE


Albuquerque, New Mexico 87111 (505) 237-8421

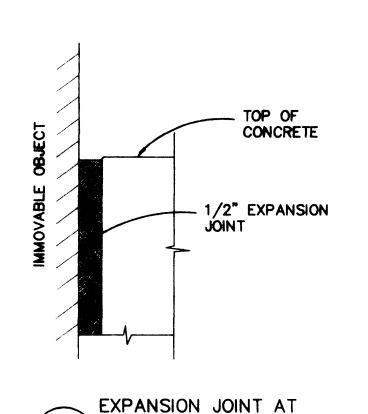


IMMOVABLE OBJECT

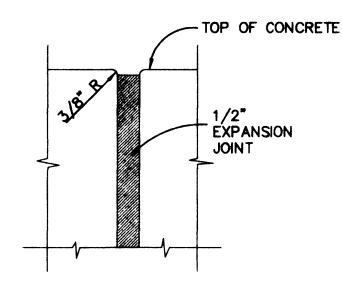

2 EXPANSION JOINT DETAIL

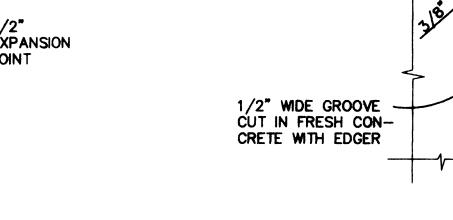

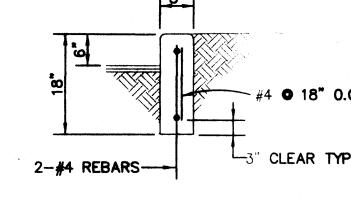


2. PROVIDE CONTRACTION JOINTS @ 6' O.C.

CONSTRUCTION NOTES:




1. PROVIDE 1/2" EXPANSION JOINTS AT 36' O.C., AT IMMOVABLE OBJECTS, AND AT THE BEGINNING AND END OF CURVES.


3. ALL EXPOSED CONCRETE CORNERS TO HAVE 3/4" RADII.

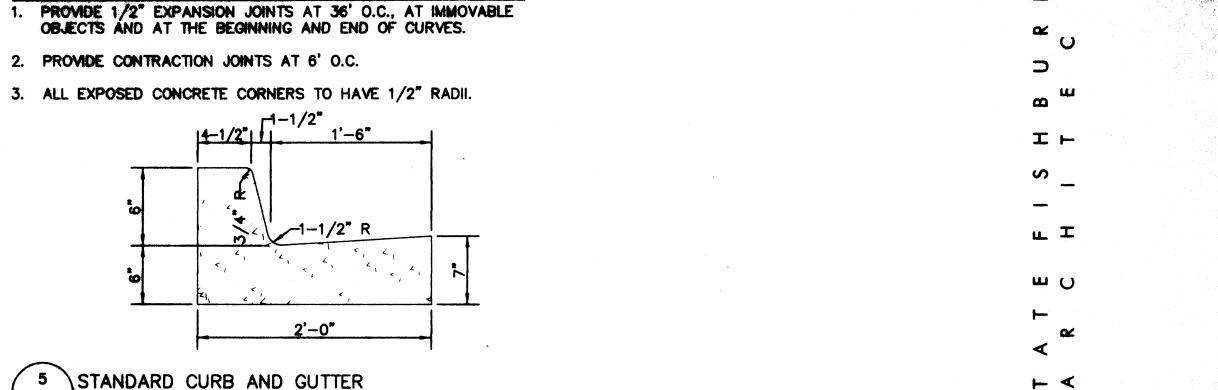



- **CONSTRUCTION NOTES:** 1. PROVIDE 1/2" EXPANSION JOINTS AT 36' O.C., AT IMMOVABLE OBJECTS AND AT PERPENDICULAR CURBS PER DETAIL THIS SHEET
- 2. PROVIDE CONTRACTION JOINTS 6' O.C. PER DETAIL THIS SHEET

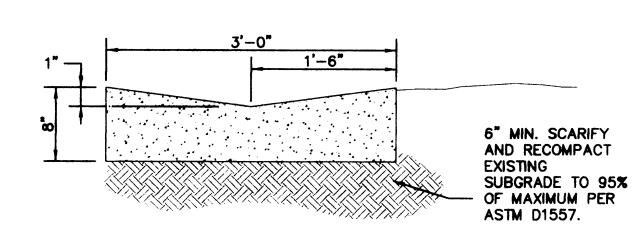

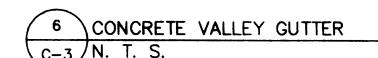


CONSTRUCTION NOTES:

1. 1/2" EXPANSION JOINTS SHALL BE INSTALLED WHERE CONCRETE ABUTS RIGID STRUCTURES, SUCH AS CURBS, BUILDINGS, OR LIGHT STANDARDS. SEE DETAIL THIS SHEET.


TOP OF CONCRETE -

2. CONCRETE SHALL HAVE CONTRACTION JOINTS AT 6' INTERVALS, UNLESS OTHERWISE SHOWN ON PLANS. SEE DETAIL THIS SHEET.

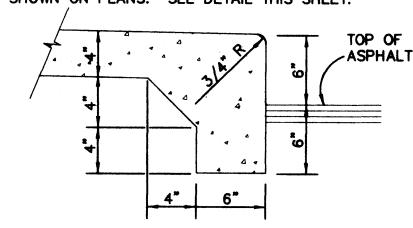


3 CONTRACTION JOINT DETAIL

CONCRETE TURNDOWN (TYP ALL VACUUM STATIONS)

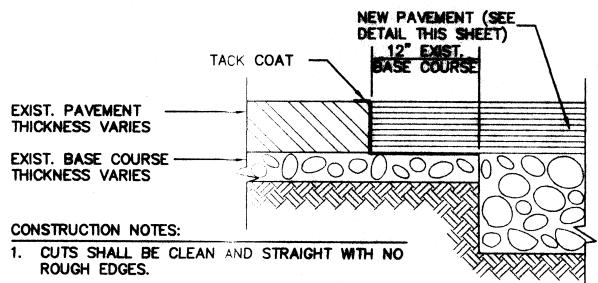

- 2. IRREGULAR BREAKAGE SHALL BE REMOVED AND REPAIRED.
- 3. LAY NEW ASPHALT PAVING ON EXIST. BASE COURSE AT JOINT.



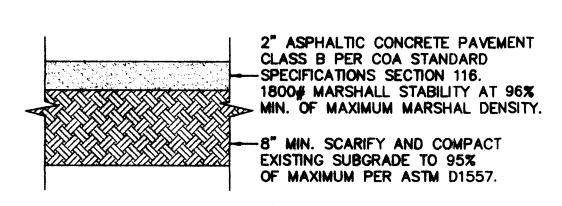

9 ASPHALT PAVEMENT SECTION

CONSTRUCTION NOTES:

DRAINAGE REPORT

LOCATION & DESCRIPTION

THE PROPOSED SITE IS 0.59 ACRES, LOCATED ON THE WEST END OF LOT A-26-A2A, AS SHOWN ON THE GRADING PLAN ON SHEET C-2. LOT A-26-A2A IS LOCATED NORTH OF QUAIL ROAD AND WEST OF COORS BOULEVARD, AS SHOWN ON THE VICINITY MAP ON SHEET C-2. ALL OF THE PROPERTIES AROUND THIS SITE ARE ALREADY DEVELOPED AND UTILIZE FREE DISCHARGE TO COORS BOULEVARD WHERE THE FLOW IS INTERCEPTED BY A STORM DRAIN. THIS LOT HAS A SLIGHT SLOPE TOWARD COORS BOULEVARD ENABLING IT TO DRAIN TO THE EAST.

FLOODPLAIN STATUS

THIS PROJECT, AS SHOWN ON FEMA'S FLOOD INSURANCE RATE MAP 35001C0337 D, DATED SEPTEMBER 20, 1996 IS NOT WITHIN ANY DESIGNATED 100-YEAR FLOODPLAIN. THE SITE IS DESIGNATED ON THE FIRM PANEL ON THIS SHEET.

METHODOLOGY

THE HYDROLOGY FOR THIS PROJECT WAS ANALYZED USING THE QUICK CALCULATIONS OF THE JUNE 1997 RELEASE OF THE CITY OF ALBUQUERQUE DEVELOPMENT PROCESS MANUAL, SECTION 22.2.

PRECIPITATION


THE 100-YR 6-HR DURATION STORM WAS USED AS THE DESIGN STORM FOR THIS ANALYSIS. THIS SITE IS WITHIN ZONE 1 AS IDENTIFIED IN THE CITY OF ALBUQUERQUE DEVELOPMENT PROCESS MANUAL, SECTION 22.2. TABLES WITHIN THIS SECTION WAS USED TO ESTABLISH THE 6-HOUR PRECIPITATION, EXCESS PRECIPITATION, AND PEAK DISCHARGE.


EXISTING DRAINAGE

THE SITE IS UNDEVELOPED AS DESCRIBED IN "LOCATION AND DESCRIPTION" ABOVE. ALL OF THE ADJACENT SITES HAVE BEEN FILLED TO DRAIN AWAY FROM THIS PROPERTY. THEREFORE, THERE ARE NO OFF SITE BASINS CONTRIBUTING DRAINAGE TO THIS SITE. A STORM DRAIN IN COORS BOULEVARD HAS BEEN DESIGNED AND CONSTRUCTED TO INTERCEPT DEVELOPED FLOWS FROM THIS TRACT OF LAND.

DEVELOPED CONDITION

AT THIS TIME ONLY 0.59 ACRES OF THE 1.24 ACRE SITE WILL BE DEVELOPED AS A CAR WASH. THE REMAINING 0.64 ACRES WILL REMAIN UNDEVELOPED. THE "100-YEAR HYDROLOGIC CALCULATIONS", ON THIS SHEET, DEMONSTRATE THAT THIS
DEVELOPMENT WILL INCREASE THE RUNOFF FROM THIS SITE FROM 0.77 CFS TO 2.36 CFS. HOWEVER, THE AREA BEING DEVELOPED
AS A CAR WASH IS ONLY 73.66% IMPERVIOUS WHICH IS LESS THAN THE DPM SECTION 22.2 ALLOWANCE OF 90% FOR COMMERCIAL
SITES. THEREFORE, THIS DEVELOPMENT DISCHARGES LESS RUNOFF THAN WHAT WAS ANTICIPATED WHEN THE COORS STORM DRAIN WAS DESIGNED. GRADES HAVE BEEN SET TO ASSURE THAT SURFACE RUNOFF WILL CONTINUE TO CROSS THE UNDEVELOPED PORTION OF THIS LOT AND DRAIN TO COORS BOULEVARD WITHOUT OBSTRUCTING FUTURE DEVELOPMENT ON THE REMAINDER OF THE LOT. THEREFORE, THIS SITE CAN BE DEVELOPED ACCORDING TO THIS GRADING AND DRAINAGE PLAN WITHOUT ADVERSELY AFFECTING DOWNSTREAM PROPERTY.

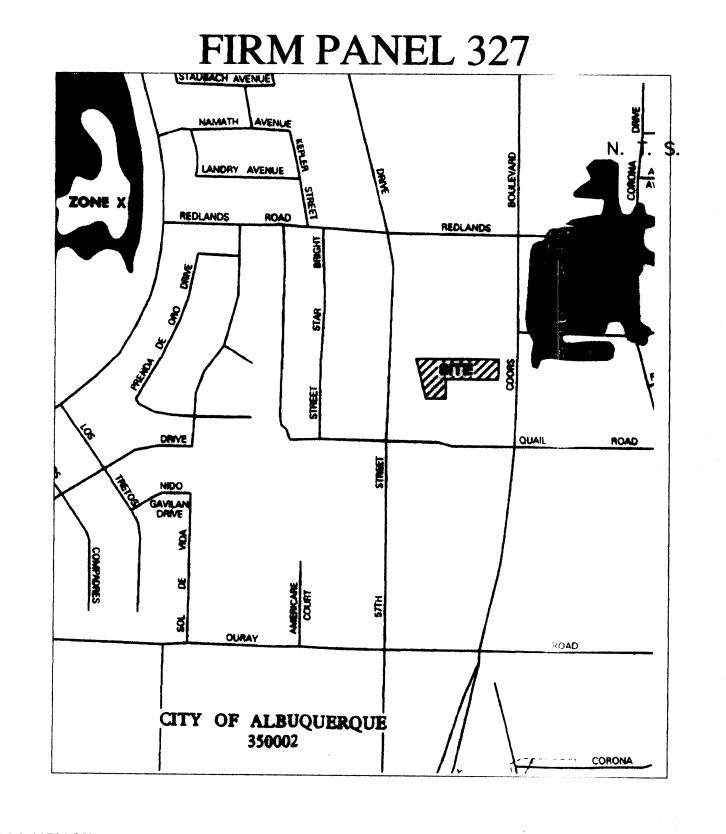

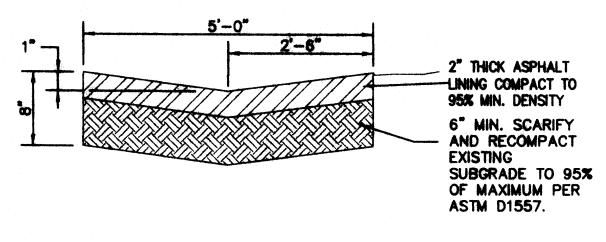

TEMPORARY ASPHALT SWALE


			AD T			WEEK! ED					
BASSI	AREA	A		C	D	E	V (6-hr)	V (6-br)	V(19 day)	V(10 day)	Q
	(eca)	(%)	(14)	(%)	(99)	(10)	(mere-ft)	(cu-ft)	(apro-ft)	(cu-ft)	(c fs)
		and the same and the	and the same of th		Same and district		a the street				
		Market B		0.00	9.40		0.02	948	0.02	948	0.77
EMANDER	0.6442	75.62	0.00	10.83	18.54	0.71	0.04	1,653	0.05	2,118	1.21
TOTAL	1.255						6.83	2,001	9.07	3,067	1.98
							A88				
HEW THE	0.4450	0.00	8,00	25.54	74.65		0.08	3,690	0.14	6,024	2.38
EMAINDER	0.6442	78.62	0.00	10.83	13.54	0.71	0.04	1,653	0.06	2,118	121
TOTAL	1.233						0.12	5,348	0.19	8,142	3.57
CVAPA -											
EXCESS P		0.44	0.67	0.99	1.97	E (in)					
PEAK DISC	HARRIE	1.29	2.03	2.87	4.37	Qn (cfs)					
			ا کاریا						ZONE =	1	
VEIGHTED E	$(in) = (E_A)$	(%A) + (E	s)(%B) +	(Ec)(%C)	+ (Eo)(9	(D)			Peur (in.) =	2.20	
ein (acre-fi) :									P24-HR (in.) =	2.66	
HODAY (ACID-II)	= Vote + ((Ac)(Piccay	- Permit	12					P100AY (in.) =	3.67	

LARRY READ & ASSOCIATES
Civil Engineers 4800-C Juan Tabo, NE Albuquerque, New Mexico 87111

(505) 237-8421

ARCHITECT SEAL

ENGINEER SEAL

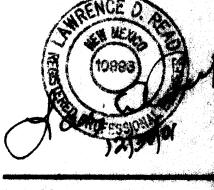



PROJECT


REVISIONS

DRAWING NAME DETAILS AND DRAINAGE PLANE


SHEET NUMBER

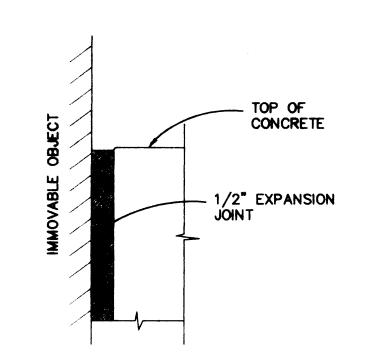

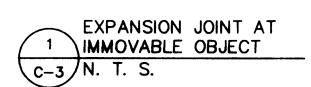


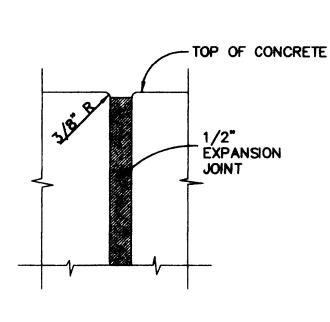

2 EXPANSION JOINT DETAIL

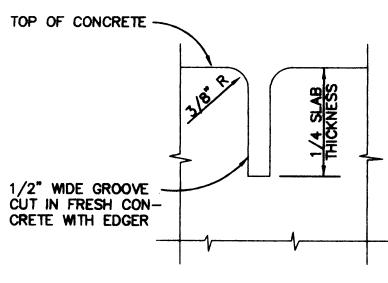

3 CONTRACTION JOINT DETAIL

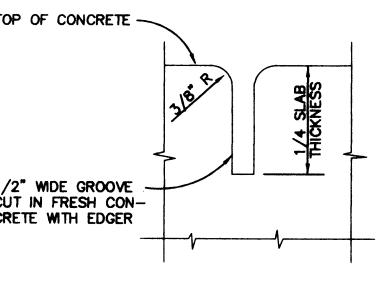


CONCRETE HEADER CURB DETAIL

2. PROVIDE CONTRACTION JOINTS • 6' O.C.

CONSTRUCTION NOTES:

PROVIDE 1/2" EXPANSION JOINTS AT 36' O.C., AT IMMOVABLE OBJECTS AND AT THE BEGINNING AND END OF CURVES. 2. PROVIDE CONTRACTION JOINTS AT 6' O.C. 3. ALL EXPOSED CONCRETE CORNERS TO HAVE 1/2" RADII.

CONSTRUCTION NOTES:

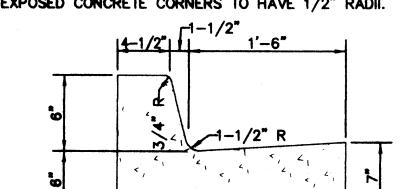


5 STANDARD CURB AND GUTTER

CONSTRUCTION NOTES:

PROVIDE 1/2" EXPANSION JOINTS AT 36' O.C., AT IMMOVABLE OBJECTS AND AT PERPENDICULAR CURBS PER DETAIL THIS SHEET

2. PROVIDE CONTRACTION JOINTS • 6' O.C. PER DETAIL THIS SHEET

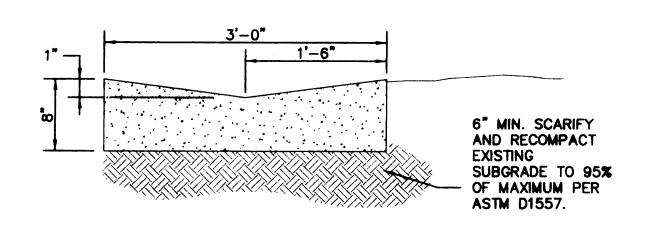


6 CONCRETE VALLEY GUTTER C-3 N. T. S.


CONSTRUCTION NOTES:

. 1/2" EXPANSION JOINTS SHALL BE INSTALLED WHERE CONCRETE ABUTS RIGID STRUCTURES, SUCH AS CURBS, BUILDINGS, OR LIGHT STANDARDS. SEE DETAIL THIS SHEET.

2. CONCRETE SHALL HAVE CONTRACTION JOINTS AT 6' INTERVALS, UNLESS OTHERWISE SHOWN ON PLANS. SEE DETAIL THIS SHEET.

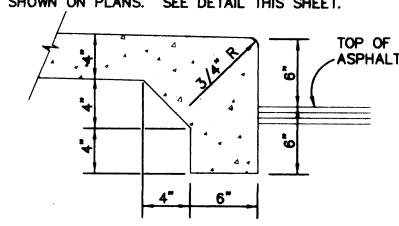

CONCRETE TURNDOWN (TYP ALL VACUUM STATIONS)

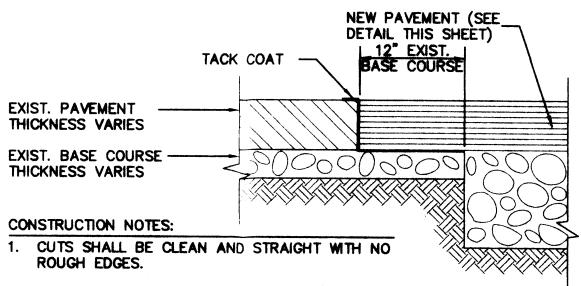


PROVIDE 1/2" EXPANSION JOINTS AT 36' O.C., AT IMMOVABLE OBJECTS, AND AT THE BEGINNING AND END OF CURVES.

3. ALL EXPOSED CONCRETE CORNERS TO HAVE 3/4" RADII.

- 2. IRREGULAR BREAKAGE SHALL BE REMOVED AND REPAIRED.
- 3. LAY NEW ASPHALT PAVING ON EXIST. BASE COURSE AT JOINT.

8 PAVEMENT CUT AND PATCH DETAIL

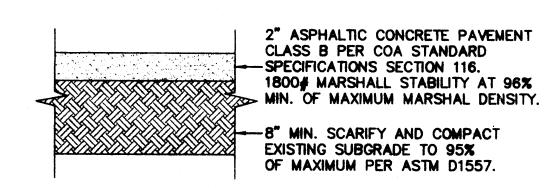

ASPHALT PAVEMENT SECTION

DRAINAGE REPORT

THE PROPOSED SITE IS 0.59 ACRES, LOCATED ON THE WEST END OF LOT A-26-A2A, AS SHOWN ON THE GRADING PLAN ON SHEET C-2. LOT A-26-A2A IS LOCATED NORTH OF QUAIL ROAD AND WEST OF COORS BOULEVARD, AS SHOWN ON THE VICINITY MAP ON SHEET C-2. ALL OF THE PROPERTIES AROUND THIS SITE ARE ALREADY DEVELOPED AND UTILIZE FREE DISCHARGE TO COORS BOULEVARD WHERE THE FLOW IS INTERCEPTED BY A STORM DRAIN. THIS LOT HAS A SLIGHT SLOPE TOWARD COORS BOULEVARD ENABLING IT TO DRAIN TO THE EAST.

FLOODPLAIN STATUS

THIS PROJECT, AS SHOWN ON FEMA'S FLOOD INSURANCE RATE MAP 35001C0337 D, DATED SEPTEMBER 20, 1996 IS NOT WITHIN ANY DESIGNATED 100-YEAR FLOODPLAIN. THE SITE IS DESIGNATED ON THE FIRM PANEL ON THIS SHEET.

METHODOLOGY

THE HYDROLOGY FOR THIS PROJECT WAS ANALYZED USING THE QUICK CALCULATIONS OF THE JUNE 1997 RELEASE OF THE CITY OF ALBUQUERQUE DEVELOPMENT PROCESS MANUAL, SECTION 22.2.

PRECIPITATION


THE 100-YR 6-HR DURATION STORM WAS USED AS THE DESIGN STORM FOR THIS ANALYSIS. THIS SITE IS WITHIN ZONE 1 AS IDENTIFIED IN THE CITY OF ALBUQUERQUE DEVELOPMENT PROCESS MANUAL, SECTION 22.2. TABLES WITHIN THIS SECTION WAS USED TO ESTABLISH THE 6-HOUR PRECIPITATION, EXCESS PRECIPITATION, AND PEAK DISCHARGE.

EXISTING DRAINAGE

THE SITE IS UNDEVELOPED AS DESCRIBED IN "LOCATION AND DESCRIPTION" ABOVE. ALL OF THE ADJACENT SITES HAVE BEEN FILLED TO DRAIN AWAY FROM THIS PROPERTY. THEREFORE, THERE ARE NO OFF SITE BASINS CONTRIBUTING DRAINAGE TO THIS SITE. A STORM DRAIN IN COORS BOULEVARD HAS BEEN DESIGNED AND CONSTRUCTED TO INTERCEPT DEVELOPED FLOWS FROM THIS TRACT OF LAND.

DEVELOPED CONDITION

AT THIS TIME ONLY 0.59 ACRES OF THE 1.24 ACRE SITE WILL BE DEVELOPED AS A CAR WASH. THE REMAINING 0.64 ACRES WILL REMAIN UNDEVELOPED. THE "100-YEAR HYDROLOGIC CALCULATIONS", ON THIS SHEET, DEMONSTRATE THAT THIS DEVELOPMENT WILL INCREASE THE RUNOFF FROM THIS SITE FROM 0.77 OFS TO 2.36 OFS. HOWEVER, THE AREA BEING DEVELOPED AS A CAR WASH IS ONLY 73.66% IMPERVIOUS WHICH IS LESS THAN THE DPM SECTION 22.2 ALLOWANCE OF 90% FOR COMMERCIAL SITES. THEREFORE, THIS DEVELOPMENT DISCHARGES LESS RUNOFF THAN WHAT WAS ANTICIPATED WHEN THE COORS STORM DRAIN WAS DESIGNED. GRADES HAVE BEEN SET TO ASSURE THAT SURFACE RUNOFF WILL CONTINUE TO CROSS THE UNDEVELOPED PORTION OF THIS LOT AND DRAIN TO COORS BOULEVARD WITHOUT OBSTRUCTING FUTURE DEVELOPMENT ON THE REMAINDER OF THE LOT. THEREFORE, THIS SITE CAN BE DEVELOPED ACCORDING TO THIS GRADING AND DRAINAGE PLAN WITHOUT ADVERSELY AFFECTING DOWNSTREAM PROPERTY.

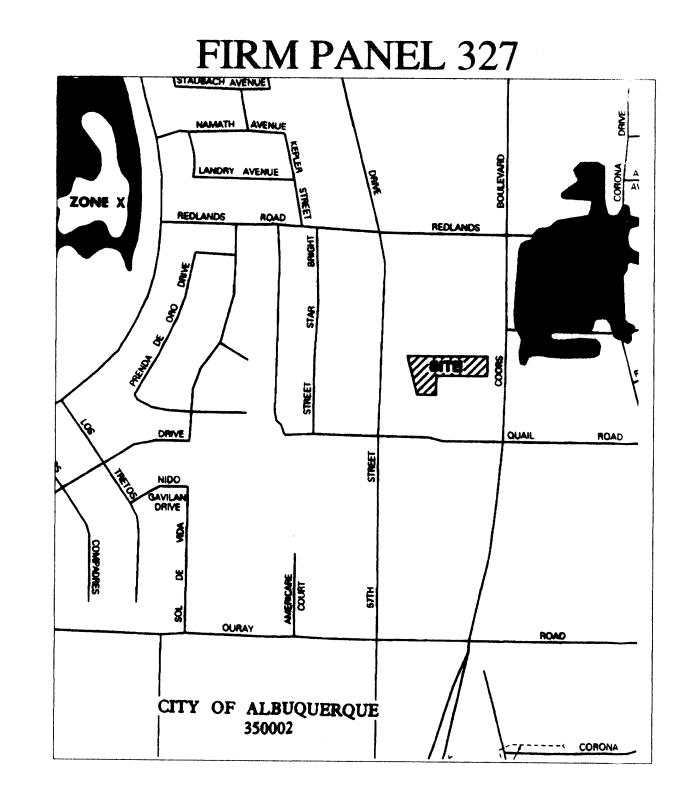

		L	AND TR	EATHER	T	WEGHTED					
BASIN	AREA	• 🔥	B	C	D	E	V (6-hr)	V (6-br)	V(10 day)	V(10 day)	Q
#	(acre)	(%)	(%)	(%)	(%)	(in)	(acre-ft)	(cu-ft)	(acre-ft)	(cu-ft)	(cfs)
					EXETE	NG COMPITIC	XXO				
CAR WASH	0.5938	100.00	0.00	0.00	0.00	0.44	0.02	948	0.02	948	0.77
REMAINDER	0.6442	75.62	0.00	10.83	13.54	0.71	0.04	1,653	0.05	2,118	1.21
TOTAL	1.2300						0.06	2,001	0.07	3,067	1.96
					PROPO	NED CONDITI	ONS				
CAR WASH	0.5938	0.00	0.00	26.34	73.68	1.71	0.08	3,690	0.14	6,024	2.36
REMAINDER	0.6442	75.62	0.00	10.83	13.54	0.71	0.04	1,653	0.05	2,118	1.21
TOTAL	1.2300						0.12	5,343	0.19	8,142	3.57
EXCESS P	RECIP.	0.44	0.67	0.99	1.97	E (in)					
PEAK DISC	HARGE	1.29	2.03	2.87	4.37	Qm (cfs)					
									ZONE =	1	
WEIGHTED E	$(in) = (E_A)$	(%A) + (E	a)(%B) +	(Ec)(%C)) + (E _D)(9	6D)			Pour (in.) =	2.20	
Vs-un (acre-ft) =	= (WEIGH	TED EXA	REA)/12			•			P24+IR (in.) =		
VIODAY (SCIE-R)	= Va + 1	AnVD.	_ DW	12					Pioday (in.) =		

ARCHITECT SEAL

ENGINEER SEAL



PROJECT

BRI

REVISIONS

OCTOBER 25, 2001 SCALE

1"=20'

DRAWING NAME **DETAILS AND**

DRAINAGE PLAN

SHEET NUMBER

LARRY READ & ASSOCIATES
Civil Engineers 4800-C Juan Tabo, NE Albuquerque, New Mexico 87111 (505) 237-8421

GENERAL

CONTRACTOR IS RESPONSIBLE FOR OBTAINING ALL REQUIRED CONSTRUCTION PERMITS, INCLUDING A TOP SOIL DISTURBANCE PERMIT, PRIOR TO START OF CONSTRUCTION.

ALL WORK ON THIS PROJECT SHALL BE PERFORMED IN ACCORDANCE WITH APPLICABLE FEDERAL, STATE, AND LOCAL LAWS, ORDINANCES, AND REGULATIONS CONCERNING CONSTRUCTION SAFETY AND HEALTH.

REFERENCES MADE TO STANDARD SPECIFICATIONS AND STANDARD DRAWINGS REFER TO THE CITY OF ALBUQUERQUE STANDARD SPECIFICATIONS FOR PUBLIC WORKS CONSTRUCTION, 1986 EDITION WITH ALL UPDATES.

THE CONTRACTOR SHALL NOT INSTALL ITEMS AS SHOWN ON THESE PLANS WHEN IT IS OBVIOUS THAT FIELD CONDITIONS ARE DIFFERENT THAN SHOWN IN THE PLANS. SUCH CONDITIONS SHALL BE BROUGHT TO THE ATTENTION OF THE ENGINEER IN A TIMELY MANNER. IN THE EVENT THE CONTRACTOR DOES NOT NOTIFY THE ENGINEER IN A TIMELY MANNER, THE CONTRACTOR ASSUMES FULL RESPONSIBILITY AND EXPENSE FOR ANY REVISIONS NECESSARY, INCLUDING ENGINEERING DESIGN FEES.

EXISTING SITE IMPROVEMENTS WHICH ARE DAMAGED OR DISPLACED BY THE CONTRACTOR SHALL BE REMOVED AND REPLACED BY THE CONTRACTOR AT THE CONTRACTOR'S EXPENSE. REPAIRS SHALL BE APPROVED BY THE OWNER PRIOR TO CONSTRUCTION OF THE REPAIRS. REPAIRS SHALL BE ACCEPTED BY THE OWNER PRIOR TO FINAL PAYMENT.

EXISTING FENCING THAT IS NOT DESIGNATED FOR REMOVAL SHALL NOT BE DISTURBED. ANY FENCING THAT IS DISTURBED OR ALTERED BY THE CONTRACTOR SHALL BE RESTORED TO ITS ORIGINAL CONDITION AT THE CONTRACTORS EXPENSE. IF THE CONTRACTOR DESIRES TO REMOVE FENCING TO ACCOMMODATE CONSTRUCTION ACTIVITIES. THE CONTRACTOR SHALL OBTAIN THE OWNER'S WRITTEN PERMISSION BEFORE THE FENCE IS REMOVED. CONTRACTOR SHALL RESTORE THE FENCE TO ITS ORIGINAL CONDITION AT THE EARLIEST OPPORTUNITY. WHILE ANY FENCING IS REMOVED, THE CONTRACTOR SHALL BE SOLELY RESPONSIBLE FOR SECURITY OF THE SITE UNTIL THE FENCE IS RESTORED.

WORK WITHIN ADJACENT RIGHT-OF-WAY

PRIOR TO BEGINNING ANY CONSTRUCTION ACTIVITIES WITHIN ADJACENT RIGHT-OF-WAYS OR WITHIN PROPERTY NOT OWNED BY THE OWNER OF THE PROJECT SITE, THE CONTRACTOR SHALL ASSURE THAT ALL PERMITS AND PERMISSIONS REQUIRED HAVE BEEN OBTAINED IN WRITING.

SURVEY MONUMENTS. PROPERTY CORNERS. BENCHMARKS

THE CONTRACTOR SHALL NOTIFY THE OWNER AT LEAST SEVEN DAYS BEFORE BEGINNING ANY CONSTRUCTION ACTIVITY THAT COULD DAMAGE OR DISPLACE SURVEY MONUMENTS, PROPERTY CORNERS, OR PROJECT BENCHMARKS SO THESE ITEMS MAY BE RELOCATED.

ANY SURVEY MONUMENTS. PROPERTY CORNERS. OR BENCHMARKS THAT ARE NOT IDENTIFIED FOR RELOCATION ARE THE RESPONSIBILITY OF THE CONTRACTOR TO PRESERVE AND PROTECT. RELOCATION OR REPLACEMENT OF THESE ITEMS SHALL BE DONE BY THE OWNER'S SURVEYOR AT THE EXPENSE OF THE CONTRACTOR.

DIMENSIONS

- ALL DIMENSIONS TO CURBS ARE TO THE FLOWLINE UNLESS OTHERWISE NOTED.
- ALL STATIONING IS TO THE CENTERLINE OF THE RIGHT-OF-WAY UNLESS OTHERWISE NOTED.
- ALL SLOPES AND GRADES ARE IN PERCENT UNLESS OTHERWISE NOTED.

CURB ELEVATIONS ARE SHOWN AT THE FLOW LINE UNLESS OTHERWISE NOTED. SEE THE DETAIL SHEET TO DETERMINE THE CURB HEIGHT ABOVE FLOW LINE.

UNLESS OTHERWISE SPECIFIED. SUBGRADE. ENGINEERED FILL. AND STRUCTURAL FILL SHALL BE COMPACTED TO THE FOLLOWING SPECIFICATIONS OF THE ASTM D-1557 MAXIMUM DRY DENSIT

MATERIAL/LOCATION	PERCENT COMPACT
STRUCTURAL FILL IN THE BUILDING AREA	95%
SUBBASE FOR SLAB SUPPORT	95%
MISCELLANEOUS BACKFILL BELOW STRUCTURA	AL
FILL OR ROADWAY PAVEMENT	95%
MISCELLANEOUS BACKFILL BELOW UNPAVED,	
NON-BUILDING AREAS	90%
ROADWAY PAVEMENT SUBGRADE	95%
SIDEWALK SUBGRADE	90%
CURB AND GUTTER SUBGRADE	95%

PAYEMENT

WHEN ABUTTING NEW PAVEMENT TO EXISTING PAVEMENT, CUT EXISTING PAVEMENT EDGE TO A NEAT, STRAIGHT LINE AS NECESSARY TO REMOVE ANY BROKEN OR CRACKED PAVEMENT AND MATCH NEW PAVEMENT ELEVATION TO

ALL UTILITIES AND UTILITY SERVICE LINES SHALL BE INSTALLED AND APPROVED PRIOR TO PAVING.

ALL WATER VALVE BOXES AND ELECTRICAL, TELEPHONE, TELEVISION, AND SEWER MANHOLES IN THE CONSTRUCTION AREA SHALL BE ADJUSTED TO FINISHED GRADE BEFORE PAVING.

WHEN SIDEWALK OR CURB AND GUTTER IS REMOVED, IT SHALL BE REMOVED TO EXISTING CONSTRUCTION JOINTS. CUTTING OR BREAKING SHALL NOT BE ALLOWED.

L	EC	B	N	D

	EX BLOCK WALL	\$	LIGHT POLE		EX SD INLET
× G 89.5	EX SPOT ELEV.	A	EX FIRE HYDRANT	<i>(e</i>)	CONCRETE
♠ FL 09.3	PROP SPOT ELEV.	•	EX WATER VALVE		EX WATER METER
5160	EX BLOCK WALL	©	EX SD MANHOLE	€	EXIST. TREE
\boxtimes	TRANSFORMER	\$	EX SAS MANHOLE		

IF ANY UTILITY LINES, PIPELINES, OR UNDERGROUND UTILITY LINES ARE SHOWN ON THESE DRAWINGS, THEY ARE SHOWN IN AN APPROXIMATE LOCATION ONLY BASED ON THE INFORMATION PROVIDED TO THE ENGINEER BY OTHERS. THIS INFORMATION MAY BE INACCURATE OR INCOMPLETE. ADDITIONALLY, UNDERGROUND LINES MAY EXIST THAT ARE NOT SHOWN. THE CONTRACTOR SHALL VERIFY THE LOCATION OF ANY UTILITY LINE, PIPELINE, OR UNDERGROUND UTILITY LINE IN OR NEAR THE AREA OF THE WORK IN ACCORDANCE WITH CHAPTER 62, ARTICLE 14-1, THROUGH 14-8, NMSA 1978.

THE CONTRACTOR SHALL CONTACT THE STATEWIDE UTILITY LOCATOR SERVICE AT 1-800-321-2537 AT LEAST TWO WORKING DAYS BEFORE BEGINNING CONSTRUCTION. AFTER THE UTILITIES ARE SPOTTED. THE CONTRACTOR SHALL EXPOSE ALL PERTINENT UTILITIES TO VERIFY THEIR VERTICAL AND HORIZONTAL LOCATION. IF A CONFLICT EXISTS BETWEEN EXISTING UTILITIES AND PROPOSED CONSTRUCTION, THE CONTRACTOR SHALL NOTIFY THE ENGINEER SO THAT THE CONFLICT CAN BE RESOLVED WITH MINIMAL DELAY.

THE CONTRACTOR SHALL EXERCISE DUE CARE TO AVOID DISTURBING ANY EXISTING UTILITIES, ABOVE OR BELOW GROUND. UTILITIES THAT ARE DAMAGED BY CARELESS CONSTRUCTION SHALL BE REPAIRED OR REPLACED AT THE CONTRACTOR'S EXPENSE.

EXISTING VALVES SHALL ONLY BE OPERATED BY THE UTILITY COMPANY. CONTRACTOR SHALL NOTIFY THE UTILITY A MINIMUM OF TWO WORKING DAYS BEFORE ANY VALVE, NEW OR EXISTING, NEEDS TO BE OPERATED.

THE CONTRACTOR SHALL COORDINATE ANY REQUIRED UTILITY INTERRUPTIONS WITH THE OWNER AND AFFECTED UTILITY COMPANY A MINIMUM OF THREE WORKING DAYS BEFORE THE INTERRUPTION.

THE CONTRACTOR SHALL MAINTAIN A RECORD DRAWING SET OF PLANS AND PROMPTLY LOCATE ALL UTILITIES. EXITING OR NEW, IN THEIR CORRECT LOCATION, HORIZONTAL AND VERTICAL. THIS RECORD SET OF DRAWINGS SHALL BE MAINTAINED ON THE PROJECT SITE AND SHALL BE AVAILABLE TO THE OWNER AND ENGINEER AT ANY TIME DURING CONSTRUCTION.

EROSION CONTROL. ENVIRONMENTAL PROTECTION. AND STORM WATER POLLUTION PREVENTION PLAN

THE CONTRACTOR SHALL CONFORM TO ALL CITY, COUNTY, STATE, AND FEDERAL DUST AND EROSION CONTROL REGULATIONS. THE CONTRACTOR SHALL OBTAIN AND PREPARE ANY DUST CONTROL OR EROSION CONTROL PERMITS REQUIRED FROM THE REGULATORY AGENCIES.

THE CONTRACTOR SHALL PROMPTLY REMOVE ANY MATERIAL EXCAVATED WITH THE PUBLIC RIGHT-OF-WAY OR ADJACENT PROPERTY TO KEEP IT FROM WASHING OFF THE PROJECT SITE.

THE CONTRACTOR SHALL ENSURE THAT NO SOIL ERODES FROM THE SITE ONTO ADJACENT PROPERTY BY CONSTRUCTION OF TEMPORARY EROSION CONTROL BERMS OR INSTALLING SILT FENCES AT THE PROPERTY LINES AND WETTING THE SOIL TO PREVENT IT FROM BLOWING.

WATERING, AS REQUIRED FOR CONSTRUCTION DUST CONTROL, SHALL BE CONSIDERED INCIDENTAL TO CONSTRUCTION AND NO MEASUREMENT OR PAYMENT SHALL BE MADE. CONSTRUCTION AREAS SHALL BE WATERED FOR DUST CONTROL IN COMPLIANCE WITH GOVERNMENT ORDINANCES. THE CONTRACTOR SHALL BE RESPONSIBLE FOR LOCATING AND SUPPLYING WATER AS REQUIRED.

ANY AREAS DISTURBED BY CONSTRUCTION AND NOT COVERED BY LANDSCAPING OR IMPERVIOUS SURFACES SHALL BE REVEGETATED WITH RECLAMATION SEEDING.

THE CONTRACTOR SHALL PROPERLY HANDLE AND DISPOSE OF ALL ASPHALT REMOVED ON THE PROJECT BY HAULING IT TO AN APPROVED DISPOSAL SITE IN ACCORDANCE WITH THE REQUIREMENTS OF THE NEW MEXICO SOLID WASTE ACT.

ALL WASTE PRODUCTS FROM THE CONSTRUCTION SITE, INCLUDING ITEMS DESIGNED FOR REMOVAL, CONSTRUCTION WASTE, CONSTRUCTION EQUIPMENT WASTE PRODUCTS (OIL, GAS, TIRES, ETC.), GARBAGE, GRUBBING, EXCESS CUT MATERIAL, VEGETATIVE DEBRIS, ETC.. SHALL BE APPROPRIATELY DISPOSED OF OFFSET AT NO ADDITIONAL COST TO THE OWNER. IT SHALL BE THE CONTRACTOR'S RESPONSIBILITY TO OBTAIN ANY PERMITS REQUIRED FOR HAUL OR DISPOSAL OF WASTE PRODUCTS, IT SHALL BE THE CONTRACTOR'S RESPONSIBILITY TO ENSURE THAT THE WASTE DISPOSAL SITE COMPLIES WITH GOVERNMENT REGULATIONS REGARDING THE ENVIRONMENT, ENDANGERED SPECIES, AND ARCHAEOLOGICAL RESOURCES.

THE CONTRACTOR SHALL BE RESPONSIBLE FOR THE CLEANUP AND REPORTING OF SPILLS OF HAZARDOUS MATERIALS ASSOCIATED WITH THE CONSTRUCTION SITE. HAZARDOUS MATERIALS INCLUDE GASOLINE, DIESEL FUEL, MOTOR OIL, SOLVENTS, CHEMICALS, PAINT, ETC. WHICH MAY BE A THREAT TO THE ENVIRONMENT. THE CONTRACTOR SHALL REPORT THE DISCOVERY OF PAST OR PRESENT SPILLS TO THE NEW MEXICO EMERGENCY RESPONSE AT 1-800-219-6157.

THE CONTRACTOR SHALL COMPLY WITH ALL APPLICABLE REGULATIONS CONCERNING SURFACE AND UNDERGROUND WATER. CONTACT WITH SURFACE WATER BY CONSTRUCTION EQUIPMENT AND PERSONNEL SHALL BE MINIMIZED. EQUIPMENT MAINTENANCE AND REFUELING OPERATIONS SHALL BE PERFORMED IN AN ENVIRONMENTALLY SAFE MANNER IN COMPLIANCE WITH GOVERNMENT REGULATIONS.

THE CONTRACTOR SHALL COMPLY WITH ALL APPLICABLE REGULATIONS CONCERNING CONSTRUCTION NOISE AND HOURS OF OPERATION.

ACCESSIBLE FACILITIES

ALL SURFACES ALONG ACCESSIBLE ROUTES AND FOR HANDICAP RAMPS SHALL BE STABLE FIRM, SLIDE RESISTANT AND SHALL COMPLY WITH UNIFORM FEDERAL ACCESSIBILITY STANDARDS, PARAGRAPH 4.5.

LONGITUDINAL SLOPES ALONG ACCESSIBLE ROUTE SIDEWALKS, EXCEPT AT HANDICAP RAMPS, SHALL NOT BE STEEPER THAN 1: 20. CROSS SLOPES ALONG ACCESSIBLE ROUTE SIDEWALKS EXCEPT AT HANDICAP RAMPS, SHALL NOT BE STEEPER THAN 1: 48. SLOPES IN ACCESSIBLE PARKING SPACES, ACCESS AISLES, AND PASSENGER LOADING ZONES SHALL NOT BE STEEPER THAN 1:48 IN ALL DIRECTIONS.

THE SITE SHALL COMPLY WITH ANSI A117.1-1992, "ACCESSIBLE AND USABLE BUILDINGS AND FACILITIES".


TRAFFIC CONTROL

THE CONTRACTOR SHALL PROVIDE ALL REQUIRED TRAFFIC CONTROL PLANS. ALL SIGNS, BARRICADES, CHANNELIZATION DEVICES, SIGN FRAMES AND ERECTION OF SUCH DEVICES SHALL CONFORM TO THE REQUIREMENTS OF " MANUAL OF UNIFORM TRAFFIC CONTROL DEVICES FOR STREETS AND HIGHWAYS" LATEST EDITION. PRIOR TO CONSTRUCTION, TRAFFIC CONTROL PLANS SHALL BE APPROVED BY THE GOVERNING AUTHORITY.

ВМ		ATIONS
		BENCHMARK OARLE TELEVISION LINE
		CABLE TELEVISION LINE CLEANOUT
COA		CITY OF ALBUQUERQUE
		CONCRETE
CL		CENTERLINE
DIA		DIAMETER
DTL		DETAIL
DWG		DRAWING
E		ELECTRIC LINE
		ELECTRIC
		ELEVATION
EX		EXISTING
F		FINISHED FLOOR ELEVATION
r G		FINISHED FLOOR ELEVATION FINISHED GRADE
G H		FIRE HYDRANT
n L		FLOW LINE
L		GAS PIPE
· M		GAS METER
		GATE VALVE
3V		INVERT ELEVATION
NV .F		
r P		LICHT POLE
		LIGHT POLE
/S ⊔		LANDSCAPING
Н		MANHOLE NATURAL CROUND
G E		NATURAL GROUND
E		OVERHEAD ELECTRIC LINE
T		OVERHEAD TELEPHONE LINE
CC		PORTLAND CEMENT CONCRETE
,		POWER POLE
		PROPOSED
C		POLYVINYL CHLORIDE PIPE
P M		REINFORCED CONCRETE PIPE
W		RIGHT-OF-WAY
_		SLOPE
S		SANITARY SEWER
		STORM DRAIN
A		STATION
D		STANDARD
•		SIDEWALK
		TELEPHONE
\		TOP OF ASPHALT PAVEMENT
		TOP OF CONCRETE SLAB (PAVEMENT)
C	*	TOP OF CONCRETE CURB
	=	TOP OF GRATE
		TOP OF SIDEWALK
1	-	TOP OF WALL
P	=	TYPICAL
:	=	UNDERGROUND ELECTRIC
7	=	UNDERGROUND TELEPHONE
	=	WATER
1	**	WATER METER
		WATER VALVE

ARCHITECT SEAL

ENGINEER SEAL

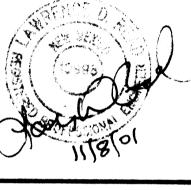

PROJECT

BRI જ 8 $\mathbf{\omega}$

REVISIONS

OCTOBER 25, 2001 SCALE


1"=20

DRAWING NAME

GENERAL NOTES

SHEET NUMBER

LARRY READ & ASSOCIATES Civil Engineers 4800-C Juan Tabo, NE Albuquerque, New Mexico 87111 (505) 237-8421

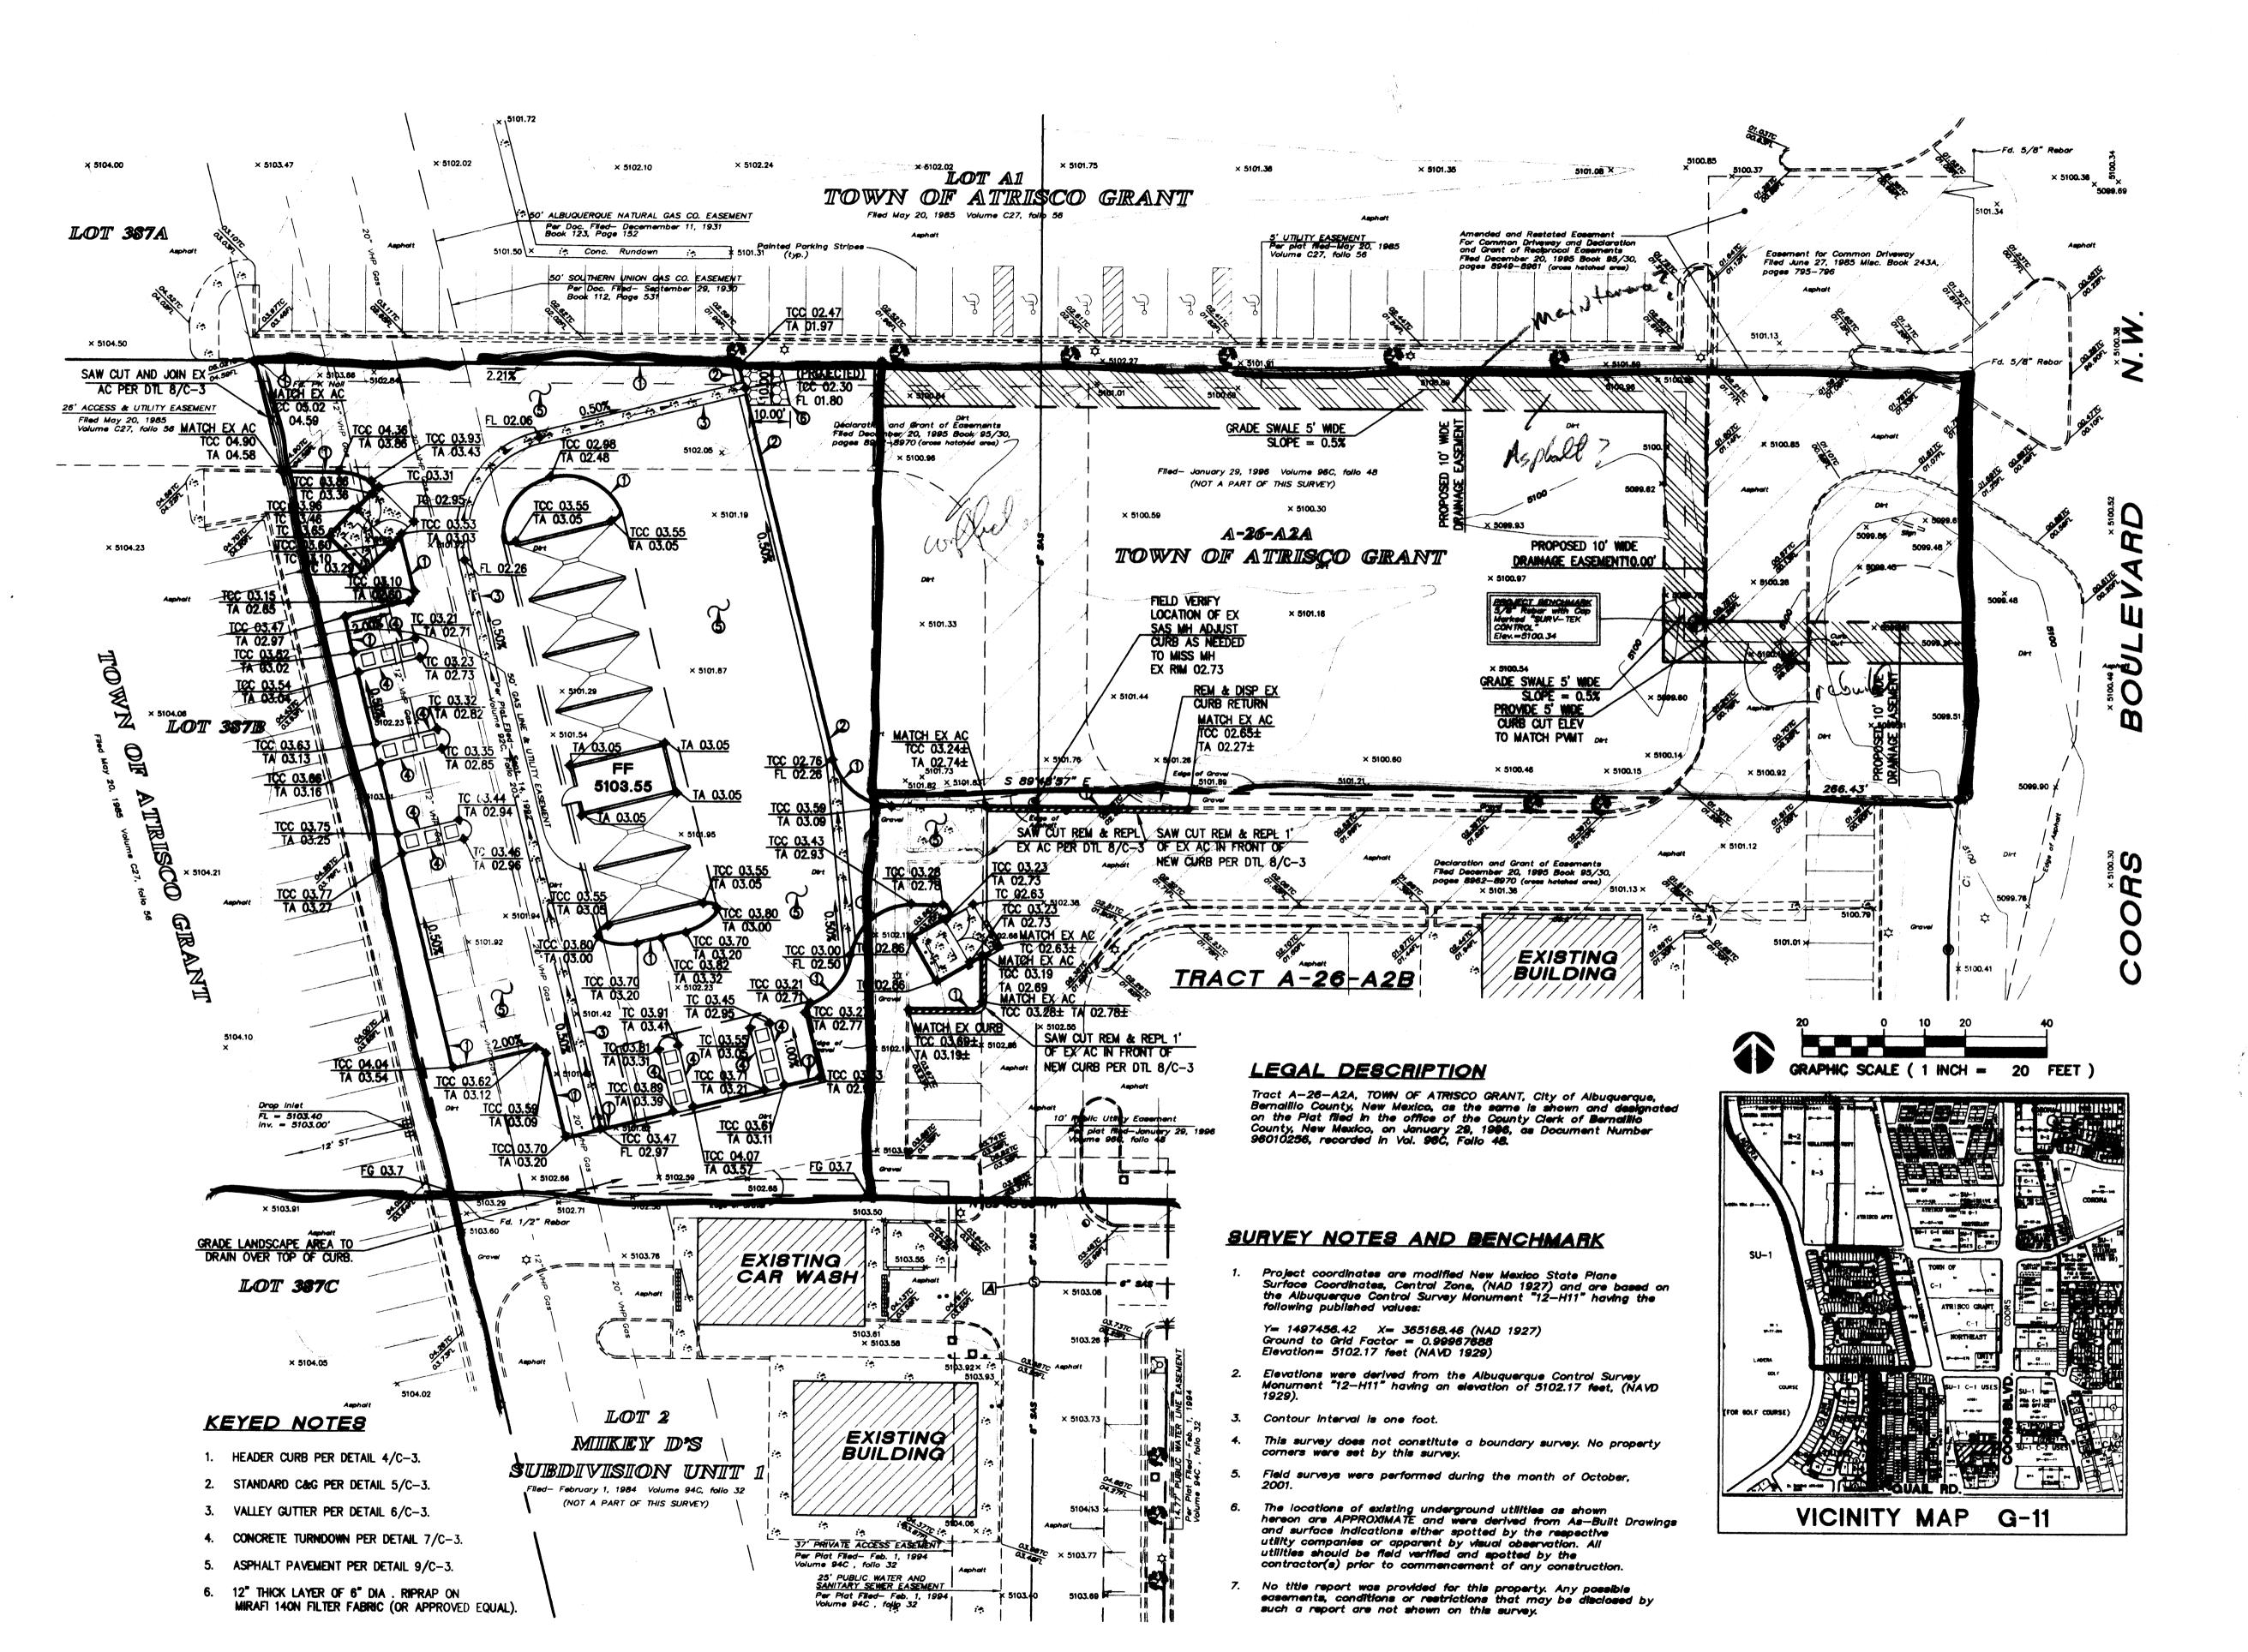

A R C H I T E C T

BOX 2941 CORRALES NEW MEXICO 87048 505 892 8911

ARCHITECT SEAL

ENGINEER SEAL



PROJECT

OR LUBRICAR, INC.
BLVD. & QUAIL RD., NW
UERQUE, NEW MEXICO

REVISIONS

OCTOBER 25, 2001

NORTH 5 C A

DRAWING NAME

GRADING PLAN


SHEET NUMBER

LARRY READ & ASSOCIATES


Civil Engineers

4800-C Juan Tabo, NE
Albuquerque, New Mexico 87111
(505) 237-8421


C-2

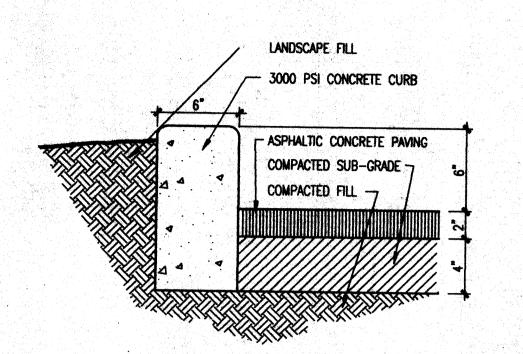

TYPICAL CURB DETAIL
1-1/2"=1'-0"

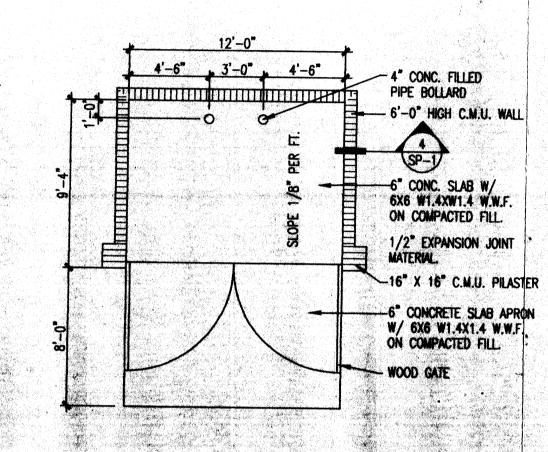


TRASH ENCLOSURE
3/16"=1"-0"

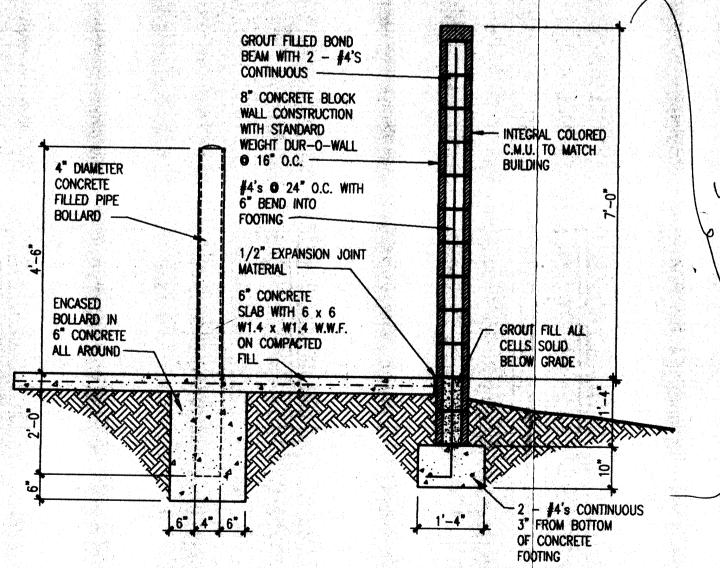

SECTION THRU ENCLOSURE WALL

1/2"=1'-0"

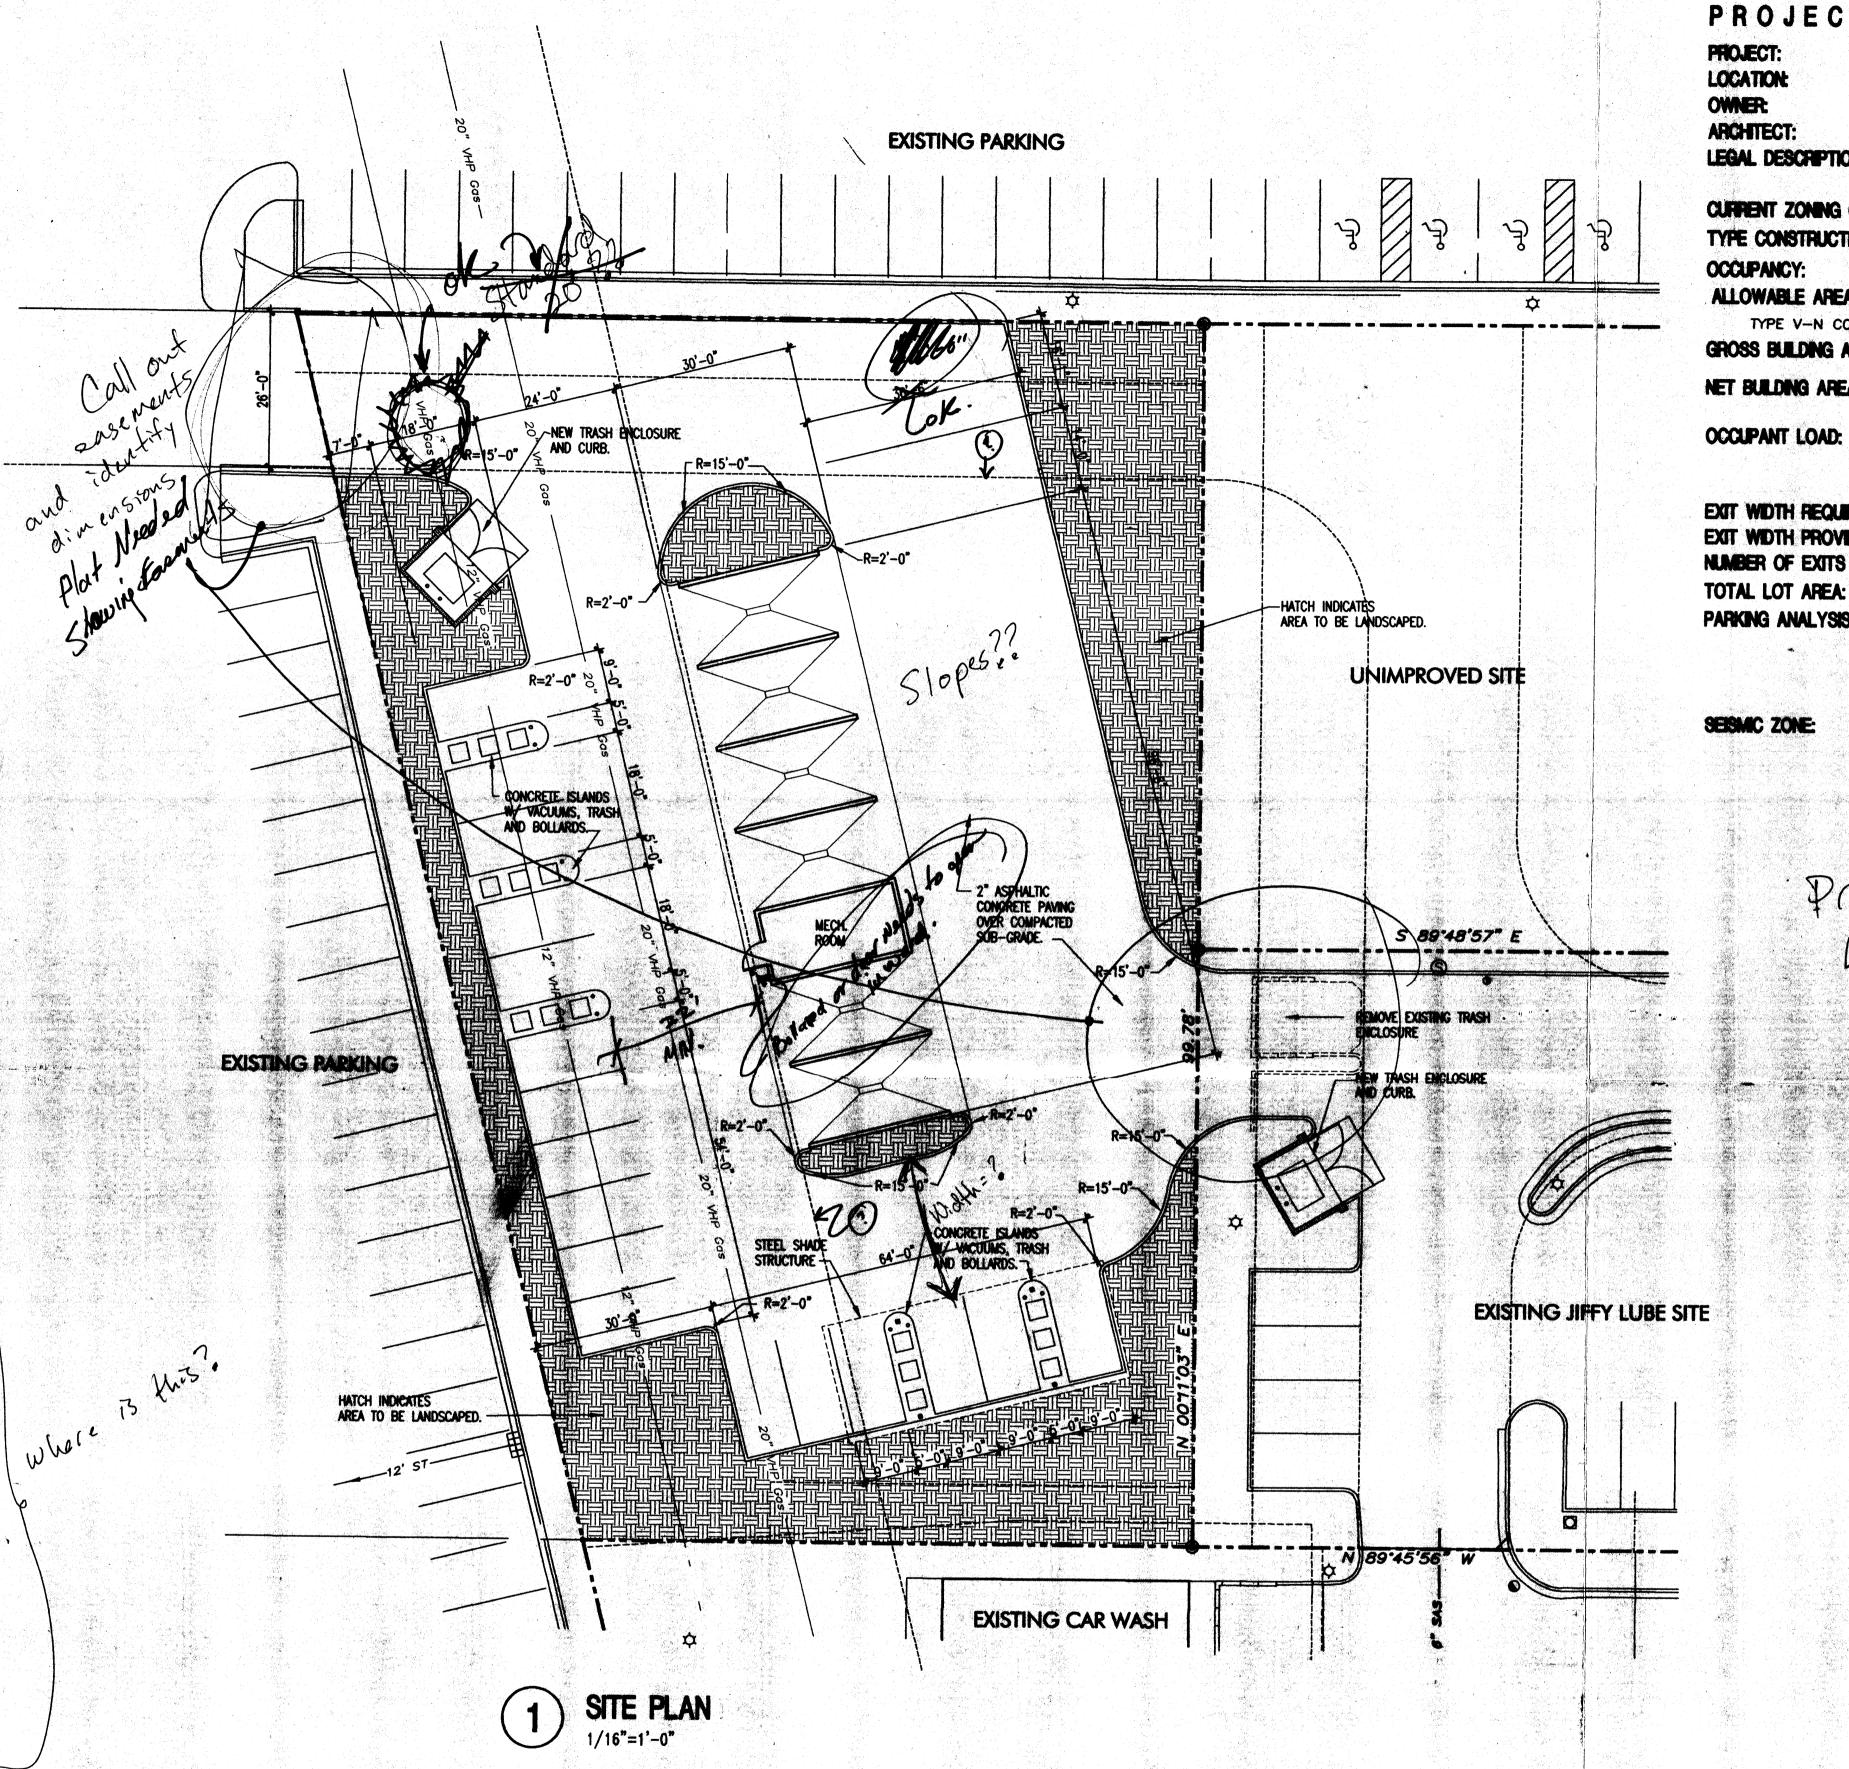

PROJECT INFORMATION

NEW SELF-SERVE CAR WASH QUAIL AND COORS BLVD., N.W. TATE FISHBURN ARCHITECT LEGAL DESCRIPTION TRACT A-26-A2A-1
TOWN OF ATRISCO GRANT
ZONE ATLAS H-11-Z CURRENT ZONING CLASSIFICATION: TYPE CONSTRUCTION ALLOWABLE AREA: TYPE V-N CONSTRUCTION & B OCCUPANCY = 8,000 GROSS BUILDING AREA: 2,880 S.F.

NET BULDING AREA: 264 S.F. 264/100 = 3 OCCUPANTS

EXIT WIDTH REQUIRED: 1 INCH EXIT WIDTH PROVIDED: 48 INCHES NUMBER OF EXITS PROVIDED: ONE TOTAL TOTAL LOT AREA: .59 ACRES +/-PARKING ANALYSIS:

NET AREA = 264 264 / 200 =2 REQUIRED SPACES SPACES REQUIRED = 2
SPACES PROVIDED= 17 SPACES

· Provide Legend

ARCHITECT SEAL

ENGINEER SEAL


REVISIONS

NOVEMBER 13, 2001 SCALE

DRAWING NAME

SITE PLAN

SHEET NUMBER

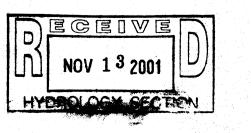

SP-1